

# **ACTION PLANS**

m: 0426 957 518

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## **DEVELOPEMENT APPLICATION**

<b>5 - 1 - - - - - -</b>			
SHEET NUMBER		SHEET NAME	DATE PUBLISHED
DA00	COVER		8/03/2019
DA01	SITE ANALYSIS		8/03/2019
DA02	SITE / ROOF / SEDIMENT EROSION / WASTE MANAGEMENT / STORMWATER CON	ICEPT PLAN	8/03/2019
DA03	EXISTING LOWER GROUND FLOOR PLAN		8/03/2019
DA04	PROPOSED LOWER GROUND FLOOR PLAN		8/03/2019
DA05	EXISTING GROUND FLOOR PLAN		8/03/2019
DA06	PROPOSED GROUND FLOOR PLAN		8/03/2019
DA07	EXISTING FIRST FLOOR PLAN		8/03/2019
DA08	PROPOSED FIRST FLOOR PLAN		8/03/2019
DA09	NORTH / WEST ELEVATION		8/03/2019
DA10	SOUTH / EAST ELEVATION		8/03/2019
DA11	LONG / CROSS SECTION		8/03/2019
DA12	AREA CALCULATIONS		8/03/2019
DA13	SAMPLE BOARD		8/03/2019
DA14	WINTER SOLSTICE 9 AM		8/03/2019
DA15	WINTER SOLSTICE 12 PM		8/03/2019
DA16	WINTER SOLSTICE 3 PM		8/03/2019
DA17	BASIX		8/03/2019

ITEM DETAILS	DEVELOPMENT APPLICATION			
ADDRESS	39 ROBERT STREET, FRESHWATE	R, NSW 2096		
LOT & DP/SP	LOT 1 DP 623176			
COUNCIL	NORTHERN BEACHS COUNCIL (WA	ARRINGAH)		
SITE AREA	937.4m²			
FRONTAGE	15.240m			
CONTROLS	PERMISSIBLE / REQUIRED	EXISTING	PROPOSED	COMPLIANCE
CONTROLS	m / m² / %	m / m² / %	m / m² / %	
<u>LEP</u>				
LAND ZONING	R2 – LOW DENSITY RESIDENTIAL	R2	R2	YES
MINIMUM LOT SIZE	450m²	937.4m <sup>2</sup>	UNCHANGED	YES
FLOOR SPACE RATIO	NOT IDENTIFIED	N/A	N/A	N/A
MAXIMUM BUILDING HEIGHT	8.5m	8.5m	UNCHANGED	YES
<u>HAZARDS</u>				
ACID SULFATE SOILS	NOT IDENTIFIED	N/A	N/A	N/A
FLOOD PLANNING	NOT IDENTIFIED	N/A	N/A	N/A
DEVELOPMENT ON SLOPING	LANDOUR AREA A A R	N1/A	11/4	11/4
LAND	LANDSLIP AREA A & B	N/A	N/A	N/A
COASTAL HAZARDS	NOT IDENTIFIED	N/A	N/A	N/A
HIGH/MED/LOW FLOOD RISK	NOT IDENTIFIED	N/A	N/A	N/A
PRECINCT	NOT IDENTIFIED	IN/A	N/A	N/A
NATIVE VEGETATION	NOT IDENTIFIED	N/A	N/A	N/A
WILDLIFRE CORRIDORS	NOT IDENTIFIED	N/A	N/A	N/A
WATERWAYS AND RIPARIAN	NOT IDENTIFIED	N/A	N/A	N/A
LAND	NOT IDENTIFIED	IN/A	14/4	IVA
THREATEND HIGH	NOT IDENTIFIED	N/A	N/A	N/A
CONSERVATION HABITAT	NOT IDENTIFIED	14/73	14/7	14/4
LAND ADJOINING PUBLIC	NOT IDENTIFIED	N/A	N/A	N/A
OPEN SPACE			1471	1471
<u>DCP</u>				
WALL HEIGHT	7.2m	7.2m	UNCHANGED	YES
NUMBER OF STOREYS	N/A	3	UNCHANGED	YES
	1 1411	E: 0.98m	E: UNCHANGED	
SIDE BOUNDARY SETBACKS	0.9m	W: 0.0m	W: UNCHANGED	NO
FRONT BOUNDARY SETBACK	6.5m	0.26m	UNCHANGED	NO
REAR BOUNDARY SETBACK	6.0m	24.695m	24.695m	YES
LANDSCAPE OPEN SPACE	40% (374.96m²)	484.06m²	415.19m²	YES
PRIVATE OPEN SPACE	60m <sup>2</sup>	218.77m <sup>2</sup>	UNCHANGED	YES
TRIVITE OF EIVOI AGE	Oom	210.77111	ONO. WHOLD	120

## 39 ROBERT STREET, FRESHWATER 2096



#### **NCC & AS COMPLIANCES SPECIFICATIONS**

- EARTHWORKS: METHOD OF EXCAVATION AND FILL - PART 3.1.1 OF NCC - SURFACE SUBSOIL-STORMWATER DRAINAGE - PART 3.1.2 OF NCC

- TERMITE-RISK MANAGEMENT - PART 3.1.3 OF NCC

- FOOTINGS & SLAB - PART 3.2 OF NCC INCLUDING AS2870

- MASONRY CONSTRUCTION - PART 3.3 OF NCC INCLUDING AS3700

- SUB FLOOR VENTILATION - PART 3.4.1 OF NCC

- FRAMING - PART 3.4 OF NCC

- ROOF, WALL-CLADDING, GUTTERS & DOWNPIPES - PART 3.5 OF NCC

- GLAZING - PART 3.6 OF NCC INCLUDING AS1288

- FIRE SEPARATION - PART 3.7.1 OF NCC

- SMOKE ALARMS - PART 3.7.2 OF NCC

- HEATING APPLIANCES - PART 3.7.3 OF NCC

- WET AREAS-PROTECTION OF WALLS & FLOORS - PART 3.8.1 OF NCC

- MINIMUM ROOF HEIGHTS - PART 3.8.3 OF NCC

- FACILITIES REQUIRRED & SANITARY DOOR CONSTRUCTION - PART 3.8.3 OF NCC

- LIGHT: NATURAL AND ARTIFICIAL - PART 3.8.4 OF NCC - VENTILATION & LOCATION OF TOILETS - PART 3.8.5 OF NCC

- SOUND INSULATION - PART 3.8.6 OF NCC

- STAIR CONSTRUCTION INCLUDING DIMENSIONS - PART 3.9.1 OF NCC

- BALUSTRADES & OTHER BARRIERS - PART 3.9.2 OF NCC

- FENCING & OTHER PROVISIONS - REGS & AS1926

- DEMOLITION WORKS - AS2601-1991 THE DEMOLITION OF STRUCTURES.

- ALL WATERPROOF MEMBRANES TO COMPLY WITH WITH AS 3740-2004 - ALL PLUMBING & DRAINAGE WORK TO COMPLY WITH AS 3500

- SITE CLASSIFICATION AS TO AS 2870

- ALL PLASTERBOARD WORK TO COMPLY WITH AS 2588-1998

- ALL STRUCTURAL STEEL WORK TO COMPLY WITH AS 4100 & AS 1554 - ALL CONCRETE WORK TO COMPLY WITH AS 3600

- ALL ROOF SHEETING WORK TO COMPLY WITH AS 1562-1992

- ALL SKYLIGHTS TO COMPLY WITH WITH AS 4285-2007


- ALL CERAMIC TILING TO COMPLY WITH AS 3958.1-2007 & 3958.2-1992 - ALL GLAZING ASSEMBLIES TO COMPLY WITH AS2047 & 1288

- ALL TIMBER RETAINING WALLS ARE TO COMPLY WITH AS 1720.1-2010,

AS 1720.2-2006, AS 1720.4-2006, AS 1170.1-1989 & AS 1170.4-1993

- ALL RETAINING WALLS ARE TO COMPLY WITH 3700 - 2011 & AS 3600 -2001

- ALL CONSTRUCTION TO COMPLY TO AS3959- 1991

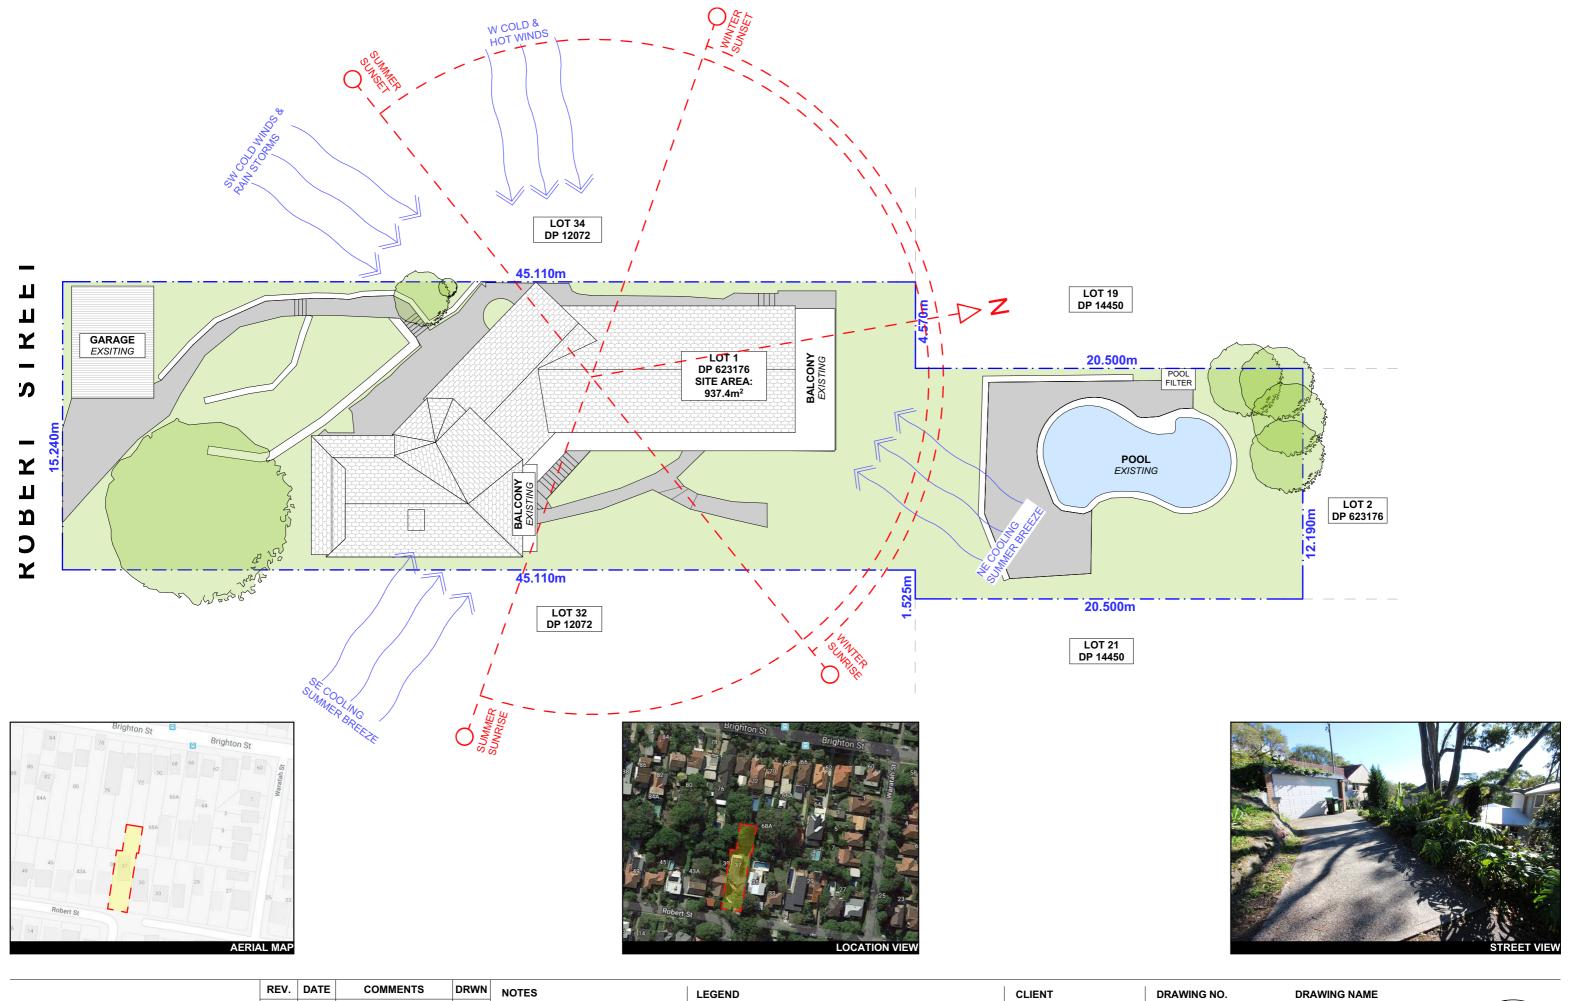



## **ACTION PLANS**

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	REV.	DATE	COMMENTS	DRWN
	А	19/07/2018	INITIAL DESIGN PLAN	DLR
	В	21/08/2018	FIRST DESIGN AMENDMENT	DLR
	С	17/09/2018	SECOND DESIGN AMENDMENT	DLR
J	D	24/10/2018	DRAFT DA SET	DLR
	E	06/03/2019	DA SET	WE

NOTES

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Do no scale on drawings. Use figured dimensions.



HARD SURFACE LANDSCAPE

CRAIG & NICOLE POOLE

#### PROJECT ADDRESS 39 ROBERT STREET,

FRESHWATER 2096

## **DA01**

Friday, 8 March 2019

DRAWING NAME


DATE


SCALE

1:200 @A3

SITE ANALYSIS



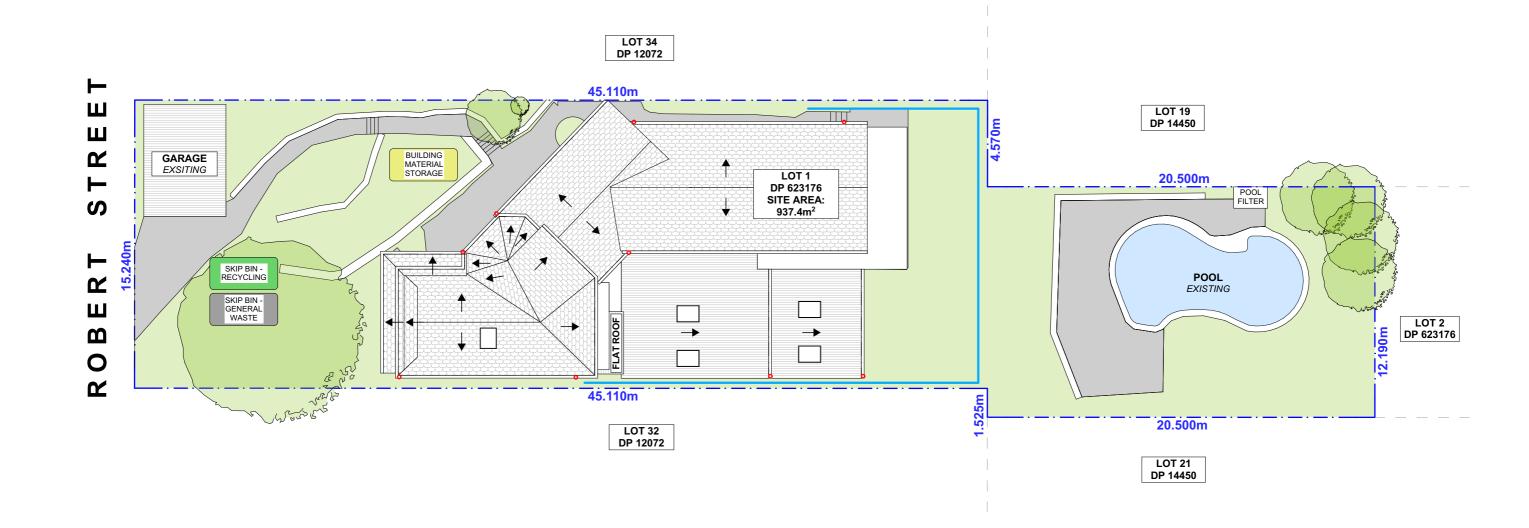

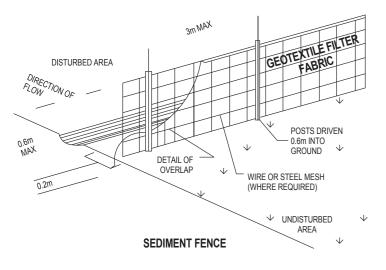

### SEDIMENT NOTE:

- 1. ALL EROSION AND SEDIMENT CONTROL MEASURES TO BE INSPECTED AND MAINTAINED DAILY BY THE SITE MANAGER.
- 2. MINIMISE DISTURBED AREAS, REMOVE EXCESS SOIL FROM EXCAVATEDAREA AS SOON AS POSSIBLE.
  3. ALL MATERIAL STOCKPILE TO BE CLEAR FROM DRAINS, GUTTERS AND FOOTPATHS, OR WITHIN
- SEDIMENT FENCE AREA.
  4. DRAINAGE TO BE CONNECTED TO STORMWATER AS SOON AS POSSIBLE. IF STORED ON SITE, IT MUST BE FILTERED BEFORE RELEASING INTO STORMWATER
- SYSTEM OR WATERWAYS.
  5. ROADS AND FOOTPATHS TO BE SWEPT DAILY.

#### STOCKPILES:

ALL STOCKPILES ARE TO BE KEPT ON-SITE WHERE POSSIBLE. ANY MATERIALS PLACED ON THE FOOTPATHS OR NATURE STRIPS REQUIRE COUNCIL'S PERMISSION.

ALL STOCKPILES ARE TO BE PLACED AWAY FROM THE DRAINAGE LINES AND STREET GUTTERS. IT IS BEST TO LOCATE THESE ON THE HIGHEST PART OF THE SITE IF POSSIBLE. PLACE WATERPROOF COVERING OVER STOCKPILES.

IF REQUIRED PROVIDE DIVERSION DRAIN & BANK AROUND STOCKPILES.

#### DUST CONTROL:

TO REDUCE DUST GENERATED BY WIND ACTION, THE REMOVAL OF THE TOP SOIL IS TO BE MINIMISED. TO PREVENT DUST GENERATION, WATERING DOWN OF THE SITE, ESPECIALLY DURING THE MOVEMENT OF MACHINERY IS REQUIRED. WHERE EXCAVATING INTO ROCK, KEEP THE SURFACE MOIST TO MINIMISE DUST. CONSTRUCT A GRAVEL ENTRY/EXIT POINT USING BLUE METAL AND RESTRICT ALL VEHICLE MOVEMENTS WITHIN THE SITE TO A MINIMUM. ENSURE WIND BREAKS, SUCH AS EXISTING FENCES ARE MAINTAINED DURING THE CONSTRUCTION PHASE UNTIL NEW LANDSCAPING IS PROVIDED OR REINSTATED. PREVENT DUST BY COVERING STOCKPILES

#### **GUTTER PROTECTION:**

PROVIDE PROTECTION TO DOWNHILL GRATE IN GUTTER BY MEANS OF SAND BAGS OR BLUE METAL WRAPPED IN GEOTEXTILE FABRIC. WHEN SOIL OR SAND BUILDS UP AROUND THIS SEDIMENT BARRIER, THE MATERIAL SHOULD BE RELOCATED BACK TO THE SITE FOR DISPOSAL.

NOTE: ALL PROPOSED STORMWATER TO CONNECT WITH EXISTING

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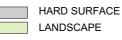
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#### LEGEND

0



FALL

SEDIMENT EROSION FENCE PROPOSED DOWNPIPE

## CLIENT

CRAIG & NICOLE POOLE

## PROJECT ADDRESS

39 ROBERT STREET, FRESHWATER 2096

#### DRAWING NO.

DA02

Friday, 8 March 2019


#### DATE


SITE / ROOF / SEDIMENT EROSION / WASTE MANAGEMENT / STORMWATER CONCEPT PLAN

DRAWING NAME

#### SCALE

1:200 @A3

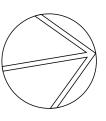

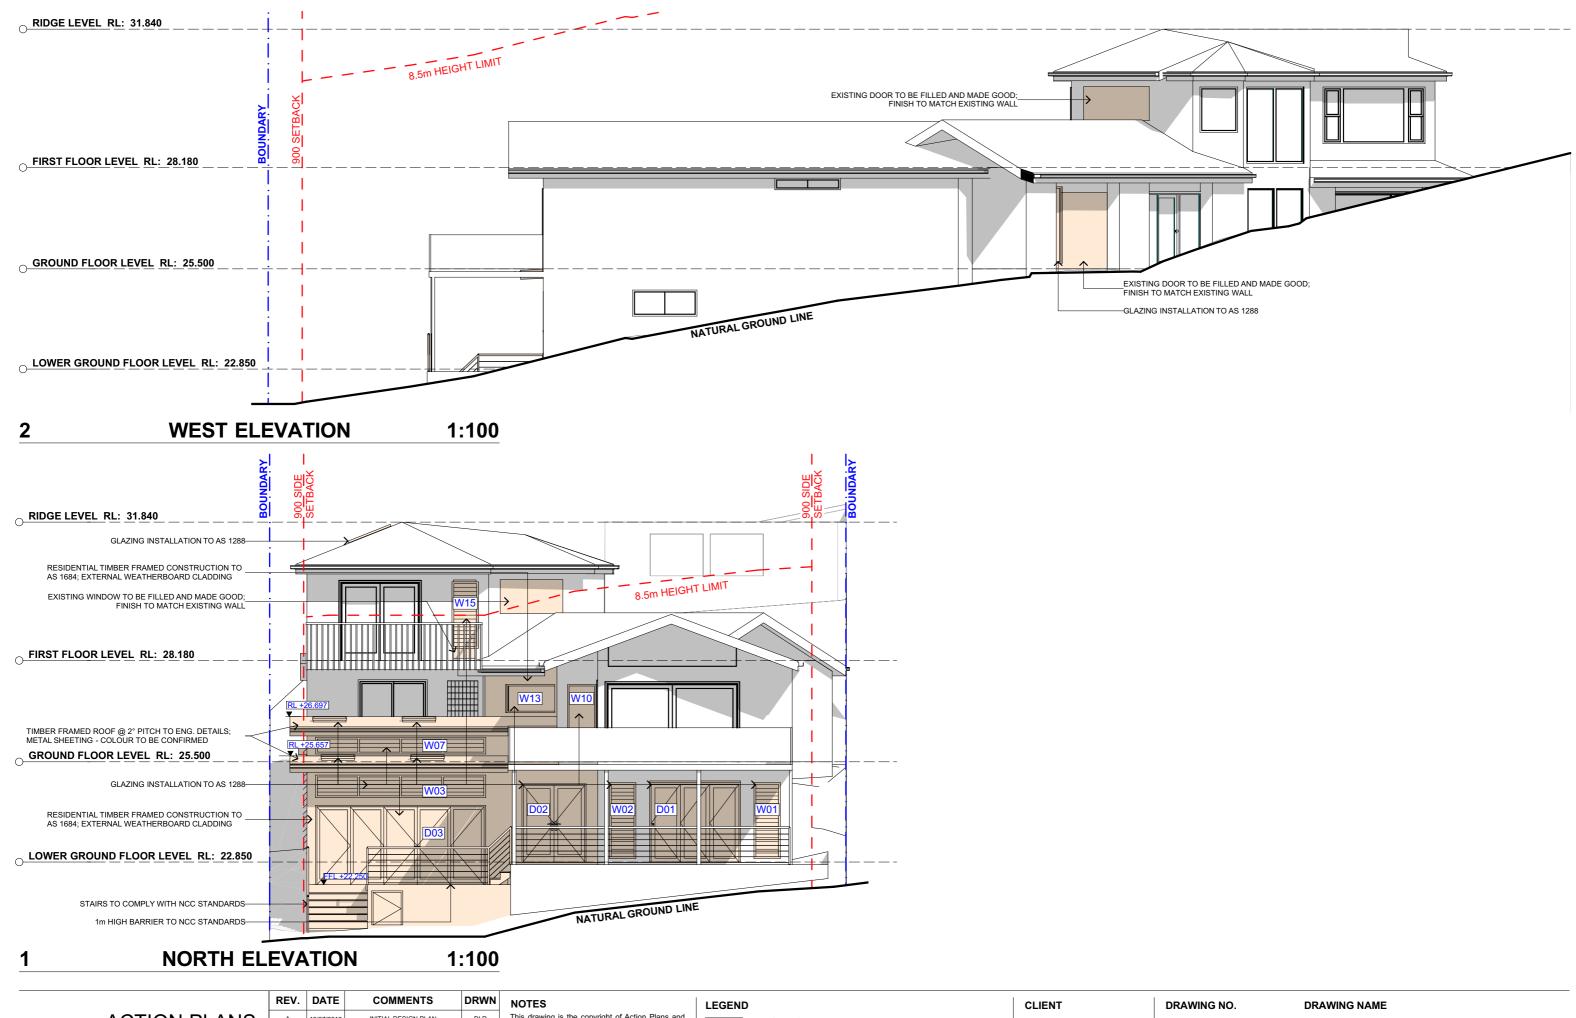



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EXISTING
PROPOSED

CRAIG & NICOLE POOLE

PROJECT ADDRESS
39 ROBERT STREET,

FRESHWATER 2096


DA09


DATE

NORTH / WEST ELEVATION

Friday, 8 March 2019 SCALE

1:100 @A3

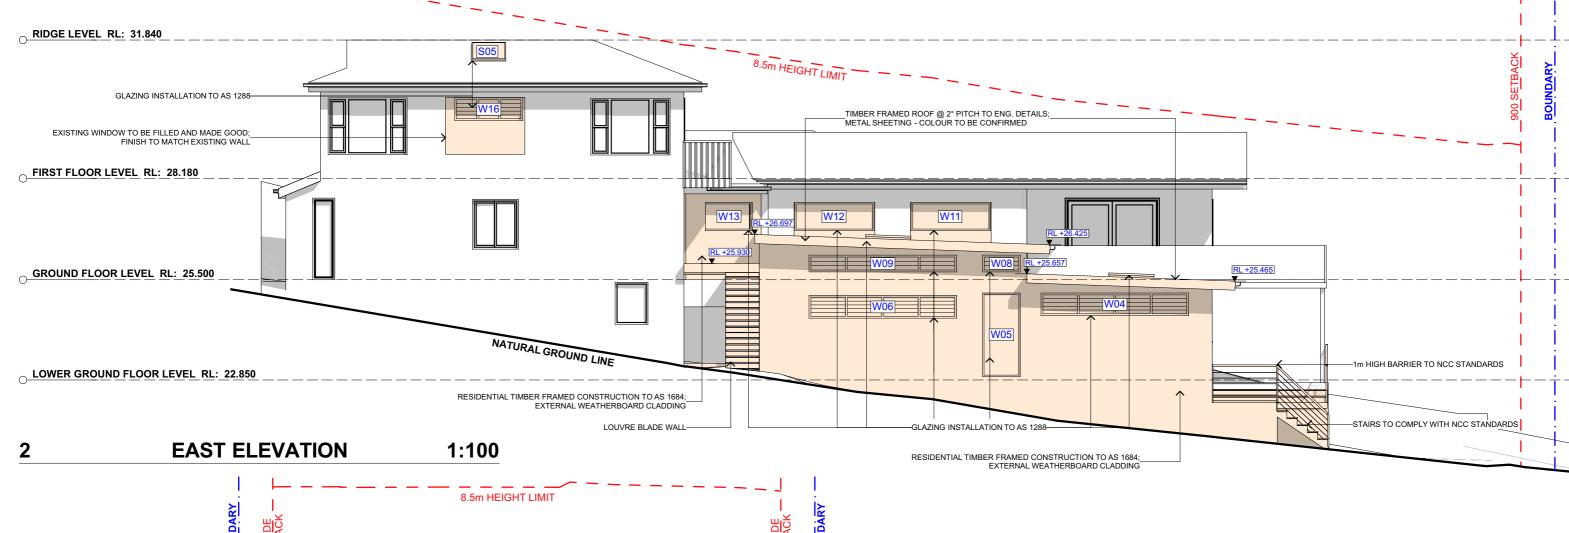

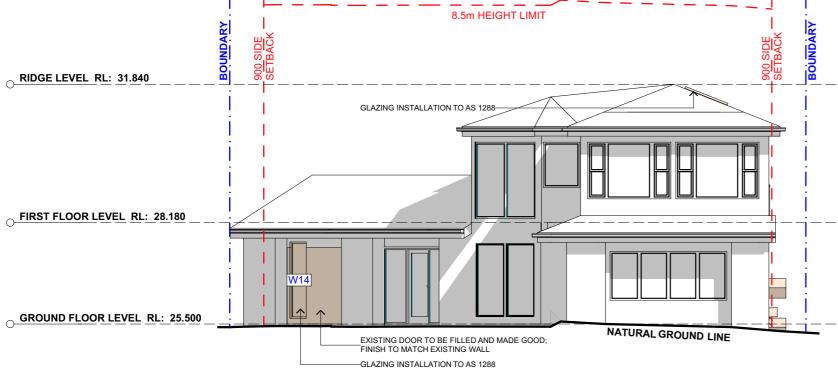

1 SOUTH ELEVATION 1:100

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compor	ients.
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LEGEND	
	EXISTING
	PROPOSED

CLIENT
CRAIG & NICOLE POOLE


PROJECT ADDRESS
39 ROBERT STREET,
EDESHWATED 2006

DA10


DATE

DATE Friday, 8 March 2019 DRAWING NAME
SOUTH / EAST ELEVATION

SCALE 1:100 @A3

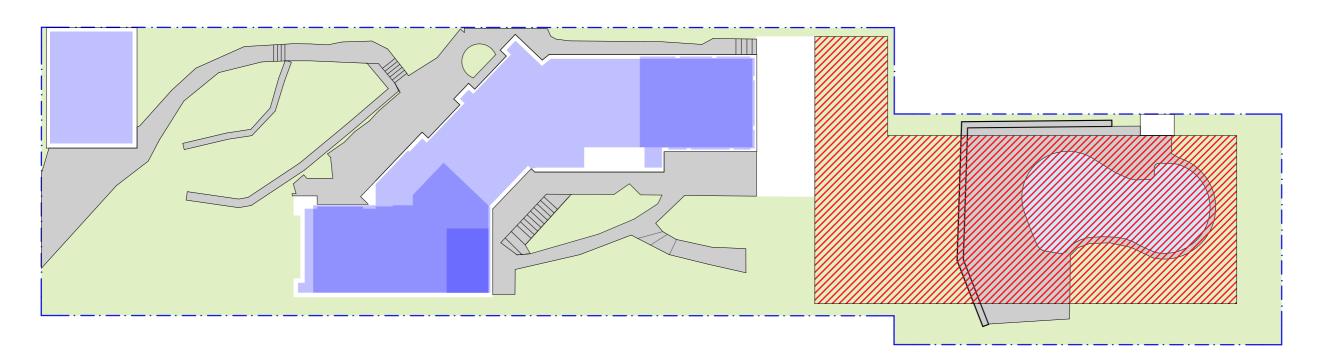

## **EXISTING AREA CALCULATIONS 1:200**

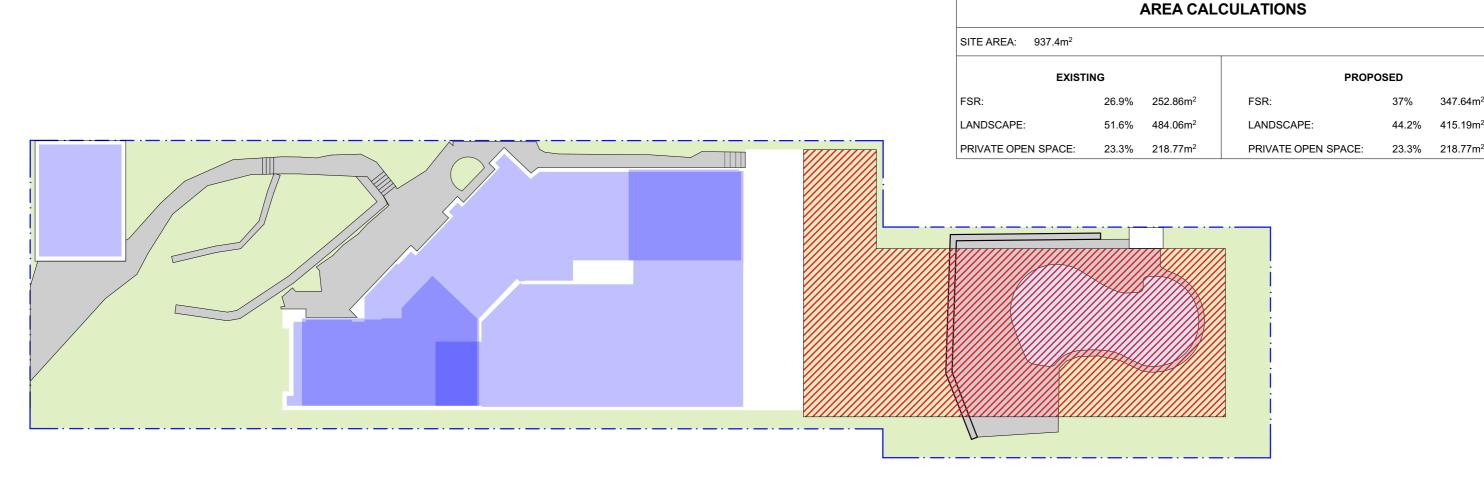

## **PROPOSED AREA CALCULATIONS 1:200**



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## CLIENT

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#### PROJECT ADDRESS 39 ROBERT STREET, FRESHWATER 2096

## **DA12**

DRAWING NO.


# AREA CALCULATIONS

DATE Friday, 8 March 2019

SCALE


1:200 @A3

DRAWING NAME

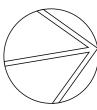

347.64m<sup>2</sup>

218.77m<sup>2</sup>

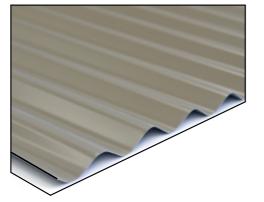






ALUMINIUM FRAMED WINDOWS BY STEGBAR



ALUMINIUM FRAMED DOORS
BY STEGBAR



LOUVRE BLADE WALL

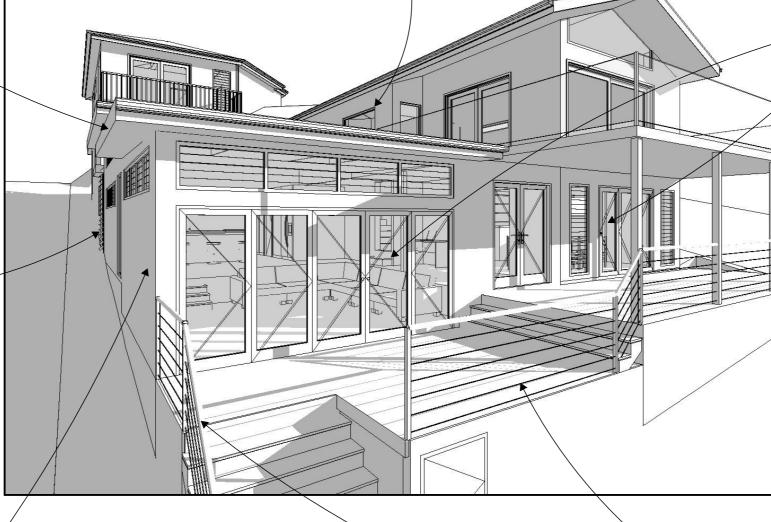

EXTERNAL WEATHERBOARD CLADDING; COLOUR TO BE CONFIRMED BY CLIENT



STAINLESS STEEL HAND RAIL

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PROJECT ADDRESS 39 ROBERT STREET,

FRESHWATER 2096

DRAWING NO.

**DA13** 


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Friday, 8 March 2019

DRAWING NAME SAMPLE BOARD

SCALE

@A3



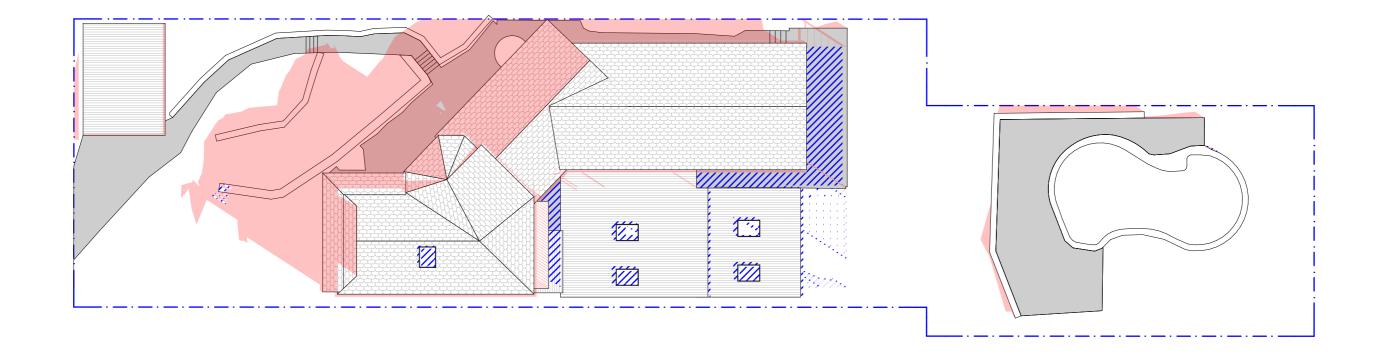

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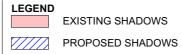
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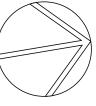
FRESHWATER 2096


DRAWING NO.

**DA14** 

DATE Friday, 8 March 2019 DRAWING NAME WINTER SOLSTICE 9 AM

SCALE 1:200 @A3



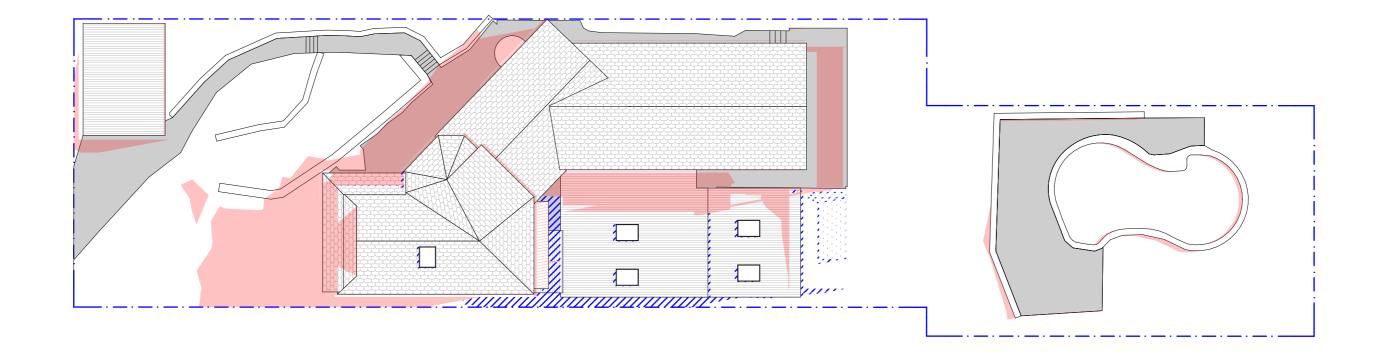



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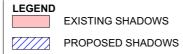
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PROJECT ADDRESS 39 ROBERT STREET, FRESHWATER 2096

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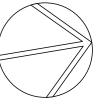
**DA15** 


DATE Friday, 8 March 2019

WINTER SOLSTICE 12 PM

DRAWING NAME

SCALE 1:200 @A3



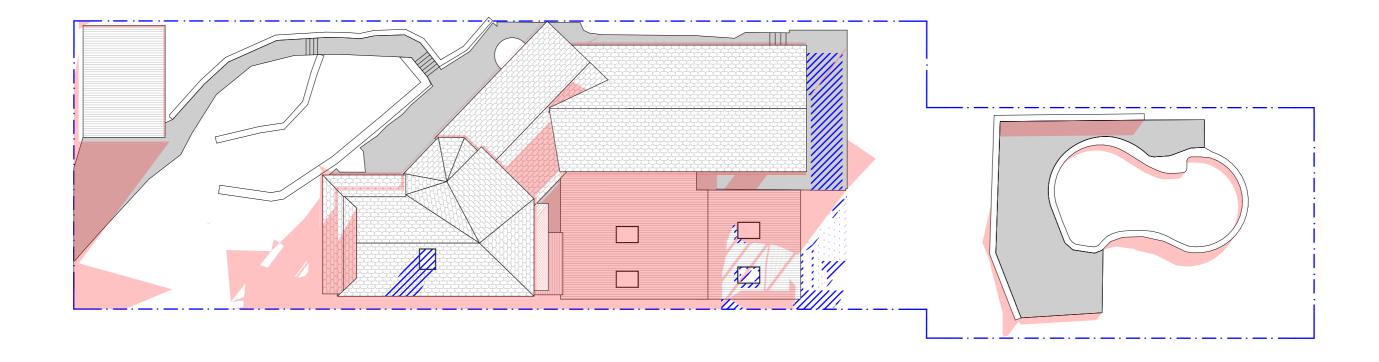



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CLIENT


CRAIG & NICOLE POOLE

PROJECT ADDRESS 39 ROBERT STREET, FRESHWATER 2096 DRAWING NO.

**DA16** 

DATE Friday, 8 March 2019 DRAWING NAME WINTER SOLSTICE 3 PM

SCALE 1:200 @A3

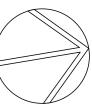



Building Sustainability Index www.basix.nsw.gov.au

#### Alterations and Additions

Certificate number: A331734 02

This certificate confirms that the proposed development will meet the NSW government's requirements for sustainability, if it is built in accordance with the commitments set out below. Terms used in this certificate, or in the commitments, have the meaning given by the document entitled "BASIX Alterations and Additions Definitions" dated 06/10/2017 published by the Department. This document is available at www.basix.nsw.gov.au

Secretary
Date of issue: Tuesday, 05, March 2019
To be valid, this certificate must be lodged within 3 months of the date of issue.



Project address	
Project name	0400_39 Robert St, Freshwater_02
Street address Local Government Area Plan type and number	39 Robert Street Freshwater 2096
Local Government Area	Warringah Council
Plan type and number	Deposited Plan 623176
Lot number	1
Section number	0
Project type	
Project type  Dwelling type  Type of alteration and	Separate dwelling house
Type of alteration and addition	My renovation work is valued at \$50,000 or more, and does not include a pool (and/or spa).
addition	

Certificate	Prepared	by (please complete before submitting to Council or PCA)	
Name / Company Name: Action Plans			
ABN (if appli	cable): 17118	3297587	

Fixtures and systems	Show on DA Plans	Show on CC/CDC Plans & specs	Certifier Check
Lighting			
The applicant must ensure a minimum of 40% of new or altered light fixtures are fitted with fluorescent, compact fluorescent, or light-emitting-diode (LED) lamps.		<b>~</b>	<b>~</b>
Fixtures	'	'	
The applicant must ensure new or altered showerheads have a flow rate no greater than 9 litres per minute or a 3 star water rating.		✓	V
The applicant must ensure new or altered toilets have a flow rate no greater than 4 litres per average flush or a minimum 3 star water rating.		<b>✓</b>	✓
The applicant must ensure new or altered taps have a flow rate no greater than 9 litres per minute or minimum 3 star water rating.		✓	

Construction			Show on DA Plans	Show on CC/CDC Plans & specs	Certifier Check
Insulation requirements					
The applicant must construct the new or altere the table below, except that a) additional insula is not required for parts of altered construction  Construction	·	~	✓		
Construction	Additional insulation required (R-value)	Other specifications			
suspended floor with enclosed subfloor: framed (R0.7).	R0.60 (down) (or R1.30 including construction)				

Legend
In these commitments, "applicant" means the person carrying out the development.
Commitments identified with a "/" in the "Show on DA plans" column must be shown on the plans accompanying the development application for the proposed development (if a

Commitments identified with a "v" in the "Show on CC/CDC plans & specs" column must be shown in the plans and specifications accompanying the application for a construction certificate / complying development certificate for the proposed development.

Commitments identified with a "v" in the "Certifier check" column must be certified by a certifying authority as having been fulfilled, before a final occupation certificate for the development may be issued.

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development application is to be lodged for the proposed development).

REV.	DATE	COMMENTS	DRWN
Α	19/07/2018	INITIAL DESIGN PLAN	DLR
В	21/08/2018	FIRST DESIGN AMENDMENT	DLR
С	17/09/2018	SECOND DESIGN AMENDMENT	DLR
D	24/10/2018	DRAFT DA SET	DLR
E	06/03/2019	DA SET	WE

### NOTES

This drawing is the copyright of Action Plans and not be altered, reproduced or transmitted in any form or by any means in part or in whole with the written permission of Action Plans.

All levels and dimensions are to be checked and verified on site prior to commencement of any work, making of shop drawings or fabrication of components.

Do no scale on drawings. Use figured dimensions.

LEGEND

Glazing requ	irements							Show on	Show on	Certifier
								DA Plans	CC/CDC Plans & specs	Check
Windows and glazed doors										
					ading devices, in accordate each window and glazed		the specifications listed in the table below.	~	~	~
The following requirements must also be satisfied in relation to each window and glazed door:									<b>~</b>	<b>~</b>
Each window or glazed door with improved frames, or pyrolytic low-e glass, or clear/air gap/clear glazing, or toned/air gap/clear glazing must have a U-value and a Solar Heat Gain Coefficient (SHGC) no greater than that listed in the table below. Total system U-values and SHGCs must be calculated in accordance with National Fenestration Rating Council (NFRC) conditions. The description is provided for information only. Alternative systems with complying U-value and SHGC may be substituted.									<b>~</b>	<b>~</b>
For projections described in millimetres, the leading edge of each eave, pergola, verandah, balcony or awning must be no more than 500 mm above the head of the window or glazed door and no more than 2400 mm above the sill.								✓	<b>✓</b>	✓
Pergolas with polycarbonate roof or similar translucent material must have a shading coefficient of less than 0.35.									_	<i></i>
Pergolas with fixed battens must have battens parallel to the window or glazed door above which they are situated, unless the pergola also									~	~
shades a perpendicular window. The spacing between battens must not be more than 50 mm.  Overshadowing buildings or vegetation must be of the height and distance from the centre and the base of the window and glazed door, as specified in the 'overshadowing' column in the table below.								~	~	~
Windows and glazed doors glazing requirements										
Window / door		Area of			Shading device		Frame and glass type			
no.		glass inc. frame	Height (m)	Distance (m)						
W01	N	(m2)	7	18.3	eave/verandah/pergola/	balcony	improved aluminium, single toned,			
	N	1.41	7	18.3	>=900 mm eave/verandah/pergola/balcony		(U-value: 6.39, SHGC: 0.56)			
W02			-		>=900 mm		improved aluminium, single toned, (U-value: 6.39, SHGC: 0.56)			
W03	N	2.7	3.8	26	eave/verandah/pergola/ >=750 mm	balcony	improved aluminium, single toned, (U-value: 6.39, SHGC: 0.56)			
W04	E	2.34	0	0	eave/verandah/pergola/ >=450 mm	balcony/	standard aluminium, single pyrolytic low-e,			
W05	E	2.1	0	0	eave/verandah/pergola/	balcony	(U-value: 5.7, SHGC: 0.47) standard aluminium, single pyrolytic low-e,			
W06	E	2.34	0	0	>=600 mm eave/verandah/pergola/	/halcony	(U-value: 5.7, SHGC: 0.47) standard aluminium, single pyrolytic low-e,			
					>=450 mm		(U-value: 5.7, SHGC: 0.47)			
W07	N	2	0	0	eave/verandah/pergola/ >=750 mm		improved aluminium, single toned, (U-value: 6.39, SHGC: 0.56)			
W08	E	2	0	0	eave/verandah/pergola/ >=450 mm	balcony	standard aluminium, single pyrolytic low-e, (U-value: 5.7, SHGC: 0.47)			
W09	E	0.44	0	0	eave/verandah/pergola/ >=450 mm	balcony/	improved aluminium, single toned, (U-value: 6.39, SHGC: 0.56)			
W10	N	1.53	0	0	eave/verandah/pergola/	balcony	improved aluminium, single toned,			
W11	E	1.56	1.6	8.3	>=900 mm eave/verandah/pergola/balcony		(U-value: 6.39, SHGC: 0.56) standard aluminium, single pyrolytic low-e,			
W12	E	1.56	1.6	8.3	>=900 mm eave/verandah/pergola/	balcony	(U-value: 5.7, SHGC: 0.47) standard aluminium, single pyrolytic low-e,			
W13	NE	1.34	0	0	>=900 mm eave/verandah/pergola/balcony		(U-value: 5.7, SHGC: 0.47) improved aluminium, single toned,			
					>=750 mm		(U-value: 6.39, SHGC: 0.56)			
W14	SW	1.21	0	0	eave/verandah/pergola/balcony >=750 mm		improved aluminium, single toned, (U-value: 6.39, SHGC: 0.56)			
W15	N	1.23	0	0	eave/verandah/pergola/balcony >=600 mm		improved aluminium, single toned, (U-value: 6.39, SHGC: 0.56)			
W16	E	1.08	0	0	eave/verandah/pergola/balcony >=450 mm		standard aluminium, single pyrolytic low-e, (U-value: 5.7, SHGC: 0.47)			
D01	N	5.04	0	0	eave/verandah/pergola/balcony		improved aluminium, single toned,			
D02	N	2 51	0	0	>=900 mm	/halaanu	(U-value: 6.39, SHGC: 0.56)			
D02		3.51			eave/verandah/pergola/balcony >=900 mm		improved aluminium, single toned, (U-value: 6.39, SHGC: 0.56)			
D03	N	9.45	0	0	eave/verandah/pergola/ >=900 mm	balcony	improved aluminium, single toned, (U-value: 6.39, SHGC: 0.56)			
Skylights										
The applicant must install the skylights in accordance with the specifications listed in the table below.								<b>✓</b>	<b>~</b>	<b>~</b>
The following requirements must also be satisfied in relation to each skylight:									<b>~</b>	<b>✓</b>
Each skylight may either match the description, or, have a U-value and a Solar Heat Gain Coefficient (SHGC) no greater than that listed in the table below.									<b>✓</b>	✓
External awnings and louvres must fully shade the skylight above which they are situated when fully drawn or closed.									<b>~</b>	<b>~</b>
Skylights glazing requirements										
Skylight number Area of glazing Shading device Frame and glass type inc. frame (m2)										
S01   1.026		external adjustable awning or blind			aluminium, moulded plastic single clear, (or U-value: 6.21, SHGC: 0.808)					
S02 1.026		external adjustable awning or blind			aluminium, moulded plastic single clear, (or U-value: 6.21, SHGC: 0.808)					
S03 1.026		external adjustable awning or blind			aluminium, moulded plastic single clear, (or U-value: 6.21, SHGC: 0.808)					
S04	S04 1.026		external	external adjustable awning or blind			aluminium, moulded plastic single clear, (or U-value:			
S05 1.026		external				6.21, SHGC: 0.808) aluminium, moulded plastic single clear, (or U-value:				
					i.21, SHG					
									1	

DRAWING NO. CLIENT CRAIG & NICOLE POOLE PROJECT ADDRESS

FRESHWATER 2096

**DA17** 

BASIX

DRAWING NAME

DATE 39 ROBERT STREET,

Friday, 8 March 2019 SCALE

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