

DA CALCULATIONS:		
TOTAL AREA	992.70	
MAX ALLOWABLE BUILT UPON AREA (BUA)	60%	
MIN ALLOWABLE LANDSCAPED OPEN SPACE (LOS) 40%	40%	
	100%	
BUA:		
House incl. deck, patio, porch	205.21	
Concrete driveway	60.34	
Front concrete path and step	8.99	
Side concrete path	30.03	
Pool Coping	8.32	
Paving	68.43	
Pool garden and filter	8.21	
Retaining walls and gardens	15.45	
Steps	5.98	
TOTAL BUILT UPON AREA (BUA)	410.96	= = 2
TOTAL BUA AS % OF TOTAL AREA	41.4%	
TOTAL LANDSCAPED OPEN SPACE (LOS)	581.75	*
TOTAL LOS AS % OF TOTAL AREA	58.6%	Complies with 1.
Warringah Council DCP		
1. D1 Minimum area of Landscaped Open Space (LOS): 40% of total	lot area	Complies.
2. D1 (1) (a) Any open space areas with a dimension of less than 2n	n	
is excluded from the calculation of LOS		Complies.
3. D1 (1) (b) The water surface of pools is included in the calculatio	n of LOS	
8 D4 /41 / 1100		Complies.
4. D1 (1) (c) LOS must be at ground level (finished)		

Boundary
Sewer
Sewer ZOI
Landscaped Open Space
Built Upon Area (BUA)

## NOTES:

- 1. This plan is not for construction purposes, indicative levels only/no engineering details provided
- 2. Do not scale from plan
- 3. The contractor shall be responsible for subgrade excavation and preparation to allow for top soil and mulch depth requirements, including stormwater engineer levels
- 4. All trees and large shrubs are to be staked as detailed on the planting schedule
- 5. Refer to Architects and Engineers site plans for precise information regarding finished levels, roadworks, drainage, fences and paving details
- 6. Before landscape work is commenced, contractor is to establish the position of all service lines, service lids; vents and hydrants shall be left exposed and not covered by any landscape finish (turfing, paving, mulch, garden beds etc)
- 7. All hard landscaping structures to be to Engineer's specifications
- 8. Mulch can be leaf mulch, ANL or similar, or gravel
- 9. All RLs, spot levels, boundaries and existing contours have been taken from survey plan by SurveyPlus dated 13/01/2022 Ref. 21184\_DET\_1A
- 10. Services to be located before excavation
- 11. VTA method used for Tree Assessment
- 12. Copyright of Urban & Rural Design
- 13. Surveyor's pegs to be installed before any built structures eg. retaining walls/pool constructed on boundaries/fences
- 14. Pool location and Sewerage ZOI as per Engineers Drawing by J. Cavasinni & Assoc. Drawing No. 2022PR1500 dated March 2022
- 15. When rear retaining wall removed for pool demolition, wall to front and around trees may fail.
- 16. All work to be done according to best practice guidelines, N.C.C., Australian Standards, manufacturers' specifications, Local Council and State Legislations





Client: Mr & Mrs Johnson 26 Orlando Road CROMER NSW 2099 DESIGN | LANDSCAPE ARCHITECTS Horticulture - Design - Consultation PO Box 56 GALSTON NSW 2159 ABN: 97 003 499 438 MOB: 0416 397 258 Drawing Purpose: D.A. RVA

Date: 21 March 2022

Scale: 1:200 @ A3 Drawn By: IF Checked By: AM

Plan No: Job No: 20211112

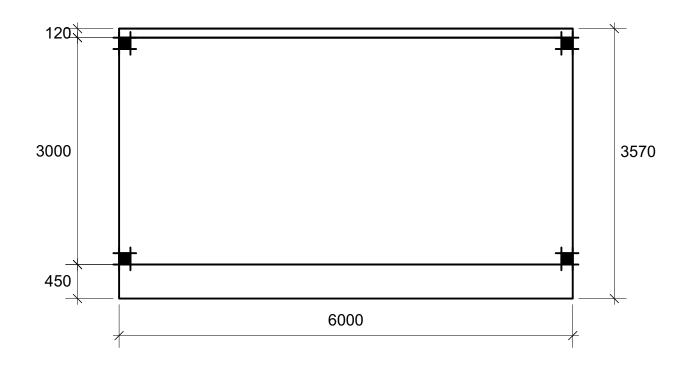

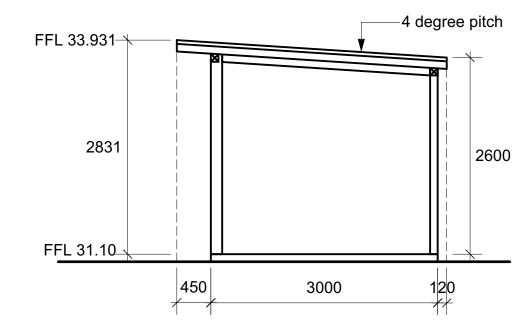



FLOOR PLAN SIDE ELEVATION

## NOTES

- 1. This plan is not for construction purposes, indicative levels only/no engineering details provided
- 2. DO NOT SCALE FROM PLAN
- The contractor shall be responsible for subgrade excavation and preparation to allow for top soil and mulch depth requirements, including stormwater engineer levels
- 4. All trees and large shrubs are to be staked as detailed on the planting schedule
- Refer to Architects and Engineers site plans for precise information regarding finished levels, roadworks, drainage, fences and paving details
- 6. Before landscape work is commenced, contractor is to establish the position of all service lines, service lids; vents and hydrants shall be left exposed and not covered by any landscape finish (turfing, paving, mulch, garden beds etc)
- 7. All hard landscaping structures to be to Engineer's specifications
- 8. Mulch can be leaf mulch, ANL or similar, or gravel
- All RLs, spot levels, boundaries and existing contours have been taken from survey plan by SurveyPlus dated 13/01/2022 Ref. 21184\_DET\_1A

- 10. Services to be located before excavation
- 11. VTA method used for Tree Assessment
- 12. Copyright of Urban & Rural Design
- Surveyor's pegs to be installed before any built structures eg. retaining walls/pool constructed on boundaries/fences
- 14a. Pool location, Sewerage ZOI and coping height as per Engineers Drawing by J. Cavasinni & Assoc. Drawing No. 2022PR1500 dated March 2022 for Pacific Pools
- 14b. New coping measurements from Bruce Read, Pacific Pools 25/03/2022
- 15. When rear retaining wall removed for pool demolition, wall to front and around trees may fail.
- All work to be done according to best practice guidelines, N.C.C., Australian Standards, manufacturers' specifications, Local Council and State Legislations
- 17. Australian Standard AS 1926 2012 applies for NCZ (Non Climbable Zone) to pool, to be maintained by client
- 18. Cubby and trampoline to be finally located as per manufacturer's safety instructions
- 19. Plant 'where able' on boundary and slopes
- 20. Measurements and levels for Pergola detail as supplied by Emanate & Co 12/04/2022

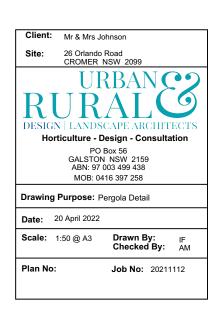


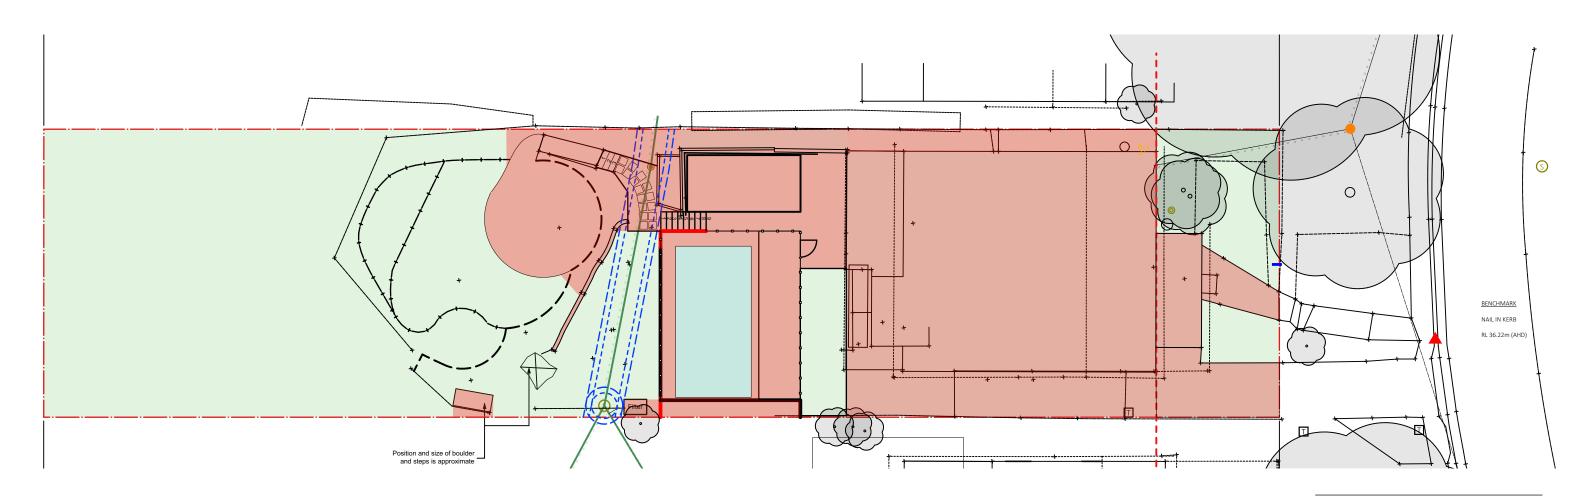

CALCULATIONS:		
TOTAL AREA	992.70	
MAX ALLOWABLE BUILT UPON AREA (BUA)	60%	
MIN ALLOWABLE LANDSCAPED OPEN SPACE (LOS)	40%	
	100%	
BUA:		
House incl. deck, patio, porch	205.21	
Concrete driveway	60.34	
Front concrete path and step	8.99	
Side concrete path	30.03	
Pool Coping	14.54	
Paving	61.65	
Pool garden and filter	8.48	
Retaining wall, gardens and stepping stones	30.48	
Rear steps	6.17	
Paved Fire Pit Area	31.90	
TOTAL BUILT UPON AREA (BUA)	457.79	
TOTAL BUA AS % OF TOTAL AREA	46.1%	
TOTAL LANDSCAPED OPEN SPACE (LOS)	534.91	
TOTAL LOS AS % OF TOTAL AREA	53.9%	Complies with 1.
Warringah Council DCP	33.370	complies with 1.
1. D1 Minimum area of Landscaped Open Space (LOS): 40% of to	tal lot area	Complies.
2. D1 (1) (a) Any open space areas with a dimension of less than	2m	-
is excluded from the calculation of LOS		Complies.
3. D1 (1) (b) The water surface of pools is included in the calculation of LOS		
4. D1 (1) (c) LOS must be at ground level (finished)		Complies.
5. D1 (1) (d) The min. soil depth of land that can be included in L	OS is 1m	Complies.

## NOTES:

- 1. This plan is not for construction purposes, indicative levels only/no engineering details provided
- 2. Do not scale from plan
- The contractor shall be responsible for subgrade excavation and preparation to allow for top soil and mulch depth requirements, including stormwater engineer levels
- 4. All trees and large shrubs are to be staked as detailed on the planting schedule
- Refer to Architects and Engineers site plans for precise information regarding finished levels, roadworks, drainage, fences and paving details
- 6. Before landscape work is commenced, contractor is to establish the position of all service lines, service lids; vents and hydrants shall be left exposed and not covered by any landscape finish (turfing, paving, mulch, garden beds etc)
- 7. All hard landscaping structures to be to Engineer's specifications
- 8. Mulch can be leaf mulch, ANL or similar, or gravel
- All RLs, spot levels, boundaries and existing contours have been taken from survey plan by SurveyPlus dated 13/01/2022 Ref. 21184\_DET\_1A
- 10. Services to be located before excavation
- 11. VTA method used for Tree Assessment
- 12. C copyright of Urban & Rural Design
- 13. Surveyor's pegs to be installed before any built structures eg. retaining walls/pool constructed on boundaries/fences
- 14a. Pool location, Sewerage ZOI and coping height as per Engineers Drawing by J. Cavasinni & Assoc. Drawing No. 2022PR1500 dated March 2022 for Pacific Pools
- 14b. New coping measurements from Bruce Read, Pacific Pools 25/03/2022
- 15. When rear retaining wall removed for pool demolition, wall to front and around trees may fail.
- All work to be done according to best practice guidelines, N.C.C., Australian Standards, manufacturers' specifications, Local Council and State Legislations
- 17. Australian Standard AS 1926 2012 applies for NCZ (Non Climbable Zone) to pool, to be maintained by client
- 18. Cubby and trampoline to be finally located as per manufacturer's safety instructions
- 19. Plant 'where able' on boundary and slopes
- 20. Measurements and levels for Pergola detail as supplied by Emanate & Co 12/04/2022

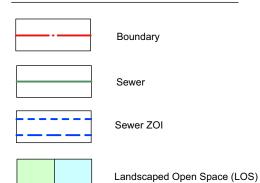




LEGEND:

Built Upon Area (BUA)





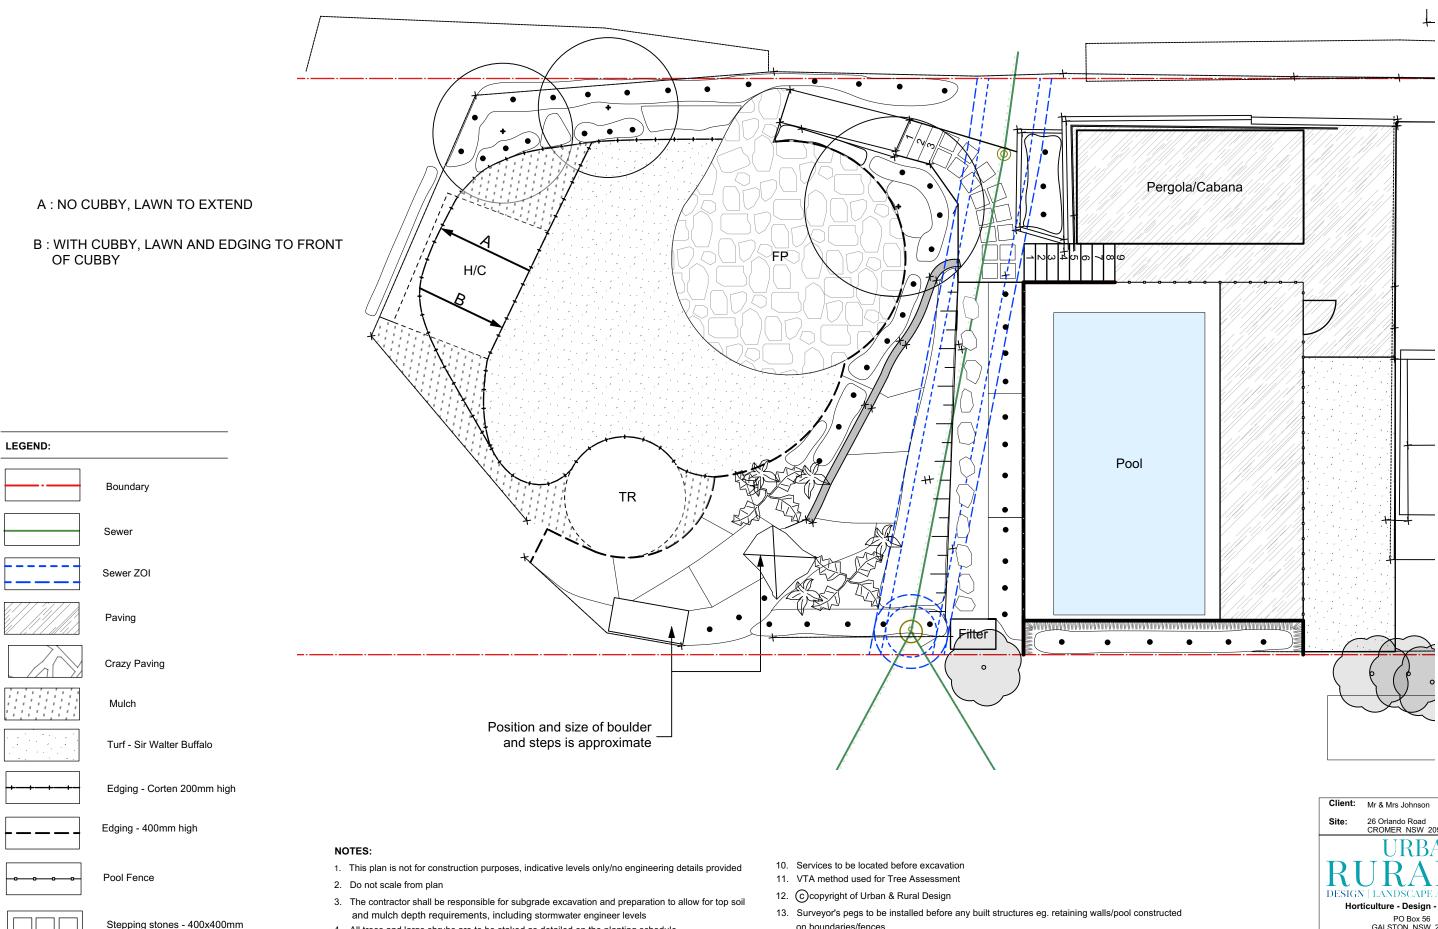

- and mulch depth requirements, including stormwater engineer levels
- 4. All trees and large shrubs are to be staked as detailed on the planting schedule
- 5. Refer to Architects and Engineers site plans for precise information regarding finished levels, roadworks, drainage, fences and paving details
- 6. Before landscape work is commenced, contractor is to establish the position of all service lines, service lids; vents and hydrants shall be left exposed and not covered by any landscape finish (turfing, paving, mulch, garden beds etc)
- 7. All hard landscaping structures to be to Engineer's specifications
- 8. Mulch can be leaf mulch, ANL or similar, or gravel

with Dichondra repens between

**Existing Retaining Wall** 

Trampoline

Herbs or Cubby

Fire Pit

TR


H/C

9. All RLs, spot levels, boundaries and existing contours have been taken from survey plan by SurveyPlus dated 13/01/2022 Ref. 21184\_DET\_1A

- 14a. Pool location, Sewerage ZOI and coping height as per Engineers Drawing by J. Cavasinni & Assoc. Drawing No. 2022PR1500 dated March 2022 for Pacific Pools
- 14b. New coping measurements from Bruce Read, Pacific Pools 25/03/2022
- 15. When rear retaining wall removed for pool demolition, wall to front and around trees may fail.
- 16. All work to be done according to best practice guidelines, N.C.C., Australian Standards, manufacturers' specifications, Local Council and State Legislations
- 17. Australian Standard AS 1926 2012 applies for NCZ (Non Climbable Zone) to pool, to be maintained
- 18. Cubby and trampoline to be finally located as per manufacturer's safety instructions
- 19. Plant 'where able' on boundary and slopes
- 20. Measurements and levels for Pergola detail as supplied by Emanate & Co 12/04/2022

DESIGN | LANDSCAPE ARCHITECTS Horticulture - Design - Consultation PO Box 56 GALSTON NSW 2159 ABN: 97 003 499 438 MOB: 0416 397 258 Drawing Purpose: Concept Plan Date: 28 April 2022 Drawn By: IF Checked By: AM Scale: 1:100 @ A3 Plan No: **Job No:** 20211112



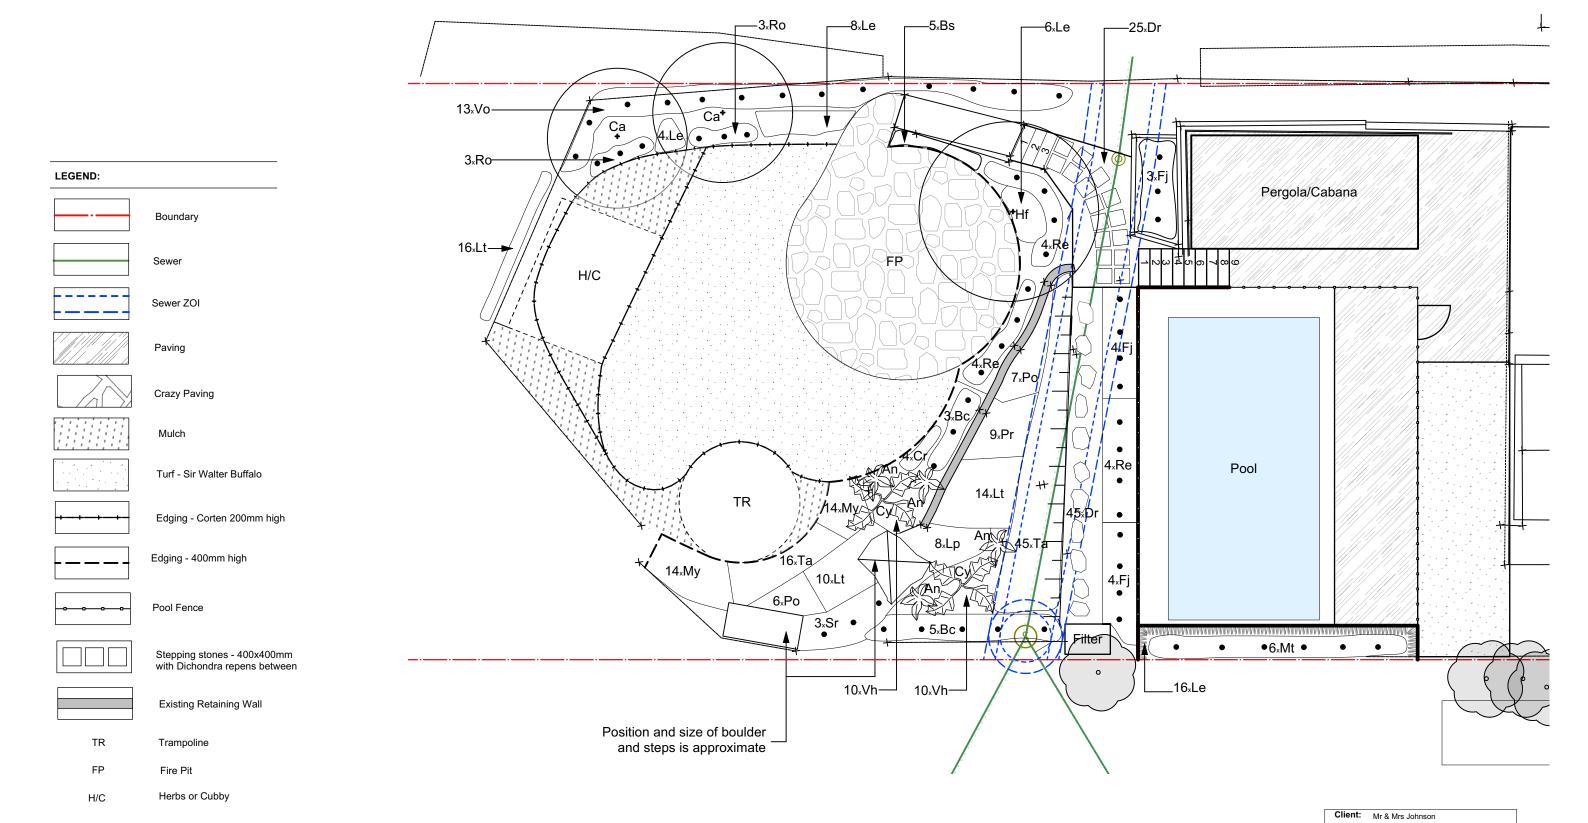

- 1. This plan is not for construction purposes, indicative levels only/no engineering details provided
- 2. Do not scale from plan
- 3. The contractor shall be responsible for subgrade excavation and preparation to allow for top soil and mulch depth requirements, including stormwater engineer levels
- 4. All trees and large shrubs are to be staked as detailed on the planting schedule
- 5. Refer to Architects and Engineers site plans for precise information regarding finished levels, roadworks, drainage, fences and paving details
- 6. Before landscape work is commenced, contractor is to establish the position of all service lines, service lids; vents and hydrants shall be left exposed and not covered by any landscape finish (turfing, paving, mulch, garden beds etc)
- 7. All hard landscaping structures to be to Engineer's specifications
- 8. Mulch can be leaf mulch, ANL or similar, or gravel
- 9. All RLs, spot levels, boundaries and existing contours have been taken from survey plan by SurveyPlus dated 13/01/2022 Ref. 21184\_DET\_1A

- 10. Services to be located before excavation
- 11. VTA method used for Tree Assessment
- 12. Copyright of Urban & Rural Design
- 13. Surveyor's pegs to be installed before any built structures eg. retaining walls/pool constructed
- 14a. Pool location, Sewerage ZOI and coping height as per Engineers Drawing by J. Cavasinni & Assoc. Drawing No. 2022PR1500 dated March 2022 for Pacific Pools
- 14b. New coping measurements from Bruce Read, Pacific Pools 25/03/2022
- 15. When rear retaining wall removed for pool demolition, wall to front and around trees may fail.
- 16. All work to be done according to best practice guidelines, N.C.C., Australian Standards, manufacturers' specifications, Local Council and State Legislations
- 17. Australian Standard AS 1926 2012 applies for NCZ (Non Climbable Zone) to pool, to be maintained by client
- 18. Cubby and trampoline to be finally located as per manufacturer's safety instructions
- Plant 'where able' on boundary and slopes
  Measurements and levels for Pergola detail as supplied by Emanate & Co 12/04/2022



26 Orlando Road CROMER NSW 2099



