


# 5 Sames Close, Mona Vale 2103

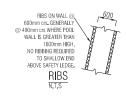


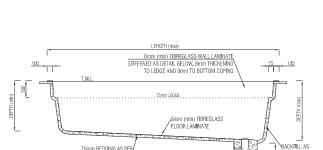

TYPICAL LONGITUDINAL SECTION

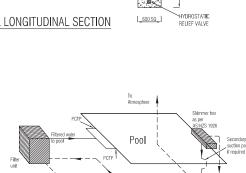

PER AS/NZS 1839

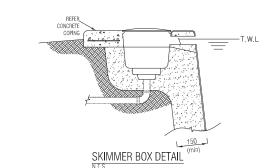

LENGTH

7.0m

Maximum Depth 1.66m Minimum Depth 1.28m

Volume 26,500ltrs

POOL PLAN - REFLECTION

75mm BEDDING AS PER

AS/NZS 1839

TYPICAL CROSS SECTION

3.8m


BACKFILL AS

PER AS/NZS 1839

CONCRETE

3-L11TM or 3-BAR 8Ø WITH 1-D12 EACH SIDE

COPING DETAIL

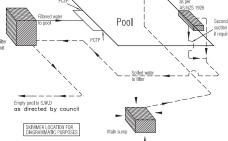

## WATER RETICULATION FLOW DIAGRAM

ALL FILTRATION PIPES TO BE 40mm (min) PVC CLASS 9 PIPES AND ALL FITTINGS CLASS 18.

- REFLECTION POOL RANGE LENGTH WIDTH DEPTH (max) DEPTH (min) 6000 3500 1600 1280 7000 3800 1660 1280 3800 8000 1720 1280 9000 3800 1780 1280 10000 3800 1840 1280
- \* All measurements are mm.

### GRP SHELL MANUFACTURE

- A. THE FIBREGLASS SHELL SHALL BE MANUFACTURED IN ACCORDANCE WITH AS/NZS 1838 (PRE-MOULDED FIBRE REINFORCED PLASTIC
- C. SHELL SHALL BE SPRAY MOULDED WITH:
- . 0.8mm GEL COAT (NPG).
- 2.0mm BARRIER COAT (VINYL ESTER).
- STRUCTURAL LAYER WHICH WILL GIVE TOTAL BARRIER/STRUCTURAL THICKNESS NOMINATED ON DRAWING.
- D. ALL LAYERS SHALL BE ROLLED OUT TO COMPLETELY BOND REINFORCING & RESINS & EXPEL AIR.
- E. STRUCTURAL LAMINATE SHALL HAVE MINIMUM
  - . FLEXURAL STRENGTH OF 110 MPa.
  - . TENSILE STRENGTH OF 60 MPa.
  - . MODULUS ELASTICITY OF 6200 MPa.

FOUNDATIONS

- A. ALL TOPSOIL & ORGANIC MATTER UNDER POOL FLOOR IS TO BE REMOVED. THE DESIGN REQUIRES THAT THE FOUNDATION MATERIAL IS TO BE UNIFORM SOUND NATURAL GROUND WITH A MINIMUM BEARING CAPACITY OF 50 kPa.
- B. THIS POOL IS SUITABLE FOR SOIL CLASSIFICATIONS OF A, S, M SITES.
- C. FOR SOIL CLASSIFICATIONS OF 'H' & 'E' SITES REFER TO CERTIFICATION LETTER FOR REQUIRED ADJUSTMENTS.
- D. ALL SOIL CLASSIFICATIONS OF 'P' SITES SHALL BE REFERED TO AN ENGINEER.


### **I**NSTALLATION

- A. THE POOL SHALL BE INSTALLED IN ACCORDANCE WITH THE REQUIREMENTS OF AS/NZS 1839 & THIS SPECIFICATION.
- B. CONCRETE TO CONCOURSE SHALL BE 20 MPa (min), WITH 20mm AGGREGATE & 100±10 SLUMP - TYPE A CEMENT, COMPACT CONCRETE THOROUGHLY AROUND SKIMMER & UNDER COPING FLANGE.
- C. REINFORCING STEEL: 3-L11TM or 3-BAR 8Ø WITH 1-D12 EACH SIDE
- D. TOLERANCES SHALL BE IN ACCORDANCE WITH AS/NZS 1838.
- E. PLUMBING SHALL BE 400 PRESSURE LINES AND 500 SUCTION LINES CLASS 9 PIPE AND CLASS 18 FITTINGS. PRIME ALL JOINTS BEFORE APPLYING SOLVENT.


#### OPERATION


A. THE POOL SHELL MAY BE DAMAGED IF THE POOL WATER IS DROPPED BELOW NORMAL OPERATING LEVEL. CONSULT THE INSTALLATION CONTRACTOR PRIOR TO EMPTYING THE POOL.


DRAWING REVISIONS				REFERENCE DRAWINGS		COPYRIGHT	5	IGNED APPRO	VAL	Summermore	Ptv	Ltd		PROJECT Character of Data 14 (5)	
						THESE DESIGNS, PLANS AND INFORMATION ARE	APPROVED	Y//	2014 4 0 202	Consulting Engineers				Structural Details(Fibreglass Swim	ming Pool)
E	REVISED AS PER CLIENTS REQUEST	GAB	MAY2020			COPYRIGHT AND ARE NOT TO BE USED OR	2000	6715	30MAR202	ACN: 108 898 433				TITLE	
D	REVISED AS PER CLIENTS REQUEST	GAB	OCT2016			REPRODUCED WHOLLY	RPEU	6/15		ABN: 42 108 898 433		¬/		REFLECTION	
С	REVISED AS PER CLIENTS REQUEST	GAB	OCT2014			OR IN PART OR TO BE USED ON ANY PROJECT	REVIEWED			ron@summermore.com.au	- 11	- 1		REFLECTION	
В	REVISED AS PER CLIENTS REQUEST	GAB	JUL2014			WITHOUT THE WRITTEN	DESIGNED	RAB	MAR2020	www.summermore.com.au	- 11	1	FISHER POOLS		
A	REVISED AS PER CLIENTS REQUEST	GAB	MAY2014			SUMMERMORE PTY LTD	DRAWN	GAB	MAR2020	PO Box 1671	Ш	/	LEISURE POOLS	DRAWING NUMBER	REV
-	PRELIMINARY FOR CLIENT APPROVAL	GAB	APR2014			DO NOT SCALE FROM	SCALE	AS SHOWN		Browns Plains BC, QLD, 4118 Phone: 07 3800 0973			SWIMMING IN QUALITY AND STYLE	14-7287-S08	
REV	DESCRIPTION	BY	DATE	DRAWING NAME	TITLE	THESE DRAWINGS.	ORIG	ORIGINAL DRAWING SIZE at A3		Fax: 07 3800 1860	$\sim$			14-7207-300	-
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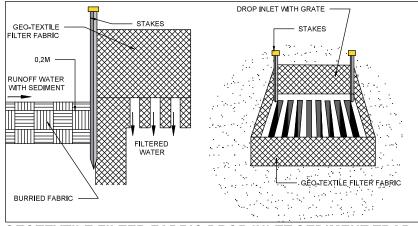

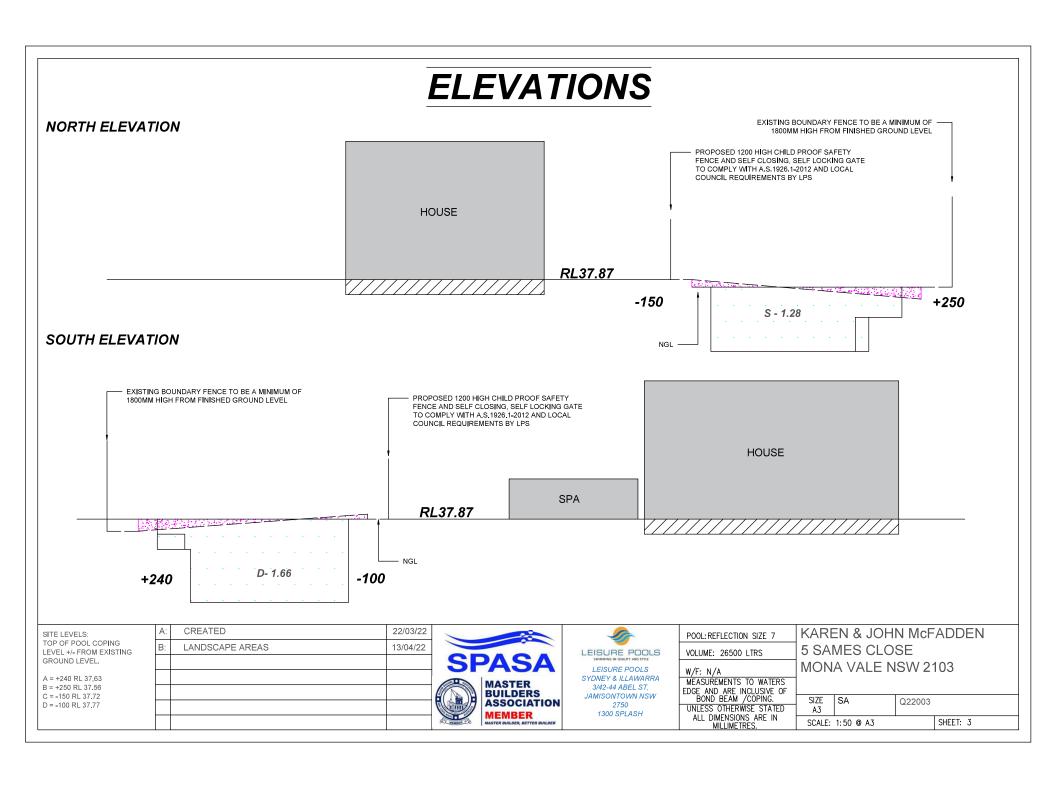
### **ELEVATIONS EAST ELEVATION** EXISTING BOUNDARY FENCE TO BE A MINIMUM OF -1800MM HIGH FROM FINISHED GROUND LEVEL PROPOSED 1200 HIGH CHILD PROOF SAFETY FENCE AND SELF CLOSING, SELF LOCKING GATE TO COMPLY WITH A.S. 1926, 1-2012 AND LOCAL COUNCIL REQUIREMENTS BY LPS HOUSE RL37.87 S - 1.28 -100 -150 **WEST ELEVATION** EXISTING BOUNDARY FENCE TO BE A MINIMUM OF 1800MM HIGH FROM FINISHED GROUND LEVEL PROPOSED 1200 HIGH CHILD PROOF SAFETY -FENCE AND SELF CLOSING, SELF LOCKING GATE HOUSE TO COMPLY WITH A.S. 1926.1-2012 AND LOCAL COUNCIL REQUIREMENTS BY LPS RL37.87 S - 1.28 NGL -D- 1.66 +250 +240 KAREN & JOHN McFADDEN CREATED 22/03/22 SITE LEVELS: POOL: REFLECTION SIZE 7 TOP OF POOL COPING LANDSCAPE AREAS 13/04/22 **5 SAMES CLOSE** LEVEL +/- FROM EXISTING LEISURE POOLS VOLUME: 26500 LTRS GROUND LEVEL. MONA VALE NSW 2103 LEISURE POOLS W/F: N/A A = +240 RL 37.63 SYDNEY & ILLAWARRA MEASUREMENTS TO WATERS B = +250 RL 37.56 3/42-44 ABEL ST, EDGE AND ARE INCLUSIVE OF BOND BEAM /COPING. **BUILDERS** C = -150 RL 37.72 JAMISONTOWN NSW SIZE SA ASSOCIATION Q22003 D = -100 RL 37,77 2750 UNLESS OTHERWISE STATED Α3 1300 SPLASH MEMBER ALL DIMENSIONS ARE IN MILLIMETRES. SHEET: 4 SCALE: 1:50 @ A3



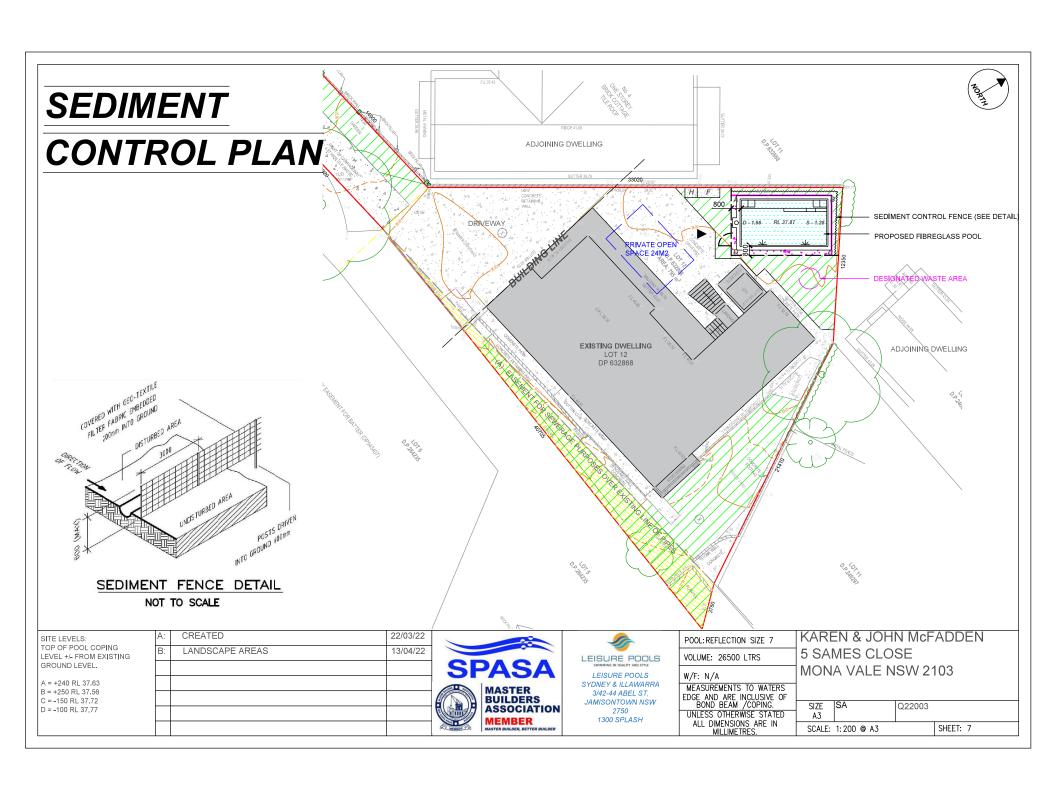


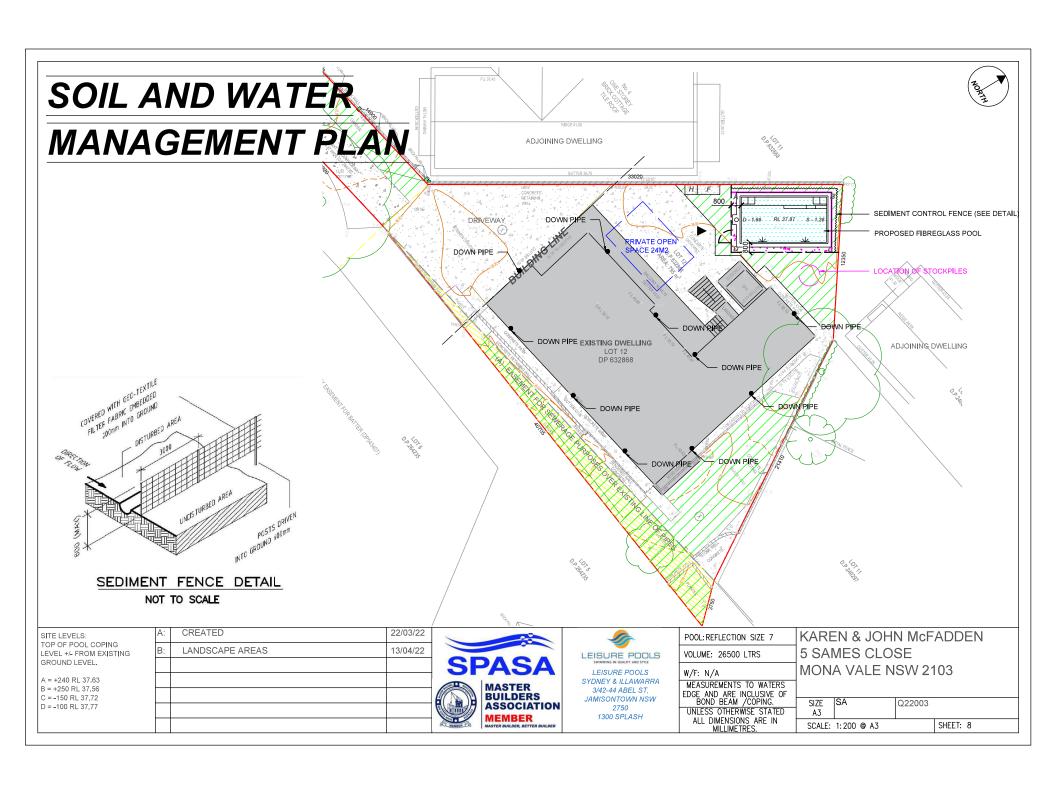

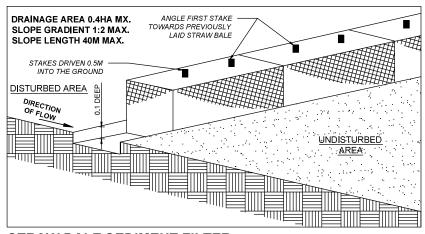

GEOTEXTILE FILTER FABRIC DROP INLET SEDIMENT TRAP

### STRAW BALE SEDIMENT FILTER

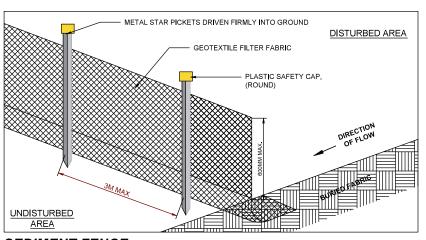

### STOCKPILE CONTROL

GEO-TEXTILE FABRIC SHALL BE PLACED ON THE BOUNDARY OF THE SITE TO PREVENT SEDIMENT WASHING FROM THE SITE INTO COUNCILS STORM WATER SYSTEM.

### EROSION/DUST CONTROL

WHERE THERE IS THE POTENTIAL OF THE SITE EROSION TO PRODUCE EXCESSIVE SEDIMENT RUNOFF, SUITABLE GEO-TEXTILE AND HAY BALE BARRIERS SHALL BE PLACED TO ALLEVIATE THE RISK ACCORDINGLY. BARE SURFACES SHALL BE KEPT MOIST IN THE EVENT THAT COUNCIL DUST LEVEL REGULATIONS MAY BE EXCEEDED. GEO-TEXTILE FABRIC LOCATED ON THE INSIDE OF FENCES SHALL ALSO BE UTILIZED FOR DUST CONTROL WHERE NECESSARY.

### STOCKPILE CONTROL

STOCKPILE AREAS SHALL BE ALLOCATED WITHIN THE SITE IN ADVANCES TO AVOID STOCKPILING OF MATERIAL ON PAVEMENT, VERGE AND ROAD SURFACES.

### RUBBISH DISPOSAL

ALL RUBBISH SHALL BE CONTAINED IN THE READE WASTE AREA NOMINATED ON SITE PLAN. PUBLIC PROPERTY WILL BE KEPT FREE OF RUBBISH AT ALL TIMES.

### SEDIMENT FENCE

### NOTE:

- 1. SILT/SEDIMENT CONTROL MEASURES ARE TO BE IN PLACE PRIOR TO ANY EXCAVATION OR CONSTRUCTION WORK.
- 2. ALL EROSION AND SEDIMENTATION CONTROL MEASURES, INCLUDING RE-VEGETATION AND STORAGE OF SOIL AND TOPSOIL, SHALL BE IMPLEMENTED TO THE STANDARDS OF THE SOIL CONSERVATION OF NSW AND INSPECTED DAILY BY THE SITE MANAGER.
- 3, ALL DRAINAGE WORKS SHALL BE CONSTRUCTED AND STABILIZED AS EARLY AS POSSIBLE DURING DEVELOPMENT.
- 4. SEDIMENT TRAPS SHALL BE CONSTRUCTED AROUND ALL INLET PITS, CONSISTING OF 300MM WIDE X 300MM DEEP TRENCH.

- 5. ALL SEDIMENT BASINS AND TRAPS SHALL BE CLEANED WHEN THE STRUCTURES ARE A MAXIMUM OF 90% FULL OF SOIL MATERIALS, INCLUDING THE MAINTENANCE PERIOD.
- 6. ALL DISTURBED AREAS SHALL BE RE-VEGETATED AS SOON AS THE RELEVANT WORKS ARE COMPLETED.
- 7. SOIL AND TOPSOIL STOCKPILED SHALL BE LOCATED AWAY FROM DRAINAGE LINES AND AREA WHERE WATER MAY CONCENTRATE. ALL ROADS AND FOOTPATHS TO BE SWEPT DAILY.
- 8. FILTER SHALL BE CONSTRUCTED BY STRETCHING A FILTER FABRIC. PROPEX OF APPROVED EQUIVALENT BETWEEN POST AT 3.0M CENTERS. FABRIC SHALL BE BURIED 150MM ALONG ITS LOWER EDGE.
- 9. DUST PREVENTION MEASURES TO BE MAINTAINED AT ALL TIMES.

