MIXED USE DEVELOPMENT 35-43 BELGRAVE STREET MANLY, NSW 2095

CIVIL DRAWING LIST

C000 COVER SHEET
C001 STANDARD NOTES

C402 DRAINAGE LAYOUT GROUND LEVEL

C405 DRAINAGE DETAILS
C406 OSD DETAILS



LOCALITY PLAN

NTS

REVISIONS:			SCALE BAR		
E	FOR S.455 APPROVAL	AB	11.10.24	COPYRIGHT © THIS DRAWING IS COPYRIGHT AND THE PROPERTY OF VAN DER MEER	WHERE THE DRAWING HAS BEEN ALTERED. AMENDED OR CHANGED
D	FOR TENDER	VB	05.08.24	(NSW) PTY LTD. IT MUST NOT BE RETAINED, COPIED OR USED WITHOUT	EITHER MANUALLY OR ELECTRONICALLY BY ANY THIRD PARTY.
С	FOR COORDINATION	VB	30.07.24	THE AUTHORITY OF VAN DER MEER (NSW) PTY LTD. DISCLAIMER	NOTE THIS IS AN UNCONTROLLED DOCUMENT ISSUED FOR INFORMATION
В	FOR COORDINATION	VB	28.06.24	THIS DRAWING AND ITS CONTENTS ARE ELECTRONICALLY GENERATED, ARE CONFIDENTIAL AND MAY ONLY BE USED FOR THE PURPOSE FOR	PURPOSES ONLY, UNLESS SIGNED. FIGURED DIMENSIONS TAKE PRECEDENCE OVER SCALED. DO NOT SCALE REDUCED SIZE DRAWINGS.
A	FOR APPROVAL	YK	10.07.23	WHICH THEY WERE INTENDED. VAN DER MEER (NSW) PTY LTD. WILL NOT ACCEPT RESPONSIBILITY FOR ANY CONSEQUENCES ARISING FROM THE	VERIFY DIMENSIONS PRIOR TO COMMENCING ANY ON-SITE OR OFF-SITE WORKS OR FABRICATION.
No.	REVISION DESCRIPTION	DRAWN	DATE	USE OF THE DRAWING FOR OTHER THAN ITS INTENDED PURPOSE OR	IF IN DOUBT - ASK.




Telephone 61-2-9436 0433 Fax 61-2-9436 1370 A.B.N. 56 158 266 301


TIME & PLACE PTY LTD
74 KING STREET, NEWTOWN NSW 2042

	MANLY, NSW 2095
SJB ARCHITECTS	COVER SHEET
LEVEL 2 490 CROWN STREET, SURRY HILLS, NSW 2010	


ROJECT TITLE	DRAWING STATUS
RESIDENTIAL DEVELOPMENT	
35-43 BELGRAVE STREET	NO
MANLY, NSW 2095	PROJECT LEADER AW
RAWING TITI F	DRAFTSPERSON


APPROVAL ISSUE NOT TO BE USED FOR CONSTRUCTION							
JECT LEADER	DESIGNER VB	SIGNATURE					
FTSPERSON /B	SCALE	AS SHOWN	SHEET SIZE A1				
No. SY232-00	78	COOO	REVISION				

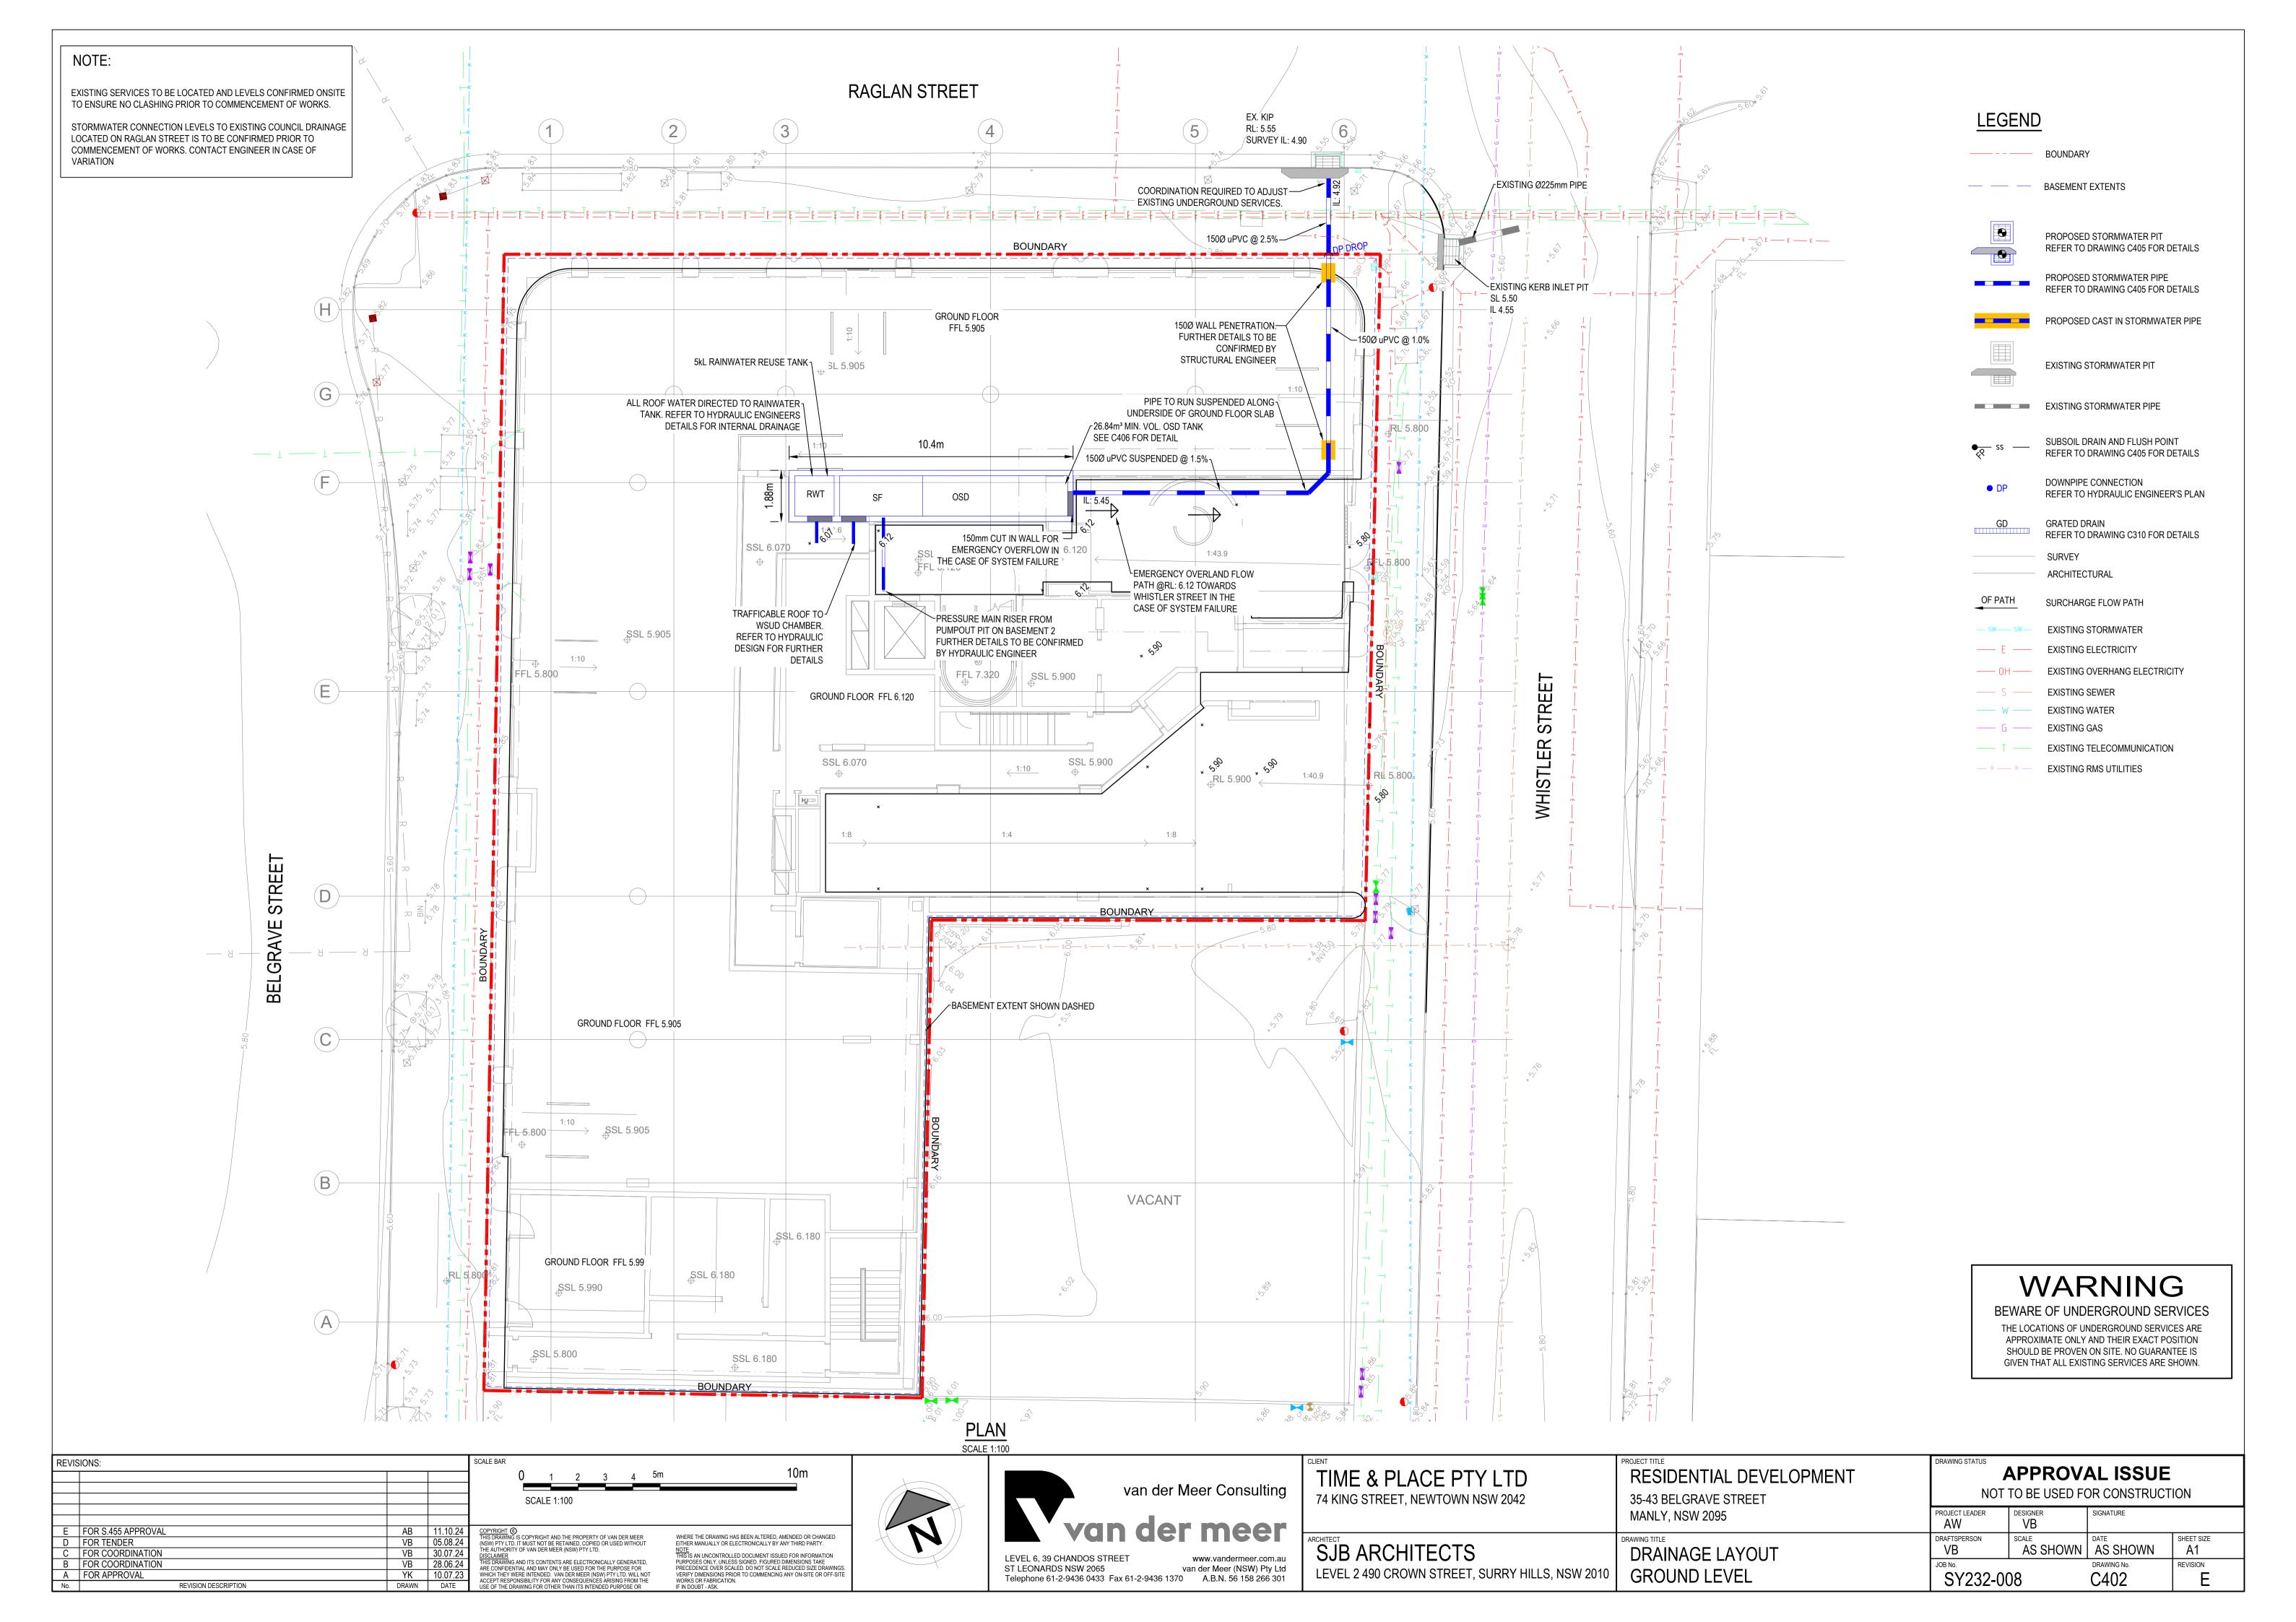

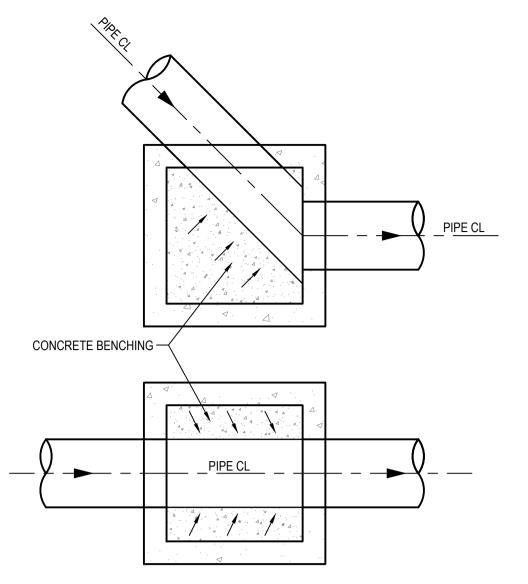


TYPICAL CONCRETE BENCHING
SCALE 1:25

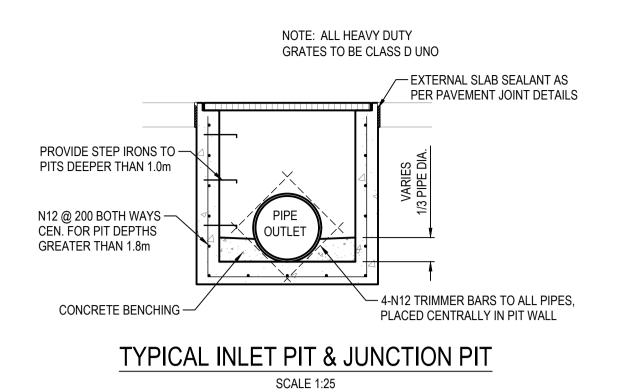

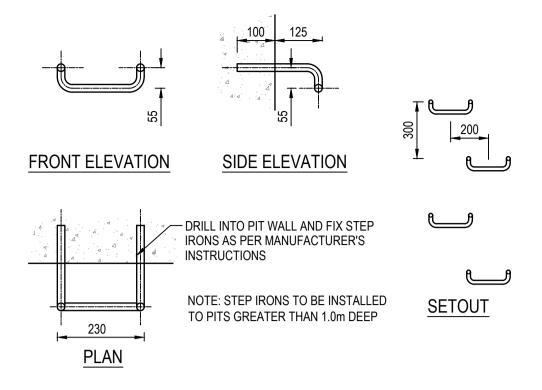


TYPICAL STEP IRON DETAIL

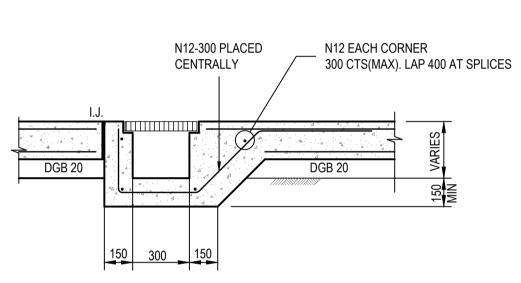


TYPICAL GRATED DRAIN DETAIL


SCALE 1:20

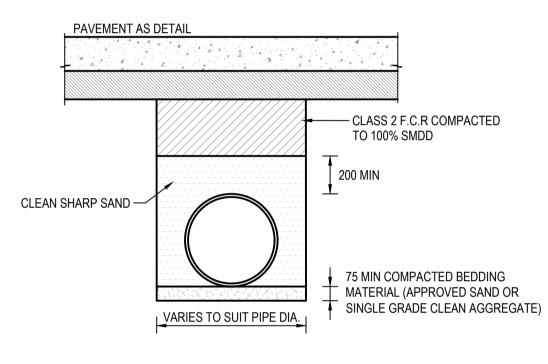


UNDER PAVEMENT PIPE BEDDING

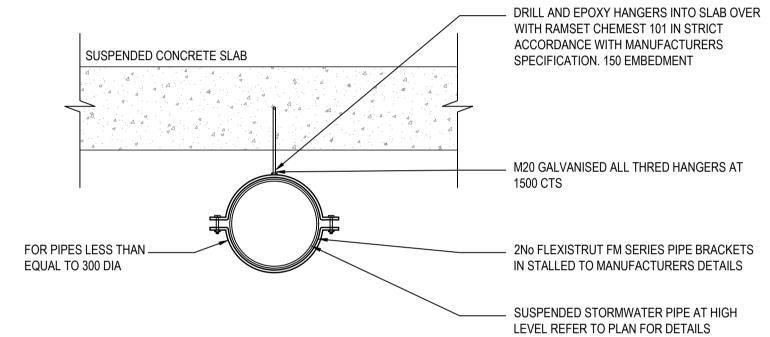




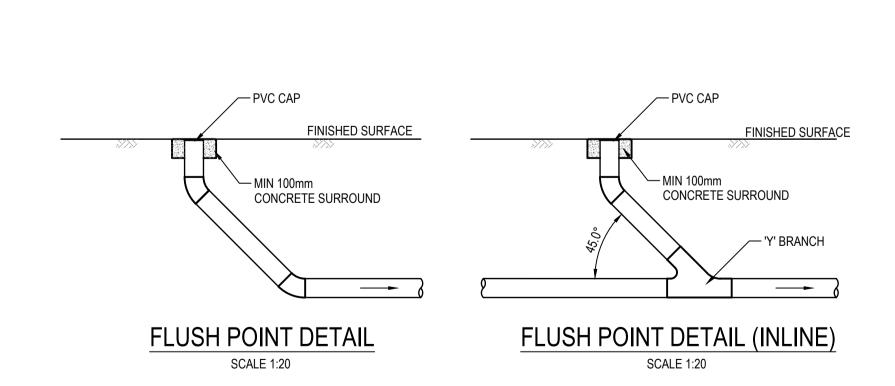

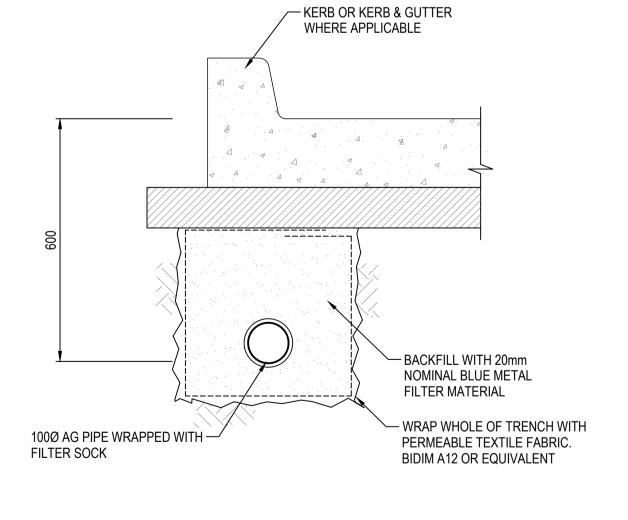

SUB-SOIL DRAIN DETAIL

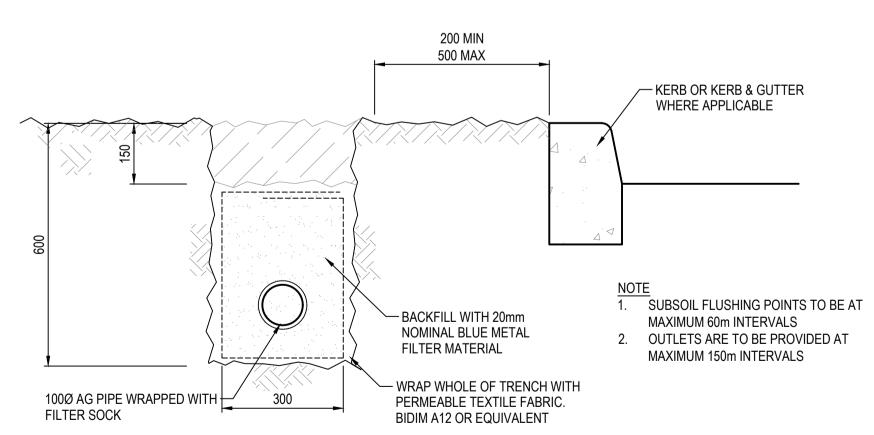

SUB-SOIL DRAIN DETAIL
SCALE 1:10


REVIS	SIONS:			SCALE BAR 0 .1 .2 .3 .4 .5 1m 1.5 2m
				SCALE 1:20 0 .1 .2 .3 .4 .5 1m 1.5 2m
				SCALE 1:25
	FOR S.455 APPROVAL	AB	11.10.24	COPYRIGHT (©) THIS DRAWING IS COPYRIGHT AND THE PROPERTY OF VAN DER MEER (NSW) PTY LTD. IT MUST NOT BE RETAINED, COPIED OR USED WITHOUT (NSW) PTY LTD. IT MUST NOT BE RETAINED, COPIED OR USED WITHOUT EITHER MANUALLY OR ELECTRONICALLY BY ANY THIRD PARTY.
С	FOR TENDER	VB	05.08.24	THE ÁUTHORITY OF VAN DER MEER (NSW) PTY LTD. <u>NOTE</u> <u>DISCLAIMER</u> THIS IS AN UNCONTROLLED DOCUMENT ISSUED FOR INFORMATION
В	FOR COORDINATION	VB	28.06.24	THIS DRAWING AND ITS CONTENTS ARE ELECTRONICALLY GENERATED, PURPOSES ONLY, UNLESS SIGNED. FIGURED DIMENSIONS TAKE ARE CONFIDENTIAL AND MAY ONLY BE USED FOR THE PURPOSE FOR PRECEDENCE OVER SCALED. DO NOT SCALE REDUCED SIZE DRAWINGS.
Α	FOR APPROVAL	YK	10.07.23	WHICH THEY WERE INTENDED. VAN DER MEER (NSW) PTY LTD. WILL NOT VERIFY DIMENSIONS PRIOR TO COMMENCING ANY ON-SITE OR OFF-SITE ACCEPT RESPONSIBILITY FOR ANY CONSEQUENCES ARISING FROM THE WORKS OR FABRICATION.
No.	REVISION DESCRIPTION	DRAWN	DATE	USE OF THE DRAWING FOR OTHER THAN ITS INTENDED PURPOSE OR IF IN DOUBT - ASK.


van der Meer Consulting
van der meer
LEVEL 6, 39 CHANDOS STREET www.vandermeer.com.au ST LEONARDS NSW 2065 van der Meer (NSW) Pty Ltd Telephone 61-2-9436 0433 Fax 61-2-9436 1370 A.B.N. 56 158 266 301

CLIENT
TIME & PLACE PTY LTD
74 KING STREET, NEWTOWN NSW 2042


74 KING STREET, NEWTOWN NSW 2042	35-43 BELGRAVE MANLY, NSW 2099
SJB ARCHITECTS LEVEL 2 490 CROWN STREET, SURRY HILLS, NSW 2010	DRAINAGE D

RESIDENTIAL DEVELOPMENT 35-43 BELGRAVE STREET	APPROVAL ISSUE NOT TO BE USED FOR CONSTRUCTION				
MANLY, NSW 2095	PROJECT LEADER AW	DESIGNER VB	SIGNATURE		
DRAINAGE DETAILS	DRAFTSPERSON VB	AS SHOWN	AS SHOWN	SHEET SIZE A1	
	JOB No. SY232-00	08	DRAWING No.	REVISION	

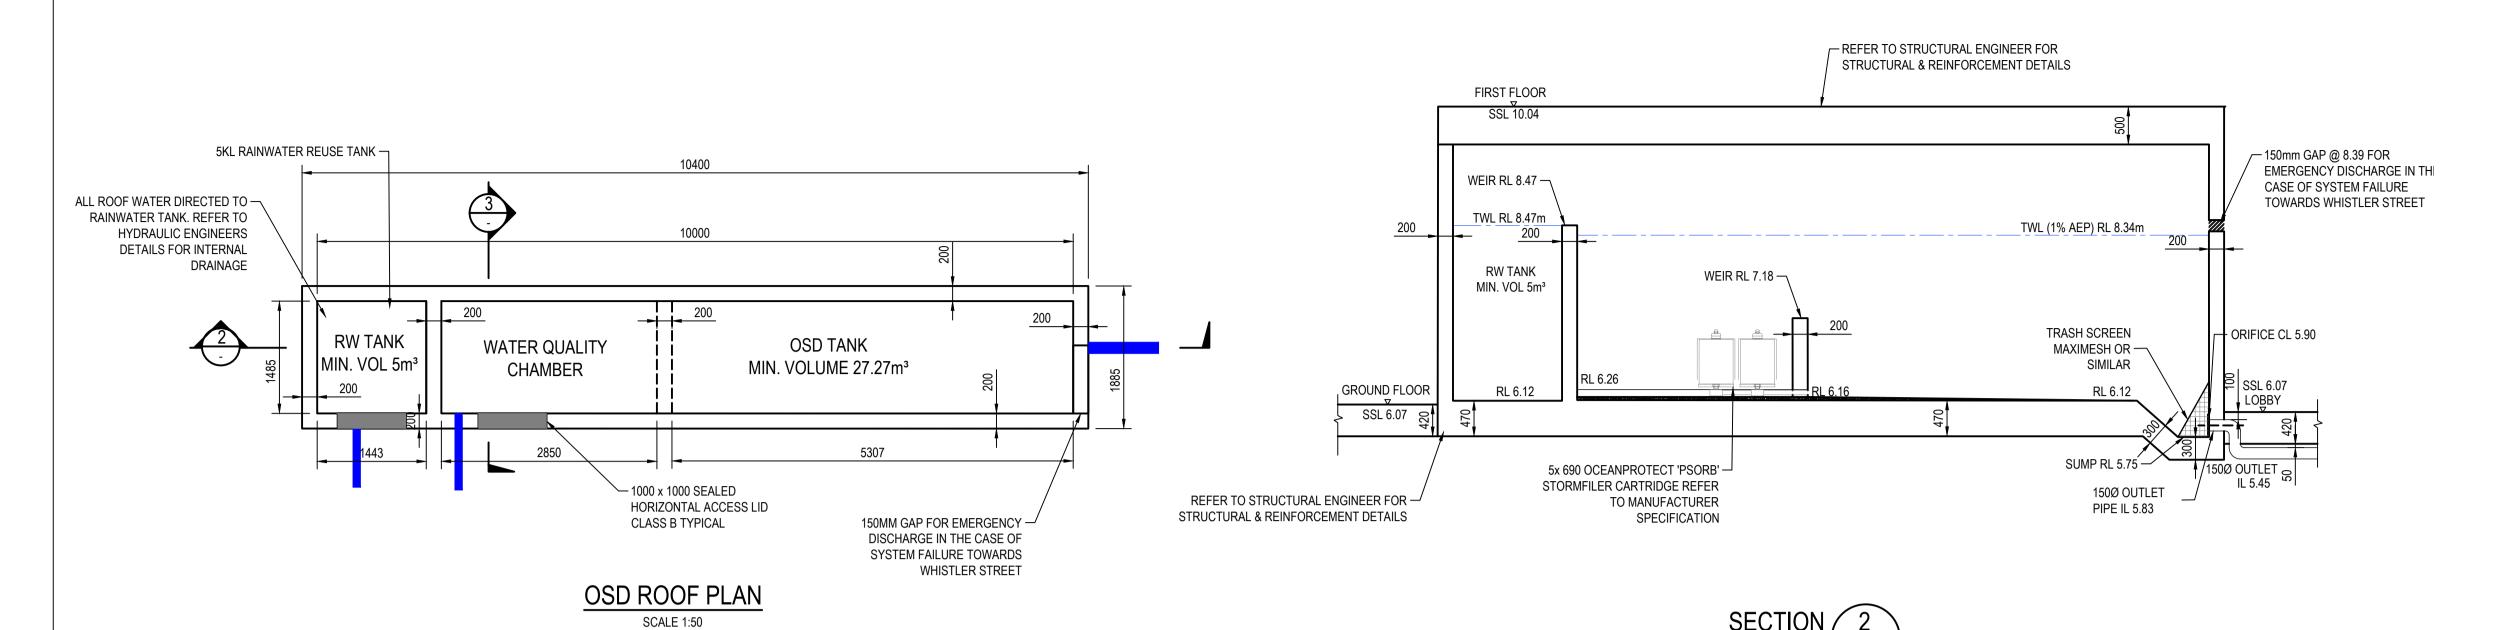


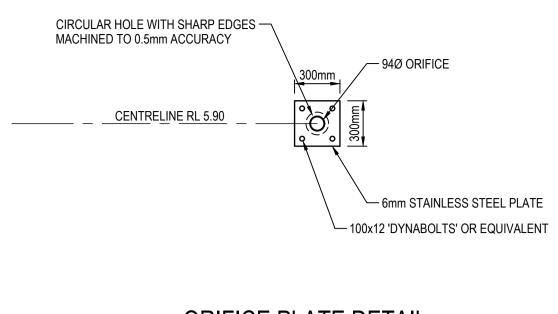

ORIFICE PLATE DETAIL

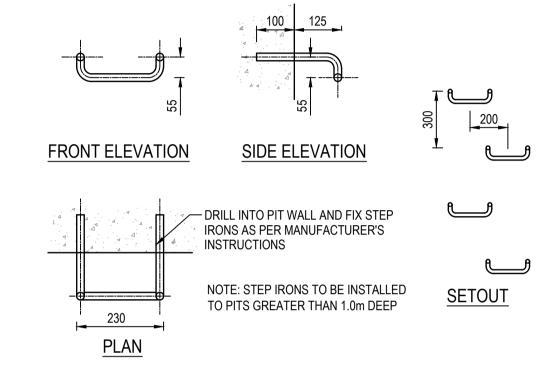

TYPICAL STEP IRON DETAIL

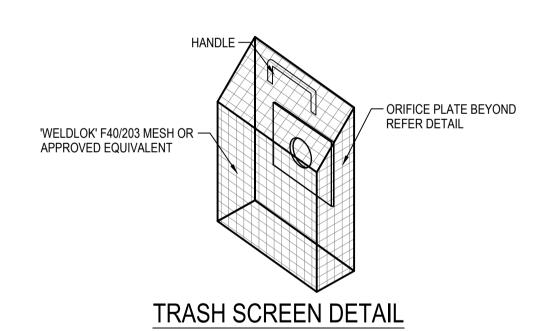

MESH TYPE	MESH SCREEN AREA				
LYSAGHT RH3030 FOR ORIFICE 150Ø OR LESS	>50x ORIFICE DIA				
'WELDLOK' F40/203 FOR ORIFICE GREATER THAN 150Ø	>20x ORIFICE DIA				
NOTE COREEN AREA INCLUDES CIRES WILEDE ARRIVED ARE					

NOTE: SCREEN AREA INCLUDES SIDES WHERE APPLICABLE

WSUD NOTES:

QUALITY TARGETS ARE LISTED BELOW:

EMERGENCY DISCHARGE @IL: 8.39 —

Ø94mm ORIFICE ─\

FALL RL 6.12

SUMP EXTENTS —

RL 6.12

RL 5.75

Ø150 uPVC OUTLET —



RL 6.16

OSD TANK

- PRESSURE MAIN RISER FROM PUMPOUT PIT ON BASEMENT 2. FURTHER DETAILS TO BE

CONFIRMED BY HYDRAULIC ENGINEER (TYP.)

5x 690 OCEANPROTECT 'PSORB' -

TO MANUFACTURER

SPECIFICATION

STORMFILER CARTRIDGE REFER

WATER QUALITY

o RL 6.26

1000 x 1000 SEALED HORIZONTAL — ACCESS LID CLASS B (TYP.)

SITE PEAK DISCHARGES						
REDUCE PEAK FLOWS FOR ALL STORMS AS PER NORTHERN BEACHES COUNCIL WATER MANAGEMENT FOR DEVELOPMENT POLICY (2021) SECTION 9.3.3.2.3 CONDITION TWO. PSD: PEAK FLOW ON 20% AEP WITH 250m² IMPERVIOUS AREA = 28L/s SITE AREA = 1,060m²						
PRE	-DEV	ST-DEVELOPMENT				
STORM PEAK FLOW		STORM	PEAK FLOW	PEAK STORAGE		
(ARI) (m³/s)		(ARI)	(m^3/s)	(m³)		
5 YEAR 0.041		5 YEAR	0.019	11.77		
10 YEAR 0.048		10 YEAR	0.022	15.01		
20 YEAR	0.056	20 YEAR	0.024	18.45		
100 YEAR 0.074 100 YEAR 0.028 26.84						

PIPE INLET FROM -

NON-TRAFFICABLE

ROOF. FURTHER DETAILS TO BE

CONFIRMED BY

TRAFFICABLE ROOF AREA TO -

STORMFILTER CHAMBER

HYDRAULIC ENGINEER

(TYPICAL) AT ACCESS GRATE

(TYP.)

- OSD TANK VOLUME PROVIDED: 27.30m3
- VALUES AS PER DRAINS MODELING
- 3. REFER TO DRAWING SHEETS C401 AND C402 FOR FURTHER DETAILS.

RW TANK

RL 6.12

TOTAL PHOSPHOROUS: 65% REDUCTION IN POST DEVELOPMENT TOTAL NITROGEN: 45% REDUCTION IN POST DEVELOPMENT TOTAL SUSPENDED SOLIDS: 85% REDUCTION IN POST DEVELOPMENT GROSS POLLUTANTS: 90% REDUCTION IN THE POST DEVELOPMENT MEAN ANNUAL LOAD

ACCORDING TO NORTHERN BEACHES WATER MANAGEMENT FOR DEVELOPMENT POLICY SECTION 3 TABLE 5, GENERAL STORMWATER

	Sources	Residual Load	% Reduction
Flow (ML/yr)	1.17	1.17	0.1
Total Suspended Solids (kg/yr)	148	22	85.1
Total Phosphorus (kg/yr)	0.352	0.0739	79
Total Nitrogen (kg/yr)	3.01	1.44	52.3
Gross Pollutants (kg/yr)	29.7	0	100

- REFER TO STRUCTURAL ENGINEER FOR STRUCTURAL & REINFORCEMENT DETAILS

- 1000 x 1000 SEALED HORIZONTAL

ACCESS LID CLASS B (TYP.)

- 150mm GAP FOR EMERGENCY

DISCHARGE IN THE CASE OF

SYSTEM FAILURE TOWARDS

WHISTLER STREET @ IL:8.39

- PROVIDE STEP IRONS @

300 CTRS (TYPICAL) AT

ACCESS GRATE

FIRST FLOOR

TWL (1% AEP) RL 8.34m

REFER TO STRUCTURAL ENGINEER FOR —

5x 690 OCEANPROTECT 'PSORB' -

TO MANUFACTURER

SPECIFICATION WEIR RL 6.26 -

STORMFILER CARTRIDGE REFER

WEIR RL 7.18 —

STRUCTURAL & REINFORCEMENT DETAILS

REVIS	SIONS:			SCALE BAR 0 1 2 3 4 5m
				SCALE 1:50 0 .1 .2 .3 .4 .5 1m 1.5 2m
E D	FOR S.455 APPROVAL FOR TENDER	AB VB	11.10.24 05.08.24	
C B	FOR COORDINATION FOR COORDINATION	VB VB	29.07.24 28.06.24	THE ÁUTHORITY OF VAN DER MEER (NSW) PTY LTD. DISCLAIMER THIS IS AN UNCONTROLLED DOCUMENT ISSUED FOR INFORMATION PURPOSES ONLY, UNLESS SIGNED. FIGURED DIMENSIONS TAKE PURPOSES ONLY, UNLESS SIGNED. FIGURED DIMENSIONS TAKE PRECEDENCE OVER SCALED. DO NOT SCALE REDUCED SIZE DRAWINGS.
A No.	FOR APPROVAL REVISION DESCRIPTION	YK DRAWN	10.07.23 DATE	WHICH THEY WERE INTENDED. VAN DER MEER (NSW) PTY LTD. WILL NOT ACCEPT RESPONSIBILITY FOR ANY CONSEQUENCES ARISING FROM THE USE OF THE DRAWING FOR OTHER THAN ITS INTENDED PURPOSE OR WEREY DIMENSIONS PRIOR TO COMMENCING ANY ON-SITE OR OFF-SITE WORKS OR FABRICATION. IF IN DOUBT - ASK.



Telephone 61-2-9436 0433 Fax 61-2-9436 1370 A.B.N. 56 158 266 301

van der Meer (NSW) Pty Ltd

ST LEONARDS NSW 2065

CLIENT
TIME & PLACE PTY LTD
74 KING STREET, NEWTOWN NSW 2042

CHITECT
SJB ARCHITECTS
OUD / ((O) II I LO I O
LEVEL 2 490 CROWN STREET, SURRY HILLS, NSW 2010

RESIDENTIAL DEVELOPMENT 35-43 BELGRAVE STREET MANLY, NSW 2095 DRAWING TITLE OSD DETAILS	APPROVAL ISSUE NOT TO BE USED FOR CONSTRUCTION							
	PROJECT LEADER AW	DESIGNER VB	SIGNATURE					
	DRAFTSPERSON VB	AS SHOWN	AS SHOWN	SHEET SIZE A1				
OSD DETAILS	JOB No. SY232-0	08	DRAWING No.	REVISION				

GENERAL NOTES

- G1. ALL LEVELS SHALL BE OBTAINED FROM ESTABLISHED BMS OR SSM.
- G2. CONTRACTOR MUST VERIFY ALL DIMENSIONS AND EXISTING LEVELS ON SITE PRIOR TO COMMENCEMENT OF WORK.
- G3. ALL WORKS ARE TO BE UNDERTAKEN IN ACCORDANCE WITH COUNCIL'S SPECIFICATIONS AND THE DIRECTIONS OF THE SUPERINTENDENT.
- G4. DIMENSIONS MUST NOT BE SCALED FROM DRAWINGS.
- G5. CONTRACTOR TO ENSURE THAT ALL ROADWORKS ARE SMOOTHLY TRANSITIONED TO EXISTING LEVELS FREE FROM ABRUPT CHANGES.
- G6. THE CONTRACTOR SHALL ARRANGE ALL SURVEY SETOUT TO BE CARRIED OUT BY A REGISTERED SURVEYOR. FURTHER, THE LOCATION OF RECOVERY MARKS SHOULD BE VERIFIED AND CONFIRMED BY THE CONTRACTOR AND ANY DISCREPANCIES SHOULD BE CLARIFIED IN WRITING WITH THE SUPERINTENDENT PRIOR TO THE COMMENCEMENT OF WORK.
- G7. AT COMPLETION OF WORKS ALL ADJOINING DISTURBED AREAS ARE TO BE REINSTATED TO THE "AS FOUND" CONDITION.
- G8. THE CONTRACTOR SHALL ENSURE ALL AREAS DRAIN WITH A MINIMUM FALL OF 1% (1:100) GRADE TO OUTLETS UNLESS INDICATED OTHERWISE. NO WORKS SHALL CAUSE PONDING OF STORMWATER ON UPSTREAM PROPERTIES OR CONCENTRATE RUNOFF ONTO DOWNSTREAM
- G9. THESE PLANS SHALL BE READ IN CONJUNCTION WITH APPROVED LANDSCAPE, ARCHITECTURAL, ELECTRICAL, RETICULATION, WATER & SEWER DRAWINGS AND SPECIFICATIONS AND OTHER WRITTEN INSTRUCTIONS AS MAY BE ISSUED.
- G10. THE CONTRACTOR SHALL ENSURE THAT ALL PAVEMENTS GRADE EVENLY BETWEEN NOMINATED RL'S ON PLAN AND NO POND OF WATER OCCURS.
- G11. ALL DIMENSIONS ARE IN METERS UNLESS STATED OTHERWISE. ALL LEVELS ARE EXPRESSED IN METERS.
- G12. DURING CONSTRUCTION THE CONTRACTOR SHALL BE RESPONSIBLE FOR MAINTAINING THE STRUCTURE IN A STABLE CONDITION AND ENSURING NO PART SHALL BE OVERSTRESSED UNDER CONSTRUCTION ACTIVITIES.
- G13. WORKMANSHIP AND MATERIALS ARE TO BE IN ACCORDANCE WITH THE RELEVANT CURRENT S.A.A. CODES INCLUDING ALL AMENDMENTS, AND THE LOCAL STATUTORY AUTHORITIES, EXCEPT WHERE VARIED BY THE CONTRACT DOCUMENTS.
- G14 THE APPROVAL OF A SUBSTITUTION SHALL BE SOUGHT FROM THE ENGINEER BUT IS NOT AN AUTHORIZATION FOR AN EXTRA. ANY EXTRAS INVOLVED MUST BE TAKEN UP WITH THE SUPERINTENDENT BEFORE THE WORK COMMENCES.
- G15 THE CONTRACTOR IS TO EMPLOY A QUALIFIED GEOTECHNICAL ENGINEER AS REQUIRED FOR ALL GEOTECHNICAL ASPECTS OF THE BUILDING WORKS. REFER TO FOUNDATION, GROUNDWORKS AND RETENTION/SHORING NOTES. REFER ALSO TO THE GEOTECHNICAL REPORT FOR THIS PROJECT.

DRAINAGE NOTES

- D1. PIT LEVELS SHOWN ON STORMWATER DRAINAGE PLANS ARE FOR INFORMATION. EXACT PIT LEVELS TO BE ADJUSTED TO SUIT FALLS IN PAVEMENT/LANDSCAPED AREA.
- D2. PITS GREATER THAN 1.2m DEEP TO BE FITTED WITH STEP IRONS.
- D3. DRAINAGE PIPES SHALL BE BACKFILLED WITH COMPACTED CLEAN SHARP SAND TO 200 ABOVE PIPE OBVERT. ADDITIONAL BACKFILL UNDER ROADS SHALL CONSIST OF CLASS 2 F.C.R. MATERIAL COMPACTED IN 200mm LAYERS TO 98% SMDD. UNDER LANDSCAPED AREAS ADDITIONAL BACKFILL SHALL CONSIST OF GRANULAR MATERIAL COMPACTED IN 200mm LAYERS TO 95% SMDD. A 3m LENGTH OF 100 Ø SLOTTED AGRICULTURAL LINE SURROUNDED BY GEOTECH STOCKING SHALL BE PROVIDED ON THE UPSTREAM SIDE OF ALL
- D4. CONCRETE STORMWATER PIPES TO BE CLASS '3' UNDER ROADS AND CLASS '2' IN NON-TRAFFICED AREAS. ALL PIPES GREATER THAN 300Ø ARE TO BE RUBBER RING JOINTS U.N.O.
- D5. CONCRETE PITS GREATER THAN 1.0m DEEP TO BE REINFORCED WITH N12-200 EACH WAY CENTRED, MIN. 300 LAP, CONCRETE - F'c 25MPa
- D6. 150Ø, 225Ø & 300Ø uPVC PIPES TO BE SEWER GRADE PIPE UNDER TRAFFICABLE PAVEMENT. MIN. 400 COVER UNDER NON-TRAFFICABLE PAVEMENT.
- D7. PIT COVERS & GRATED DRAINS IN TRAFFICABLE PAVEMENT TO BE AS 3996 CLASS D "HEAVY DUTY" & IN NON-TRAFFICABLE AREAS TO BE AS 3996 CLASS C "LIGHT DUTY".

UTILITY SERVICES

- S1. CONDUITS TO BE PROVIDED FOR WATER AND ENERGY AUTHORITIES, TELSTRA AND OTHER SERVICES AS REQUIRED.
- S2. THE LOCATIONS OF UNDERGROUND SERVICES SHOWN ON THESE DRAWING'S HAVE BEEN PLOTTED FROM SURVEY AND AUTHORITY INFORMATION. THE SERVICE INFORMATION HAS BEEN PREPARED ONLY TO SHOW THE APPROXIMATE POSITIONS OF ANY KNOWN SERVICES AND MAY NOT BE AS CONSTRUCTED OR ACCURATE.
- S3. VAN DER MEER CANNOT GUARANTEE THAT THE SERVICES INFORMATION SHOWN ON THESE DRAWINGS, ACCURATELY INDICATES THE PRESENCE OR ABSENCE OF SERVICES OR THEIR LOCATION AND WILL ACCEPT NO LIABILITY FOR INACCURACIES IN THE SERVICES INFORMATION SHOWN ARISING FROM ANY CAUSE WHATSOEVER.
- S4. IT IS THE RESPONSIBILITY OF THE CONTRACTOR TO ESTABLISH THE LOCATION AND LEVEL OF ALL EXISTING SERVICES PRIOR TO THE COMMENCEMENT OF ANY WORK. ANY DISCREPANCIES SHALL BE REPORTED TO THE SUPERINTENDENT. CLEARANCES SHALL BE OBTAINED FROM THE RELEVANT SERVICE AUTHORITY.
- S5. CONTRACTORS SHALL TAKE DUE CARE WHEN EXCAVATING ON SITE INCLUDING HAND EXCAVATION WHERE NECESSARY.
- S6. CONTRACTORS ARE TO CONTACT THE RELEVANT SERVICE AUTHORITY PRIOR TO COMMENCEMENT OF EXCAVATION OR FUTURE WORKS.
- S7. CONTRACTORS ARE TO UNDERTAKE A SERVICES SEARCH PRIOR TO COMMENCEMENT OF WORKS ON SITE. SEARCH RESULTS ARE TO BE KEPT ON SITE AT ALL TIMES.

TELSTRA - DUTY OF CARE NOTE:

TELSTRA'S PLANS SHOW ONLY THE PRESENCE OF CABLES AND PLANT. THEY ONLY SHOW THEIR POSITION RELATIVE TO ROAD BOUNDARIES, PROPERTY FENCES ETC. AT THE TIME OF INSTALLATION AND TELSTRA DOES NOT WARRANT OR UPHOLD THAT SUCH PLANS ARE ACCURATE THEREAFTER DUE TO CHANGES THAT MAY OCCUR OVER TIME. DO NOT ASSUME DEPTH OR ALIGNMENT OF CABLES OR PLANT AS THESE VARY SIGNIFICANTLY.

THE CONTRACTOR HAS A DUTY OF CARE WHEN EXCAVATING NEAR TELSTRA CABLES AND PLANT. BEFORE USING MACHINE EXCAVATORS TELSTRA PLANT MUST FIRST BE PHYSICALLY EXPOSED BY SOFT DIG POT HOLING TO IDENTIFY IT'S LOCATION. TELSTRA WILL SEEK COMPENSATION FOR DAMAGES CAUSED TO IT'S PROPERTY AND LOSSES CAUSED TO TELSTRA AND IT'S CUSTOMERS.

ELECTRICAL & GAS NETWORK:

A MINIMUM OF 30 DAYS PRIOR TO COMMENCEMENT OF EXCAVATION WORKS THE SUBCONTRACTOR MUST CONTACT DIAL BEFORE YOU DIG.

SURVEY

- SU1. ALL SURVEY INFORMATION PROVIDED FOR THIS PROJECT IS OBTAINED FROM LTS SURVEYORS PTY LTD REV. A DATED 08/02/2023 AND GEOSURV REV. A DATED 19/07/2024.
- SU2. ALL LEVELS ARE TO AUSTRALIAN HEIGHT DATUM.
- SU3. ALL CHAINAGES AND LEVELS ARE IN METRES, DIMENSION FOR DETAILS AS SHOWN.
- SU4. CONTRACTORS SHALL ARRANGE FOR THE WORKS TO BE SET OUT BY A REGISTERED SURVEYOR.

REVIS	EVISIONS:			SCALE BAR	
				COPYRIGHT (©) THIS DRAWING IS COPYRIGHT AND THE PROPERTY OF VAN DER MEER	WHERE THE DRAWING HAS BEEN ALTERED. AMENDED OR CHANGED
D	FOR S.455 APPROVAL	AB	11.10.24	(NSW) PTY LTD. IT MUST NOT BE RETAINED, COPIED OR USED WITHOUT	EITHER MANUALLY OR ELECTRONICALLY BY ANY THIRD PARTY.
С	FOR TENDER	VB	05.08.24	THE AUTHORITY OF VAN DER MEER (NSW) PTY LTD. DISCLAIMER	NOTE THIS IS AN UNCONTROLLED DOCUMENT ISSUED FOR INFORMATION
В	FOR COORDINATION	VB	28.06.24	THIS DRAWING AND ITS CONTENTS ARE ELECTRONICALLY GENERATED, ARE CONFIDENTIAL AND MAY ONLY BE USED FOR THE PURPOSE FOR	PURPOSES ONLY, UNLESS SIGNED. FIGURED DIMENSIONS TAKE PRECEDENCE OVER SCALED. DO NOT SCALE REDUCED SIZE DRAWINGS.
Α	FOR APPROVAL	YK	10.07.23	WHICH THEY WERE INTENDED. VAN DER MEER (NSW) PTY LTD. WILL NOT ACCEPT RESPONSIBILITY FOR ANY CONSEQUENCES ARISING FROM THE	VERIFY DIMENSIONS PRIOR TO COMMENCING ANY ON-SITE OR OFF-SITE WORKS OR FABRICATION.
Nο	REVISION DESCRIPTION	DRAWN	DATE	LISE OF THE DRAWING FOR OTHER THAN ITS INTENDED PURPOSE OR	IF IN DOLIRT - ASK



Telephone 61-2-9436 0433 Fax 61-2-9436 1370 A.B.N. 56 158 266 301

van der Meer (NSW) Pty Ltd

ST LEONARDS NSW 2065

TIME & PLACE PTY LTD
74 KING STREET, NEWTOWN NSW 2042

LEVEL 2 490 CROWN STREET, SURRY HILLS, NSW 2010

RESIDENTIAL DEVELOPMENT
35-43 BELGRAVE STREET
MANLY, NSW 2095
DRAWING TITLE

RESIDENTIAL DEVELOPMENT 35-43 BELGRAVE STREET	APPROVAL ISSUE NOT TO BE USED FOR CONSTRUCT							
RESIDENTIAL DEVELOPMENT 35-43 BELGRAVE STREET MANLY, NSW 2095	PROJECT LEADER AW	DESIGNER VB	SIGNATURE					
DRAWING TITLE STANDARD NOTES	DRAFTSPERSON VB	SCALE	AS SHOWN	SHEE				
01711107111011101110	JOB No. SY232-0	308	DRAWING No.	REVIS				

DOCUMENT TRANSMITTAL

Val	n der meer	Transmittal Page	1 o f 1	DATE OF ISSUE											
PROJECT NAME:	35-43 BELGRAVE STREET	MANLY		DD	10	28	30	5	11						ıt
				MM YY	7 23	6 24	7 24	8 24	10 24						current
PROJECT No:	SY232-008			BY	PS										ರ
Drawing No.:	Drawing Title:			DWG Revision											
C000	COVER SHEET				Α	В	С	D	Е						Е
C001	STANDARD NOTES				Α	В		С	D						D
C201	BULK EARTHWORKS PLAN					Α		В							В
C202	BULK EARTHWORKS SECT					Α		В							В
C210	EROSION & SEDIMENT COI	NTROL			Α	В		С							С
0004	PAVEMENT LAYOUT														
C301	PAVEMENT DETAILS														
C302 C311	DRIVEWAY PLAN AND LON	G SECTION				Α		В							В
CSTT	DRIVEWATT LAW AND LOW	OCCITON				^									_
C401	DRAINAGE LAYOUT BASEN	IENT 2 LEVEL			Α									1	Α
C402	DRAINAGE LAYOUT GROUI				Α	В	С	D	Е						Е
C405	DRAINAGE DETAILS				Α	В		С	D						D
C406	OSD DETAILS				Α	В	С	D	Е						Е
C501	EXTERNAL WORKS PLANS	& DETAILS					Α	В							В
															—
					\vdash			-			-			-	
														-	
					\vdash									-	—
														\dashv	
					\vdash										
REASON FOR ISS	UE														
A - Approval	B - As Built C - Cons	truction CC - Construction	Certificate		۸	_	7	_	٨						
P - Preliminary	R - As Requested T - Tende	ar			Α	Р	Р	T	Α				1 1		\wedge

BRISBANE CANBERRA MELBOURNE NEWCASTLE SYDNEY Level 1, 51 Alfred Street, Fortitude Valley QLD 4006 Level 9, 2 Phillip Law Street, Canberra ACT 2601 Level 6, 379 Collins Street, Melbourne VIC 3000 Level 1, 17 Bolton Street, Newcastle NSW 2300 Level 6, 39 Chandos Street, St Leonards NSW 2065 P 07 3021 6600 P 02 6243 4839 P 03 8614 5555 P 02 4910 4035

P 02 9436 0433

E QLD-enquiries@vandermeer.com.au E ACT-enquiries@vandermeer.com.au E VIC-enquiries@vandermeer.com.au E NC-enquiries@vandermeer.com.au E NSW-enquiries@vandermeer.com.au