Single Dwelling 950 Barrenjoey Road, Palm Beach NSW 2108 Lot No / DP: 27/950

#### Water (All dwellings) Shower head rating Specification 3 star (> 7.5 but <= 9 L/min) Toilet rating Kitchen taps rating 3 star 3 star

Bathroom taps rating 3 star Alternative water details

Connected to: Garden and lawn areas Yes Laundry Thermal Comfort

The applicant must construct the development in accordance with all thermal performance specifications set out in the Assessor Certificate, and in accordance with those aspects of the development application or application for a complying development cert which were used to calculate those specifications.

The applicant must construct the floors and walls of the dwelling in accordance with the specifications listed in the table below.

Floor and wall construction			Area	
floor - concrete slab on ground			78.0 square metres	
floor - suspended floor/open subfloor		148.0 square metres		
External walls		Requirements		
Concrete block, lined	Garage level	Medium colour, R2.7 bulk i	nsulation	
Weatherboard Cavity Panel Direct Fix	All other levels	Medium colour, R2.7 bulk insulation		
Internal walls				
Cavity wall, direct fix plasterboard		No insulation		
Ceiling				
External ceiling - Plasterboard	All levels (excl garage)	R4.0 bulk insulation		
Internal ceiling - Timber above plasterboard	All levels	No insulation		

Roof Light Colour (solar absorptance < 0.475) Corrugated iron Reflective side Down, Anti-glare Up R1.8 Light Colour (solar absorptance < 0.475) Garage leve Waterproofing membrane

Floors Concrete slab on ground Suspended timber R4.0 bulk insulation All other levels

Windows Trend TND-062-51 All glazing (excl below) Trend TND-026-01 W8A. W8B. W9 Trend TND-062-44 Trend TND-062-52 W1 & Skylights

U value 4.09 and SHGC 0.39 U value 4.01 and SHGC 0.52 U value 4.02 and SHGC 0.27 U value 4.0 and SHGC 0.39

Adjoining units calculated into model calculation

No mechanical ventilation (ie. Natural)

Overshadowing details Site
Orientation of nominal north elevation As shown on plans Energy (All Dwellings) Hot water Individual system Individual fan, ducted to façade or roo Control switch Interlocked to light Kitchen exhaust Individual fan, ducted to façade or roof Manual switch on/off

Control switch Laundry Control switch Cooling

Individual systems - living areas Individual systems - bedroom areas 1-phase airconditioning 3 star 1-phase airconditioning The cooling system must provide for day/night zoning between living areas and bedrooms

The heating system must provide for day/night zoning between living areas and bedrooms

Redrigerator space The applicant must construct each refrigerator space in the development so that it is "well ventilated", as defined in the BASIX definitions.

Outdoor clothes drying line Indoor clothes drying line

## Artificial lighting

The applicant must ensure that the "primary type of artificial lighting" is fluorescent or light emitting diode (LED) lighting in each of the following rooms, and where the word "dedicated" appears, the fittings for those lights must only be capable of accepting fluorescent o light emitting diode (LED) lamps:

- · at least 4 of the bedrooms / study; dedicated
- at least 1 of the living / dining rooms; dedicated · the kitchen; dedicated
- all bathrooms/toilets; dedicated and the second secon
- · the laundry; dedicated · all hallways: dedicated

### Natural lighting

The applicant must install a window and/or skylight in the kitchen of the dwelling for natural lighting.

The applicant must install a window and/or skylight in 3 bathroom(s)/toilet(s) in the development for natural lighting

### **BUSHFIRE REQUIREMENTS**

#### Construction

- 1. New construction shall comply with the requirements of section 3 of Australian Standard AS3959-2009 "Construction of buildings in bush fire-prone areas".
- 2. New construction on the north-easterly and south-easterly aspects shall also comply with the requirements of BAL-40 Australian Standard AS3959-2009 "Construction of buildings in bush fire-prone areas" and section A3.7 Addendum Appendix 3 of "Planning for Bush fire Protection".
- 3. New construction on the north-westerly and south-westerly aspects shall also comply with the requirements of BAL-29 Australian Standard AS3959-2009 "Construction of buildings in bush fire-prone areas" and section A3.7 Addendum Appendix 3 of "Planning for Bush fire Protection".
- 4. Any new fencing to be property should be in accordance with Rural Fire Service "Fast Fact 2/06".
- 5. New roofing valleys and guttering should be fitted with a non-combustible leaf protection to stop the accumulation of

### Electricity + Gas

6. Any new electricity or gas connections are to comply with the requirements of section 4.1.3 of Planning for Bushfire

### Asset Protection Zone

- 7. At the commencement of building works and in perpetuity the entire property shall be managed as an Asset Protection Zone in accordance with the requirements of Planning for Bushfire Protection, the RFS document Standards for Asset Protection Zones and in a manner that does not create a bushfire hazard to the property.
- 8. Any trees located on the subject lot and within 10m of the proposed building should be removed as part of the establishment of the Inner Protection Area for the Asset Protection Zone works.

### Landscaping

Any new landscaping to the site is to comply with the principles of Appendix 5 of Planning for Bush Fire Protection 2006. In this regard the following landscaping principles are, where applicable, to be incorporated into the development:

- · Suitable impervious areas being provided immediately surrounding the building such as courtyards, paths and
- · Grassed areas/mowed lawns/ or ground cover plantings being provided in close proximity to the building;
- · Restrict planting in the immediate vicinity of the building which may over time and if not properly maintained come in contact with the building;
- Maximum tree cover should be less than 30%, and maximum shrub cover less than 20%;
- Planting should not provide a continuous canopy to the building (i.e. trees or shrubs should be isolated or located in small clusters):
- · When considering landscape species consideration needs to be given to estimated size of the plant at maturity;
- Avoid species with rough fibrous bark, or which retain/shed bark in long strips or retain dead material in their
- Use smooth bark species of trees species which generally do not carry a fire up the bark into the crown;
- Avoid planting of deciduous species that may increase fuel at surface/ ground level (i.e. leaf litter);
- · Avoid climbing species to walls and pergolas;
- · Locate combustible materials such as woodchips/mulch, flammable fuel stores away from the building;
- · Locate combustible structures such as garden sheds, pergolas and materials such timber garden furniture way from the building; and
- Use of low flammability vegetation species.x

	Matthew Willis		
Prepared and certified by:	BPAD – Level3 Certified Practitioner	Matherine.	18/07/2017
	Certification No:		
	BPD-PA 09337		
Can this proposal comply with AS3959-2009 (inc PBP addendum 3)?		Yes	
What is the recommended AS 3959-2009 level of compliance?		BAL-40/29	
Is referral to the RFS required?		Yes	
Can this development comply with the requirements of PBP?		Yes	
Plans by "Sarah Blacker" (Appendix 1) dated.		15/5/2017	



### **SPECIFICATION**

### Demolition: -

· AS 2601(1991) - The demolition of structures

### Site Preparation: -

- Earthworks To be carried out in accordance with the requirements of the Environmental Planning & Assessment Act 1979, conditions of development consent and the relevant requirements of Part 3.1.1 of the BCA (Volume 2)
- Stormwater drainage Part 3.1.2 of the BCA (Volume 2); and
- AS/NZS 3500 (2003) Part 3 Stormwater drainage
- AS/NZS 3500 (2000) Part 5 Domestic installations Section 5 stormwater drainage
- Termite protection Part 3.1.3 of the BCA (Volume 2); and
- AS 3660.1(2000) Protection of buildings from subterranean termites

#### Footings and Slabs: -

- · Footings and slabs Part 3.2 of the BCA (Volume 2); and
- AS 2870 (1996) Residential slabs and footings
- AS 3600 (2001) Concrete structures
- AS 2159 (1995) Piling Design and installation
   Site classification Part 3.2.4 of the BCA (Volume 2)

- Masonry construction Part 3.3 of the BCA (Volume 2) and AS 3700 (2001) Masonry Code
- Lintels in masonry Part 3.3.3.4 of the BCA (volume 2)

- Sub-floor ventilation Part 3.4.1 of the BCA (Volume 2)
- Steel framing Part 3.4.2 of the BCA (Volume 2)
- Acceptable construction practice (Part 3.4.2.1 of the BCA) and / or
- AS 4100 (1998) Steel structures
- . Timber wall, floor and roof framing Part 3.4 of the BCA (Volume 2); and
- AS 1684 (2006) Residential timber frame construction
- Structural steel members Part 3.4.4 of the BCA (Volume 2)

### Roof and wall cladding: -

- Roof tilling Parts 3.5.1.1 & 3.5.1.2 of the BCA (Volume 2) and AS 2049 (2002) Roof tiles
- Metal roof sheeting Parts 3.5.1.1 & 3.5.1.3 of the BCA (Volume 2)
- Gutters and downpipes Part 3.5.2 of BCA (Volume 2); and
- AS/NZS 3500 (2003) Part 3 Stormwater drainage
- AS/NZS 3500 (2000) Part 5 Domestic installation
- Wall cladding Part 3.5.3 of the BCA (Volume 2)

#### Glazing: -

- Glazing Part 3.6 of the BCA (Volume 2)
- AS 1288 (2006) Glass in buildings
- AS 2047 (1999) Windows in buildings

### Fire safety: -

- Fire separation Part 3.7.1 of the BCA (Volume 2)
- Fire separation Separating wall construction Part 3.7.1.8 of the BCA (Volume 2)
- Fire separation Roof lights Part 3.7.1.10 of the BCA (Volume 2)
- Smoke alarms Part 3.7.2 of the BCA (Volume 2) and AS 3786 (1993) Smoke alarms
- Heating appliances Part 3.7.3 of the BCA (Volume 2) and AS 2918 (2001)- Domestic solid fuel

#### burning appliances - installation Health and amenity:

- Wet areas Part 3.8.1 of the BCA (Volume 2) and AS 3740 (2004) Waterproofing of wet areas in residential buildings
- Room heights Part 3.8.2 of the BCA (Volume 2)
- Kitchen, sanitary and washing facilities Parts 3.8.3.2 and 3.8.3.3 of the BCA (Volume 2)
- Natural and artificial light Parts 3.8.4.2 and 3.8.4.3 of the BCA (Volume 2)
- . Ventilation Part 3.8.5 of the BCA
- Natural Parts 3.8.5.2 and 3.8.5.3 of the BCA (Volume 2)
- Mechanical Parts 3.8.5.0 and 3.8.5.3 of the BCA (Volume 2)
- Sound insulation Part 3.8.6.1 of the BCA (Volume 2)

### Safe movement and access: -

- Stair construction Part 3.9.1.1 of the BCA (Volume 2) Acceptable construction practice
- Balustrades Part 3.9.2.1 of the BCA (Volume 2) Acceptable construction practice
- Handrails Part 3.9.2.4 of the BCA (Volume 2) Acceptable construction practice
- Protection of openable windows Part 3.9.2.5 of the BCA (Volume 2) Acceptable construction practice Energy efficiency: -

### Building Fabric - Part 3.12.1 of the BCA (Volume 2)

- Building Sealing Part 3.12.3 of the BCA (Volume 2)
   Services Part 3.12.5 of the BCA (Volume 2)

## Structural design manuals: -

- AS 1170.1 (1989) Dead and live loads and load combinations
- AS 1170.2 (1989) or AS 4055 (1992) Wind loads
- AS 1170.4 (1993) Earthquake loads
- AS 1720.1 (1997) Timber structures
- AS 2159 (1995) Piling design and installation AS 3600 (2001) - Concrete structures
- AS 4100 (1998) Steel structures

### DISCLAIMER

ALL WORKS TO BE IN ACCORDANCE WITH AUSTRALIAN STANDARDS, THE BUILDING CODE OF AUSTRALIA, OTHER RELEVANT CODES, AND WITH MANUFACTURER'S RECCOMENDATIONS AND INSTRUCTIONS. DO NOT SCALE FROM DRAWINGS. VERIFY ALL DIMENSIONS ON SITE PRIOR TO CONSTRUCTION. THIS DRAWING IS COPYRIGHT AND MAY NOT BE USED WITHOUT WRITTEN CONSENT FROM SARAH BLACKER.

**PROJECT ADDRESS** 

DOCUMENT

WILLIAMS HOUSE

950 BARRENJOEY RD, PALM BEACH S4.55(1) APPLICATION

REVISION

DRAWING NO.

**SCALE** 

DATE

Α NTS

02.03.22


DA.00

# SARAH BLACKER

ARCHITECT + INTERIOR DESIGNER ARCHITECT'S REG NO. 8403

PO Box 1313, Potts Point NSUJ 1335 T: 0412 660 754 E: info@sarahblacker.com.au

DRAWING **COVER PAGE** 

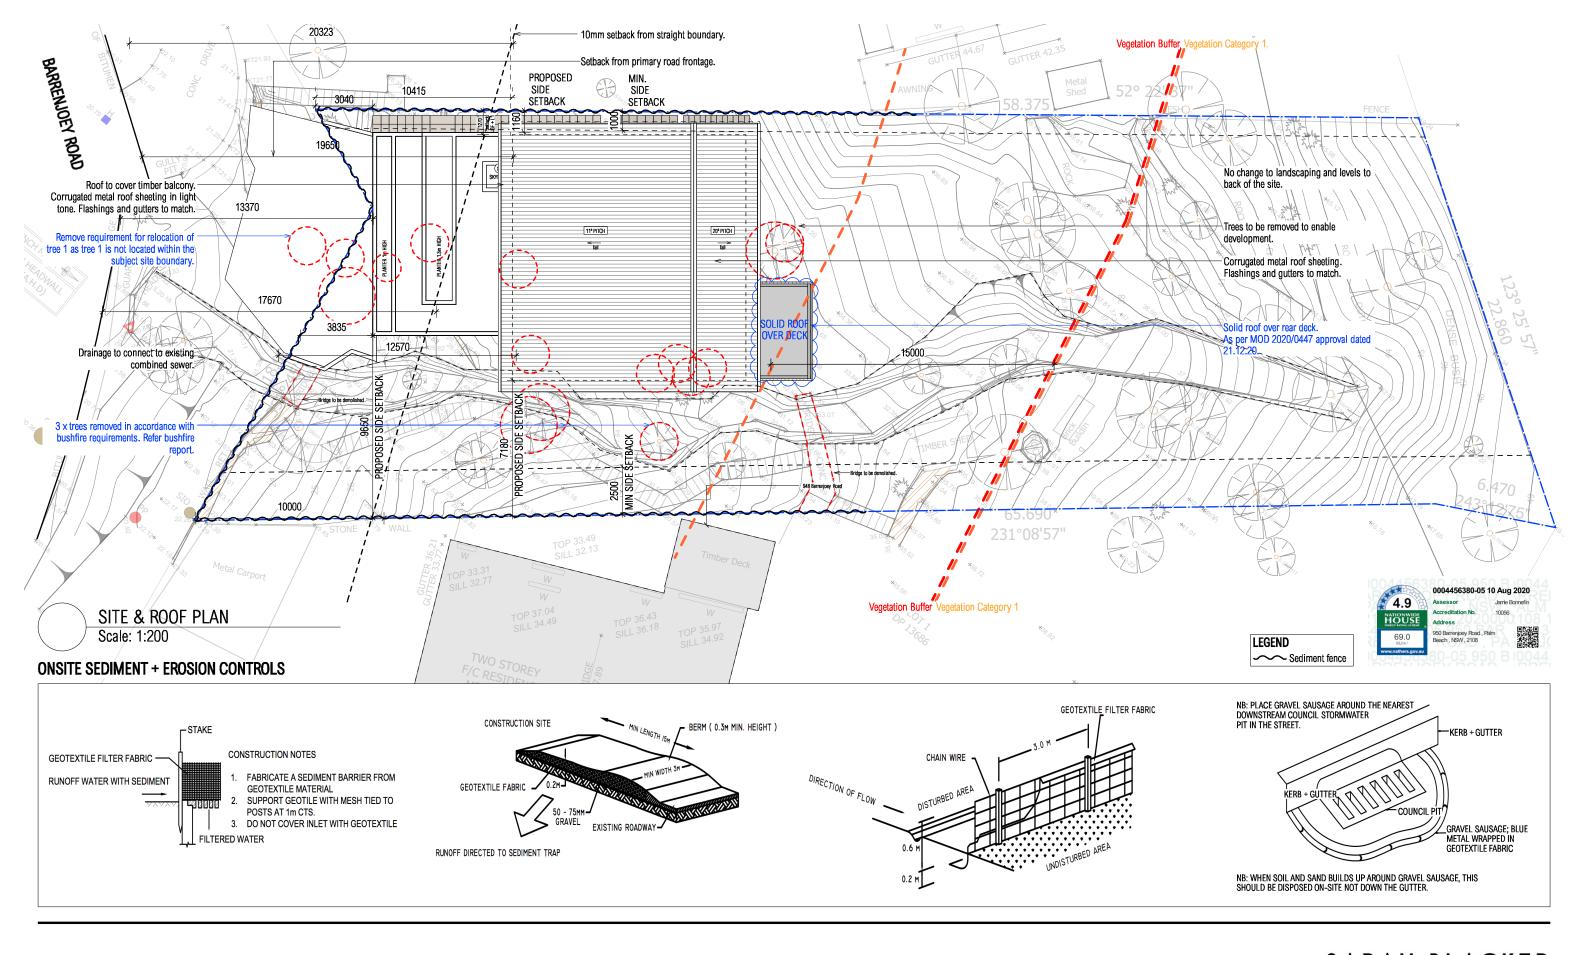

S.B

## DISCLAIMER


ALL WORKS TO BE IN ACCORDANCE WITH AUSTRALIAN STANDARDS, THE BUILDING CODE OF AUSTRALIA, OTHER RELEVANT CODES, AND WITH MANUFACTURER'S RECCOMENDATIONS AND INSTRUCTIONS. DO NOT SCALE FROM DRAWINGS. VERIFY ALL DIMENSIONS ON SITE PRIOR TO CONSTRUCTION. THIS DRAWING IS COPYRIGHT AND MAY NOT BE USED WITHOUT WRITTEN CONSENT FROM SARAH BLACKER.

PROJECT
ADDRESS
DOCUMENT
DRAWING

WILLIAMS HOUSE 950 BARRENJOEY RD, PALM BEACH S4.55(1) APPLICATION SITE & ROOF PLAN DRAWING NO. REVISION SCALE


DATE

DA.01 A 1:200 @ A3 02.03.22

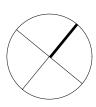

# SARAH BLACKER

ARCHITECT + INTERIOR DESIGNER
ARCHITECT'S REG NO. 8403

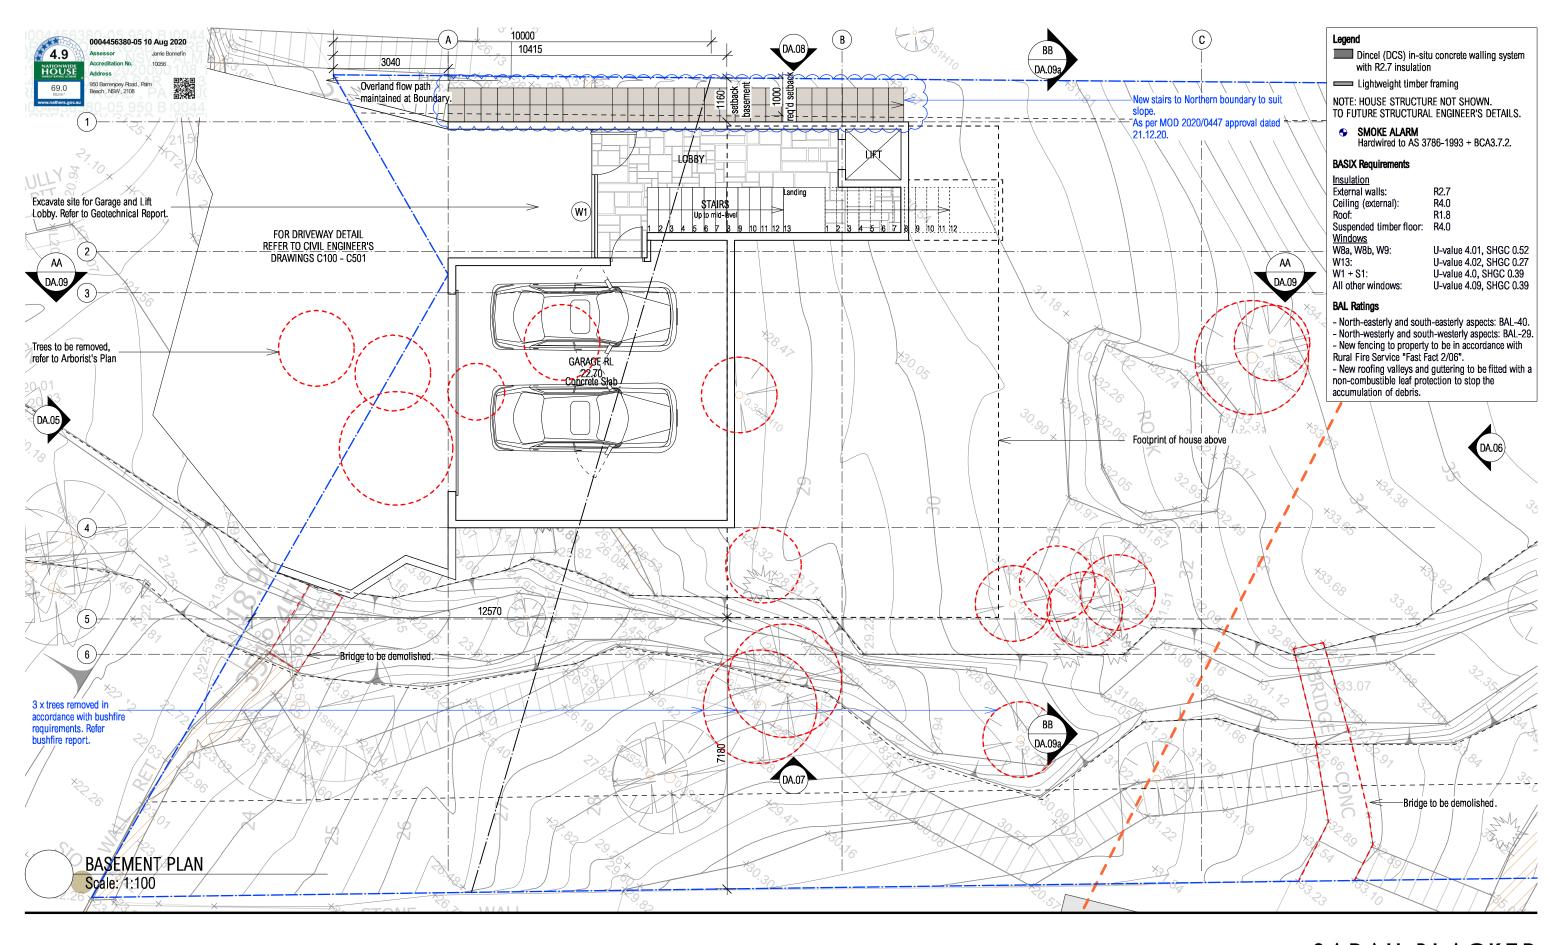

S.B

# DISCLAIMER


ALL WORKS TO BE IN ACCORDANCE WITH AUSTRALIAN STANDARDS, THE BUILDING CODE OF AUSTRALIA, OTHER RELEVANT CODES, AND WITH MANUFACTURER'S RECCOMENDATIONS AND INSTRUCTIONS. DO NOT SCALE FROM DRAWINGS. VERIFY ALL DIMENSIONS ON SITE PRIOR TO CONSTRUCTION. THIS DRAWING IS COPYRIGHT AND MAY NOT BE USED WITHOUT WRITTEN CONSENT FROM SARAH BLACKER.

PROJECT
ADDRESS
DOCUMENT
DRAWING

WILLIAMS HOUSE 950 BARRENJOEY RD, PALM BEACH S4.55(1) APPLICATION BASEMENT PLAN DRAWING NO. REVISION SCALE


DATE

DA.02 A 1:100 @ A3 02.03.22

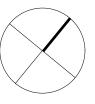

# SARAH BLACKER

ARCHITECT + INTERIOR DESIGNER
ARCHITECT'S REG NO. 8403

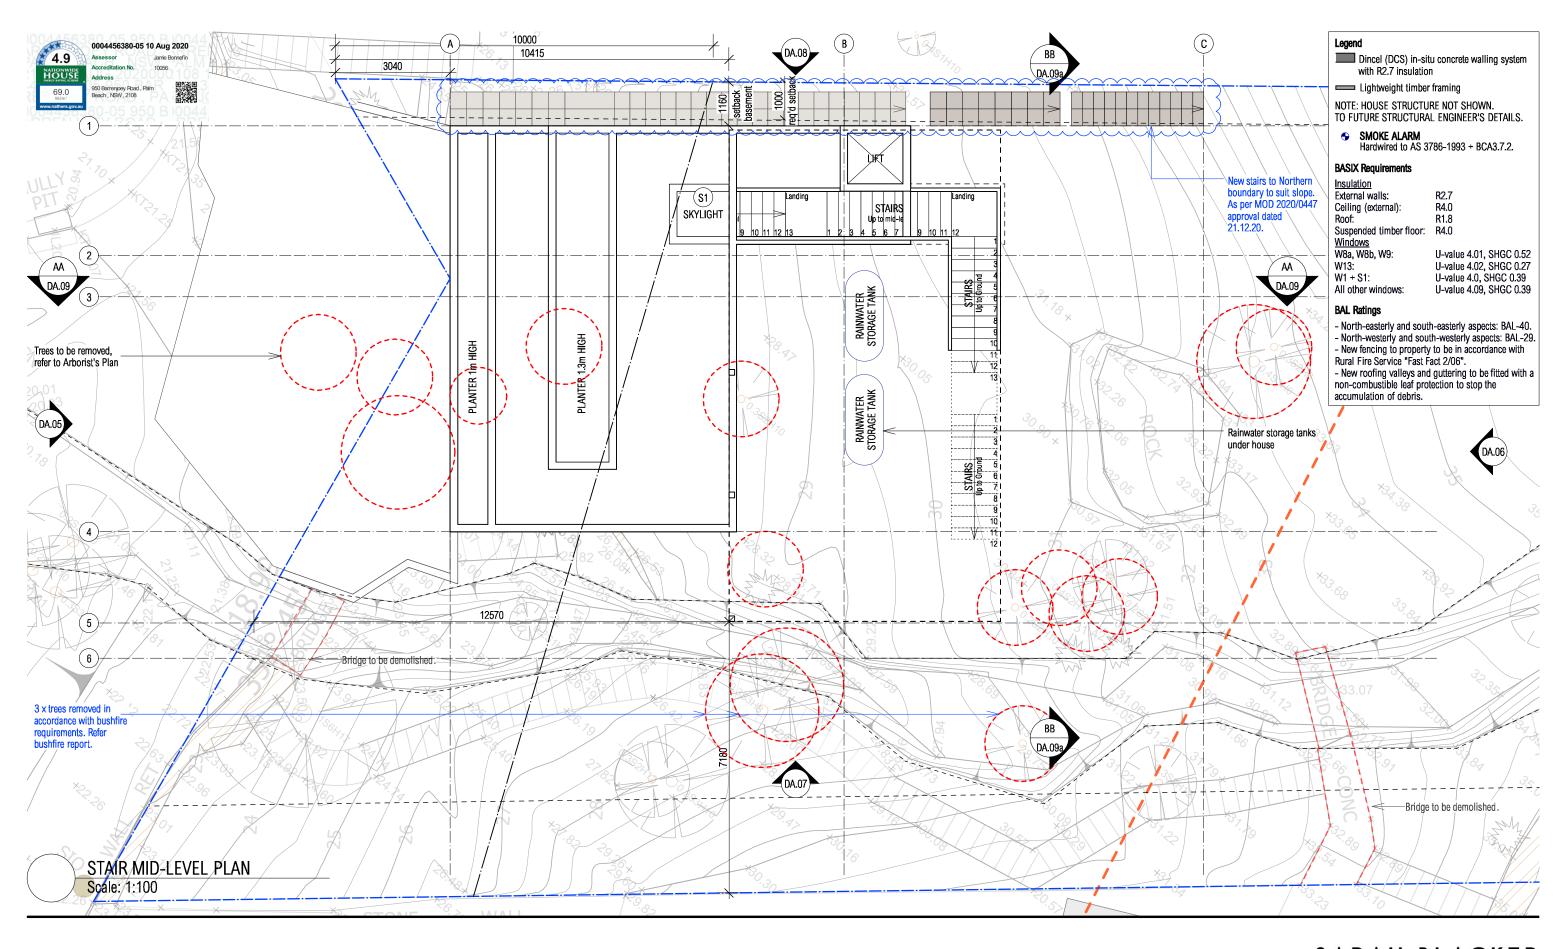

# DISCLAIMER

ALL WORKS TO BE IN ACCORDANCE WITH AUSTRALIAN STANDARDS, THE BUILDING CODE OF AUSTRALIA, OTHER RELEVANT CODES, AND WITH MANUFACTURER'S RECCOMENDATIONS AND INSTRUCTIONS. DO NOT SCALE FROM DRAWINGS. VERIFY ALL DIMENSIONS ON SITE PRIOR TO CONSTRUCTION. THIS DRAWING IS COPYRIGHT AND MAY NOT BE USED WITHOUT WRITTEN CONSENT FROM SARAH BLACKER.

PROJECT
ADDRESS
DOCUMENT
DRAWING

WILLIAMS HOUSE 950 BARRENJOEY RD, PALM BEACH S4.55(1) APPLICATION STAIR MID-LEVEL PLAN DRAWING NO. REVISION SCALE


DATE

DA.02B A 1:100 @ A3 02.03.22



# SARAH BLACKER

ARCHITECT + INTERIOR DESIGNER
ARCHITECT'S REG NO. 8403

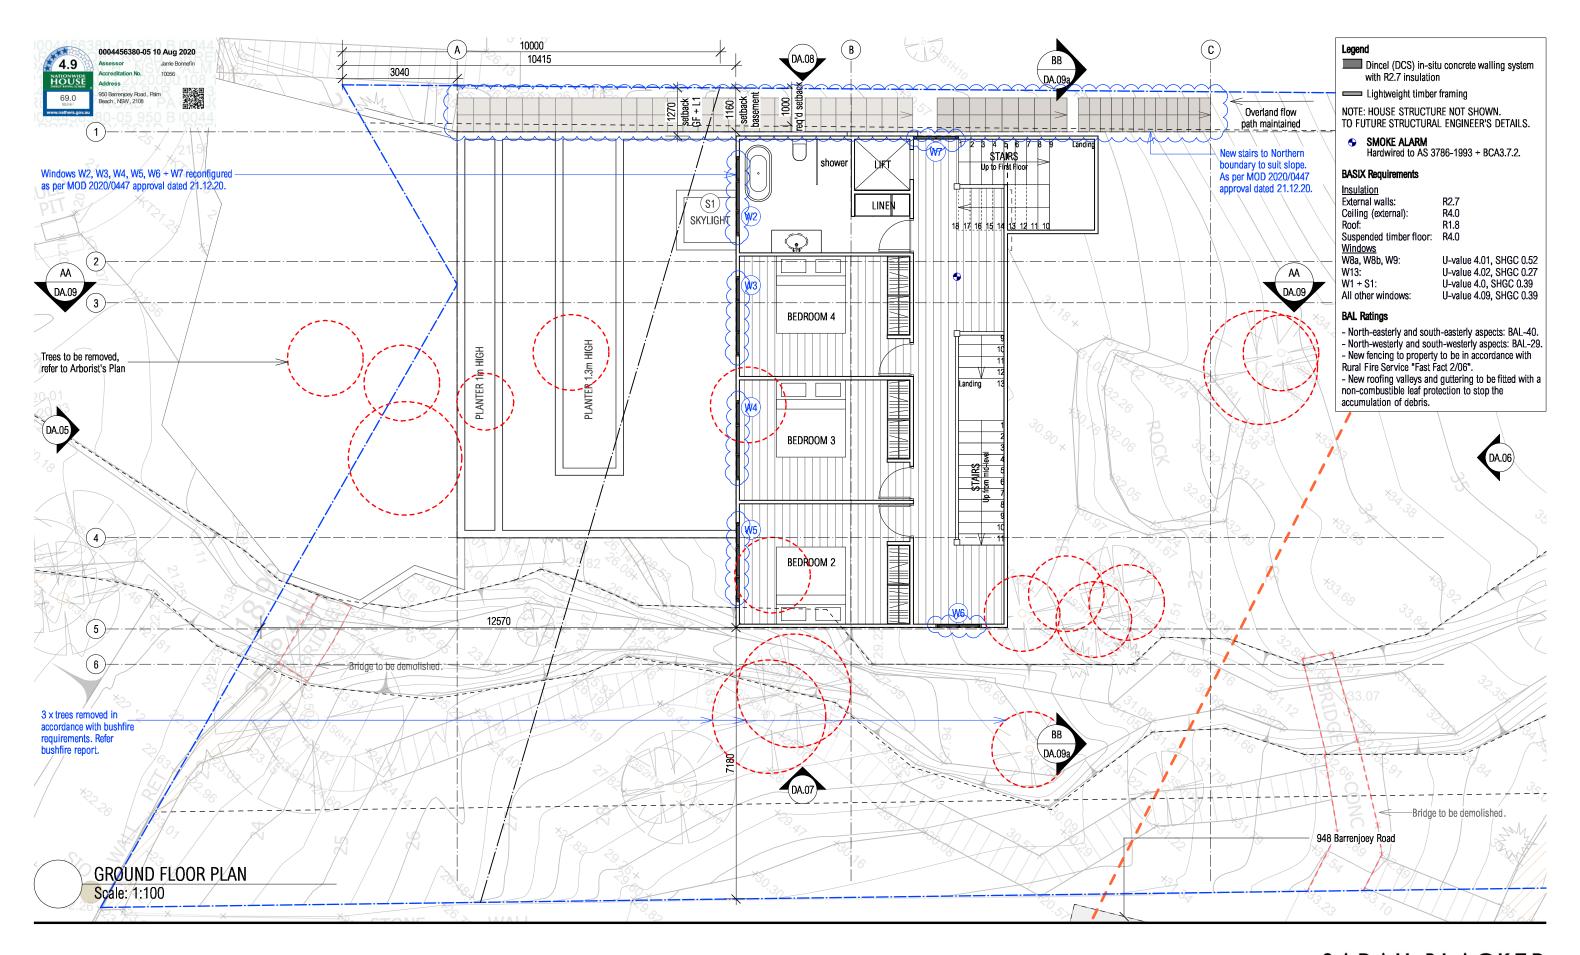

# DISCLAIMER

ALL WORKS TO BE IN ACCORDANCE WITH AUSTRALIAN STANDARDS, THE BUILDING CODE OF AUSTRALIA, OTHER RELEVANT CODES, AND WITH MANUFACTURER'S RECCOMENDATIONS AND INSTRUCTIONS. DO NOT SCALE FROM DRAWINGS. VERIFY ALL DIMENSIONS ON SITE PRIOR TO CONSTRUCTION. THIS DRAWING IS COPYRIGHT AND MAY NOT BE USED WITHOUT WRITTEN CONSENT FROM SARAH BLACKER.

PROJECT
ADDRESS
DOCUMENT
DRAWING

WILLIAMS HOUSE 950 BARRENJOEY RD, PALM BEACH S4.55(1) APPLICATION GROUND FLOOR PLAN DRAWING NO. REVISION SCALE


DATE

DA.03 A 1:100 @ A3 02.03.22



# SARAH BLACKER

ARCHITECT + INTERIOR DESIGNER
ARCHITECT'S REG NO. 8403

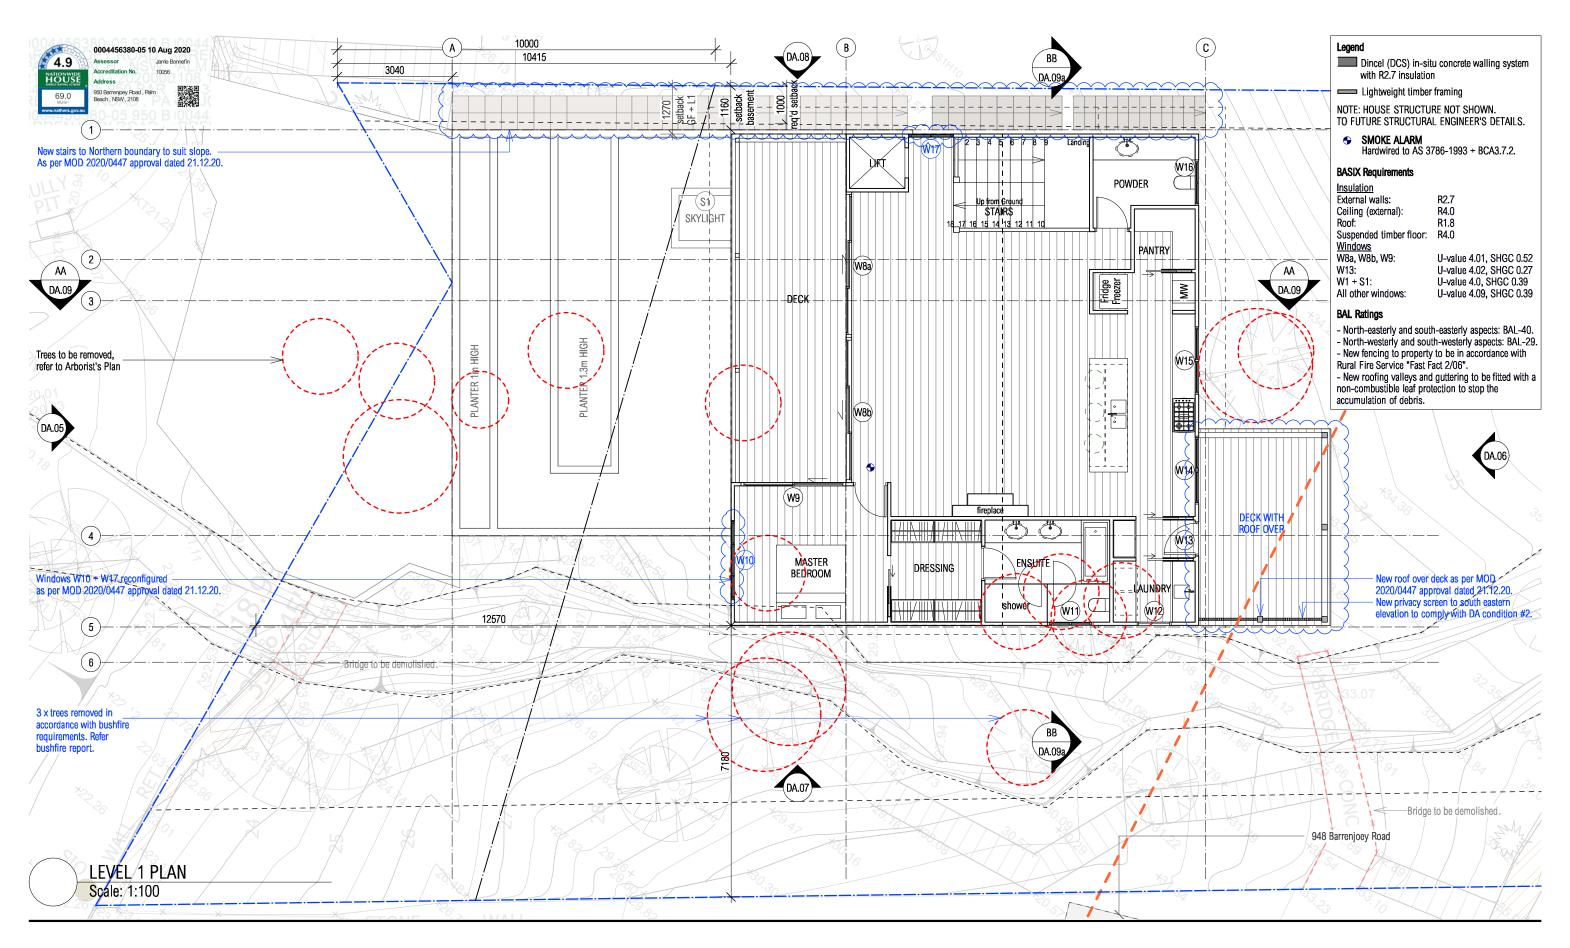

# DISCLAIMER

ALL WORKS TO BE IN ACCORDANCE WITH AUSTRALIAN STANDARDS, THE BUILDING CODE OF AUSTRALIA, OTHER RELEVANT CODES, AND WITH MANUFACTURER'S RECCOMENDATIONS AND INSTRUCTIONS. DO NOT SCALE FROM DRAWINGS. VERIFY ALL DIMENSIONS ON SITE PRIOR TO CONSTRUCTION. THIS DRAWING IS COPYRIGHT AND MAY NOT BE USED WITHOUT WRITTEN CONSENT FROM SARAH BLACKER.

**PROJECT** ADDRESS **DOCUMENT** DRAWING

WILLIAMS HOUSE 950 BARRENJOEY RD, PALM BEACH S4.55(1) APPLICATION LEVEL ONE PLAN


DRAWING NO. REVISION **SCALE** DATE

DA.04 1:100 @ A3 02.03.22

Α

# SARAH BLACKER

ARCHITECT + INTERIOR DESIGNER ARCHITECT'S REG NO. 8403

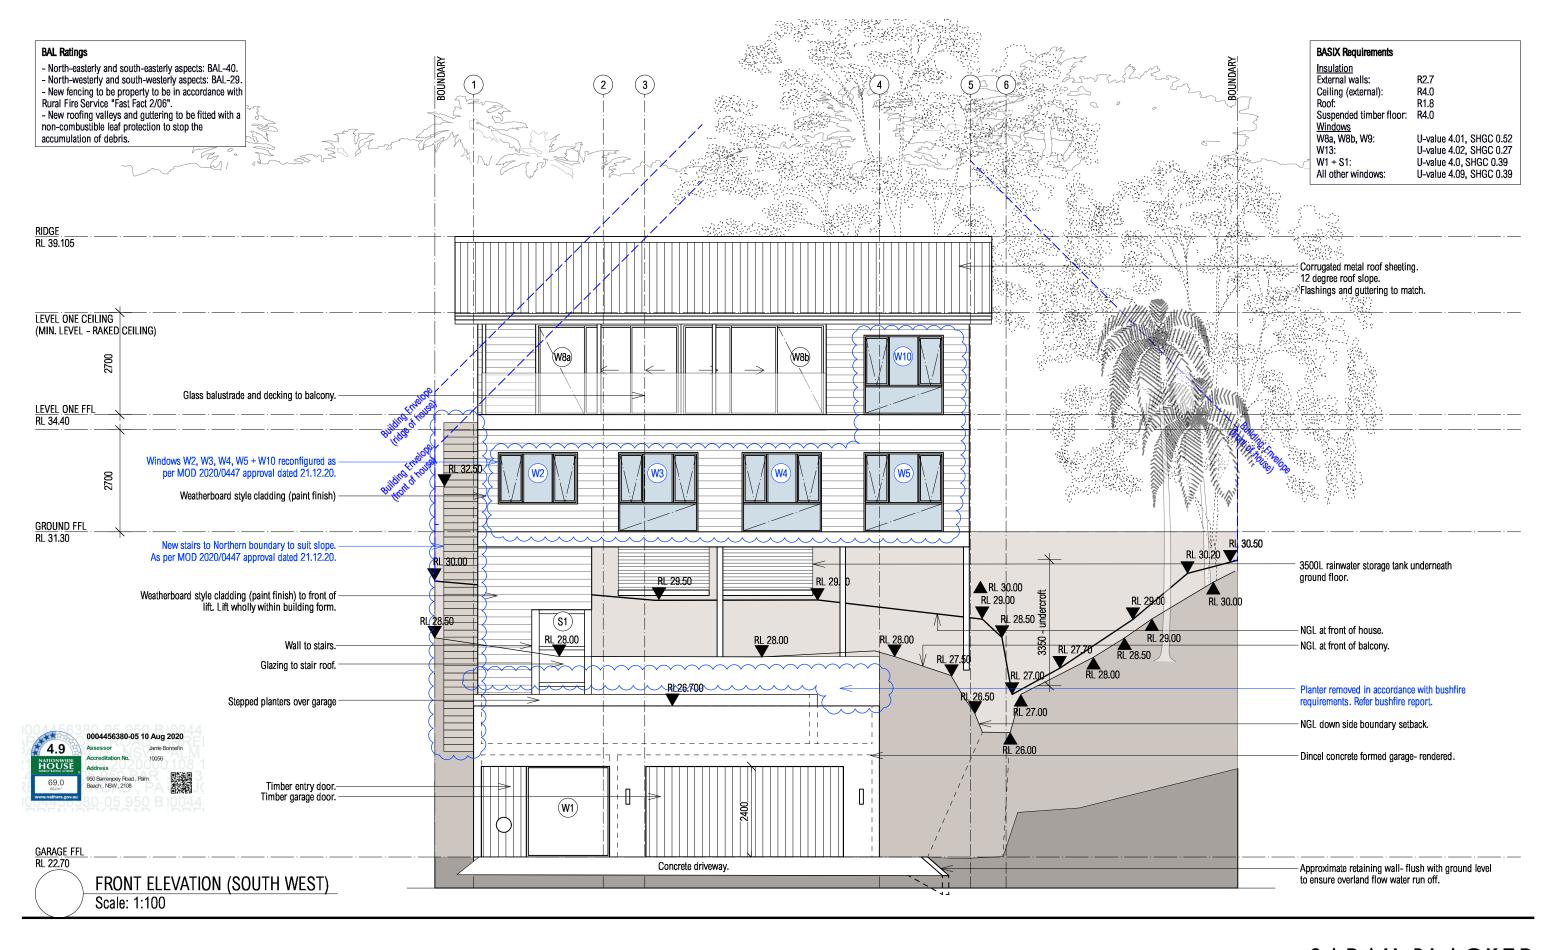

### DISCLAIMER

ALL WORKS TO BE IN ACCORDANCE WITH AUSTRALIAN STANDARDS, THE BUILDING CODE OF AUSTRALIA, OTHER RELEVANT CODES, AND WITH MANUFACTURER'S RECCOMENDATIONS AND INSTRUCTIONS. DO NOT SCALE FROM DRAWINGS. VERIFY ALL DIMENSIONS ON SITE PRIOR TO CONSTRUCTION. THIS DRAWING IS COPYRIGHT AND MAY NOT BE USED WITHOUT WRITTEN CONSENT FROM SARAH BLACKER.


PROJECT
ADDRESS
DOCUMENT
DRAWING

WILLIAMS HOUSE
950 BARRENJOEY RD, PALM BEACH
S4.55(1) APPLICATION
FRONT ELEVATION

DRAWING NO. DA.05
REVISION A
SCALE 1:100 @ A3
DATE 02.03.22

# SARAH BLACKER

ARCHITECT + INTERIOR DESIGNER ARCHITECT'S REG NO. 8403

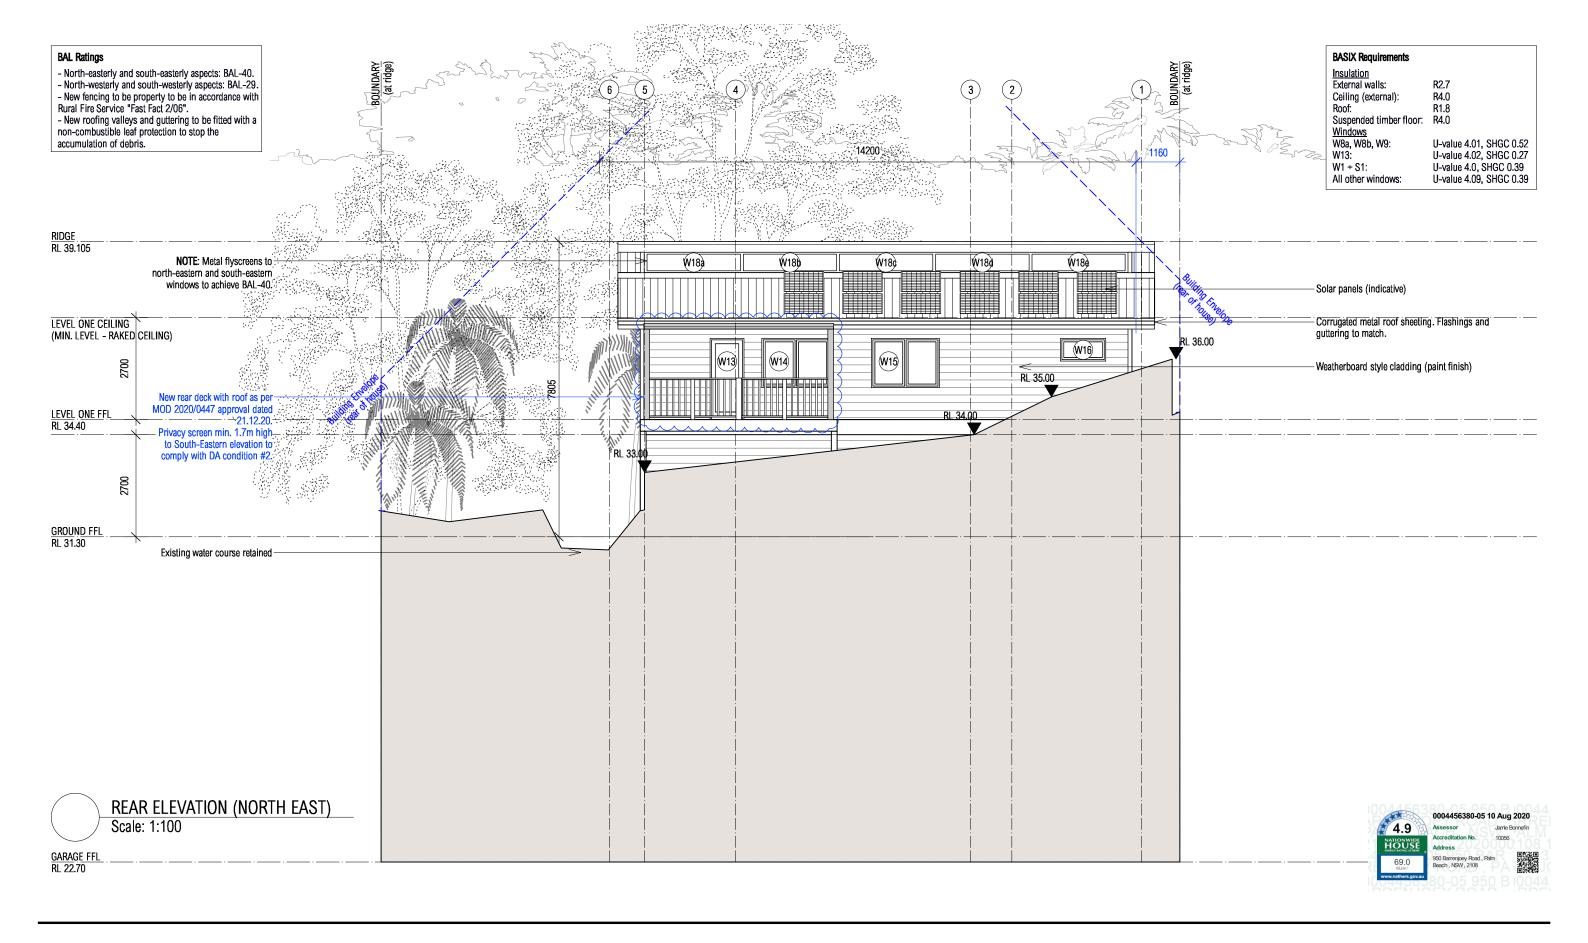

# DISCLAIMER

ALL WORKS TO BE IN ACCORDANCE WITH AUSTRALIAN STANDARDS, THE BUILDING CODE OF AUSTRALIA, OTHER RELEVANT CODES, AND WITH MANUFACTURER'S RECCOMENDATIONS AND INSTRUCTIONS. DO NOT SCALE FROM DRAWINGS. VERIFY ALL DIMENSIONS ON SITE PRIOR TO CONSTRUCTION. THIS DRAWING IS COPYRIGHT AND MAY NOT BE USED WITHOUT WRITTEN CONSENT FROM SARAH BLACKER.


PROJECT
ADDRESS
DOCUMENT
DRAWING

WILLIAMS HOUSE 950 BARRENJOEY RD, PALM BEACH S4.55(1) APPLICATION REAR ELEVATION DRAWING NO.
REVISION
SCALE
DATE

DA.06 A 1:100 @ A3 02.03.22

# SARAH BLACKER

ARCHITECT + INTERIOR DESIGNER
ARCHITECT'S REG NO. 8403

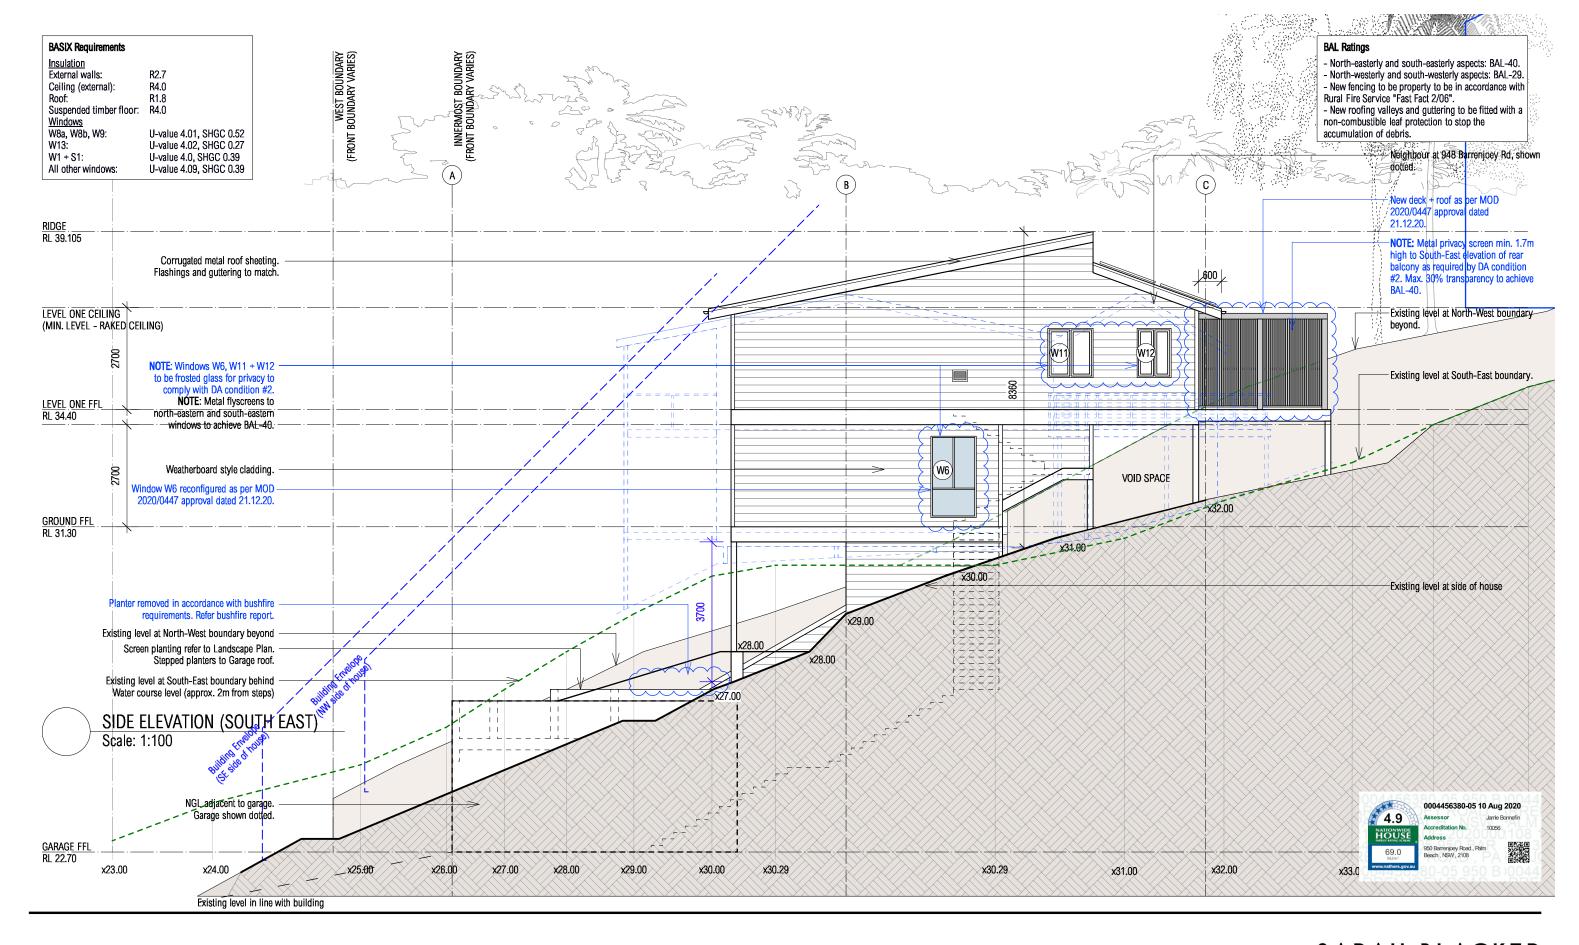

S.B

## DISCLAIMER

ALL WORKS TO BE IN ACCORDANCE WITH AUSTRALIAN STANDARDS, THE BUILDING CODE OF AUSTRALIA, OTHER RELEVANT CODES, AND WITH MANUFACTURER'S RECCOMENDATIONS AND INSTRUCTIONS. DO NOT SCALE FROM DRAWINGS. VERIFY ALL DIMENSIONS ON SITE PRIOR TO CONSTRUCTION. THIS DRAWING IS COPYRIGHT AND MAY NOT BE USED WITHOUT WRITTEN CONSENT FROM SARAH BLACKER.

PROJECT
ADDRESS
DOCUMENT
DRAWING

WILLIAMS HOUSE 950 BARRENJOEY RD, PALM BEACH S4.55(1) APPLICATION SOUTH EAST SIDE ELEVATION DRAWING NO.
REVISION
SCALE
DATE

DA.07


1:100 @ A3

02.03.22

Α

# SARAH BLACKER

ARCHITECT + INTERIOR DESIGNER ARCHITECT'S REG NO. 8403

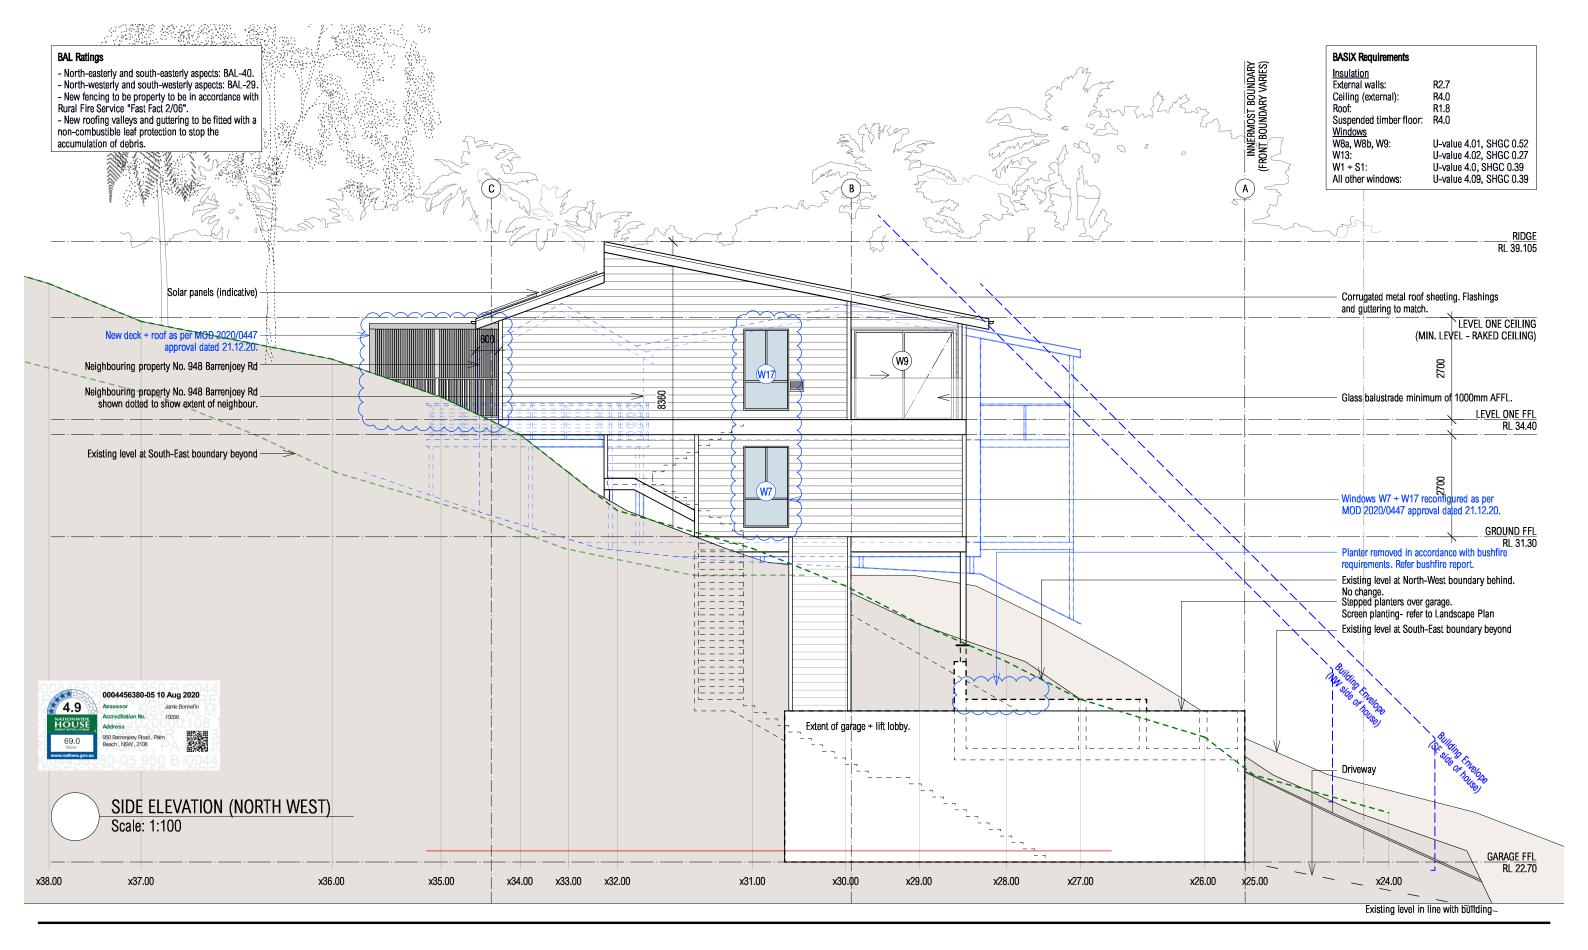

## DISCLAIMER


ALL WORKS TO BE IN ACCORDANCE WITH AUSTRALIAN STANDARDS, THE BUILDING CODE OF AUSTRALIA, OTHER RELEVANT CODES, AND WITH MANUFACTURER'S RECCOMENDATIONS AND INSTRUCTIONS. DO NOT SCALE FROM DRAWINGS. VERIFY ALL DIMENSIONS ON SITE PRIOR TO CONSTRUCTION. THIS DRAWING IS COPYRIGHT AND MAY NOT BE USED WITHOUT WRITTEN CONSENT FROM SARAH BLACKER.

PROJECT
ADDRESS
DOCUMENT
DRAWING

WILLIAMS HOUSE 950 BARRENJOEY RD, PALM BEACH S4.55(1) APPLICATION NORTH WEST SIDE ELEVATION DRAWING NO. DA.08
REVISION A
SCALE 1:100 @ A3
DATE 02.03.22

# SARAH BLACKER

ARCHITECT + INTERIOR DESIGNER ARCHITECT'S REG NO. 8403

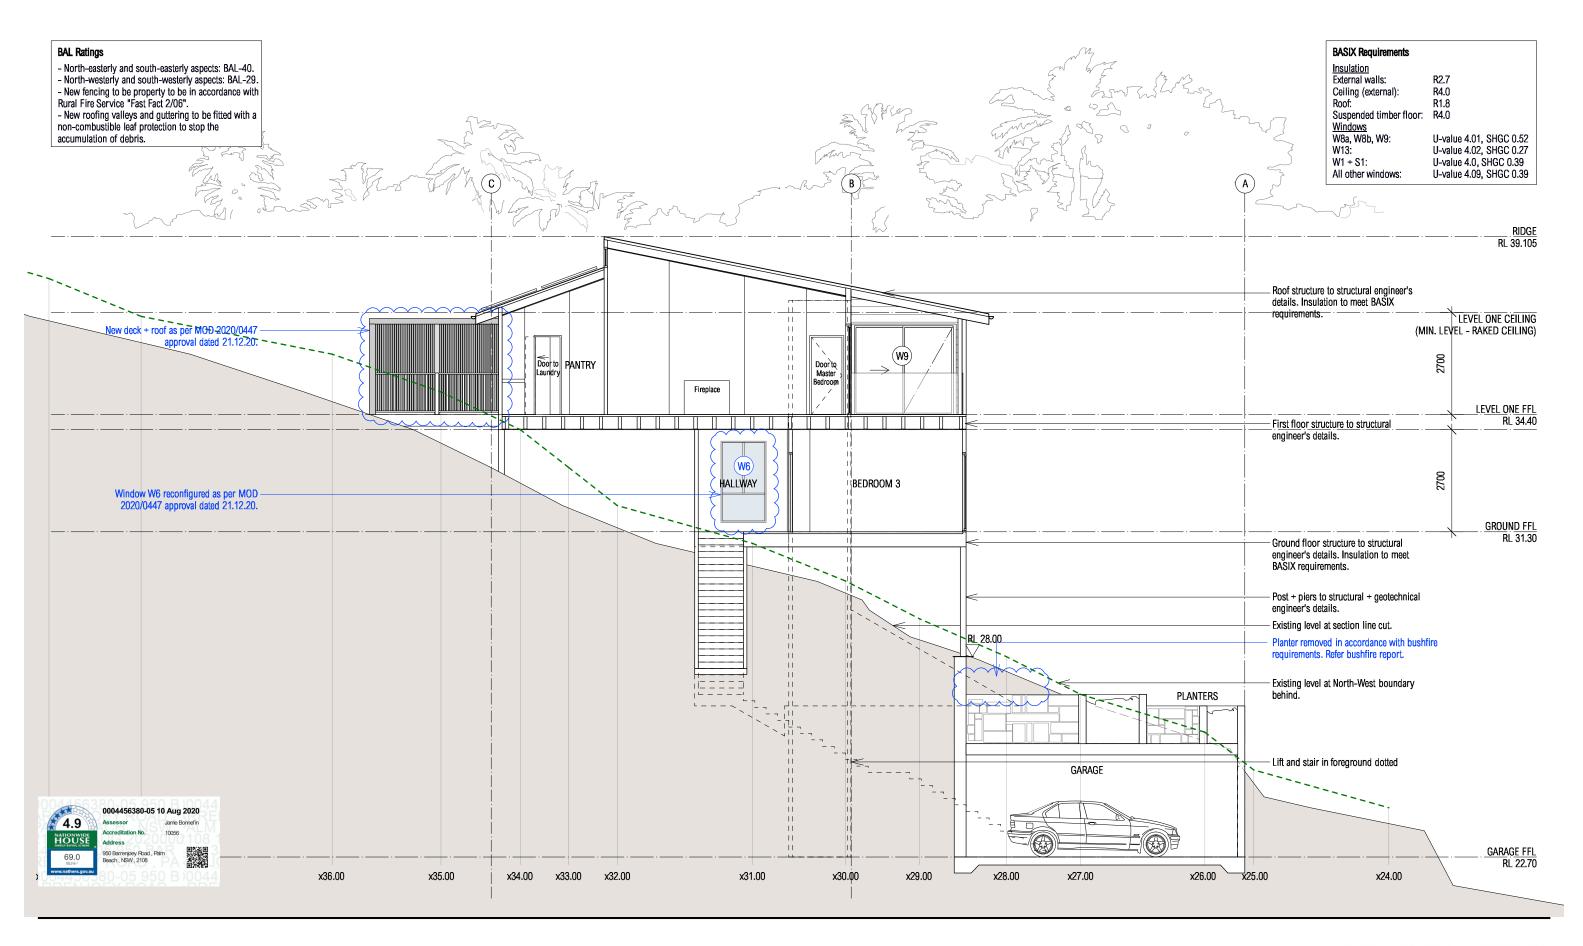

# DISCLAIMER


ALL WORKS TO BE IN ACCORDANCE WITH AUSTRALIAN STANDARDS, THE BUILDING CODE OF AUSTRALIA, OTHER RELEVANT CODES, AND WITH MANUFACTURER'S RECCOMENDATIONS AND INSTRUCTIONS. DO NOT SCALE FROM DRAWINGS. VERIFY ALL DIMENSIONS ON SITE PRIOR TO CONSTRUCTION. THIS DRAWING IS COPYRIGHT AND MAY NOT BE USED WITHOUT WRITTEN CONSENT FROM SARAH BLACKER.

PROJECT
ADDRESS
DOCUMENT
DRAWING

WILLIAMS HOUSE 950 BARRENJOEY RD, PALM BEACH S4.55(1) APPLICATION SECTION AA DRAWING NO. DA.09
REVISION A
SCALE 1:100 @ A3
DATE 02.03.22

# SARAH BLACKER

ARCHITECT + INTERIOR DESIGNER
ARCHITECT'S REG NO. 8403

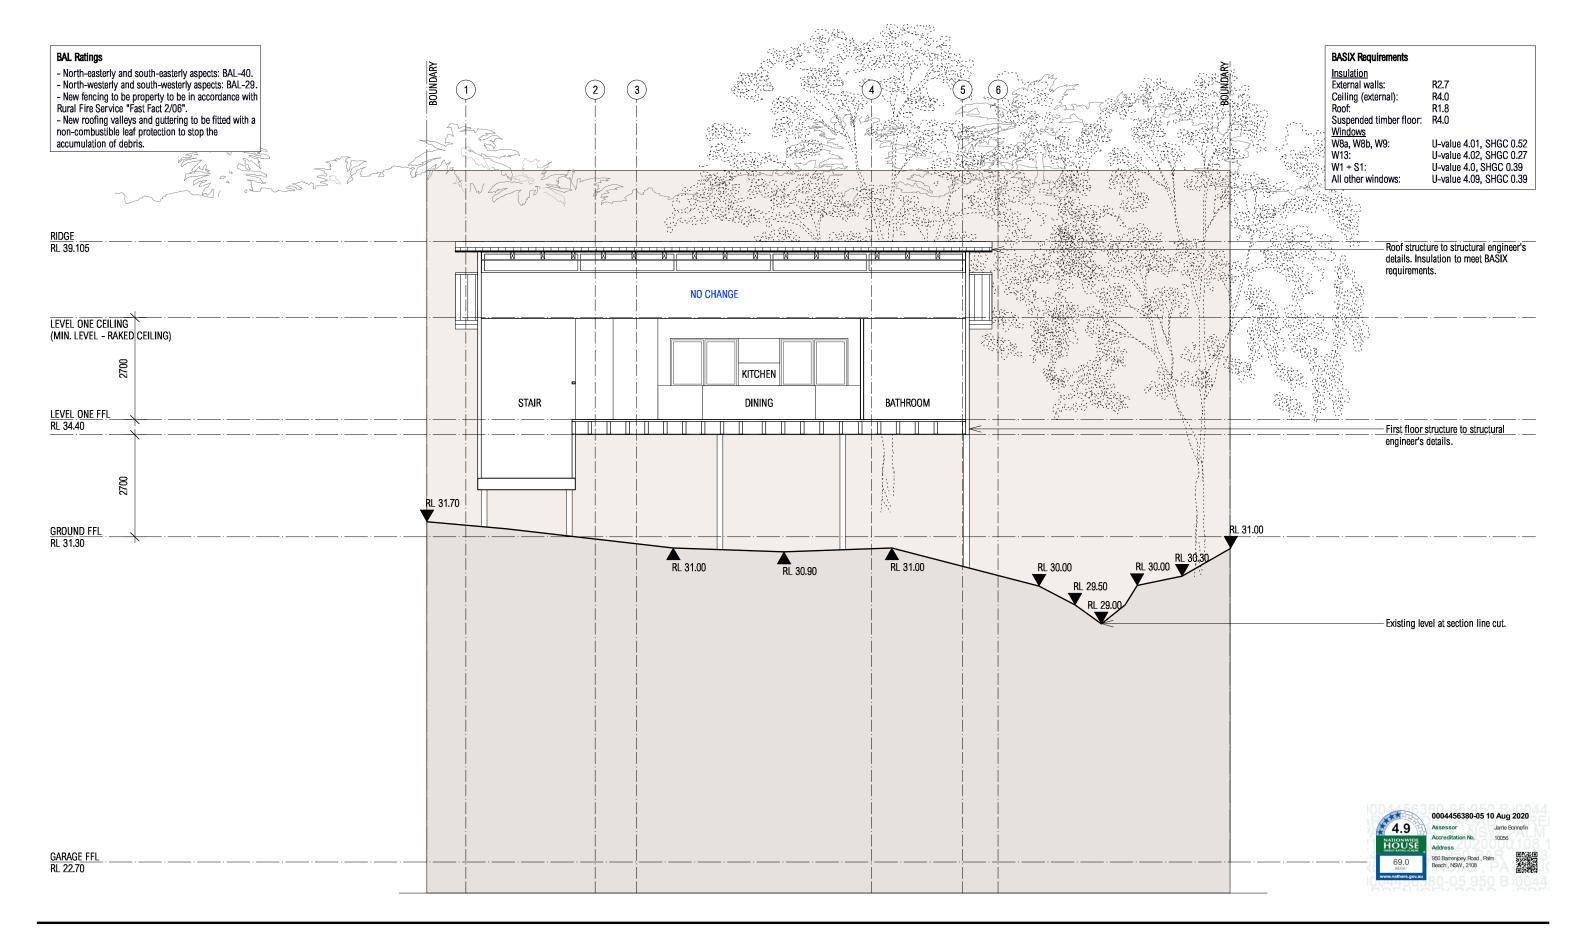

# DISCLAIMER

ALL WORKS TO BE IN ACCORDANCE WITH AUSTRALIAN STANDARDS, THE BUILDING CODE OF AUSTRALIA, OTHER RELEVANT CODES, AND WITH MANUFACTURER'S RECCOMENDATIONS AND INSTRUCTIONS. DO NOT SCALE FROM DRAWINGS. VERIFY ALL DIMENSIONS ON SITE PRIOR TO CONSTRUCTION. THIS DRAWING IS COPYRIGHT AND MAY NOT BE USED WITHOUT WRITTEN CONSENT FROM SARAH BLACKER.

PROJECT
ADDRESS
DOCUMENT
DRAWING

WILLIAMS HOUSE 950 BARRENJOEY RD, PALM BEACH S4.55(1) APPLICATION SECTION BB DRAWING NO. DA.09a
REVISION A
SCALE 1:100 @ A3
DATE 02.03.22

# SARAH BLACKER

ARCHITECT + INTERIOR DESIGNER
ARCHITECT'S REG NO. 8403



HOUSE CLADDING James Hardie Linea Weatherboard painted Colour: Colorbond "Windspray" or darker



WINDOW TRIMS + ROOF FRAME: NON-COMBUSTIBLE TO COMPLY WITH BAL-40 Colour: White/Off Grey to match windows



GARAGE

Sliding Aluminium Doors

Colour: Colorbond "Woodland Grey" or darker



PRIVACY SCREEN Vertical metal privacy screen with max. 30% transparency to achieve BAL-40. Decowood or similar. Colour: TBA




GLAZING Sliding Aluminium Doors



Matt white aluminium framed. Bushfire rated where required: BAL-29 to north-western and south-western windows; BAL-40 with metal flyscreens to north-eastern and south-eastern windows. Colours to be confirmed. To be selected from DCP colour range.



CORRUGATED METAL ROOFING + FLASHING + GUTTERING New roofing valleys and guttering to be fitted with a non-combustible leaf protection to stop the accumulation of debris. Colour: Colorbond Woodland Grey

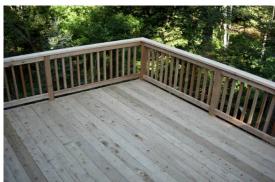

COVERED TIMBER BALCONY + BALUSTRADE Natural weathered grey hardwood decking and balustrade; non-combustible bushfire resisting timber.



COVERED TIMBER DECKING Natural weathered grey hardwood decking; non-combustible bushfire resisting timber.



TIMBER GARAGE DOOR: NON-COMBUSTIBLE BUSHFIRE-RESISTING TIMBER Colour: Natural timber or Colorbond "Woodland Grey" or darker

### REQUIRED BAL RATINGS

- North-easterly and south-easterly aspects: BAL-40 (no exposed timber).
   North-westerly and south-westerly aspects: BAL-29 (non-combustible material bushfire resisting timber).
- New fencing to property to be in accordance with Rural Fire Service "Fast Fact 2/06".
  New roofing valleys and guttering to be fitted with a non-combustible leaf protection to stop the accumulation of debris.



## DISCLAIMER

ALL WORKS TO BE IN ACCORDANCE WITH AUSTRALIAN STANDARDS, THE BUILDING CODE OF AUSTRALIA, OTHER RELEVANT CODES, AND WITH MANUFACTURER'S RECCOMENDATIONS AND INSTRUCTIONS. DO NOT SCALE FROM DRAWINGS. VERIFY ALL DIMENSIONS ON SITE PRIOR TO CONSTRUCTION. THIS DRAWING IS COPYRIGHT AND MAY NOT BE USED WITHOUT WRITTEN CONSENT FROM SARAH BLACKER.

**PROJECT ADDRESS DOCUMENT** DRAWING

WILLIAMS HOUSE 950 BARRENJOEY RD, PALM BEACH S4.55(1) APPLICATION FINISHES SCHEDULE

DRAWING NO. REVISION SCALE DATE

DA.10

Α

NTS

02.03.22

ARCHITECT + INTERIOR DESIGNER ARCHITECT'S REG NO. 8403

SARAH BLACKER