


rl 34.53 (ffl lower floor)


#### **Existing Street Elevation**

# Note: All footings, slabs, structural beams, etc, to future engineers details, All wall/roof connections + member sizes to NCC & future engineers details, All wall/roof connections to stromwater system to relevant Building Codes, Council requirements. All wall-roof connect to existing sewer system to relevant to all relevant NCC, Building Codes + Council requirements. All materials to comply with all relevant NCC, Building Codes + Council requirements. All works to comply with all relevant NCC, Building Codes + Council requirements. All works to comply with all relevant NCC, Building Codes + Council requirements. All works to comply with all relevant NCC, Building Codes + Council requirements. All works to comply with all relevant NCC, Building Codes + Council requirements. All works to comply with all relevant NCC, Building Codes + Council requirements. All works to comply with all relevant NCC, Building Codes + Council requirements. All works to comply with all relevant NCC, Building Codes + Council requirements. All works to comply with all relevant NCC, Building Codes + Council requirements. All works to comply with all relevant NCC, Building Codes + Council requirements. All works to comply with all relevant NCC, Building Codes + Council requirements. All works to comply with all relevant NCC, Building Codes + Council requirements. All works to comply with all relevant NCC, Building Codes + Council requirements. All works to comply with all relevant NCC, Building Codes + Council requirements. All works to comply with all relevant NCC, Building Codes + Council requirements. All works to comply with all relevant NCC, Building Codes + Council requirements. All works to comply with all relevant NCC, Building Codes + Council requirements. A N D Y L E H M A N D E S I G N AND N D BEXISTING WALL CONCRETE C

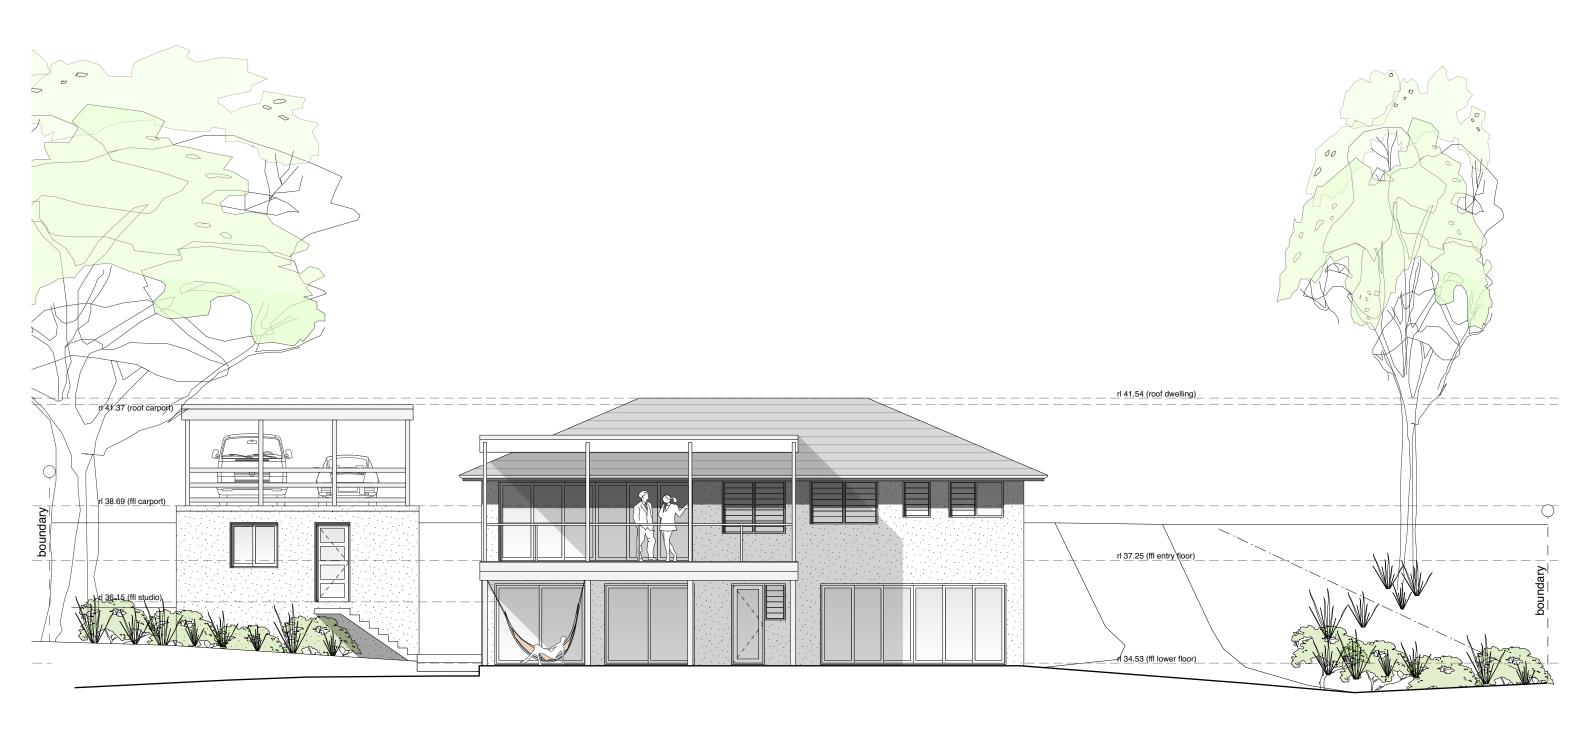


**Existing North Elevation** 

	MATERIALS:			Daniel & Mal Mussett			
All footings, slabs, structural beams, etc, to future engineers details.	BAL BALUSTRADE CONC. CONCRETE	EXISTING WALL		Daniel & Mel Mussett			
All wall/roof connections + member sizes to NCC & future engineers details.  Rainwater from gutters to connect to stormwater system to relevant	COS CONCRETE	TO BE REMOVED		6 Net Road Avalon Beach NSW 2107 LOT 8 DP 232	2257, Site Area 1030.7m <sup>2</sup>		_
Building Codes, Council requirements.  All wastewater/sewage to connect to existing sewer system	DP DOWNPIPE FG FIXED GLAZING	NEW WALL	PROJECT	Alterations & Additions	ANDY LEHMAN DESIGN		OF
to all relevant NCC, Building Codes + Council requirements.	HWD HARDWOOD		DRAWING	Existing North Elevation		DWG. NO.	MOD. <b>05</b>
All materials to comply with BAL12.5 requirements. All works to comply with all relevant NCC, Building Codes + Council	LC LIGHTWEIGHT CLADDING MASONRY		DRAWING	Exising North Elevation	Tel. 0414 466 665	SCALE	1:100@A3
requirements.	MRS METAL ROOF SHEETING		NOTES	Please print in A3 or A1. This drawing is copyright and is for Development	Email: andy@andylehman.com.au	DATE	18th April 2024
	NGL NATURAL GROUND LEVEL			Application purposes only. Do not measure off drawings.	If in doubt ask.	ISSUE	

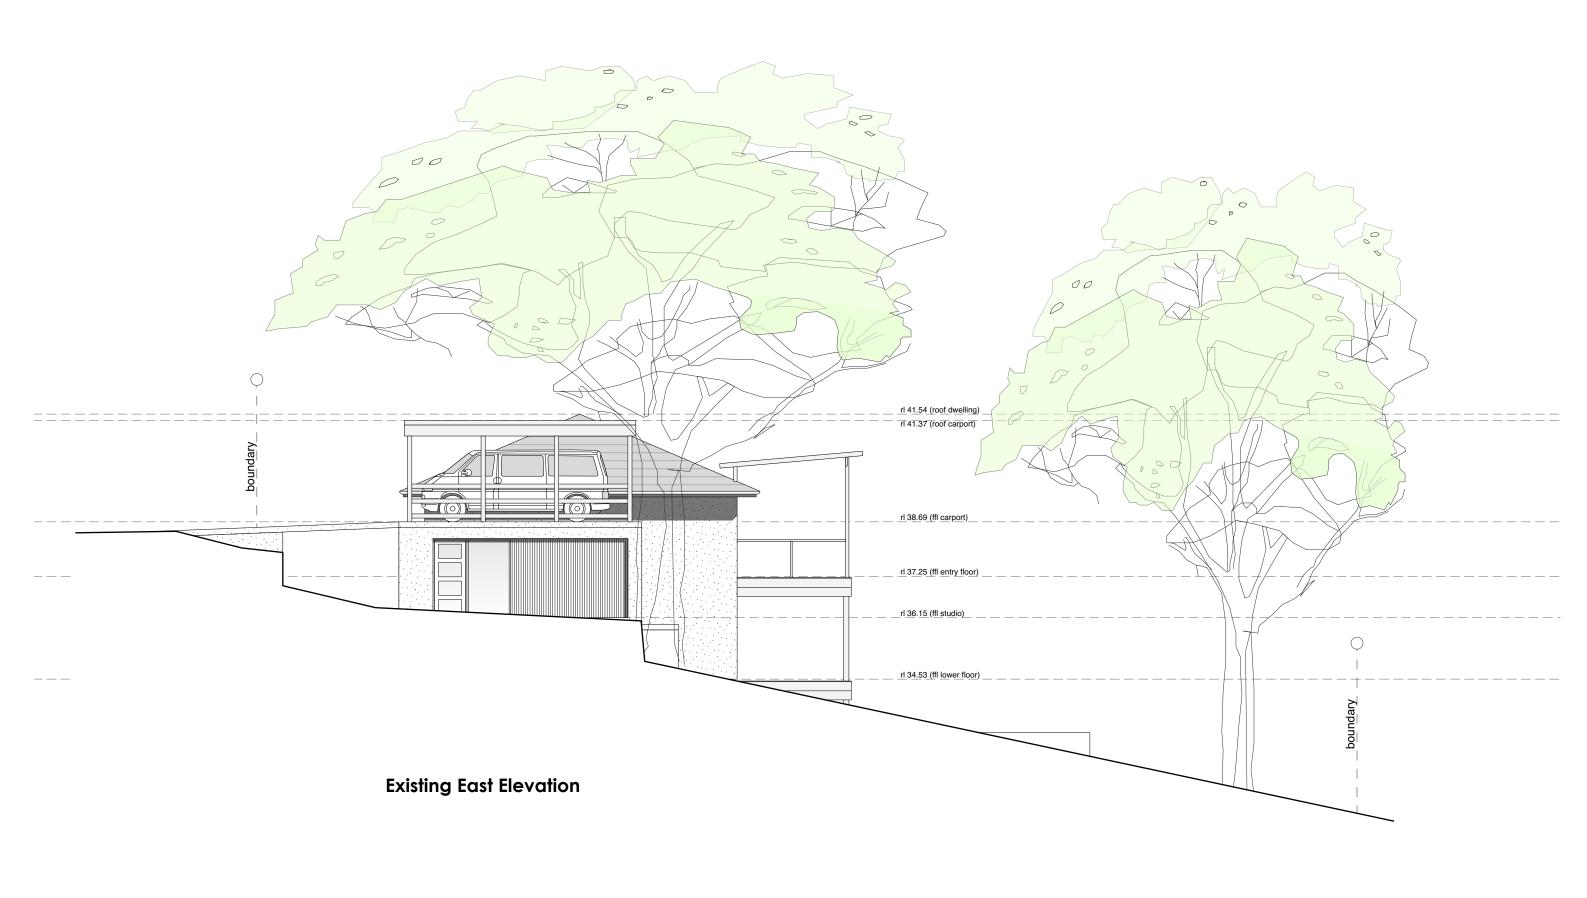



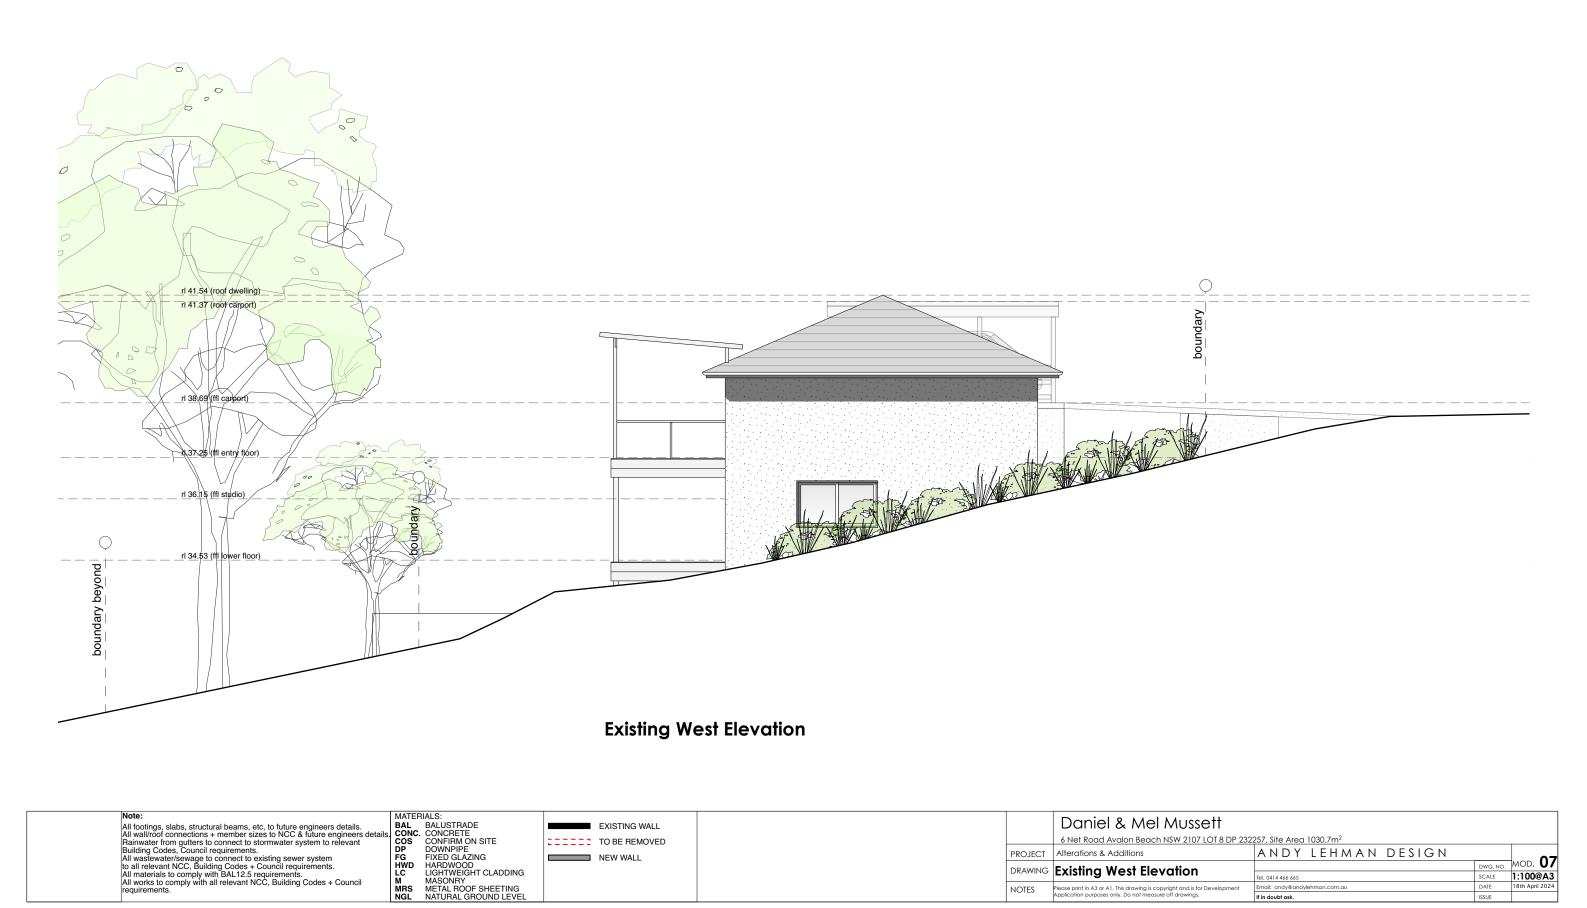

EXISTING WALL

TO BE REMOVED

NEW WALL

Daniel & Mel Mussett

Please print in A3 or A1. This drawing is copyright and is for Development Application purposes only. Do not measure off drawings.

Alterations & Additions

NOTES

DRAWING Existing West Elevation

6 Net Road Avalon Beach NSW 2107 LOT 8 DP 232257, Site Area 1030.7m<sup>2</sup>

Alterations & Additions

A N D Y L E H M A N D E S I G N

Tel. 0414 466 665

DWG. NO. MOD. **07**SCALE 1:100@A3


DATE 18th April 2024


All footings, slabs, structural beams, etc, to future engineers details. All wall/roof connections + member sizes to NCC & future engineers detail Rainwater from gutters to connect to stormwater system to relevant Building Codes, Council requirements.


All wastewater/sewage to connect to existing sewer system to all relevant NCC, Building Codes + Council requirements.


All materials to comply with BAL12.5 requirements.


All works to comply with all relevant NCC, Building Codes + Council requirements.

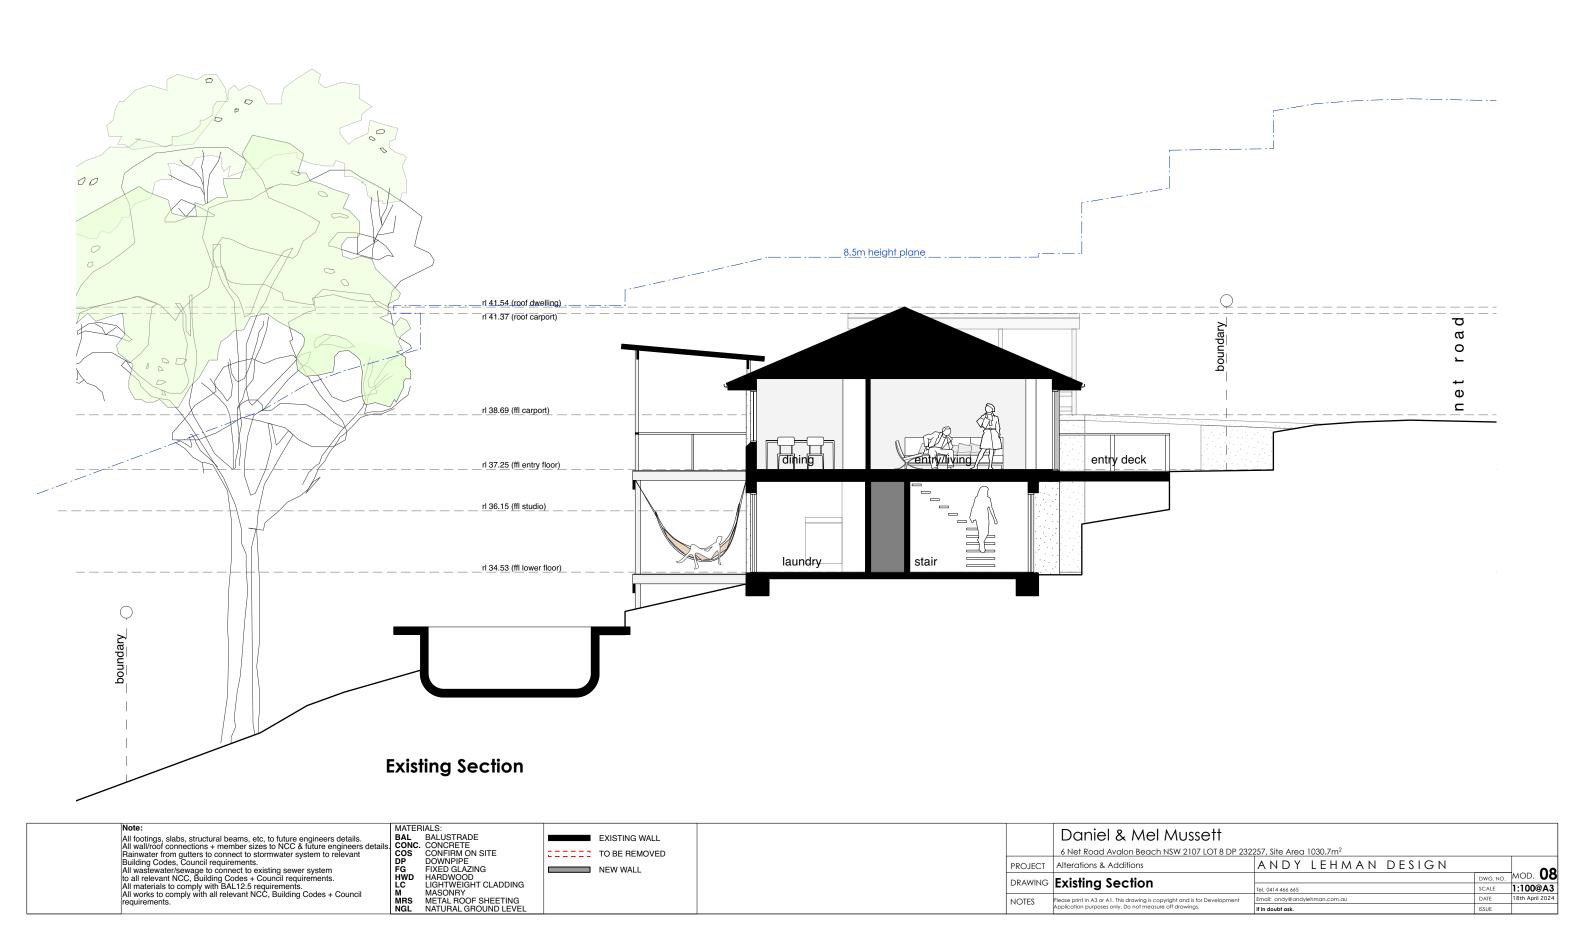

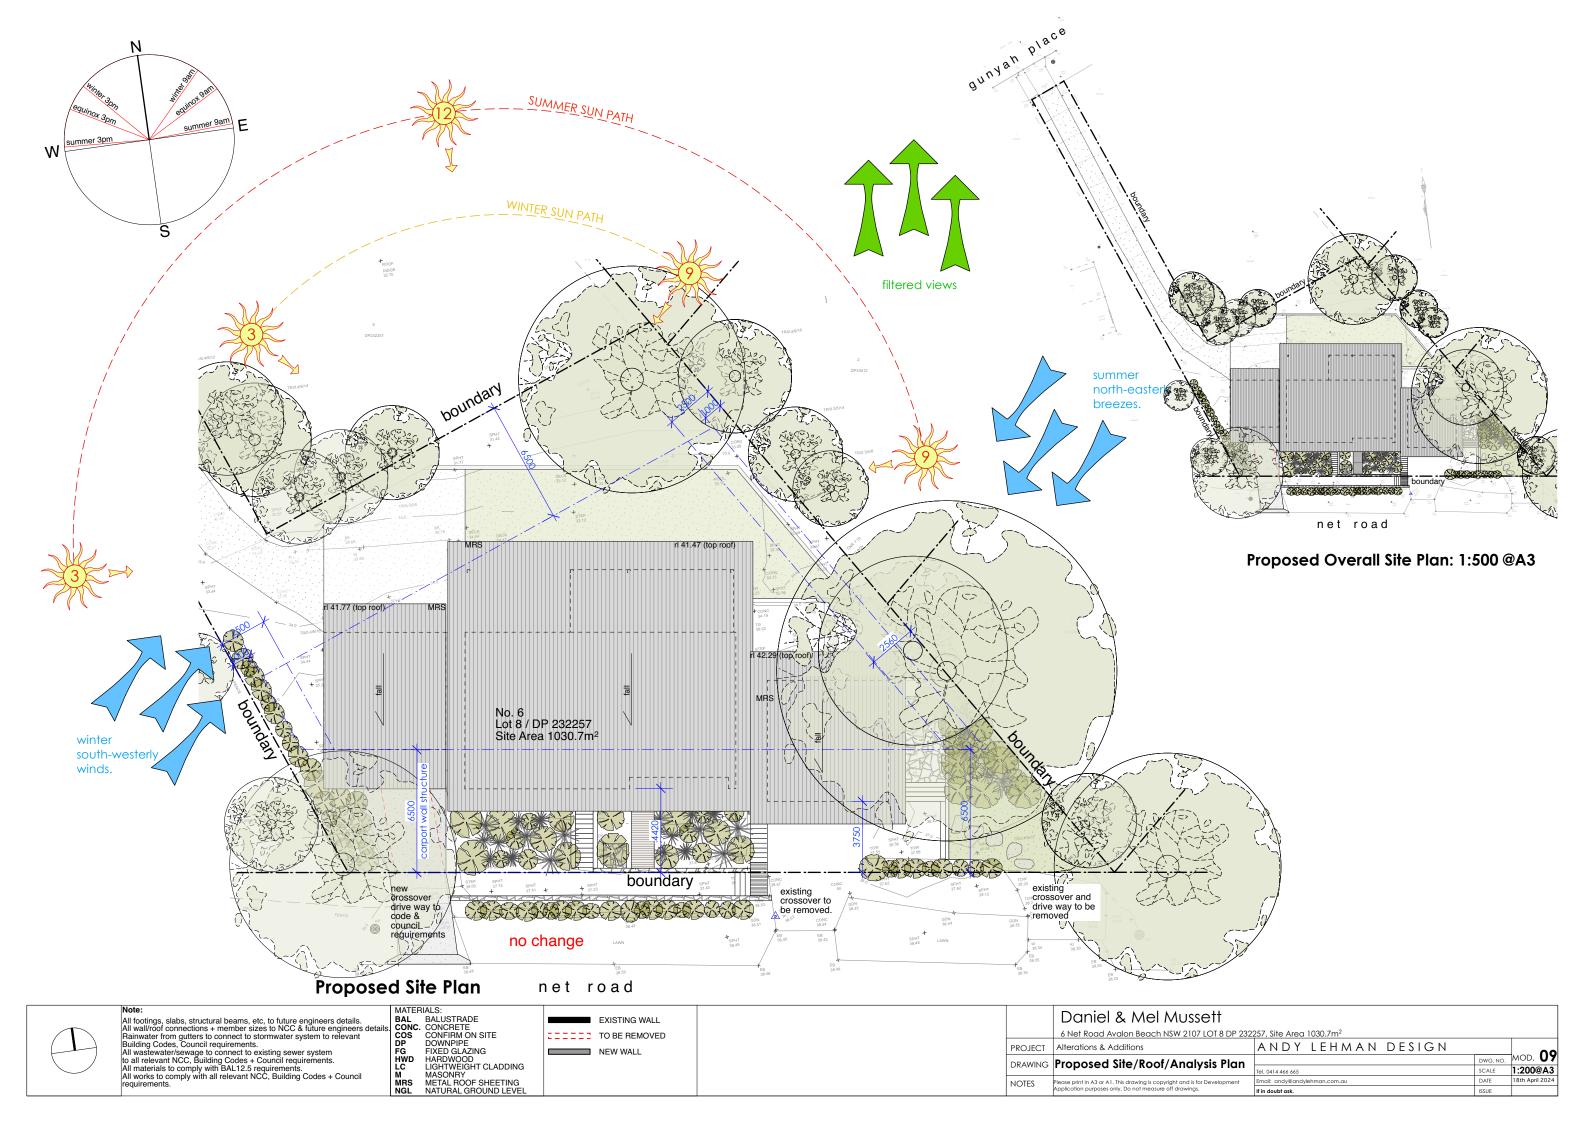

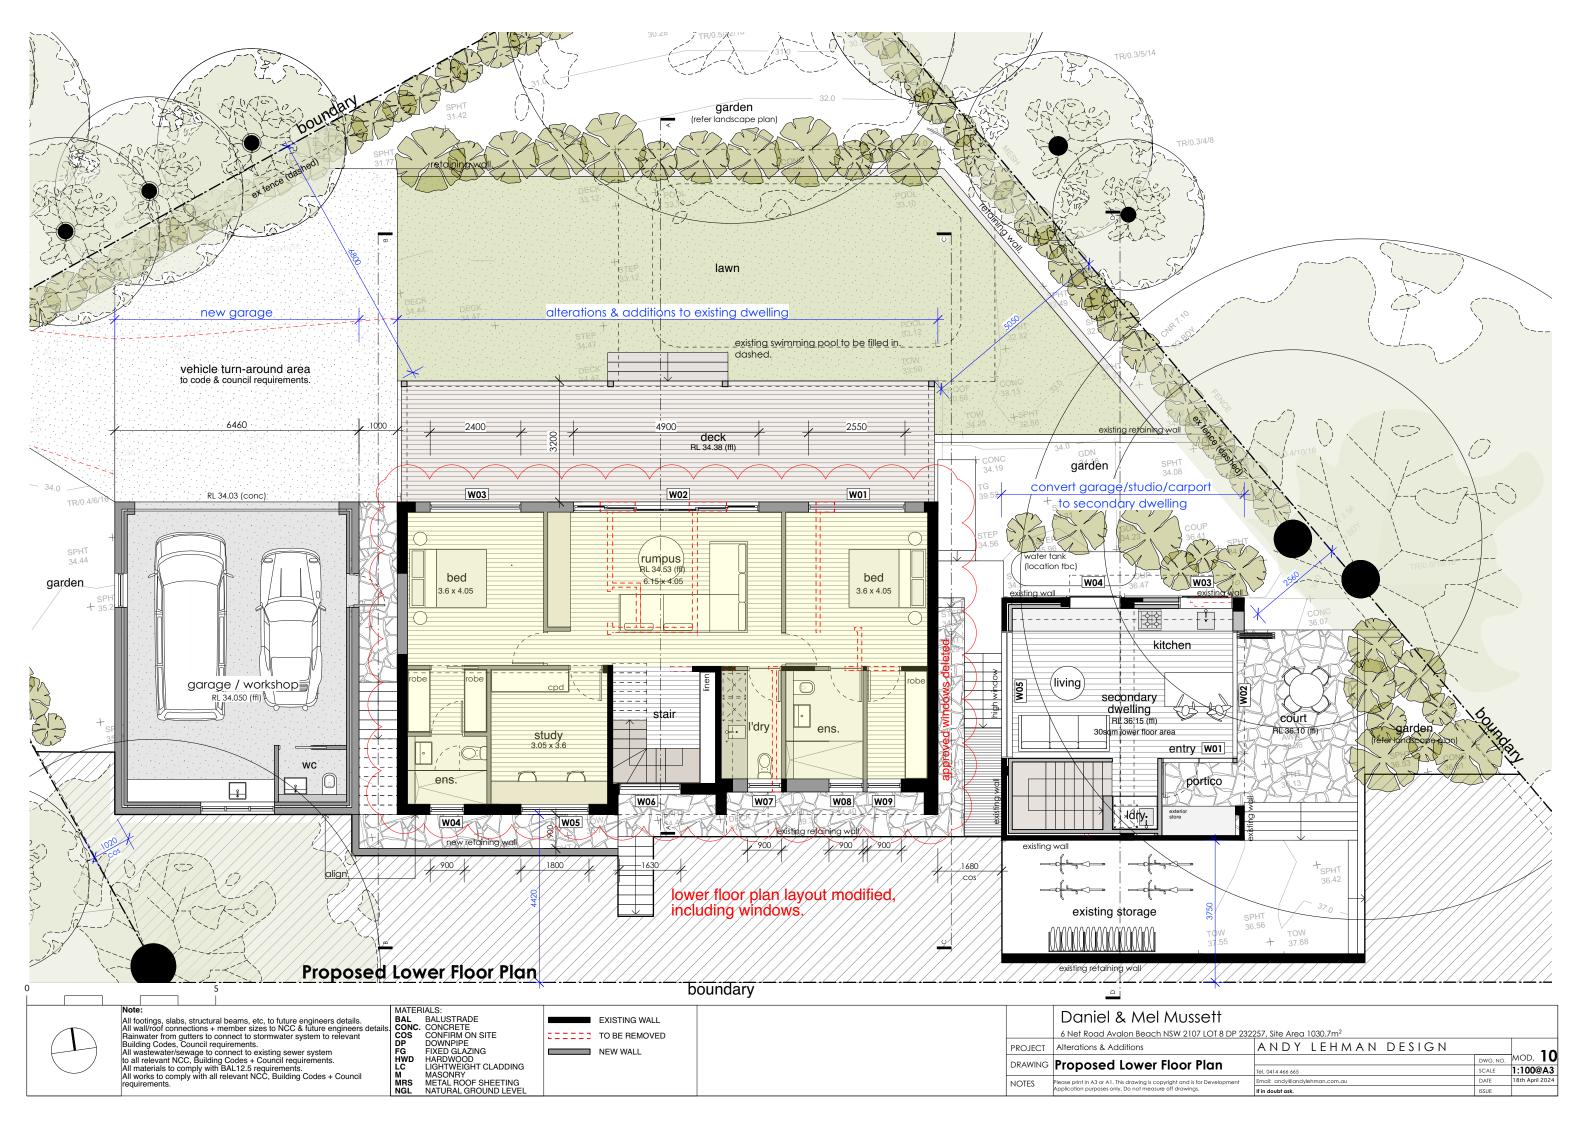

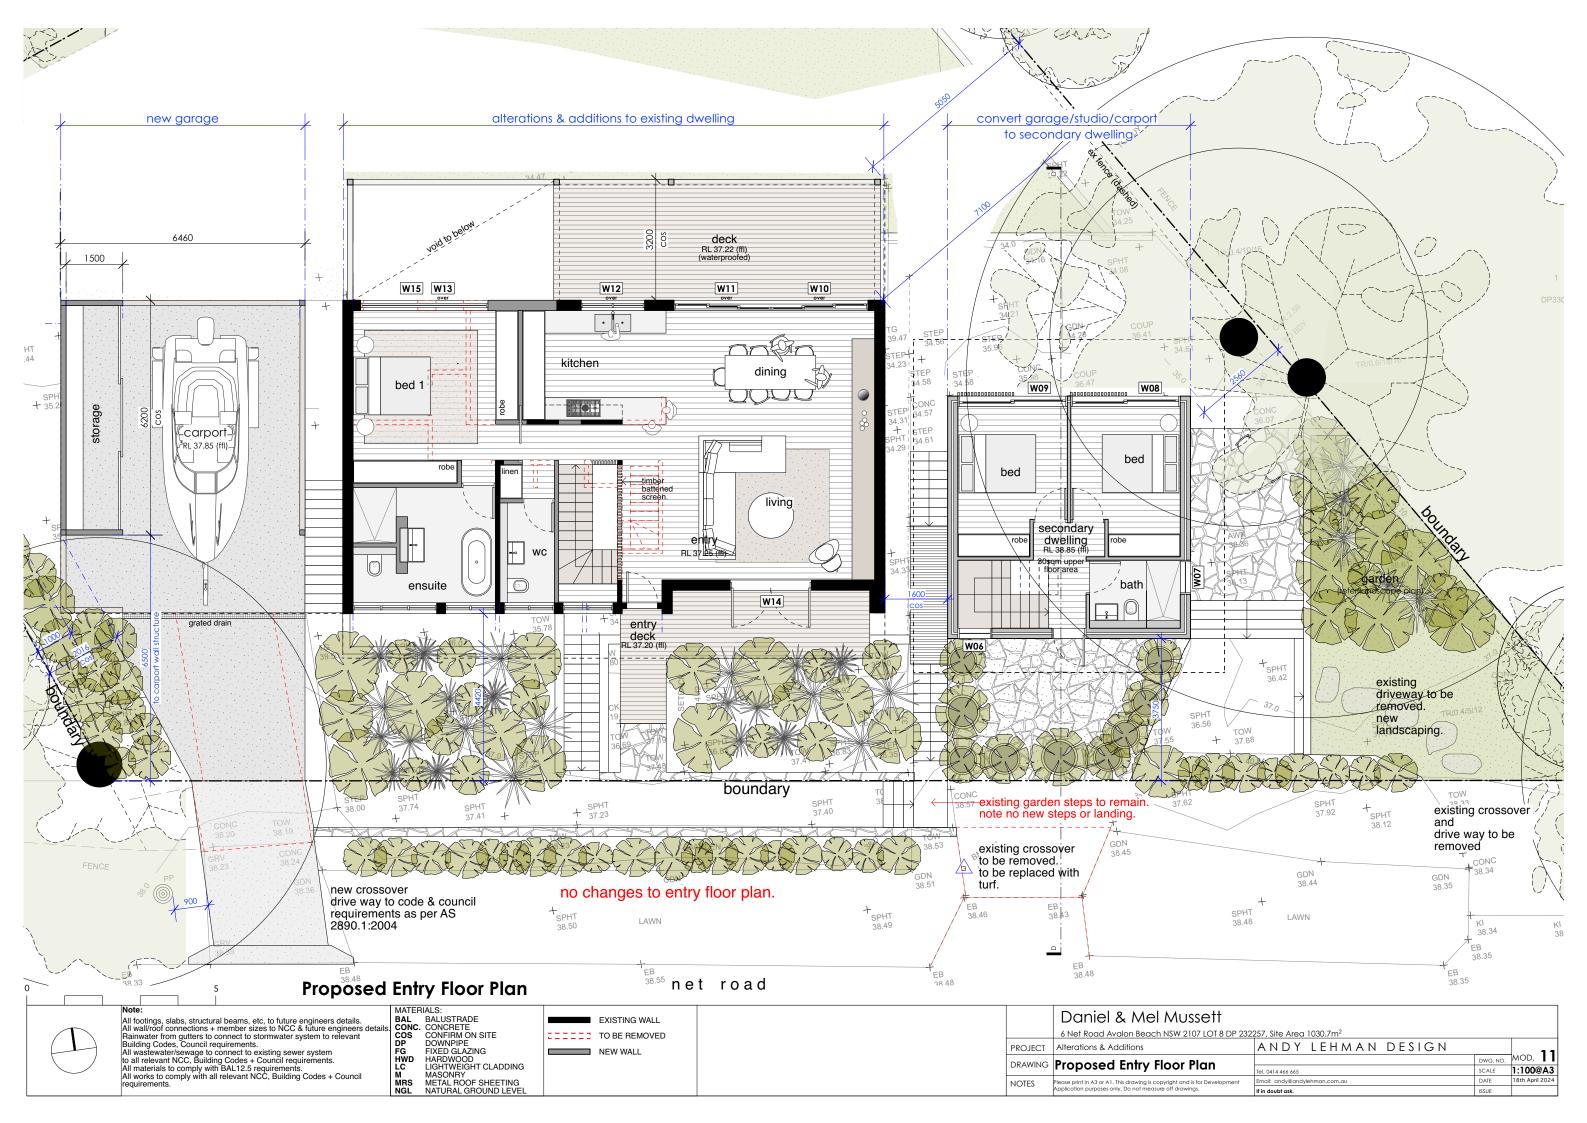


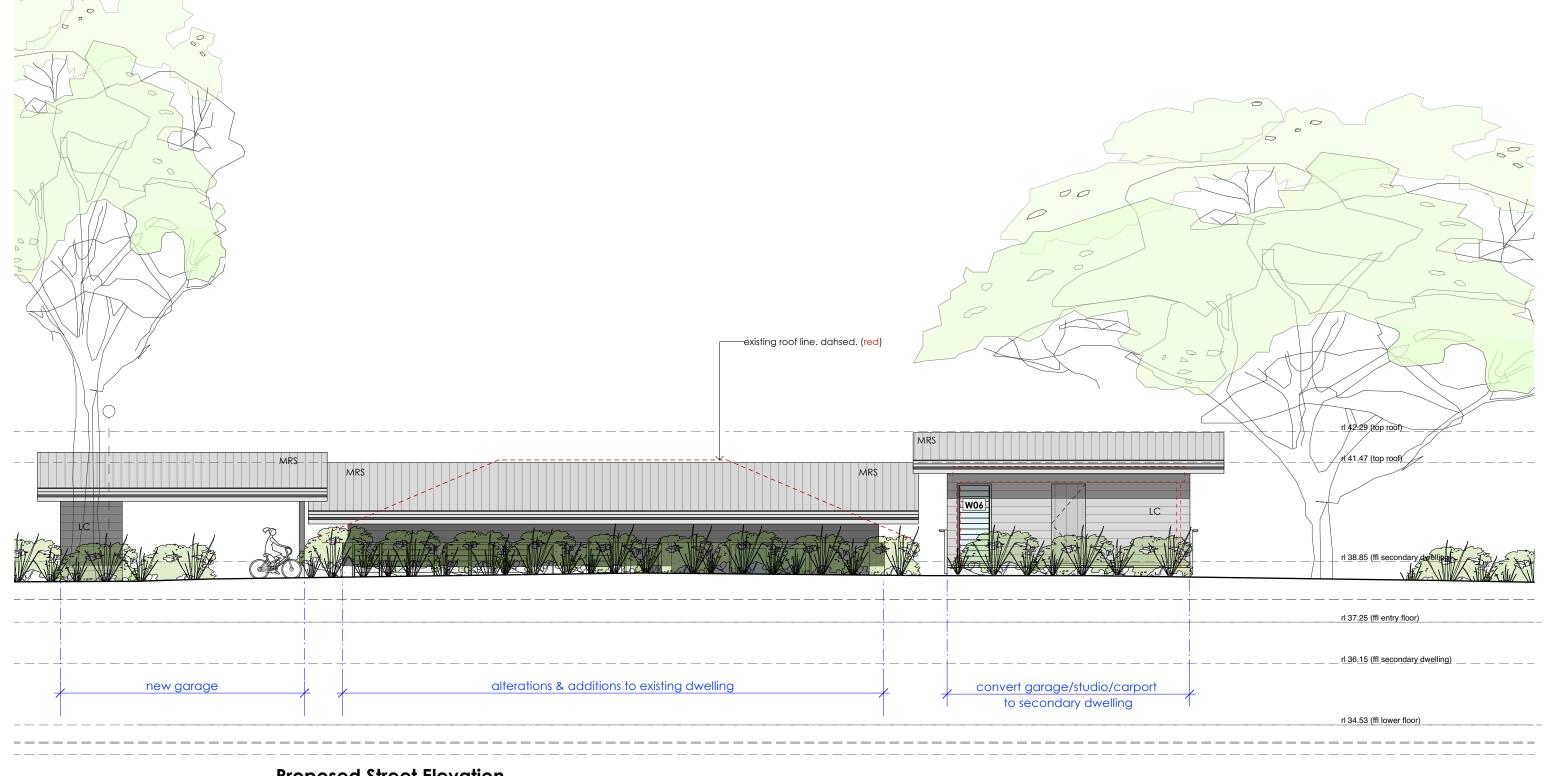

#### **Proposed Street Elevation**

no change to street elevation



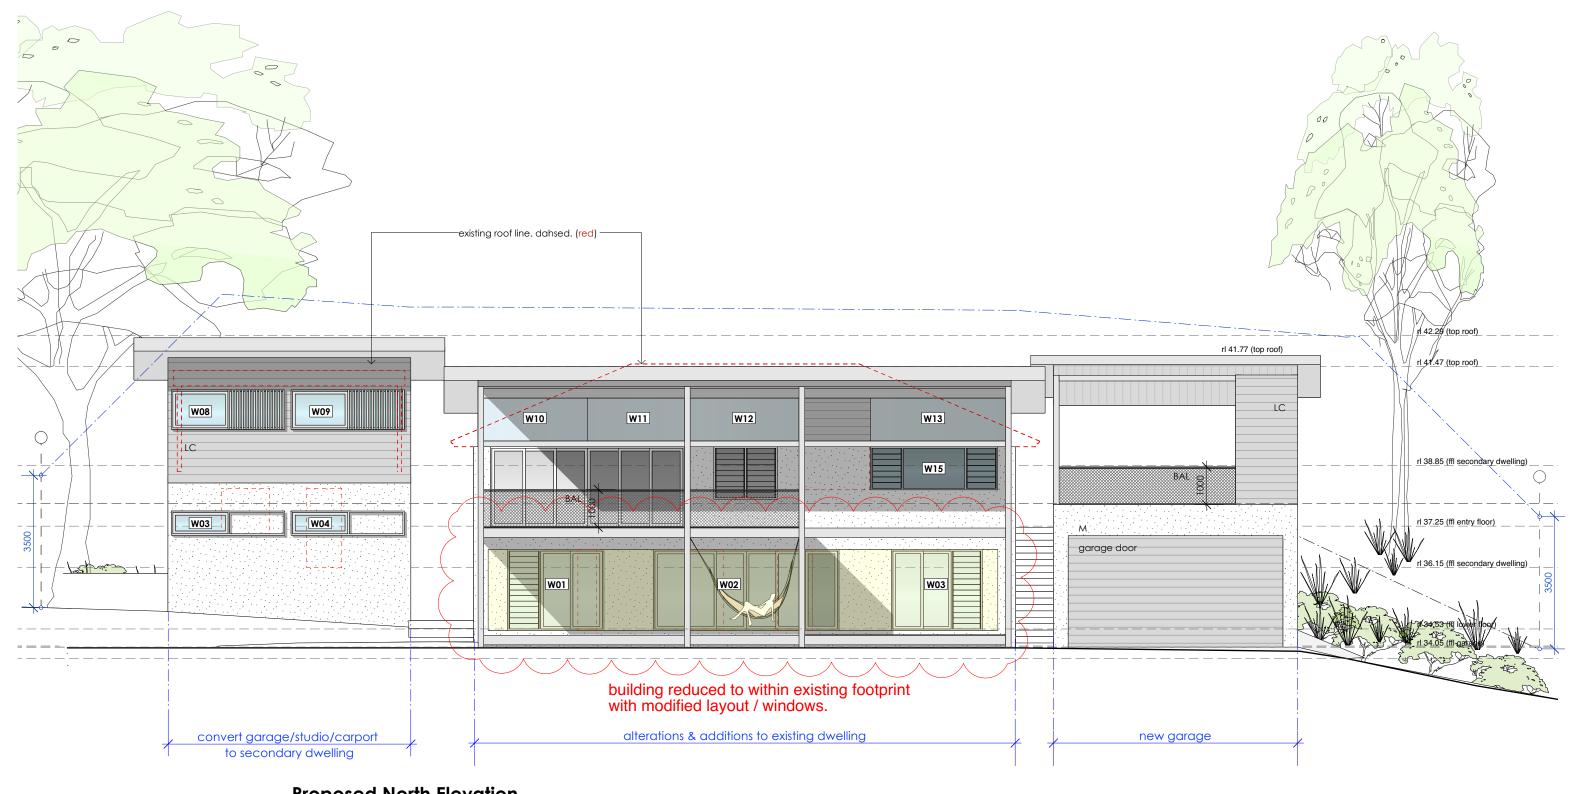


### **Proposed North Elevation**

Note:	MATERIALS:			Develol 9 Adol Advisorth			
All footings, slabs, structural beams, etc, to future engineers details. All wall/roof connections + member sizes to NCC & future engineers de	BAL BALUSTRADE	EXISTING WALL		Daniel & Mel Mussett			
All wall/roof connections + member sizes to NCC & future engineers de Rainwater from gutters to connect to stormwater system to relevant	COS CONFIRM ON SITE	TO BE REMOVED		6 Net Road Avalon Beach NSW 2107 LOT 8 DP 232	257, Site Area 1030.7m <sup>2</sup>		
Building Codes, Council requirements.  All wastewater/sewage to connect to existing sewer system	DP DOWNPIPE FG FIXED GLAZING	NEW WALL	PROJECT	Alterations & Additions	ANDY LEHMAN DESIGN		
to all relevant NCC, Building Codes + Council requirements.	HWD HARDWOOD	THEW WALL	DRAWING	Proposed North Elevation		DWG. NO.	MOD.
All materials to comply with BAL12.5 requirements. All works to comply with all relevant NCC, Building Codes + Council	LC LIGHTWEIGHT CLADDING M MASONRY		DRAWING	rioposea Norin Elevation	Tel. 0414 466 665	SCALE	1:100@A3
requirements.	MRS METAL ROOF SHEETING		NOTES	Please print in A3 or A1. This drawing is copyright and is for Development	Email: andy@andylehman.com.au	DATE	18th April 202
100	NGL NATURAL GROUND LEVEL			Application purposes only. Do not measure off drawings.	If in doubt ask.	ISSUE	





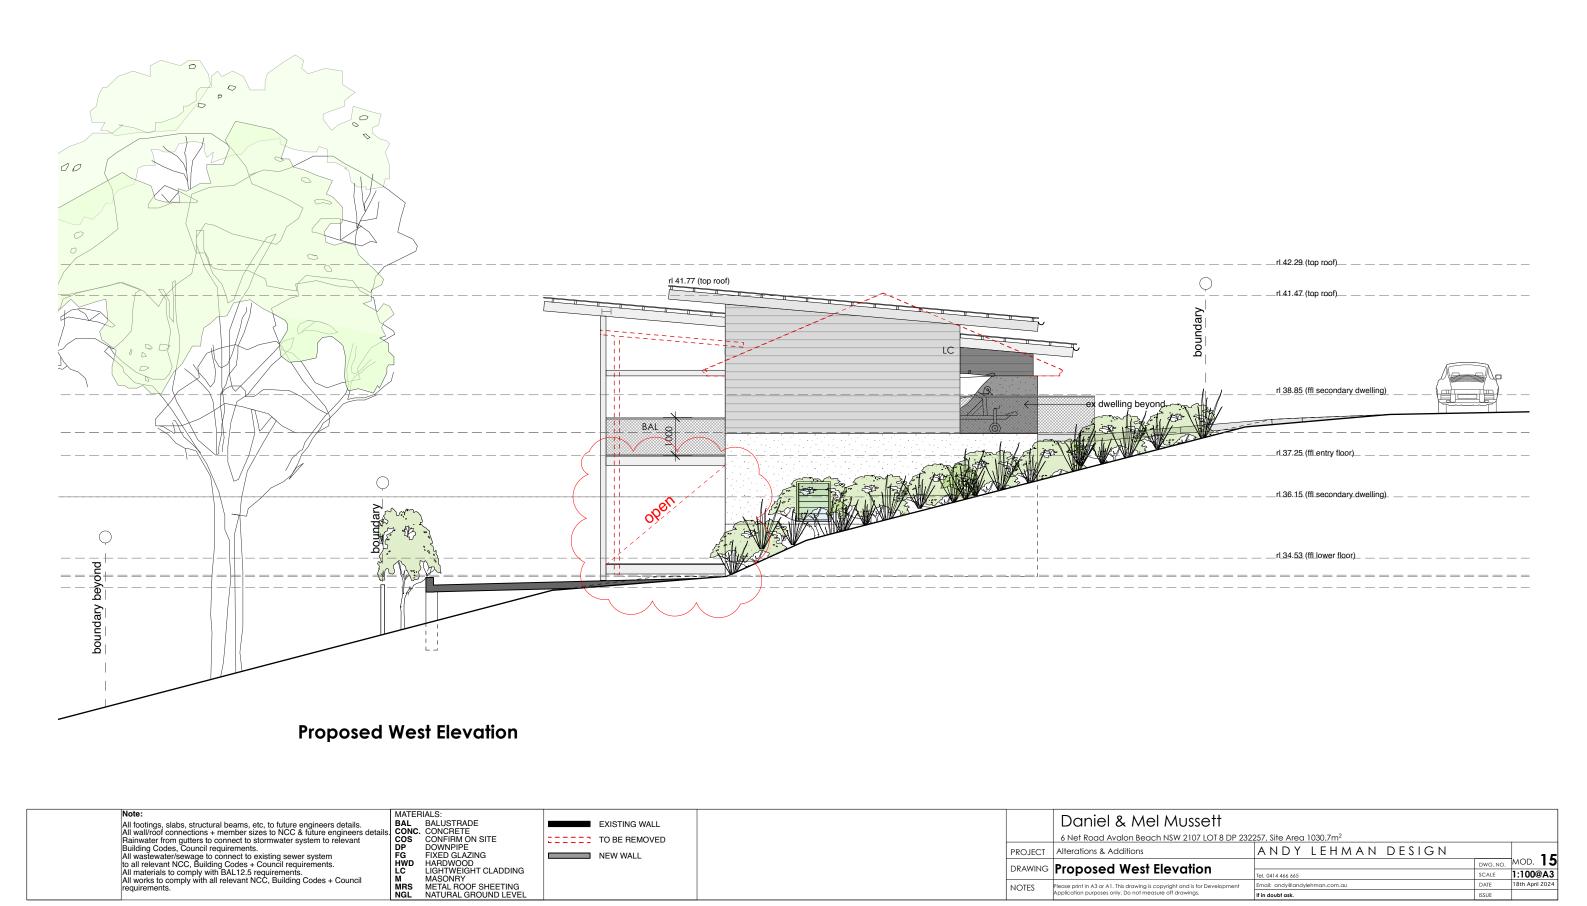

EXISTING WALL

TO BE REMOVED

NEW WALL

Daniel & Mel Mussett

lease print in A3 or A1. This drawing is copyright and is for Development application purposes only. Do not measure off drawings.

Alterations & Additions

NOTES

**Proposed West Elevation** 

6 Net Road Avalon Beach NSW 2107 LOT 8 DP 232257, Site Area 1030.7m<sup>2</sup>

ANDY LEHMAN DESIGN

Tel. 0414 466 665

DWG. NO. MOD. 15


SCALE 1:100@A3


All footings, slabs, structural beams, etc, to future engineers details. All wall/roof connections + member sizes to NCC & future engineers detail Rainwater from gutters to connect to stormwater system to relevant Building Codes, Council requirements.

All wastewater/sewage to connect to existing sewer system to all relevant NCC, Building Codes + Council requirements.

All materials to comply with BAL12.5 requirements.

All works to comply with all relevant NCC, Building Codes + Council requirements.

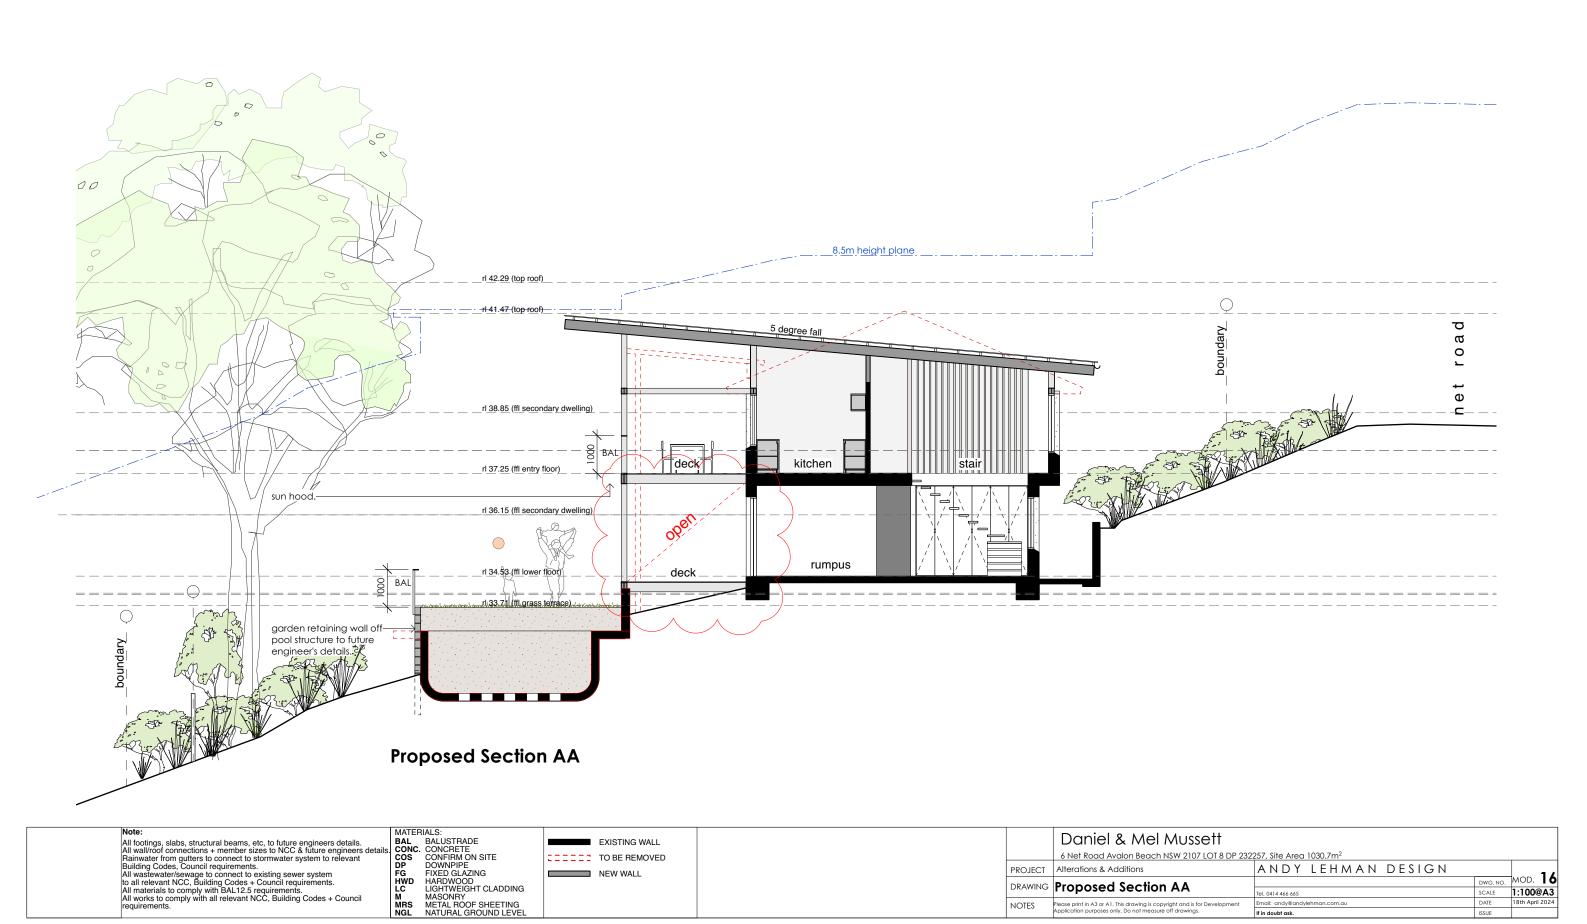

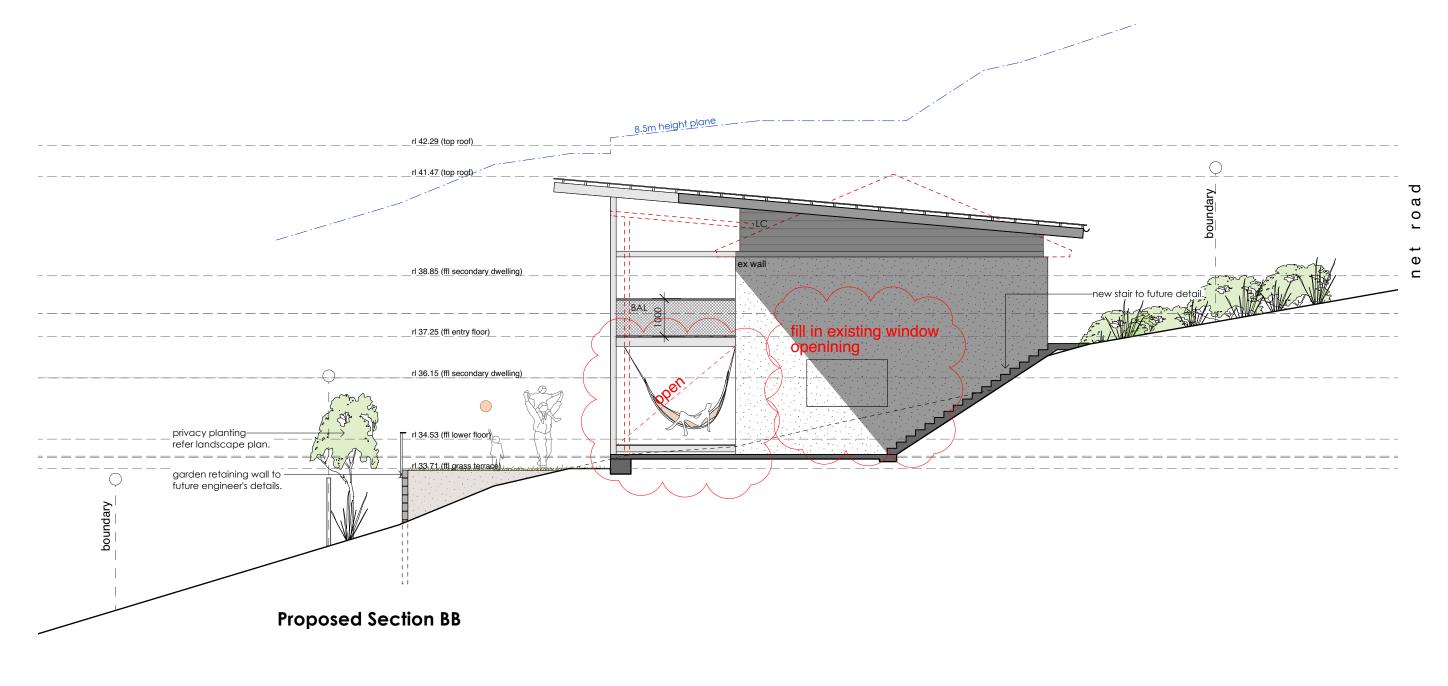

Note:
All footings, slabs, structural beams, etc, to future engineers details. All walfword connections + member sizes to NCC & future engineers details. BAL BALUSTRADE CONC. CONCRETE GONC. CONCRETE GONC. CONCRETE GONC. CONCRETE TO BE REMOVED Building Codes, Council requirements.

All wasteward/sewage to connect to existing sewer system to relevant NCC, Building Codes + Council requirements.

All materials to comply with all relevant NCC, Building Codes + Council requirements.

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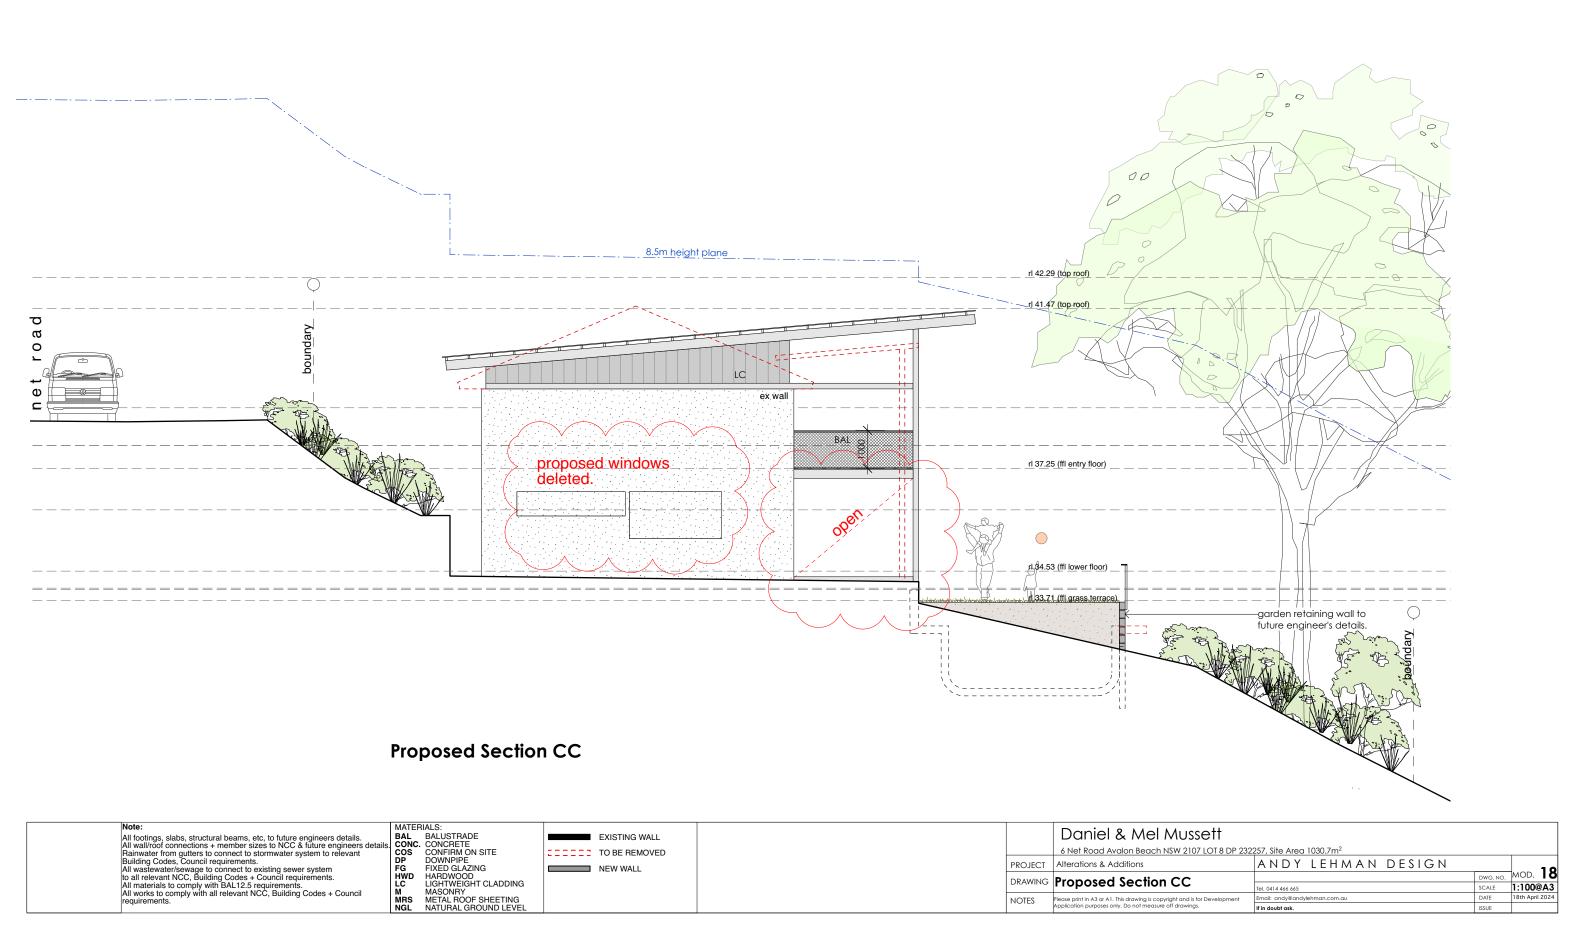
All works to comply with all relevant NCC, Building Codes + Council requirements.


All works to comply with all relevant NCC, Building Codes + Council requirements.

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All works to comply with all relevant NCC, Building Codes + Council r





## Shadow Diagram - 9am no change

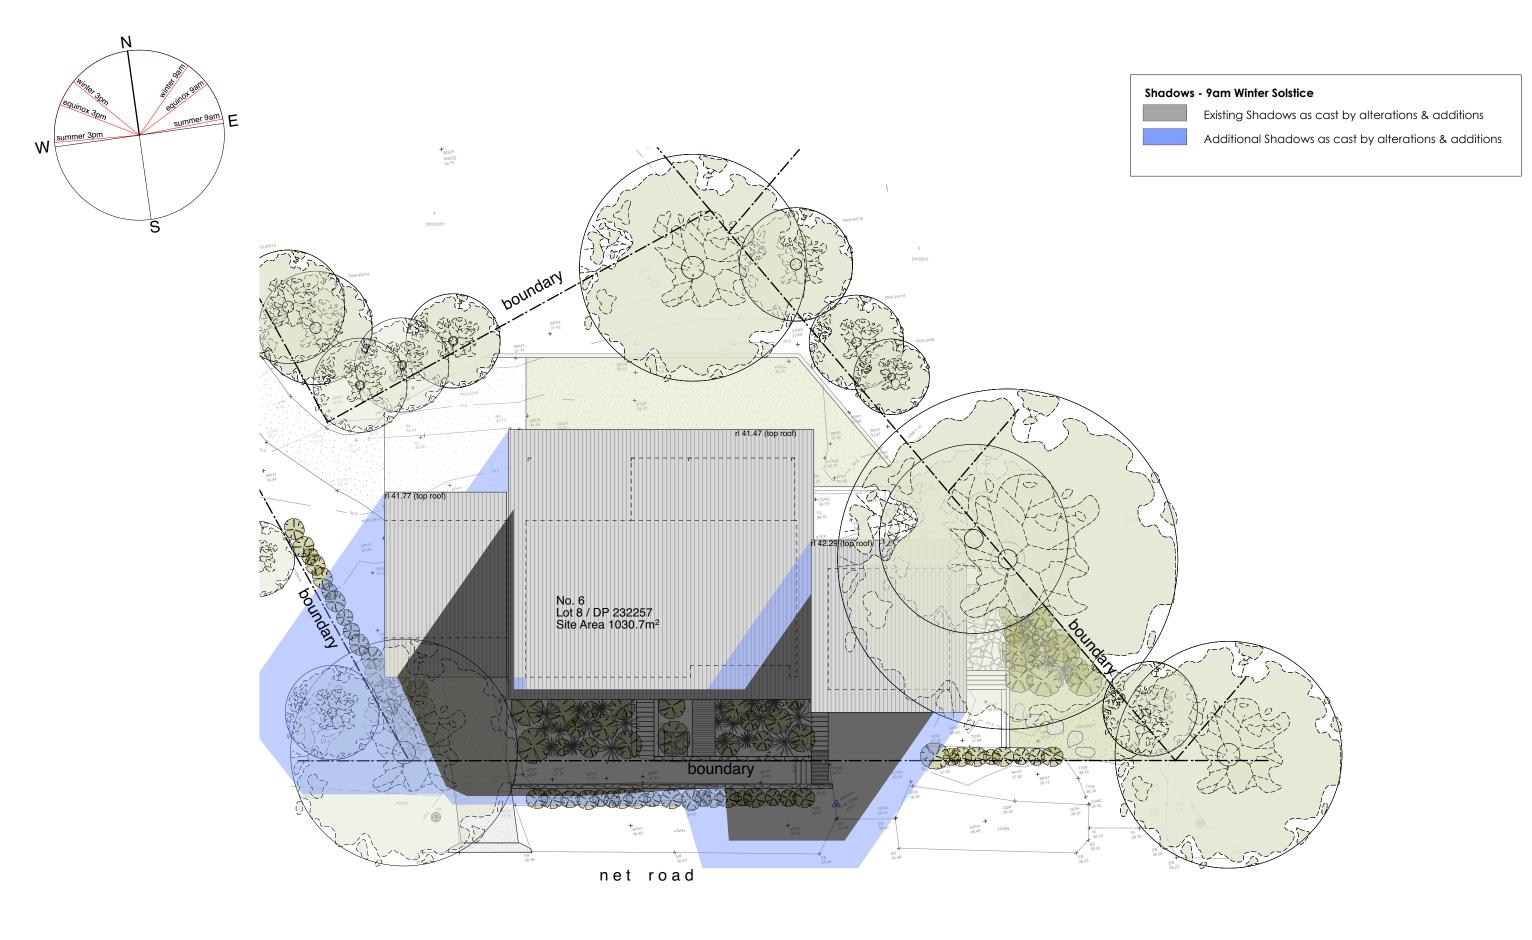


Note:
All footings, slabs, structural beams, etc, to future engineers details.
All wall/roof connections + member sizes to NCC & future engineers detail
Rainwater from gutters to connect to stormwater system to relevant
Building Codes, Council requirements.
All wastewater/sewage to connect to existing sewer system
to all relevant NCC, Building Codes + Council requirements.
All materials to comply with BAL12.5 requirements.
All works to comply with all relevant NCC, Building Codes + Council requirements.

MATERIALS:
BAL BALUSTRADE
CONC. CONCRETE
COS CONFIRM ON SITE
DP DOWNPIPE
FG FIXED GLAZING
HWD HARDWOOD
LC LIGHTWEIGHT CLADDING
M MASONRY
MRS METAL ROOF SHEETING
NGL NATURAL GROUND LEVEL

EXISTING WALL TO BE REMOVED NEW WALL

		Daniel & Mel Mussett			
		6 Net Road Avalon Beach NSW 2107 LOT 8 DP 232	257, Site Area 1030.7m <sup>2</sup>		
	PROJECT	Alterations & Additions	ANDY LEHMAN DESIGN		10
	DRAWING	Shadow Diagram 9am		DWG. NO.	мор. <b>19</b>
		Silddow Diagram 7am	Tel. 0414 466 665	SCALE	1:200@A3
	NOTES	Please print in A3 or A1. This drawing is copyright and is for Development	Email: andy@andylehman.com.au	DATE	18th April 2024
		Application purposes only. Do not measure off drawings.	M. and a state of the state of	ICCLIE	

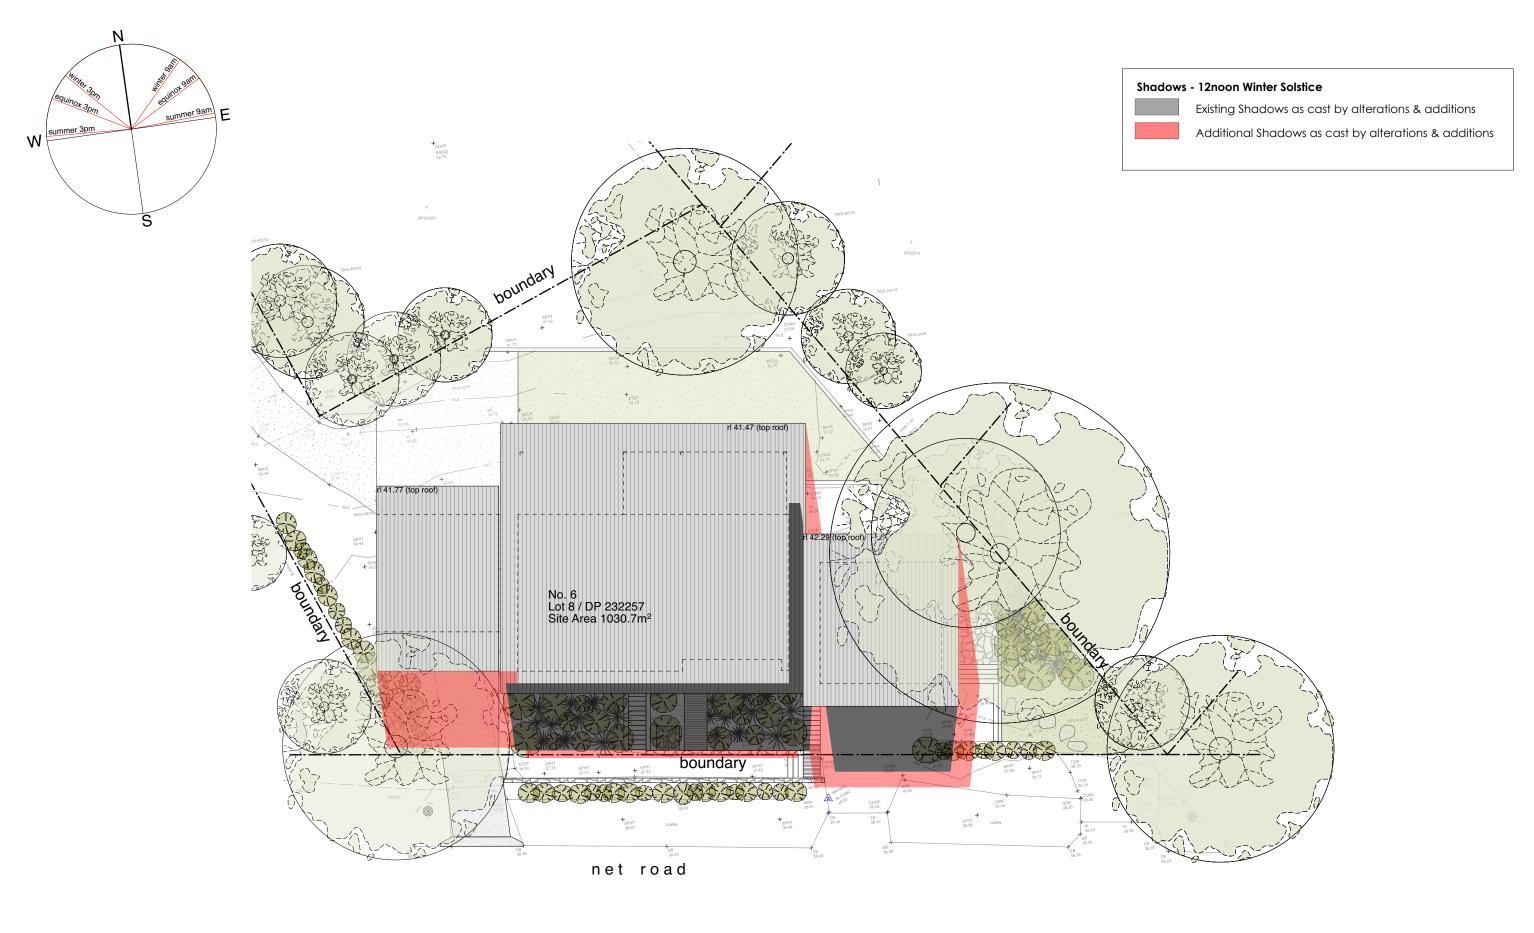

## Shadow Diagram - 12noon no change




Note:
All footings, slabs, structural beams, etc, to future engineers details.
All wall/roof connections + member sizes to NCC & future engineers detail
Rainwater from gutters to connect to stormwater system to relevant
Building Codes, Council requirements.
All wastewater/sewage to connect to existing sewer system
to all relevant NCC, Building Codes + Council requirements.
All materials to comply with BAL12.5 requirements.
All works to comply with all relevant NCC, Building Codes + Council requirements.

MATERIALS:
BAL BALUSTRADE
CONC. CONCRETE
COS CONFIRM ON SITE
DP DOWNPIPE
FG FIXED GLAZING
HWD HARDWOOD
LC LIGHTWEIGHT CLADDING
M MASONRY
MRS METAL ROOF SHEETING
NGL NATURAL GROUND LEVEL

	EXISTING WALL
=====	TO BE REMOVED
	NEW WALL

	Daniel & Mel Mussett			
	6 Net Road Avalon Beach NSW 2107 LOT 8 DP 232	257, Site Area 1030.7m <sup>2</sup>		
PROJECT	Alterations & Additions	ANDY LEHMAN DESIGN		20
DRAMING	Shadow Diagram 12noon		DWG. NO.	мор. <b>20</b>
DRAWING	Silddow blagfaill 12110011	Tel. 0414 466 665	SCALE	1:200@A3
	Please print in A3 or A1. This drawing is copyright and is for Development	Email: andy@andylehman.com.au	DATE	18th April 2024
	Application purposes only. Do not measure off drawings.	If in all white make	ICCLIE	

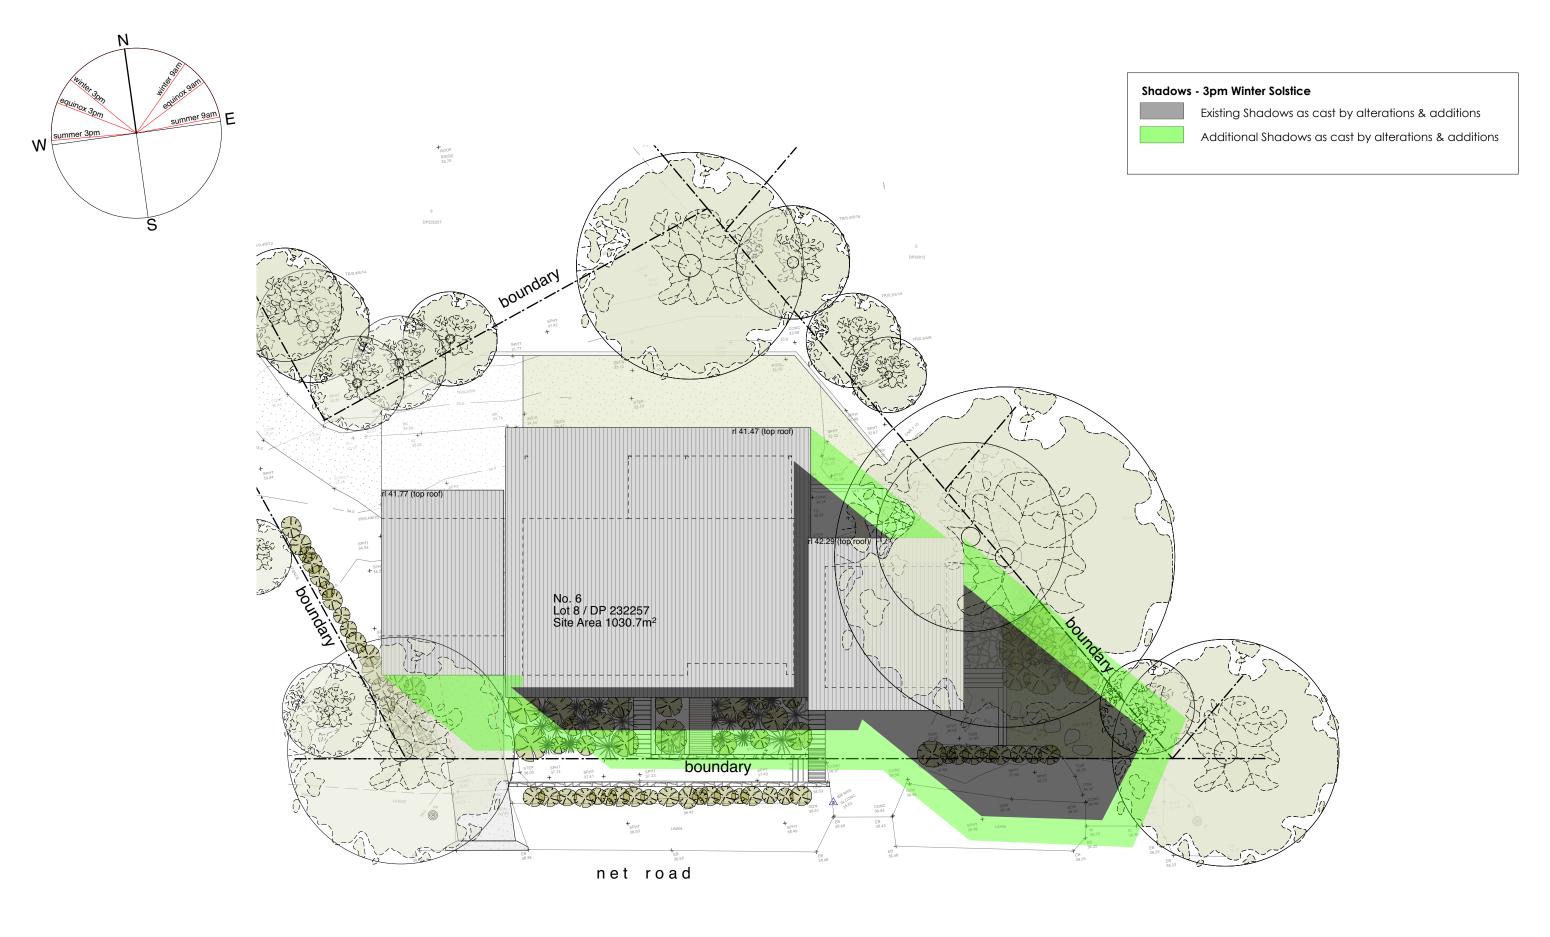

#### Shadow Diagram - 3pm no change



Note:
All footings, slabs, structural beams, etc, to future engineers details.
All wall/roof connections + member sizes to NCC & future engineers detail
Rainwater from gutters to connect to stormwater system to relevant
Building Codes, Council requirements.
All wastewater/sewage to connect to existing sewer system
to all relevant NCC, Building Codes + Council requirements.
All materials to comply with BAL12.5 requirements.
All works to comply with all relevant NCC, Building Codes + Council
requirements.

MATERIALS:
BAL BALUSTRADE
CONC. CONCRETE
COS CONFIRM ON SITE
DP DOWNPIPE
FG FIXED GLAZING
HWD HARDWOOD
LC LIGHTWEIGHT CLADDING
M MASONRY
MRS METAL ROOF SHEETING
NGL NATURAL GROUND LEVEL

	EXISTING WALL
=====	TO BE REMOVED
	NEW WALL

Daniel & Mel Mussett 6 Net Road Avalon Beach NSW 2107 LOT 8 DP 232257, Site Area 1030.7m<sup>2</sup> ANDY LEHMAN DESIGN Alterations & Additions мор. **21** DWG. NO. MOD. 21 SCALE 1:200@A3 DRAWING Shadow Diagram 3pm el. 0414 466 665 Please print in A3 or A1. This drawing is copyright and is for Development Application purposes only. Do not measure off drawings. NOTES