DEVELOPMENT APPLICATION

13 ILYA AVENUE - BAYVIEW



ARTIST IMPRESSION

INDEX OF DRAWINGS:

DA.01 SITE PLAN (SCALE1:500)

DA.02 SITE ANALYSIS PLAN

DA.03 TOP TERRACE FLOOR PLAN

DA.04 LOWER GROUND FLOOR PLAN

DA.05 GROUND FLOOR PLAN

DA.06 NORTH ELEVATION

DA.07 EAST ELEVATION

DA.08 WEST ELEVATION

DA.09 SOUTH ELEVATION / BASIX NOTES

DA.10 SECTION AA / SPECIFICATION NOTES

DA.11 LANDSCAPE AREA CALCULATION PLAN

DA.12 LANDSCAPE CONCEPT PLAN

DA.13 EROSION & SEDIMENT CONTROL / WASTE

MANAGEMENT PLAN

DA.14 SHADOW DIAGRAM JUNE21 @ 9AM

DA.15 SHADOW DIAGRAM JUNE21 @ 12NOON


DA.16 SHADOW DIAGRAM JUNE21 @ 3PM







JJ DRAFTING PTY LTD 1300977804 www.jjdrafting.com.au

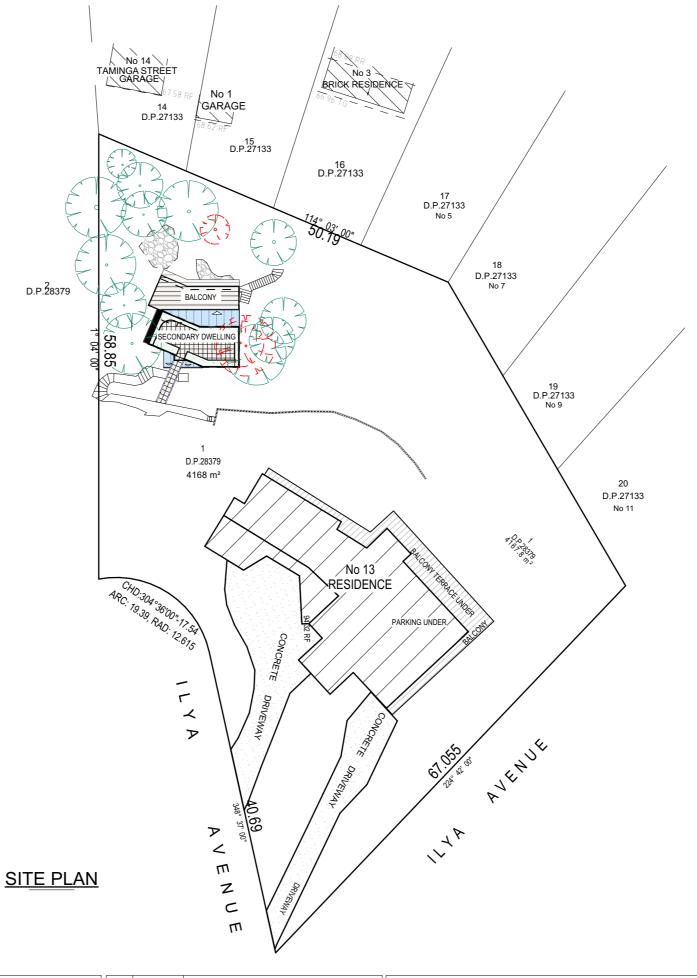

TRUE NORTH:



- NOTES (E & OE)

 All structures including stormwater & drainage to engineer's details.

 Do not obtain dimensions by scaling drawings.

 All dimensions are to be checked on site prior to starting work.

 These drawings are to be read in conjunction with all other consultant's drawings and specifications.

 All workmanship & materials shall be in accordance with the requirements of current editions including amendments of the National Construction Code, relevant Australian Standards & local
- All workmanship & materials shall be in accordance with the requirements of current editions including amendments of the National Construction Code, relevant Australian Standards & local council requirements.

 New materials are to be used throughout unless otherwise noted.


 Concrete footings, slab, structural beams or any other structural members are to be designed by a practicing engineer.

Division of JJ DRAFTING AUSTRALIA PTY LTD 26/90 Mona Vale Road, Mona Vale, NSW, 2103 PO Box 687, Dee Why, NSW, 2099 Mob. 0414 717 541 / Email:enquiries@jjdrafting.com.au www.jjdrafting.com.au ACN 651 693 346

	REV:	DATE:	DESCRIPTION:
	Α	01/09/22	PRELIM. DRAWINGS UPDATED
	В	06/09/22	PRELIM. DRAWINGS UPDATED
3	С	30/01/23	LANDSCAPE CONCEPT PLAN DRAWING
	D	18/08/23	NCC NOTES UPDATED
u			
- 1			

PROPOSED NEW SECONDARY DWELLING 13 ILYAAVENUE - BAYVIEW NSW 2104
CLIENT: Rex Pemberton
DRAWING TITLE: SITE PLAN

DRAWN BY:	SCALE:
LB	1:500 @ A3
CHECKED BY:	DRAWING No:
JJ	DA.01
	LB CHECKED BY:

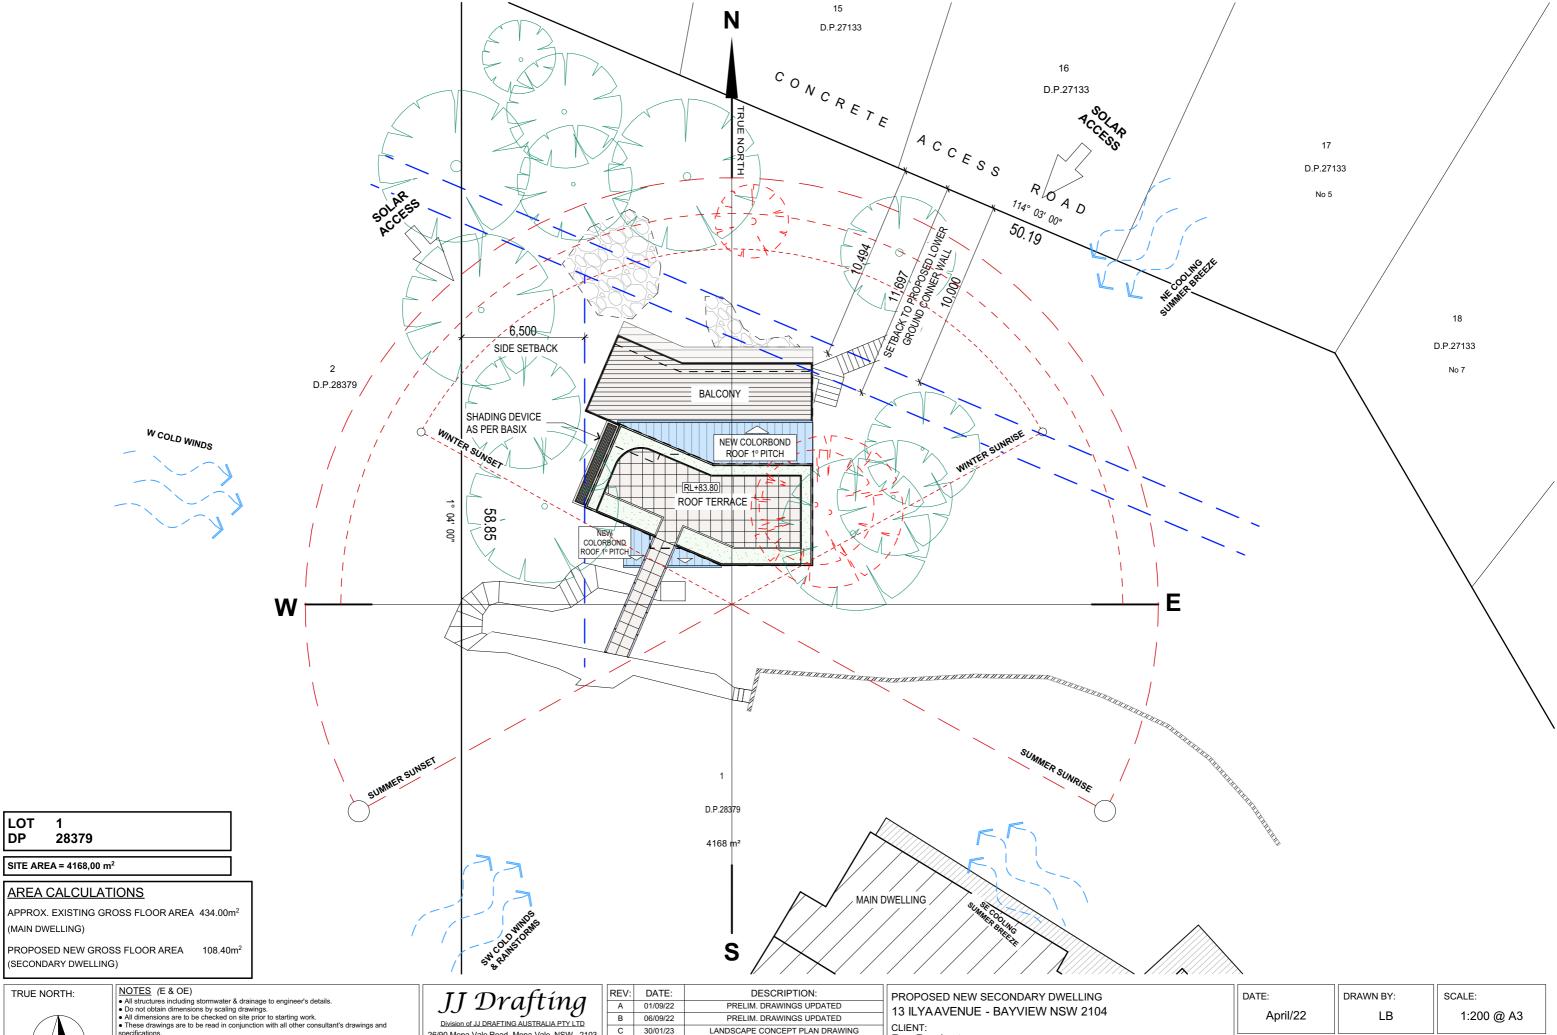

TRUE NORTH:


- specifications.

 All workmanship & materials shall be in accordance with the requirements of current editions. All working amendments of the National Construction Code, relevant Australian Standards & local council requirements.
 New materials are to be used throughout unless otherwise noted.
 Concrete footings, slab, structural beams or any other structural members are to be designed by a precision construction construction.
- by a practicing engineer.

REV:	DATE:	DESCRIPTION:
Α	01/09/22	PRELIM. DRAWINGS UPDATED
В	06/09/22	PRELIM. DRAWINGS UPDATED
С	30/01/23	LANDSCAPE CONCEPT PLAN DRAWING
D	18/08/23	NCC NOTES UPDATED

PROPOSED NEW SECONDARY DWELLING
13 ILYAAVENUE - BAYVIEW NSW 2104
CLIENT:
Rex Pemberton
DRAWING TITLE: SITE ANALYSIS PLAN
SITE ANALTSIS PLAIN

DATE:	DRAWN BY:	SCALE:
April/22	LB	1:200 @ A3
JOB No:	CHECKED BY:	DRAWING No:
1021/22	JJ	DA.02

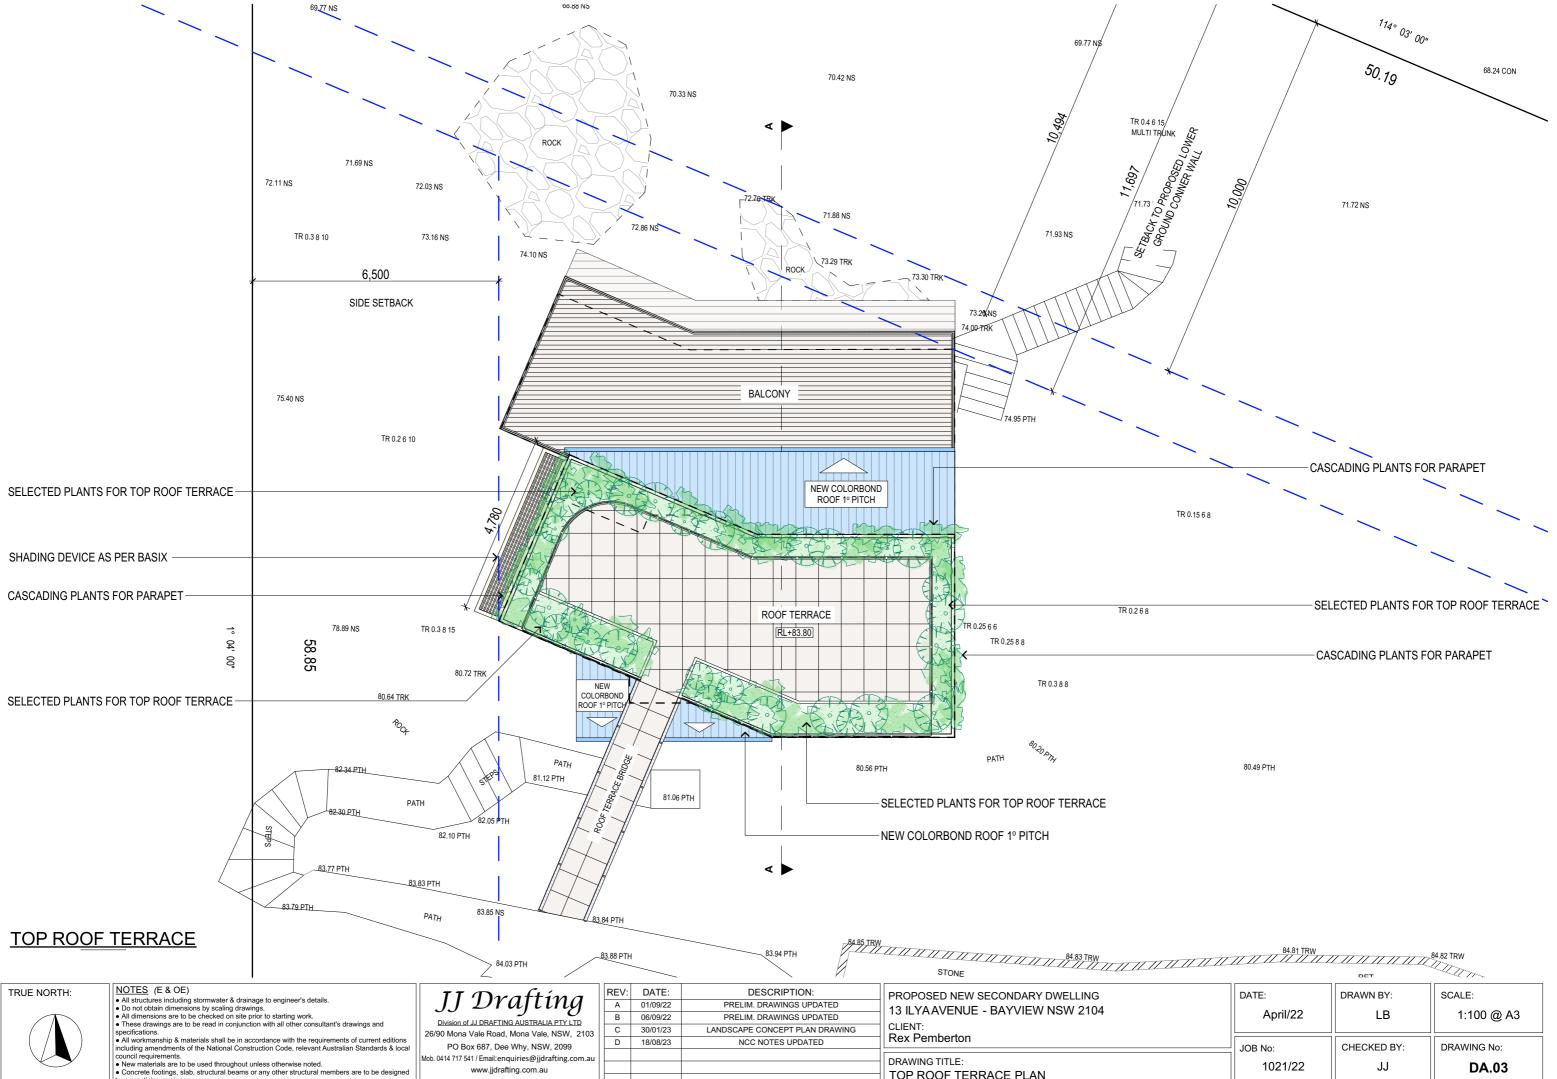





- by a practicing engineer.

JJ Drajing	A	01/09/22	PRELIM. DRAWINGS UPDATED
Division of JJ DRAFTING AUSTRALIA PTY LTD (90 Mona Vale Road, Mona Vale, NSW, 2103		06/09/22	PRELIM. DRAWINGS UPDATED
		30/01/23	LANDSCAPE CONCEPT PLAN DRAV
PO Box 687, Dee Why, NSW, 2099	D	18/08/23	NCC NOTES UPDATED
0414 717 541 / Email:enquiries@jjdrafting.com.au			
www.jjdrafting.com.au			
ACN 651 693 346			

PROPOSED NEW SECONDARY DWELLING 13 ILYAAVENUE - BAYVIEW NSW 2104 CLIENT:	DATE: April/22	DRAWN BY:	SCALE: 1:100 @ A3
Rex Pemberton	JOB No:	CHECKED BY:	DRAWING No:
DRAWING TITLE: TOP ROOF TERRACE PLAN	1021/22	JJ	DA.03

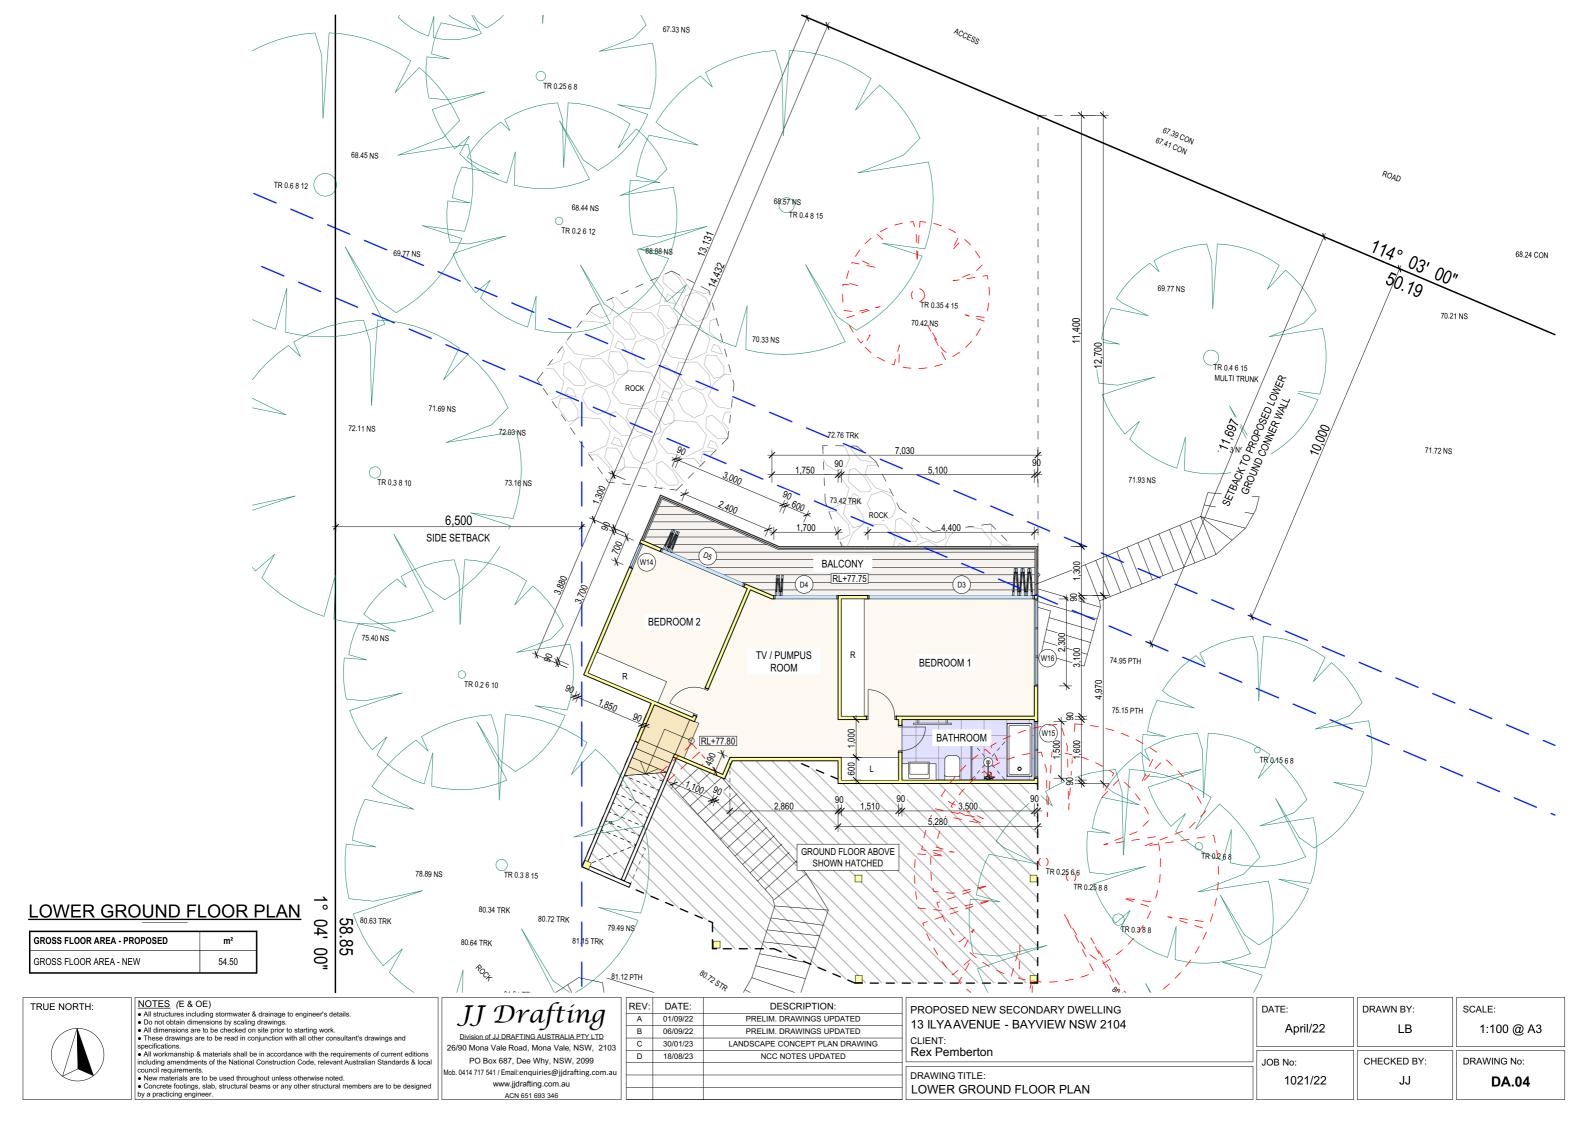

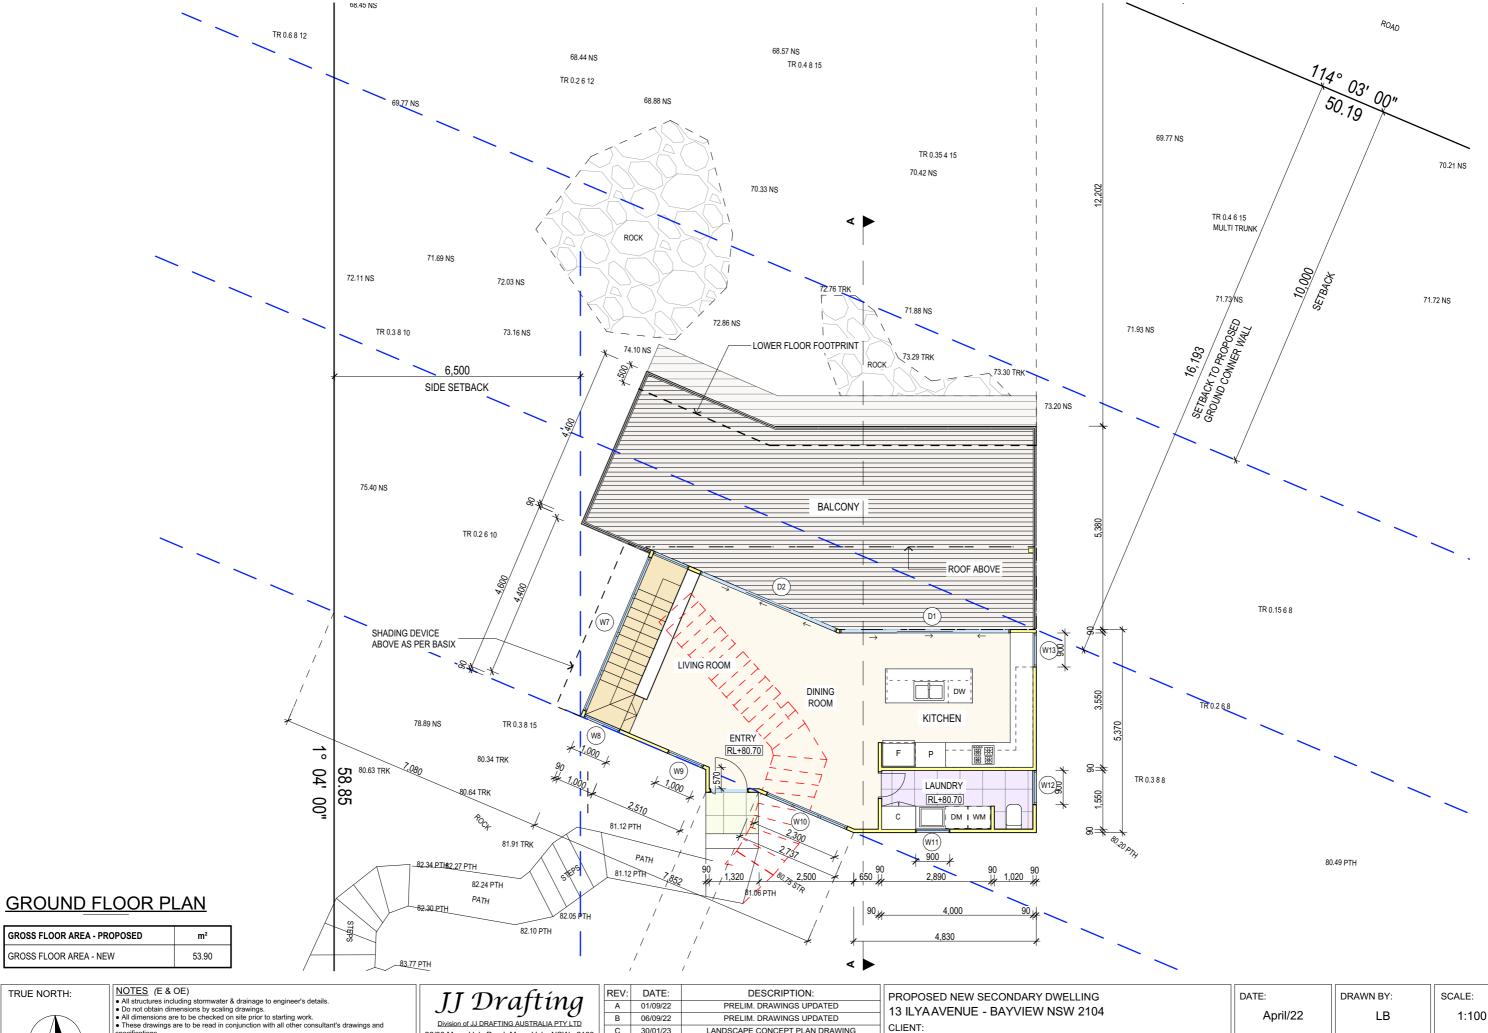

TRUE NORTH:



- All workflariship of inaterials shall be in accordance with the requirements of current construction including amendments of the National Construction Code, relevant Australian Standards & local council requirements.

 New materials are to be used throughout unless otherwise noted.

 Concrete footings, slab, structural beams or any other structural members are to be designed the construction of the c by a practicing engineer.

	REV:	DATE:	DESCRIPTION:	
	Α	01/09/22	PRELIM. DRAWINGS UPDATED	
	В	06/09/22	PRELIM. DRAWINGS UPDATED	
3	С	30/01/23	LANDSCAPE CONCEPT PLAN DRAWING	
	D	18/08/23	NCC NOTES UPDATED	
u				

PROPOSED NEW SECONDARY DWELLING 13 ILYA AVENUE - BAYVIEW NSW 2104	
CLIENT: Rex Pemberton	
DRAWING TITLE: GROUND FLOOR PLAN	

DATE:	DRAWN BY:	SCALE:
April/22	LB	1:100 @ A3
JOB No:	CHECKED BY:	DRAWING No:
1021/22	JJ	DA.05



NORTH ELEVATION

NOTES (E & OE)

• All structures including stormwater & drainage to engineer's details.

• Do not obtain dimensions by scaling drawings.

• All dimensions are to be checked on site prior to starting work.


• These drawings are to be read in conjunction with all other consultant's drawings and specifications.

These drawings are to be read in conjunction with all other consultant's drawings and specifications.
 All workmanship & materials shall be in accordance with the requirements of current editions including amendments of the National Construction Code, relevant Australian Standards & local council requirements.
 New materials are to be used throughout unless otherwise noted.
 Concrete footings, slab, structural beams or any other structural members are to be designed by a practicing engineer.

JJ Drafting

	REV:	DATE:	DESCRIPTION:	
	Α	01/09/22	PRELIM. DRAWINGS UPDATED	
	В	06/09/22	PRELIM. DRAWINGS UPDATED	
3	С	30/01/23	LANDSCAPE CONCEPT PLAN DRAWING	
Ĭ	D	18/08/23	NCC NOTES UPDATED	
u l				

13	ROPOSED NEW SECONDARY DWELLING B ILYAAVENUE - BAYVIEW NSW 2104 IENT:	DATE: April/22	DRAWN BY:	SCALE: 1:100 @ A3
1	Rex Pemberton	JOB No:	CHECKED BY:	DRAWING No:
	DRAWING TITLE: NORTH ELEVATION	1021/22	JJ	DA.06

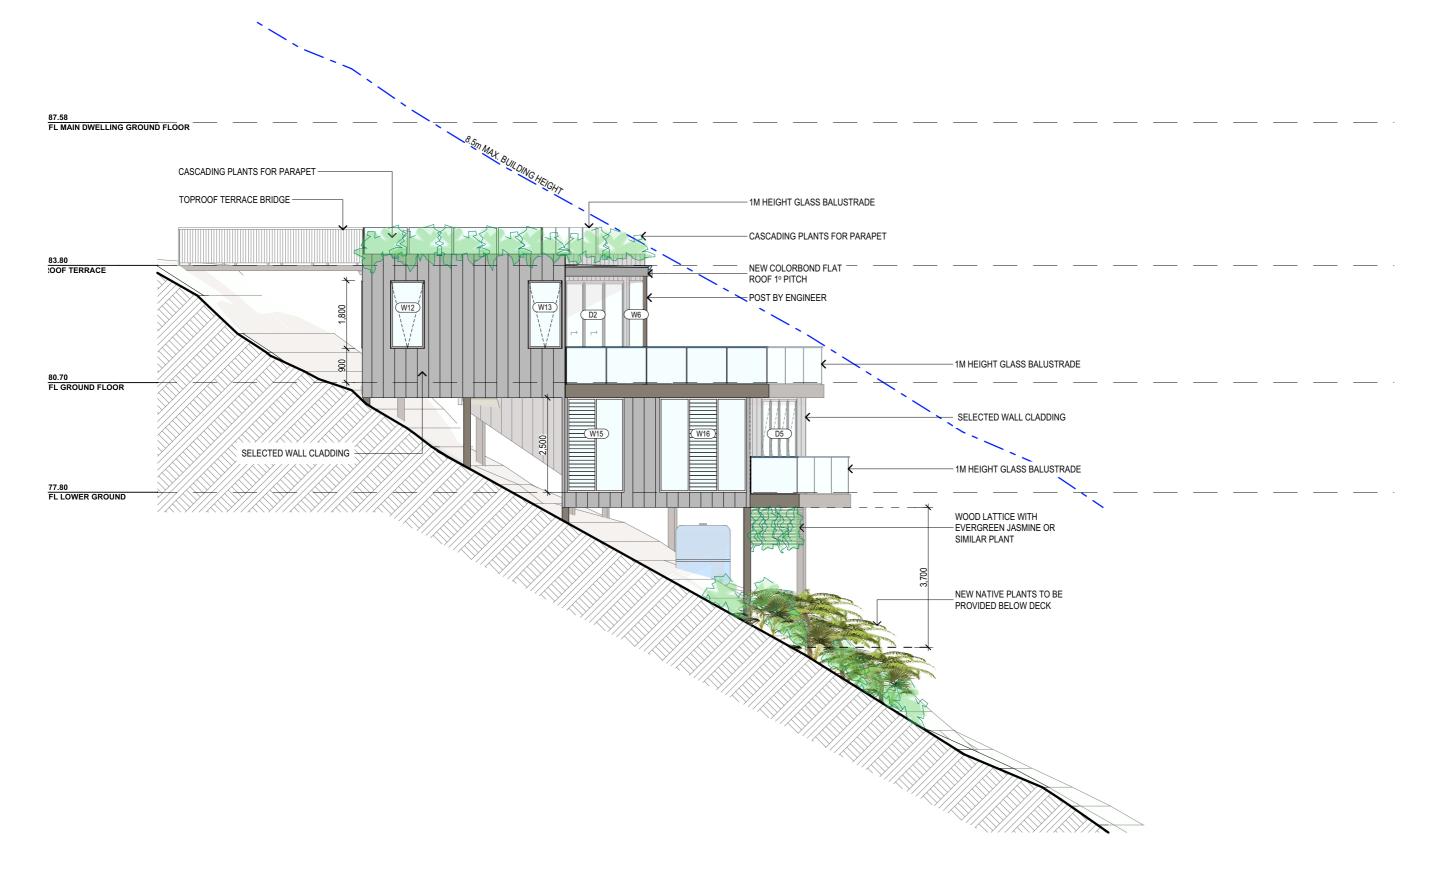

EAST ELEVATION

- NOTES (E & OE)

 All structures including stormwater & drainage to engineer's details.

 Do not obtain dimensions by scaling drawings.

 All dimensions are to be checked on site prior to starting work.

 These drawings are to be read in conjunction with all other consultant's drawings and specifications.

 All workmanship & materials shall be in accordance with the requirements of current editions including amendments of the National Construction Code, relevant Australian Standards & local council requirements.

 New materials are to be used throughout unless otherwise noted.


 Concrete footings, slab, structural beams or any other structural members are to be designed by a practicing engineer.

\overline{JJ} Drafting Division of JJ DRAFTING AUSTRALIA PTY LTD

	REV:	DATE:	DESCRIPTION:
	Α	01/09/22	PRELIM. DRAWINGS UPDATED
	В	06/09/22	PRELIM. DRAWINGS UPDATED
03	С	30/01/23	LANDSCAPE CONCEPT PLAN DRAWING
	D	18/08/23	NCC NOTES UPDATED
au			

PROPOSED NEW SECONDARY DWELLING 13 ILYAAVENUE - BAYVIEW NSW 2104	
CLIENT: Rex Pemberton	
DRAWING TITLE: EAST ELEVATION	

	DATE: April/22	DRAWN BY:	1:100 @ A3	
╛	JOB No:	CHECKED BY:	DRAWING No:	
	1021/22	JJ	DA.07	

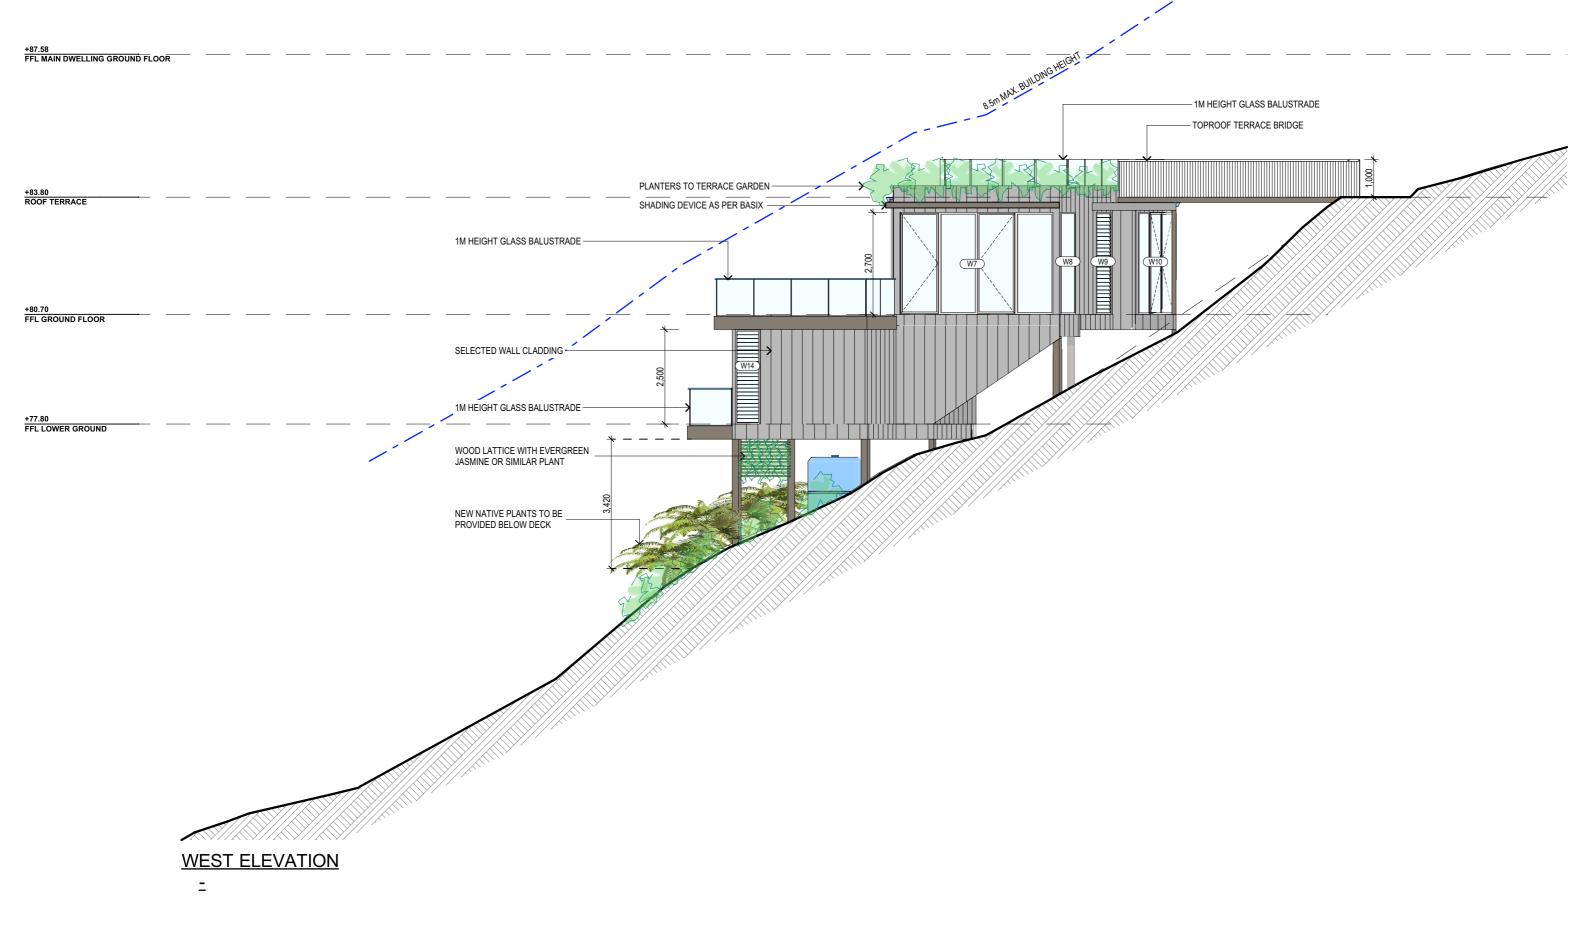

NOTES (E & OE)

• All structures including stormwater & drainage to engineer's details.

• Do not obtain dimensions by scaling drawings.

• All dimensions are to be checked on site prior to starting work.

• These drawings are to be read in conjunction with all other consultant's drawings and specifications.

• All workmanship & materials shall be in accordance with the requirements of current editions including amendments of the National Construction Code, relevant Australian Standards & local council requirements.

• New materials are to be used throughout unless otherwise noted.


• Concrete footings, slab, structural beams or any other structural members are to be designed by a practicing engineer.

Division of JJ DRAFTING AUSTRALIA PTY LTD

	REV:	DATE:	DESCRIPTION:
	Α	01/09/22	PRELIM. DRAWINGS UPDATED
	В	06/09/22	PRELIM. DRAWINGS UPDATED
:	С	30/01/23	LANDSCAPE CONCEPT PLAN DRAWING
	D	18/08/23	NCC NOTES UPDATED
١			
- 1			

PROPOSED NEW SECONDARY DWELLING 13 ILYAAVENUE - BAYVIEW NSW 2104 CLIENT: Rex Pemberton	
DRAWING TITLE: WEST ELEVATION	

DATE: April/22	DRAWN BY:	SCALE: 1:100 @ A3	
JOB No: 1021/22	CHECKED BY:	DRAWING No: DA.08	

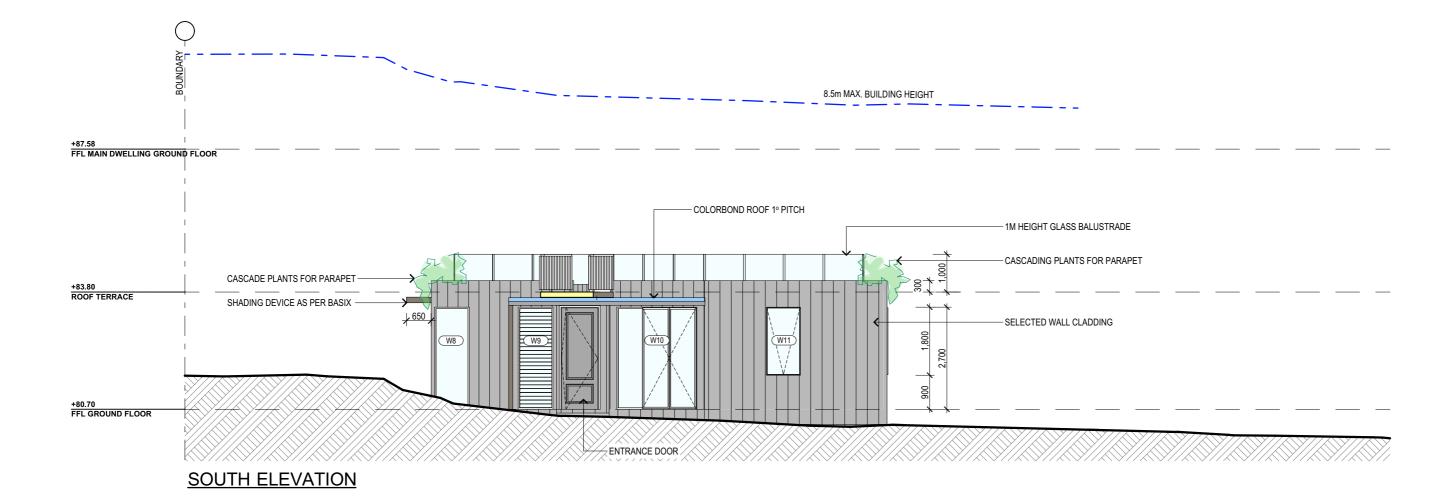

BASIX REQUIREMENT:

BASIX INCLUSIONS FOR 13 ILYAAVENUE - BAYVIEW

External walls

Lightweight cladding on framed walls with R2.5 insulation (insulation only value) External colour:

Medium (0.475 < SA < 0.7)

Walls within dwellings

Plasterboard on studs, no insulation required

Plasterboard on studs with R2.5 insulation on the internal walls of bathroom and laundry and habitable areas

Glazing doors/windows

Glazed windows and doors:

Group A - awning + bifold + casement windows + hinged glazed doors

U-value: 6.70 (equal to or lower than) SHGC: 0.57 (±10%)

Group B - sliding doors/windows + fixed glazing + louvred windows

U-value: 6.70 (equal to or lower than) SHGC: 0.70 (±10%)

Upgrades as per NatHERS certificate:

Group A - awning + bifold + casement windows + hinged glazed doors

U-value: 2.20 (equal to or lower than) SHGC: 0.32 (±10%)

Group B - sliding doors/windows

U-value: 3.60 (equal to or lower than) SHGC: 0.54 (±10%)

Group B - Fixed glazing

U-value: 3.40 (equal to or lower than) SHGC: 0.33 (±10%)

Group B - Louvred windows

U-value: 4.90 (equal to or lower than) SHGC: 0.33 (±10%)

Given values are AFRC total window system values (glass and frame)

External colour:

Medium (0.475 < SA < 0.7)

Floors

Suspended timber floor with R4.0 insulation (insulation only value) to open and enclosed suspended areas

Roof and ceilings

Plasterboard ceiling with R4.0 insulation (insulation only value) where metal roof above

External colour

Medium (0.475 < SA < 0.7)

Ceiling penetrations

Sealed LED downlights, as per electrical plan, modelled as 150mm diameter

Sealed externally ducted exhaust fans, modelled as 200mm diameter Ceiling fans 1300mm diameter to bedrooms, living room and rumpus Penetrations not to exceed NatHERS certificate

Floor coverings

Tiles to wet areas; carpet with rubber underlay to bedrooms and rumpus; timber elsewhere

External shading

Shading as per stamped drawings

Ventilation

All external doors have weather seals, all exhaust fans and chimneys have dampers, and down lights will be sealed.

BASIX Water Commitments

Fixtures

Install showerheads minimum rating of 3 stars - High flow (>7.5 and <= 9 litres/min) Install toilet flushing system with a minimum rating of 4 stars in each toilet Install tap with a minimum rating of 3 stars in the kitchen Install taps with a minimum rating of 3 stars in each bathroom

Alternative water

Install rainwater tank, minimum 3,000L capacity collected from min. 150m² roof area. Tank connected to - at least one outdoor tap, and all toilets

BASIX Energy Commitments

Hot water system

Gas instantaneous - 6 Stars

Cooling system

1-phase air-conditioning to living areas and bedrooms: EER 3.0-3.5 Day-night zoned

Heating system

1-phase air-conditioning to living areas and bedrooms: EER 3.0-3.5 Day-night zoned

Bathrooms - individual fan, externally ducted to roof or façade, manual on/off switch Kitchen - individual fan. not ducted, manual on/off switch

Laundry - individual fan, externally ducted to roof or façade, manual on/off switch

Other

Electric cooktop & electric oven Outdoor clothes drying line

Alternative Energy

1kW PV System

NOTES (E & OE)


- All structures including stormwater & drainage to engineer's details.
 Do not obtain dimensions by scaling drawings.
 All dimensions are to be checked on site prior to starting work.
 These drawings are to be read in conjunction with all other consultant's drawings and
- specifications.

 All workmanship & materials shall be in accordance with the requirements of current editions
- New materials are to be used throughout unless otherwise noted.
 Remarks are to be used throughout unless otherwise noted.
 Concrete footings, slab, structural beams or any other structural members are to be designed. by a practicing engineer.

	REV:	DATE:	DESCRIPTION:	
	Α	01/09/22	PRELIM. DRAWINGS UPDATED	
	В	06/09/22	PRELIM. DRAWINGS UPDATED	
	С	30/01/23	LANDSCAPE CONCEPT PLAN DRAWING	
	D	18/08/23	NCC NOTES UPDATED	
П				

	-
PROPOSED NEW SECONDARY DWELLING 13 ILYAAVENUE - BAYVIEW NSW 2104	
CLIENT: Rex Pemberton	
DRAWING TITLE: SOUTH ELEVATION / BASIX NOTES	

DATE:	DRAWN BY:	SCALE:	
April/22	LB	1:100 @ A3	
JOB No:	CHECKED BY:	DRAWING No:	
1021/22	JJ	DA.09	

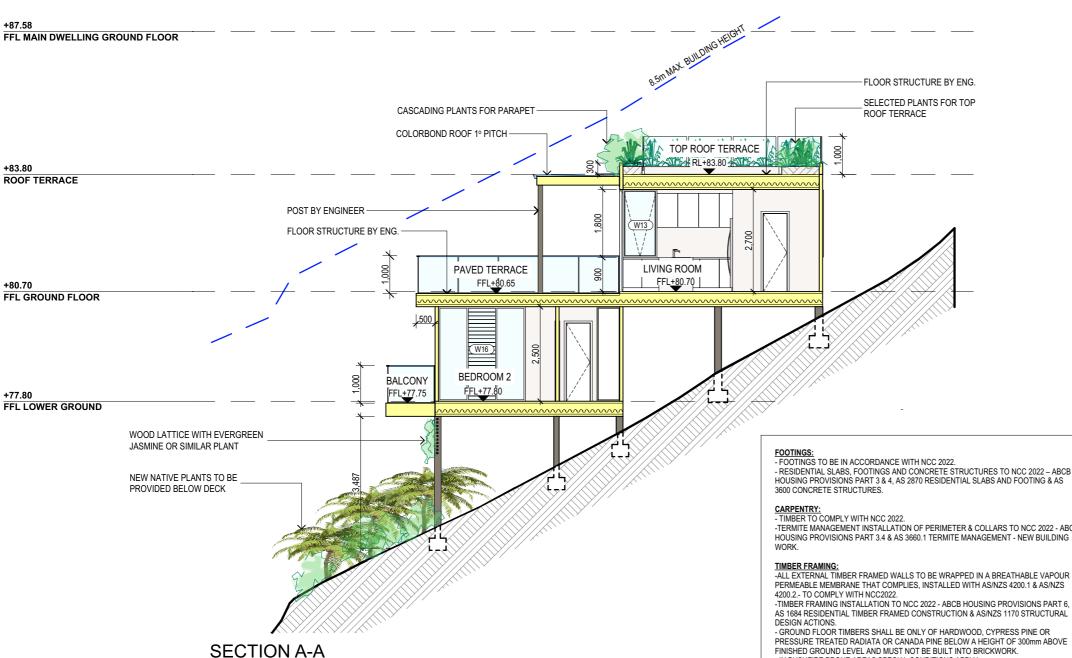

SPECIFICATION NOTES

INTERNAL LINING
- PROVIDE PLASTERBOARD LINING.

EXTERNAL WALLS:

- LIGHTWEIGHT METAL WALL CLADDING. - ALL EXTERNAL WALL CLADDINGS MUST BE COMPLIANT WITH THE REQUIREMENTS OF NCC 2022 - ABCB

HOUSING PROVISIONS PART 7 AS1684 AND ALL RELEVANT CODEMARK CERTIFICATES. - ROOF AND WALL CLADDING INSTALLATION TO NCC 2022 - ABCB HOUSING PROVISIONS PART 7 & AS 1562 DESIGN AND INSTALLATION OF SHEET ROOF AND WALL CLADDING.

CONDENSATION MANAGEMENT:

- CONDENSATION MANAGEMENT MUST BE ADHERED TO IN ACCORDANCE WITH NCC 2022 - HOUSING PROVISIONS PART 10.8

GROUND FLOOR TO BE SUSPENDED TIMBER FRAMED FINISHED WITH T&G HARDWOOD FLOORING.

- ALL WATERPROOFING TO NCC 2022 – ABCB HOUSING PROVISIONS PART 10, AS3740 AND PROVIDE A GUARANTEED FLEXIBLE WATERPROOF MEMBRANE TO ALL WET AREA FLOORS & SHOWER WALLS TO

MANUFACTURED SPECIFICATIONS AND INSTALL ATION INSTRUCTIONS. - WATERPROOF INSTALLATION NCC (2022): HOUSING PROVISIONS PART 10, AS 3740 WATERPROOFING OF DOMESTIC WET AREAS (INTERNAL) & AS 4654 WATERPROOF MEMBRANES FOR EXTERNAL USE

- SHALL BE INSTALLED TO COMPLY WITH AS1684 AS AMENDED FOR TIMBER COMPONENTS OR AS3620 FOR LIGHTWEIGHT STEEL FRAMING SECTIONS OR AS PER THE NASH ALTERNATIVES TO AS 3623.

ANT CAPS:
- SHALL BE INSTALLED IN ACCORDANCE WITH AS3660.

PROFILED STEEL ROOF:

- COLORBOND ROOF CLADDING

- METAL ROOF DESIGN AND INSTALLATION SHALL BE IN ACCORDANCE WITH NCC 2022 - ABCB HOUSING PROVISIONS PART 7, AS 1562.

ROOF TILES OR SHINGLES: - NCC VOL.2 PART 3.5.2.

- SHALL BE IN ACCORDANCE WITH NCC VOL.1 PART B1.4 OR VOL.2 PART 3.2.3.

- ALL WORKMANSHIP AND MATERIALS SHALL BE IN ACCORDANCE WITH CURRENT EDITIONS OF THE

BRICK AND BLOCKWORK:

Mob. 04

- MASONRY STRUCTURES TO NCC 2022 - ABCB HOUSING PROVISIONS PART 5 & AS 3700 MASONRY STRUCTURES.

- RESIDENTIAL SLABS, FOOTINGS AND CONCRETE STRUCTURES TO NCC 2022 – ABCB HOUSING PROVISIONS PART 3 & 4, AS 2870 RESIDENTIAL SLABS AND FOOTING & AS

-TERMITE MANAGEMENT INSTALLATION OF PERIMETER & COLLARS TO NCC 2022 - ABCB HOUSING PROVISIONS PART 3.4 & AS 3660.1 TERMITE MANAGEMENT - NEW BUILDING

PERMEABLE MEMBRANE THAT COMPLIES, INSTALLED WITH AS/NZS 4200.1 & AS/NZS

AS 1684 RESIDENTIAL TIMBER FRAMED CONSTRUCTION & AS/NZS 1170 STRUCTURAL

FINISHED GROUND LEVEL AND MUST NOT BE BUILT INTO BRICKWORK.
- IN BUSHFIRE PRONE AREAS SPECIAL CONDITIONS APPLY.

- WHERE TERMITE BARRIERS NEED TO BE INSPECTED, 400mm CLEARANCE IS REQUIRED BETWEEN THE UNDERSIDE OF BEARER AND GROUND SURFACE.

- USE TREATED TIMBER WHERE REQUIRED FOR DURABILITY.
- DO NOT USE TIMBER UNSUITABLE FOR EXPOSURE TO MOISTURE IN EXPOSED

- USE GALVANISED FIXINGS WHERE EXPOSED TO WEATHER

STEEL STRUCTURES, AS/NZS 4600 COLD-FORMED STEEL STRUCTURES & NASH

TERMITE CONTROL:
- TO BE IN ACCORDANCE WITH TO NCC2022.

FLASHING AND CAPPINGS:
- SELECTION AND INSTALLATION OF METAL RAINWATER GOODS

- FLASH PROJECTIONS ABOVE THE ROOF WITH TWO PART FLASHINGS CONSISTING OF AN APRON FLASHING AND OVER FLASHING, WITH AT LEAST 100mm OVERLAP. - PROVIDE FOR INDEPENDENT MOVEMENT BETWEEN ROOF AND PROJECTION. - DAMP PROOF COURSE AND FLASHINGS TO NCC 2022 - ABCB HOUSING PROVISIONS

PART 5, 7 & 12 & AS/NZS 2904 DAMP-PROOF COURSES AND FLASHINGS.

CONCRETE BLOCKS OR BRICKS: TO COMPLY WITH TO NCC2022

LIGHTING:
-40% OF NEW OR ALTERED LIGHT FIXTURES TO BE FITTED WITH FLUORESCENT, COMPACT FLUORESCENT, OR LIGHT-EMITTING-DIODE (LED) LAMPS

WATERPROOFING FOR EXTERNAL TILED BALCONIES:

- WATERPROOFING TO COMPLY WITH NCC2022

- ALL FRAMED WINDOWS SHALL BE INSTALLED IN ACCORDANCE WITH NCC2022 ALUMINIUM WINDOWS AND TIMBER
- ALUMINIUM FRAMED WINDOWS AND DOORS.
- WEATHER STRIPPING IS TO BE PROVIDED TO ALL EXTERNAL WINDOWS AND DOORS.
- ALL WINDOWS ARE TO BE RESTRICTED IN ACCORDANCE WITH NCC 2022 ABCB HOUSING PROVISIONS PART 11.3.7 & PART 11.3.8 PROTECTION OF OPENABLE WINDOWS WHERE SURFACE BELOW IS MORE THAN 2M.
- PROVIDE LIFT-OFF HINGES WHERE THE TOILET PAN IS WITHIN 1.2 METRES OF THE HINGED SIDE OF THE DOOR IN ACCORDANCE WITH NCC 2022 - ABCB HOUSING PROVISIONS PART 10.4.

STAIRS, HANDRAILS AND BALUSTRADES:

- RELATIONSHIP OF RISER TO GOING SHALL BE BETWEEN 1:2 AND 1:1.35 UNLESS OTHERWISE DIRECTED TO GOING SHALL BE BETWEEN 1:2 AND 1:1.35 UNLESS OTHERWISE DIRECTED OR AS PERMITTED IN NCC2022.

- BALUSTRADES SHALL BE PROVIDED TO ALL LANDINGS, RAMPS, DECKS, ROOFS AND OTHER ELEVATED PLATFORMS WHERE THE VERTICAL DISTANCE FROM THAT LEVEL IS MORE THAN 1m ABOVE THE ADJOINING FLOOR OR FINISHED GROUND LEVEL

- THE HEIGHT OF BALUSTRADE MUST BE A MINIMUM OF 1m HIGH ABOVE LANDING AND NOT LESS THAN 865mm ABOVE THE NOSINGS OF ANY STAIR TREADS OR FLOOR RAMP AND HAVE NO OPENING GREATER THAN 125mm. - THE HEIGHT OF BALUSTRADE TO THE NEW STAIRCASES IS TO BE MEASURED A MINIMUM 865mm ABOVE THE NOSING LINE AND HAVE NO OPENING GREATER NO OPENING GREATER THAN 125mm

- ALL BALUSTRADES & PRIVACY SCREENS TO COMPLY WITH NCC 2022 - ABCB HOUSING PROVISIONS PART 11, AS 1684, AS 1170, AS 1288 & AS/NZS 2208

SLIP RESISTANCE:

- MATERIALS TO BE USED FOR SURFACES OF FLOORS, STAIR LANDING, STEPS AND NOSINGS SHALL BE IN ACCORDANCE WITH THE CLASSIFICATIONS FOR SLIP RESISTANCE AS APPLY IN NCC2022.
- ALL STAIRS PROVIDING ACCESS TO COMPLY WITH NCC 2022 ABCB HOUSING PROVISIONS PART 11, AS 4586 INCLUDING SLIP RESISTANCE P3 / R10 FOR DRY OR P4 / R11 FOR WET.

STORMWATER: EAVES GUTTERS, VALLEY GUTTERS AND DOWPIPES

- IN ACCORDANCE WITH NCC 2022 NEW DOWNPIPES TO BE CONNECTED INTO EXISTING STORMWATER LINE
- COLORBOND GUTTERS AND DOWNPIPES
- MINIMUM SLOPE OF EAVES AND GUTTERS 1:200

GLAZING:

-ALL WINDOW GLAZING AND DOOR GLAZING TO BE INSTALLED IN ACCORDANCE TO NCC 2022 - ABCB HOUSING PROVISIONS PART 8, AS 1288 GLASS IN BUILDINGS, AS/NZS 2208 SAFETY GLAZING MATERIALS IN BUILDINGS & AS 2047 WINDOWS AND EXTERNAL DOORS IN BUILDINGS.

- SHOWER SCREEN/MIRRORS / WARDROBE GLASS INSTALLATION TO NCC 2022 - HOUSING PROVISIONS PART 8, AS 1288 & AS/NZS 2208.

- GLASS BALUSTRADE INSTALLATION TO NCC 2022 - HOUSING PROVISIONS PART 11, AS 1288 GLASS IN BUILDINGS, AS/NZS 2208 SAFETY GLAZING MATERIALS IN BUILDINGS & AS 1170 STRUCTURAL DESIGN ACTIONS.

FIRE SAFETY, SMOKE DETECTORS/ALARMS:

- PROVIDE HARDWIRED & INTERCONNECTED SMOKE ALARM DEVICES COMPLYING WITH THE REQUIREMENTS OF THE LOCAL GOVERNMENT ACT AND/OR STATE OR TERRITORY REGULATIONS MUST BE FITTED IN THE LOCATIONS REQUIRED AND APPROVED BY THE AUTHORITY. SMOKE ALARMS TO BE INSTALLED TO NCC 2022 - ABCB HOUSING PROVISIONS PART 3.7.5
- INSTALLATIONS IN BUILDINGS OTHER THAN CLASS 1a AND 1b MUST BE INSTALLED AND MANAGED TO COMPLY WITH NCC SECTIONS 3.7.5.3 and 3.7.5.4.
- FIRE SEPARATING WALL, A WALL WITHIN 900MM OF BOUNDARY INSTALLATION CERTIFICATE (FRL60/60/60) INCL ACOUSTIC SOUND (RW) + CTR50 TO NCC 2022 ABCB HOUSING PROVISIONS
- BUSHFIRE-PRONE AREAS CERTIFICATE FOR BUILDING NCC 2022 VOL. 2 PART NSW H7D4 CONSTRUCTION IN BUSHFIRE PRONE AREAS - AS 3959 CONSTRUCTION OF BUILDING IN BUSHFIRE-PRONE AREAS & PLANNING FOR BUSHFIRE PROTECTION 2019.

WASTE MANAGEMENT:

- ALL WASTE SHALL BE TAKEN AWAY BY TRUCKS TO A SUITABLE LANDFILL OR RECYCLE DEPOT.
- ALL WASTE SHALL BE COVERED DURING TRANSPORTATION.
- WASTE GENERATED DURING CONSTRUCTION SHALL BE PLACED IN STEEL BINS AND TAKEN AWAY BY AN APPROVED CONTRACTOR TO A APPROVED LANDFILL SITE.

SEDIMENT CONTROL:

- A FILTER CLOTH SYSTEM SHALL BE INSTALLED TO STOP ANY SEDIMENT ENTERING COUNCILS STORMWATER

SWIMMING POOLS & SAFETY:

-POOL PLUMBING/CIRCULATION TO COMPLY WITH NCC 2022 PART NSW H7D2, AS 1926.3 SWIMMING POOL SAFETY -WATER RECIRCULATION SYSTEMS

- ALL POOL FENCING TO BE INSTALLED TO: NCC 2022 NSW H7D2, AS 1926.1 - 2012 - SAFETY BARRIERS FOR SWIMMING POOLS, AS NCC2022 - LOCATION OF SAFETY BARRIERS FOR SWIMMING POOLS, STRUCTURAL DESIGN ACTIONS AND IF GLASS POOL FENCING TO ADDITIONALLY COMPLY WITH NCC2022 - SAFETY GLASS,

- AS 2783 USE OF REINFORCED CONCRETE FOR SMALL SWIMMING POOLS

MISCELLANEOUS ITEMS:

- ALLOW FOR SEPARATE TAPS FOR THE WASHING MACHINE AND KEEP THEM SEPARATE FROM THOSE OF THE LAUNDRY TUB. A DEDICATED LAUNDRY SPACE COMPRISING OF ONE WASHTUB AND A SPACE FOR A WASHING MACHINE MUST BE PROVIDED IN ACCORDANCE WITH NCC 2022 - ABCB HOUSING PROVISIONS PART 10.4. - GAS FIRE SUPPLY AND INSTALLATION TO COMPLY WITH NCC 2022 - ABCB HOUSING PROVISIONS PART 12.4, AS/NZS 5601 GAS INSTALLATIONS

NOTE:

ALL PLANS ARE TO BE READ IN CONJUNCTION AND COMPLY WITH THE BASIX CERTIFICATE, BUSHFIRE AND GEOTECH

NOTES (E & OE)

FIRST FLOOR TO BE TIMBER FRAMED FINISHED WITH T&G HARDWOOD FLOORING.


- All structures including stormwater & drainage to engineer's details
 Do not obtain dimensions by scaling drawings.
 All dimensions are to be checked on site prior to starting work.
- These drawings are to be read in conjunction with all other consultant's drawings and
- All workmanship & materials shall be in accordance with the requirements of current editions cluding amendments of the National Construction Code, relevant Australian Sta

ouncil requirements. New materials are to be used throughout unless otherwise noted. Concrete footings, slab, structural beams or any other structural members are to be designed by a practicing engineer

Di 26/90

TT Docaftina	REV:	DATE:	DESCRIPTION:
JJ Drafting		01/09/22	PRELIM. DRAWINGS UPDATED
Division of JJ DRAFTING AUSTRALIA PTY LTD	В	06/09/22	PRELIM. DRAWINGS UPDATED
0 Mona Vale Road, Mona Vale, NSW, 2103	С	30/01/23	LANDSCAPE CONCEPT PLAN DRAWING
PO Box 687, Dee Why, NSW, 2099		18/08/23	NCC NOTES UPDATED
414 717 541 / Email:enquiries@jjdrafting.com.au			
www.jjdrafting.com.au			
ACN 651 603 346			

PROPOSED NEW SECONDARY DWELLING 13 ILYAAVENUE - BAYVIEW NSW 2104 CLIENT:	DATE: April/22	DRAWN BY:	SCALE: 1:100 @ A3
Rex Pemberton	JOB No:	CHECKED BY:	DRAWING No:
DRAWING TITLE: SECTION AA / SPECIFICATION NOTES	1021/22	JJ	DA.10

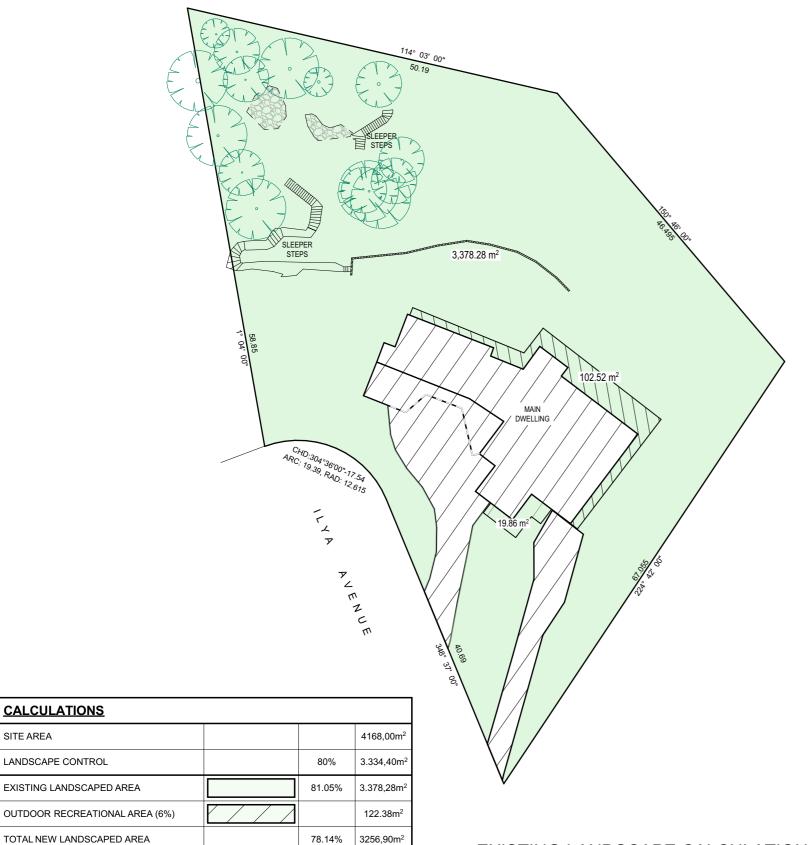


789,72m²

121,38m²

911,10m²

21.86%

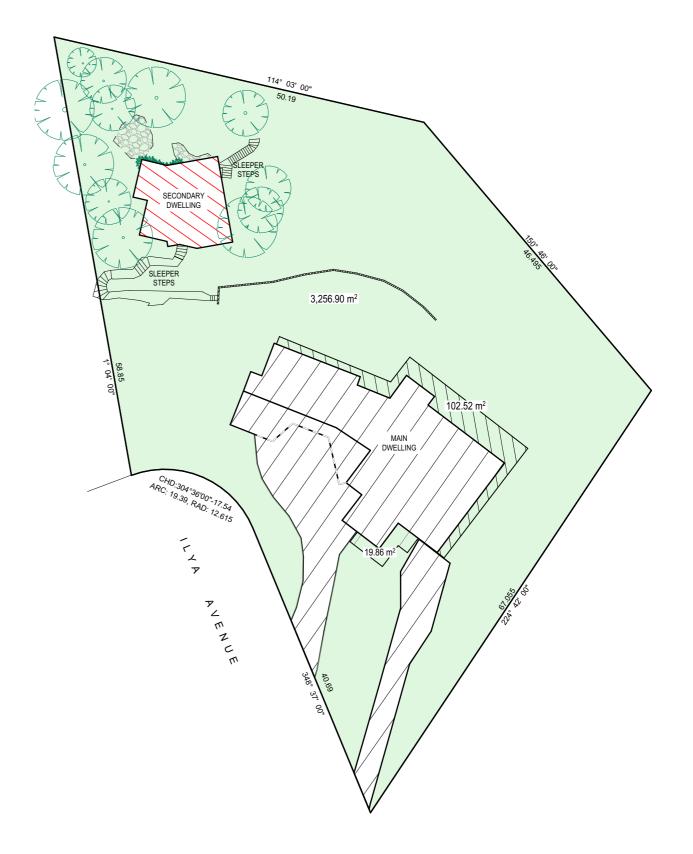

EXISTING LANDSCAPE CALCULATION PLAN

PROPOSED LANDSCAPE CALCULATION PLAN

TRUE NORTH:

EXISTING HARD SURFACE AREA

NEW HARD SURFACE AREA

TOTAL HARD SURFACE AREA



- NOTES (E & OE)

 All structures including stormwater & drainage to engineer's details.

 Do not obtain dimensions by scaling drawings.

 All dimensions are to be checked on site prior to starting work.

 These drawings are to be read in conjunction with all other consultant's drawings and
- specifications.

 All workmanship & materials shall be in accordance with the requirements of current editions.
- All working an indefined strain be in accordance with the requirements of content editions including amendments of the National Construction Code, relevant Australian Standards & local council requirements.

 New materials are to be used throughout unless otherwise noted.

 Concrete footings, slab, structural beams or any other structural members are to be designed by a contribition analysis. by a practicing engineer.

	REV:	DATE:	DESCRIPTION:
	Α	01/09/22	PRELIM. DRAWINGS UPDATED
	В	06/09/22	PRELIM. DRAWINGS UPDATED
03	С	30/01/23	LANDSCAPE CONCEPT PLAN DRAWING
	D	18/08/23	NCC NOTES UPDATED
.au			

	PROPOSED NEW SECONDARY DWELLING 13 ILYA AVENUE - BAYVIEW NSW 2104	
$\frac{1}{2}$	CLIENT: Rex Pemberton	
	DRAWING TITLE: LANDSCAPED AREA CALCULATION PLAN	

DATE:	DRAWN BY:	SCALE:
April/22	LB	1:500 @ A
'		
JOB No:	CHECKED BY:	DRAWING No:
1021/22	JJ	DA 44
1021/22	JJ	DA.11



NEW TREE SELECTED BY CLIENT FROM NORTHERN BEACHES NATIVE TREE BOOKLET NEW NATIVE PLANTS - EMU BUSH -NEW NATIVE PLANTS - LOMANDRA CONFERTIFOLIA OR SIMILAR PHILODENDRO XANADU OR SIMILAR WOOD LATTICE WITH EVERGREEN JASMINE OR SIMILAR PLANTS (shown hatched in green) 2 D.P.28379 PROPOSED BUILDING ABOVE SHOWN DOTTED 2 8

	PLANTS T	ABLE - L	EGEND:		
SYMBOL	COMMON NAME		SCIENTIFIC NAME	HEIGHT	SPREAD
	NEW TREE SELECTED BY CLIENT FROM NORTHERN BEACHES NATIVE TREE BOOKLET			MIN. 8.5m	
A	NATIVE PLANTS - LOMANDRA CONFE	ERTIFOLIA	Seascape	0.6 m	0.6m
	NATIVE PLANTS - EMU BUSH		Eremophila Maculate	1.0 m	1m
	NATIVE PLANTS - KANGAROO PAW or SIMILAR Anigozan		Anigozanthos	1.5 m	3m
	PHILODENDRO 'XANADU' or SIMILAR		Thaumatophyllum Xanadu	1.5 m	2m
5 12	SELECTED CASCADE SILVE	ER FALLS	Dichondra	1.0 m	0.5m
Erwit &	PLANTS (EXAMPLES): TRAIL	LING ROSEMARY	Anigozanthos	0.5 m	3m
	SELECTED PLANTS BY CLIENT		-	-	-
	EXISTING TREE TO REMAIN -		-	-	-
M	EXISTING PALM TREE TO REMAIN		-	-	
	EXISTING TREE TO BE REMOVED -		-	-	-

LANDSCAPE BALCONY CASCADING PLANTS SELECTED PLANTS FOR FOR PARAPET TOP ROOF TERRACE CASCADING PLANTS SELECTED PLANTS FOR FOR PARAPET TOP ROOF TERRACE CASCADING PLANTS FOR PARAPET SELECTED PLANTS FOR TOP ROOF TERRACE LANDSCAPE CONCEPT PLAN - ROOF TERRACE

15 D.P.27133

NATURAL BUSH SLOPING AREA

NATURAL BUSH

SLOPING AREA

OSD

NATURAL BUSH

SLOPING AREA

Exist. Rock

R.W.T.

D.P.27133

1_{14°} 03′ 00″

NEW NATIVE PLANTS - KANGAROO PAW

D.F

NEW TREE SELECTED BY CLIENT

TREE BOOKLET

(refer to table legend)

(shown hatched in green)

BOOKLET

DRAWN BY:

CHECKED BY:

LB

JJ

FROM NORTHERN BEACHES NATIVE

NEW NATIVE PLANTS - LOMANDRA

WOOD LATTICE WITH EVERGREEN

NEW TREE SELECTED BY CLIENT FROM NORTHERN BEACHES NATIVE TREE

CONFERTIFOLIA OR SIMILAR

JASMINE OR SIMILAR PLANTS

EXISTING TREES TO REMAIN

EXIST. TREES TO BE REMOVED

NOTE: NEW TREES ARE TO HAVE A

MINIMUM MATURE HEIGHT OF 8.5m AND BE CONSISTENT WITH COUNCIL'S NATIVE

GARDENING GUIDE - ROLLING HILLS &

SCALE:

DRAWING No:


1:200 @ A3

DA.12

LOWER SHALE SLOPES LOCALITY

SHOWN DOTTED IN RED

TRUE NORTH:

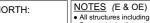

- All structures including stormwater & drainage to engineer's details
 Do not obtain dimensions by scaling drawings.
 All dimensions are to be checked on site prior to starting work.
- These drawings are to be read in conjunction with all other consultant's drawings and
- All workmanship & materials shall be in accordance with the requirements of current editions New materials are to be used throughout unless otherwise noted.
 New materials are to be used throughout unless otherwise noted.
 Concrete footings, slab, structural beams or any other structural members are to be designed.
- by a practicing engineer.
- JJ Drafting 26/90 Mona Vale Road, Mona Vale, NSW, 2103 PO Box 687, Dee Why, NSW, 2099 Mob. 0414 717 541 / Email:enquiries@jjdrafting.com.au www.jjdrafting.com.au

ACN 651 693 346

	REV:	DATE:	DESCRIPTION:
	Α	01/09/22	PRELIM. DRAWINGS UPDATED
	В	06/09/22	PRELIM. DRAWINGS UPDATED
	С	30/01/23	LANDSCAPE CONCEPT PLAN DRAWING
	D	18/08/23	NCC NOTES UPDATED
П			
- 1			

58

.85

Exist. Path

LANDSCAPE CONCEPT PLAN

PROPOSED NEW SECONDARY DWELLING 13 ILYAAVENUE - BAYVIEW NSW 2104	DATE: April/22
CLIENT: Rex Pemberton	JOB No:
DRAWING TITLE: LANDSCAPE CONCEPT PLAN	1021/22

NOTES

DESIGNATED SITE MANAGER/BUILDER

PRIOR TO COMMENCEMENT OF WORK A SITE MANAGER OR BUILDER MUST BE NOMINATED. THE SITE MANAGER OR BUILDER WILL BE RESPONSIBLE AND LIABLE FOR ALL WORKS CARRIED OUT ON THE SITE. THIS ASSUMES THE RESPONSIBILITY FOR THE ACTIONS OF ALL SUBCONTRACTED PARTIES AS WELL AS ADVISING THEM OF COUNCIL'S REQUIREMENTS WHEN CARRYING OUT

TOPSOIL MANAGEMENT

PRIOR TO THE STRIPPING OF TOPSOIL, THE VEGETATIVE COVER MUST BE REDUCED BY EITHER SLASHING OR MOWING. ALL TOPSOIL IS TO BE RETAINED AND PROTECTED FOR REUSE ON SITE. SOIL STOCKPILES MUST NOT BE LOCATED ON NATURE STRIPS, FOOTPATHS, ROADWAYS, KERBS, ACCESSWAYS, WITHIN DRAINAGE LINES/FLOWS/PATHS OR AROUND OR AGAINST TREE SHRUBS. SEDIMENT CONTROL MEASURES MUST BE INCORPORATED WITH ANY RESULTING STOCKPILE. THE STOCKPILE CAN BE PROTECTED FROM EROSION BY COVERING IT WITH AN MPERVIOUS MATERIAL, IN CONJUNCTION WITH THE INSTALLATION OF A SEDIMENT FENCE AROUND IT. IF STOCKPILES ARE TO REMAIN FOR MORE THAN ONE MONTH THEY ARE TO BE GRASSED IMMEDIATELY AND STABILISED WITHIN FOURTEEN DAYS. SURPLUS TOPSOIL MUST BE REASONABLY REMOVED FROM SITE.

BUILDING MATERIAL STOCKPILING

SUFFICIENT AREA MUST BE ALLOCATED WITHIN THE SITE FOR SUCH STORAGE OF BUILDING MATERIALS, DEMOLITION WASTE, WASTE CONTAINERS, ETC. AS WILL BE REQUIRED.

A SEDIMENT FENCE SHOULD BE LOCATED ALONG THE DOWNSLOPE BOUNDARY(S) OF THE SITE ON THE CONSTRUCTION SIDE OF THE TURF FILTER STRIP OR NATIVE VEGETATION, AND AROUND ALL STOCKPILES OF MATERIAL ON THE SITE.

ALL TRUCKS/UTES MUST COVER THEIR LOADS AT ALL TIMES. APPROPRIATE METHODS ARE TO BE EMPLOYED TO PREVENT BLOWING DUST CREATING AN UNACCEPTABLE HAZARD OR NUISANCE ON THE SITE OR DOWN WIND. PRODUCTION OF DUST CAN BE MINIMISED BY LIMITING AREA OF EARTHWORKS, WATERING AND PROGRESSIVE VEGETATION. WHERE DUST IS CREATED AS A RESULT WORKS AND/OR SOIL EXPOSURE, THE BARE SOIL AREAS MUST BE WATERED, DURING AND/OR AT THE END OF EACH DAY TO LAY THE DUST. EARTH MOVING ACTIVITIES SHOULD BE AVOIDED WHERE WINDS ARE SUFFICIENTLY STRONG ENOUGH TO RAISE VISIBLE

EROSION & SEDIMENT CONTROLS

APPROPRIATE EROSION AND SEDIMENT CONTROLS MUST BE IMPLEMENTED ON ALL SITES THAT INVOLVE SOIL DISTURBANCE. THE MEASURES MUST BE IN PLACE PRIOR TO THE COMMENCEMENT OF WORK. THOSE CONTROLS ARE TO BE MONITORED AND MAINTAINED IN ORDER TO SERVE THEIR INTENDED FUNCTION FOR THE DURATION OF THE WORKS OR UNTIL SUCH TIME AS THE SITE IS FULLY STABILISED. IF ANY CONTROLS ARE DAMAGED OR BECOME INEFFECTIVE DURING THE COURSE OF THE WORKS THEY ARE TO BE REINSTATED OR REPLACED IMMEDIATELY. SUFFICIENT ACCESS TO THESE CONTROLS MUST BE PROVIDED IN CASE OF THE

SEDIMENT TRAPS


WHERE A SEDIMENT FENCE IS NOT USED APPROPRIATE SEDIMENT TRAPS SHOULD BE LOCATED AT ALL POINTS WHERE STORMWATER LEAVES THE CONSTRUCTION SITE OR LEAVES THE GUTTER AND ENTERS THE DRAINAGE SYSTEM. A COMMON TECHNIQUE IS THE GRAVEL SAUSAGE.

DIVERSION CHANNELS


A DIVERSION CHANNEL IS AN EXCAVATED EARTH DITCH OR PATH. THESE STRUCTURES ARE JSED TO INTERCEPT AND DIRECT RUN-OFF TO A DESIRED LOCATION WHERE POSSIBLE. ALL STORMWATER RUN-OFF FLOWING ONTO DISTURBED AREAS, INCLUDING STOCKPILES, MUST BE INTERCEPTED, DIVERTED AND/OR SAFELY DISPOSED OF. THIS CAN BE ACHIEVED BY CONSTRUCTING A TEMPORARY EARTH BANK AROUND THE UPSLOPE EXTENT OF THE CONSTRUCTION SITE WHERE THE DIVERSION DOES NOT AFFECT THE NEIGHBOURING


VEHICLE MOVEMENTS

TO LIMIT DISTURBANCE TO THE SITE AND TRACKING OF MATERIAL ONTO THE STREET ALL VEHICLES AND PLANT EQUIPMENT ARE TO USE A SINGLE ENTRY/EXIT POINT UNLESS COUNCIL HAS APPROVED ALTERNATIVE ARRANGEMENTS. ACCESS POINTS AND PARKING AREAS ARE TO BE STABILISED WITH COMPACTED SUB-GRADE ASAP AFTER THEIR FORMATION. IF SPILLAGE DOES OCCUR IT IS TO BE CONTAINED IMMEDIATELY AND CAREFULLY REMOVED. THE AREA AFFECTED IS TO BE RESTORED TO A STANDARD EQUAL TO OR BETTER THAN ITS PREVIOUS CONDITION. ALL VEHICLES ARE TO BE WASHED PRIOR TO EXISTING THE SITE. THIS SERVES THE PURPOSE OF REMOVING SITE MATERIAL ON THE VEHICLE AND PREVENTS IT FROM BEING DEPOSITED ON THE ROAD NETWORK ADJACENT TO THE SITE AND THUS, THE STORMWATER SYSTEM. NO VEHICLE ASSOCIATED WITH THE WORK IS TO BE PARKED ON A FOOTPATH OR PUBLIC RESERVE. ALL VEHICLES VISITING THE SITE DURING DEMOLITION, EXCAVATION AND/OR CONSTRUCTION WORKS, ARE TO COMPLY WITH THE PARKING REQUIREMENTS IN THAT AREA.

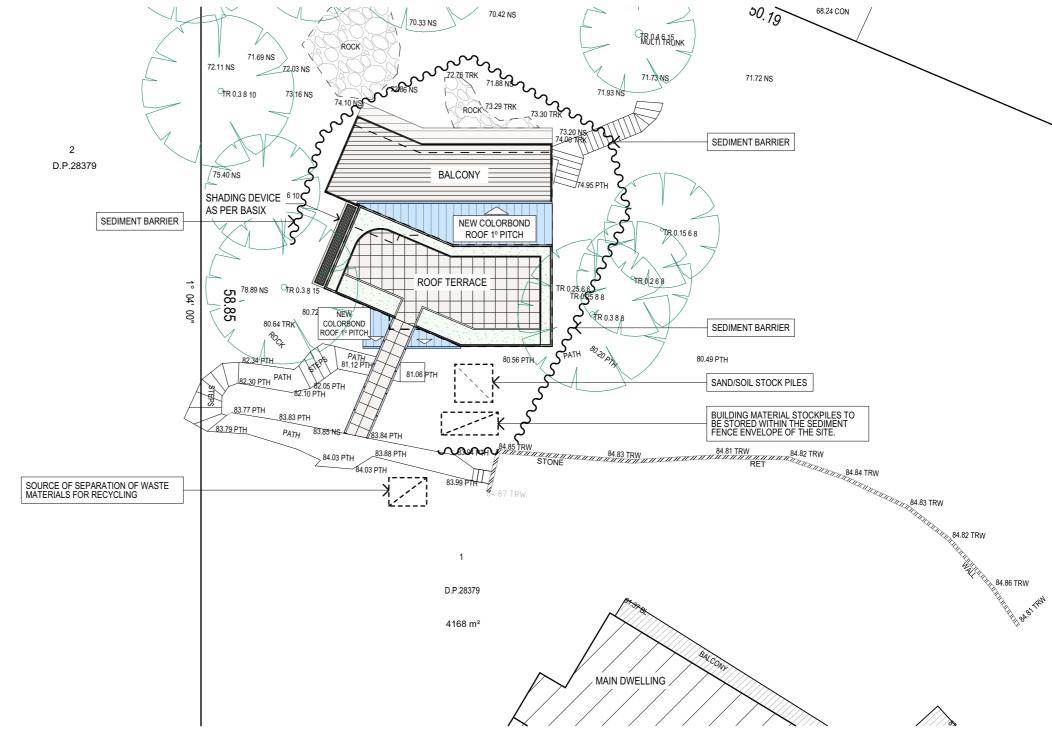

EROSION & SEDIMENT CONTROL / WASTE MANAGEMENT PLAN

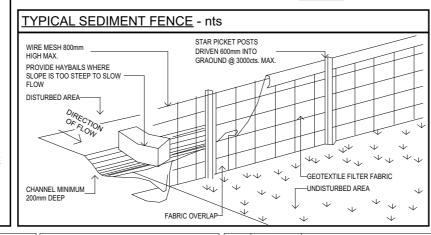

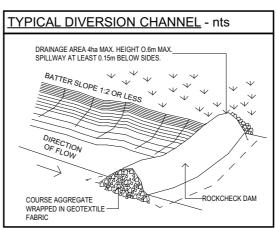

TRUE NORTH:



- NOTES (E & OE)
- All structures including stormwater & drainage to engineer's details
 Do not obtain dimensions by scaling drawings.
 All dimensions are to be checked on site prior to starting work.
- These drawings are to be read in conjunction with all other consultant's drawings and
- All workmanship & materials shall be in accordance with the requirements of current edition nts of the National Construction Code, relevant Australian Sta

- Juncil requirements.

 New materials are to be used throughout unless otherwise noted.

 Concrete footings, slab, structural beams or any other structural members are to be designed.

JJ Drafting
Division of JJ DRAFTING AUSTRALIA PTY LTD
26/90 Mona Vale Road, Mona Vale, NSW, 2103
PO Box 687, Dee Why, NSW, 2099
Mob. 0414 717 541 / Email:enquiries@jjdrafting.com.au


www.jjdrafting.com.au

ACN 651 693 346

	REV:	DATE:	DESCRIPTION:
	Α	01/09/22	PRELIM. DRAWINGS UPDATED
	В	06/09/22	PRELIM. DRAWINGS UPDATED
)3	С	30/01/23	LANDSCAPE CONCEPT PLAN DRAWING
	D	18/08/23	NCC NOTES UPDATED
au			

PROPOSED NEW SECONDARY DWELLING 13 ILYAAVENUE - BAYVIEW NSW 2104	DATE: April/22	DRAWN BY:	SCALE: 1:200 @ /
CLIENT: Rex Pemberton	JOB No:	CHECKED BY:	DRAWING No:
DRAWING TITLE: EROSION & SEDIMENT CONTROL / WASTE	1021/22	JJ	DA.13
MANAGEMENT PLAN			

1:200 @ A3

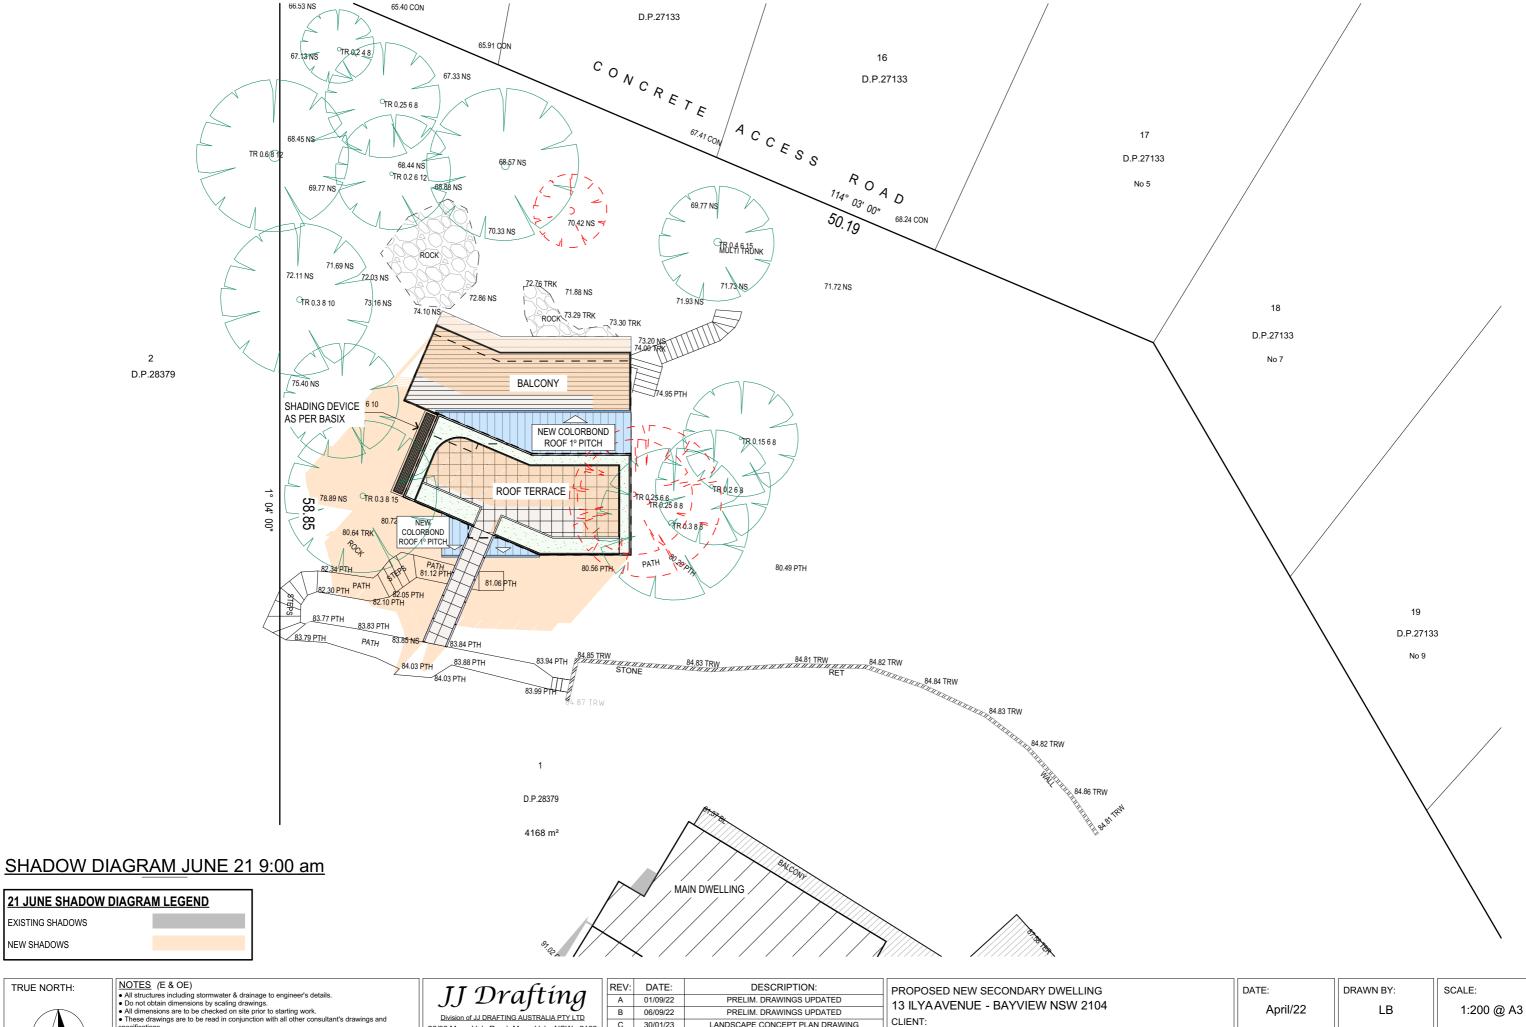

- specifications.


 All workmanship & materials shall be in accordance with the requirements of current editions
- New materials are to be used throughout unless otherwise noted.
 Concrete footings, slab, structural beams or any other structural members are to be designed. by a practicing engineer.

JJ Drafting
Division of JJ DRAFTING AUSTRALIA PTY LTD

	KEV.	DATE.	DESCRIPTION.
	Α	01/09/22	PRELIM. DRAWINGS UPDATED
	В	06/09/22	PRELIM. DRAWINGS UPDATED
3	С	30/01/23	LANDSCAPE CONCEPT PLAN DRAWING
1	D	18/08/23	NCC NOTES UPDATED
u l			

=	PROPOSED NEW SECONDARY DWELLING 13 ILYAAVENUE - BAYVIEW NSW 2104
	CLIENT: Rex Pemberton
	DRAWING TITLE: SHADOW DIAGRAM JUNE 21 9:00 am

	DATE: April/22	DRAWN BY:	SCALE: 1:200 @ A3
_	JOB No:	CHECKED BY:	DRAWING No:
	1021/22	JJ	DA.14

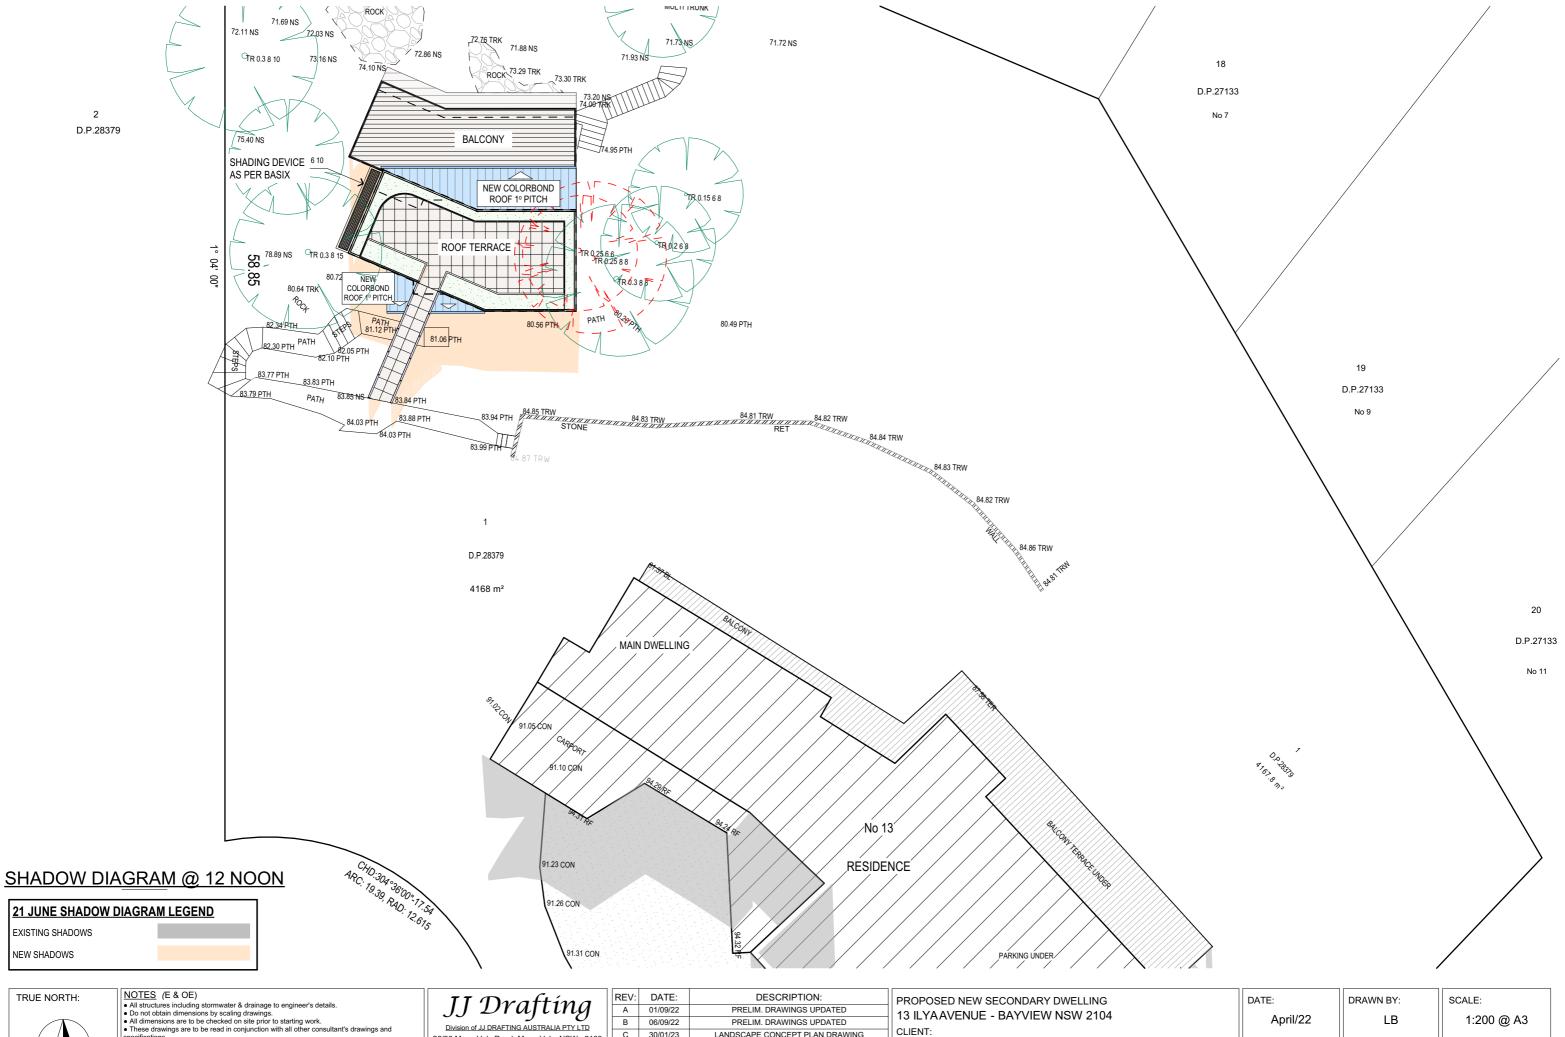



- All working an indefined strain be in accordance with the requirements of content editions including amendments of the National Construction Code, relevant Australian Standards & local council requirements.


 New materials are to be used throughout unless otherwise noted.

 Concrete footings, slab, structural beams or any other structural members are to be designed by a contribition analysis. by a practicing engineer.
- Division of JJ DRAFTING AUSTRALIA PTY LTD 26/90 Mona Vale Road, Mona Vale, NSW, 2103 PO Box 687, Dee Why, NSW, 2099 Mob. 0414 717 541 / Email:enquiries@jjdrafting.com.au www.jjdrafting.com.au ACN 651 693 346

П	REV:	DATE:	DESCRIPTION:	
ı	Α	01/09/22	PRELIM. DRAWINGS UPDATED	
ı	В	06/09/22	PRELIM. DRAWINGS UPDATED	
ı	С	30/01/23	LANDSCAPE CONCEPT PLAN DRAWING	
ı	D	18/08/23	NCC NOTES UPDATED	
ı				
ı				
П				

PROPOSED NEW SECONDARY DWELLING 13 ILYAAVENUE - BAYVIEW NSW 2104 CLIENT: Rex Pemberton	
DRAWING TITLE:	

DATE:	DRAWN BY:	SCALE:
April/22	LB	1:200 @ A3
IOB No:	CHECKED BY:	DRAWING No:
1021/22	JJ	DA.15

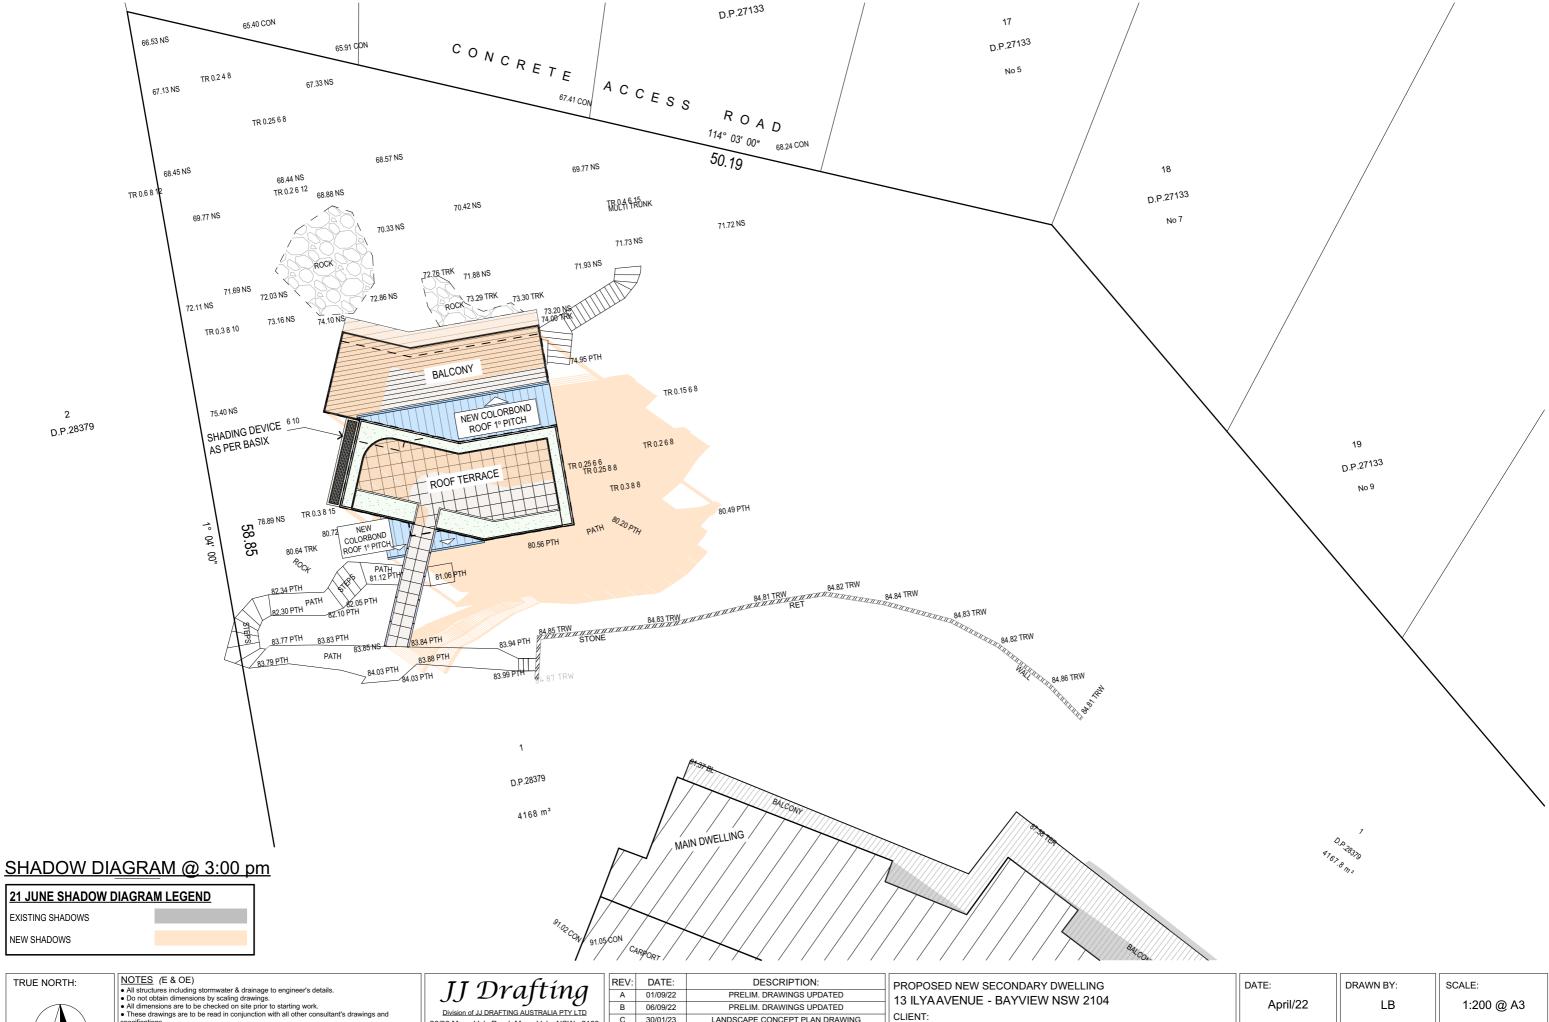



- specifications.

 All workmanship & materials shall be in accordance with the requirements of current editions
- All workflariship a finitetrials sitial use in accordance with the requirements of content construction including amendments of the National Construction Code, relevant Australian Standards & local council requirements.

 New materials are to be used throughout unless otherwise noted.

 Concrete footings, slab, structural beams or any other structural members are to be designed.
- by a practicing engineer.

JJ Drafting
D

Division of JJ DRAFTING AUSTRALIA PTY LTD 26/90 Mona Vale Road, Mona Vale, NSW, 2103 PO Box 687, Dee Why, NSW, 2099 Mob. 0414 717 541 / Email:enquiries@jjdrafting.com.au www.jjdrafting.com.au ACN 651 693 346

	REV:	DATE:	DESCRIPTION:
	Α	01/09/22	PRELIM. DRAWINGS UPDATED
	В	06/09/22	PRELIM. DRAWINGS UPDATED
:	С	30/01/23	LANDSCAPE CONCEPT PLAN DRAWING
	D	18/08/23	NCC NOTES UPDATED
١			
- 1			

PROPOSED NEW SECONDARY DWELLING 13 ILYAAVENUE - BAYVIEW NSW 2104
CLIENT: Rex Pemberton
DRAWING TITLE: SHADOW DIAGRAM JUNE 21 3:00 pm

DATE:	DRAWN BY:	SCALE:
April/22	LB	1:200 @ A3
JOB No:	CHECKED BY:	DRAWING No:
1021/22	JJ	DA.16