NORTHERN BEACHES COUNCIL

Waste Management Plan

(For development in the area of WLEP 2011 and WLEP 2000)

This plan is to be completed in accordance with Council's

Waste Management Guidelines

(For development in the area of WLEP 2011 and WLEP 2000)

Effective Date: 25 October 2016

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Purpose of the Waste Management Plan

This Waste Management Plan (WMP) will detail the arrangements for waste management during all stages of development and occupation.

The WMP must be completed in accordance with the Waste Management Guidelines (Guidelines).

A completed WMP is a mandatory requirement for any Development Application (DA) submitted under WLEP 2011 or WLEP 2000. DAs that are submitted without a completed WMP will be rejected or refused by Council.

Structure of the Waste Management Plan

All applicants are required to complete the 'Applicant and Project Details' part of the WMP and include it with the relevant Sections that apply to their proposed development.

The WMP is divided into Sections and applicants are only required to complete the relevant Sections in accordance with the Guidelines. The table below identifies which Sections are relevant to which development types.

For example, if the proposed development was to include demolition of an existing structure and construction of a single dwelling, the relevant Sections would be Sections 1, 2 and 3.

Section	Development Type^
Section 1 – Demolition	All
Section 2 – Construction	All
Section 3 – On-going waste management for one or two	One or two dwelling developments
dwellings	Mixed-use developments containing
	one or two dwellings
Section 4 – On-going waste management for three or	Three or more dwelling developments
more dwellings	Mixed-use developments containing
	three or more dwellings
Section 5 – On-going waste management for non-	Commercial developments
residential and mixed use developments	Industrial developments
	Mixed-use developments
Section 6 – Private roadway developments	Private roadways

^Note: the definitions of the development types are provided in Section vi of the Introduction to the Guidelines

Applicant and Project Details

Complete this page and the relevant Sections that apply to your proposed development.

Applicants' Details

Name: (must be the same as the DA form)	Tim & Air Kiehne
Address: (must be the same as the DA form)	13 Athol Street Frenchs Forest, NSW, 2086
Phone Number:	0423 328 617 Air, 0409 242 251 Tim
Email Address:	air.kiehne@gmail.com

Property Details

Lot No: Deposited Plan (DP) No: or Strata Plan (SP) No:	Lot 13 DP 225845
Unit No:	13 Athol Street
House No:	
Street:	
Suburb:	Frenchs Forest
Postcode:	2086

Project Details

Description of proposed development:	Demolition of an existing swimming pool and construction of a new swimming pool
Structures to be demolished:	existing swimming pool

Applicant Declaration

I declare that:

- 1. This plan has been completed in accordance with the Waste Management Guidelines
- 2. To the best of my knowledge, the details on this form are accurate and correct

NORTHERN BEACHES COUNCIL Waste Management Plan Effective Date: 25 October 2016

I understand that:

- All records demonstrating lawful disposal of waste will be retained and kept readily accessible for inspection by regulatory authorities such as Council, NSW Environment Protection Authority or WorkCover NSW.
- 2. A bond in accordance with Council's fees and charges may apply to this development and must be paid to Council prior to any works commencing.
- 3. The bond will only be refunded when Council is satisfied that all waste outlined in this plan has been managed as per the plan, and evidence such as photos, receipts and statutory declarations must be supplied where appropriate.

Signature of Applicant:	- lo	SIGN HERE	Date: 31/10/2022	
olgitatare of Applicant.				

Section 1 - Demolition

This section must be completed in accordance with 'Chapter 1 – Demolition' of the Waste Management Guidelines

MATERIALS ON SITE		DESTINATION Evidence such as weighbridge dockets and invoices for waste disposal or must be retained on site for inspection				r recycling	
		AND RECYCLING (MOST FAVOURABLE)			DISPOSAL (LEAST FAVOURABLE)		
Types of Waste Material	Estimated Volume (m³) or Weight (t)	ONSITE RE-USE ✓ Specify how material will be reused on site	OFFSITE RECYCLING ✓ Recycling Outlet (RO) ✓ Waste Transport Contractor (WTC) OFFSITE DISPO ✓ Specify landfi site (LS) ✓ Specify Waste Transport Contractor (W		landfill) Waste ort		
	T		WTC	RO	WTC	LS	
Excavated Material							
Garden Organics							
Bricks							
Tiles	3m ^3				OPTION NO	DΤ	
Concrete	18 m ^3				AVAILABLE These mate be re-used	:: rials must	
Timber					separated or separated on or off site and sent for recycling.		
Plasterboard							
Metals	6m ^3						
Asbestos							
Other waste (please specify)							
Estimated Total % Recovered		oo in 'Chantar 1	Damalitian' a				

Refer to the estimation tables in 'Chapter 1 – Demolition' of the Guidelines for assistance in completing this table.

The applicant must submit a Site Plan showing the structures to be demolished and storage areas for waste and construction materials (if the development also includes construction).

Have you included the following:	Applicant Tick
 A site plan showing: The structures to be demolished. Storage areas for waste to be reused, recycled, or disposed of. Materials storage (if the development also includes construction) 	x
The table on the previous page, completed in accordance with 'Chapter 1 – Demolition' in the guidelines.	

<u>LEGEND</u>

AWN - AWNING **BALC - BALCONY LEVEL** CHM - CHIMNEY LEVEL CL - ROAD CENTER LINE LEVEL CONC - CONCRETE SURFACE LEVEL DECK - DECK LEVEL EPIT - ELECTRICAL PIT **ELEC- ELECTRICAL SUBSTATION** TPIT TELECOMMUNICATION PIT FLR - FLOOR LEVEL GAS - GAS METER GATE - GATE GDN - GARDEN LEVEL GRATE - GRATED PIT LEVEL **GRV - GRAVEL LEVEL HC - HOUSE CONNECTION HYD - HYDRANT** INV- INVERT LEVEL KT - TOP OF KERB LEVEL KI - KERB INVERT LEVEL LP - LIGHT POLE PAR - PARAPET LEVEL PAT - PATIO PATH - PATH LEVEL PAV - PAVING LEVEL PINV - PIT INVERT POOL - POOL LEVEL RWT - RAIN WATER TANK ROOF - ROOF LEVEL SIC - SEWER INSPECTION CAP SKYL - SKYLIGHT LEVEL SPIPE - SEWER VENT PIPE SPHT - SPOT HEIGHT STEP - STEP LEVEL

TR/6/0.2/5 - TREE (SPREAD 6m, TRUNK DIA 0.2m, HEIGHT 5m) DIMENSIONS ARE **APPROXIMATE**

DOOR TOP **BD - DOOR BOTTOM** WINDOW TW - WINDOW TOP **BW - WINDOW BOTTOM**

TG - TOP OF GUTTER

TILE - TILED LEVEL TOW - TOP OF WALL

TPIT - TELSTRA PIT


WM - WATER METER

BOW- BOTTOM OF WALL)

CONTOUR INTERVAL - 0.2m

BM NAIL IN KERB 151.78 WALL - WALL LEVEL (TOW- TOP OF WALL,

- 1. A FIELD BOUNDARY SURVEY (BOUNDARY IDENTIFICATION) HAS BEEN UNDERTAKEN WITH BOUNDARIES DEFINED UTILISING DP224535,DP225845, DP247597, DP1190985 & DP1192794 BOUNDARY DIMENSIONS CAN MOVE TO A DEGREE WITH THE LODGEMENT OF A PLAN AT THE TITLES OFFICE OF THE SUBJECT LOT OR OF A LOT IN THE VICINITY.
- 2. DIMENSIONED STRUCTURES ARE IN RELATION TO THIS BOUNDARY SURVEY. 3. ORIGIN OF LEVELS SSM9174 RL: 159.318m (A.H.D.- CLASS LC) SEARCH DATED
- 22/12/2022.
- 4. BEARINGS ARE ON MGA GRID NORTH. 5. RELATIONSHIP OF OTHER IMPROVEMENTS, DETAIL AND ADJOINING BUILDINGS TO THE BOUNDARY, IF CRITICAL, WILL REQUIRE FURTHER SURVEY. IF ANY FENCING OR BUILDING NEAR THE SUBJECT BOUNDARIES IT IS RECOMMENDED THAT THE BOUNDARIES BE PHYSICALLY MARKED BY A REGISTERED SURVEYOR.
- 6. SERVICES SHOWN ARE BASED ON VISIBLE SURFACE INDICATORS EVIDENT AT THE DATE OF SURVEY ONLY. DIAL BEFORE YOU DIG AND ALL SERVICE AUTHORITIES SHOULD BE CONTACTED PRIOR TO ANY DEVELOPMENT. 7. ROOF AND EAVE & GUTTER HEIGHTS HAVE BEEN OBTAINED BY AN INDIRECT
- METHOD AND ARE ACCURATE FOR PLANNING PURPOSES ONLY. 8. ADJOINING BUILDINGS AND DWELLINGS HAVE BEEN PLOTTED FOR DIAGRAMMATIC PURPOSES ONLY AND SPECIFIC DETAILS, IF CRITICAL, WILL
- REQUIRE FURTHER SURVEY. 9. THE DIAMETER OF TREE TRUNKS CONTAINED WITHIN TREE SYMBOLS ARE NOT
- TO SCALE AND ARE INDICATIVE ONLY. 10. IF TREE DIMENSIONS ARE NOT STATED, TREE SYMBOLS ARE USED TO INDICATE THE OUTLINE OF A HEDGE. SYMBOLS MAY NOT INDICATE ACTUAL AMOUNT OF
- 11. RESTRICTIONS ON THE USE OF LAND NOTED ON TITLE (DP224535 & DP225845)

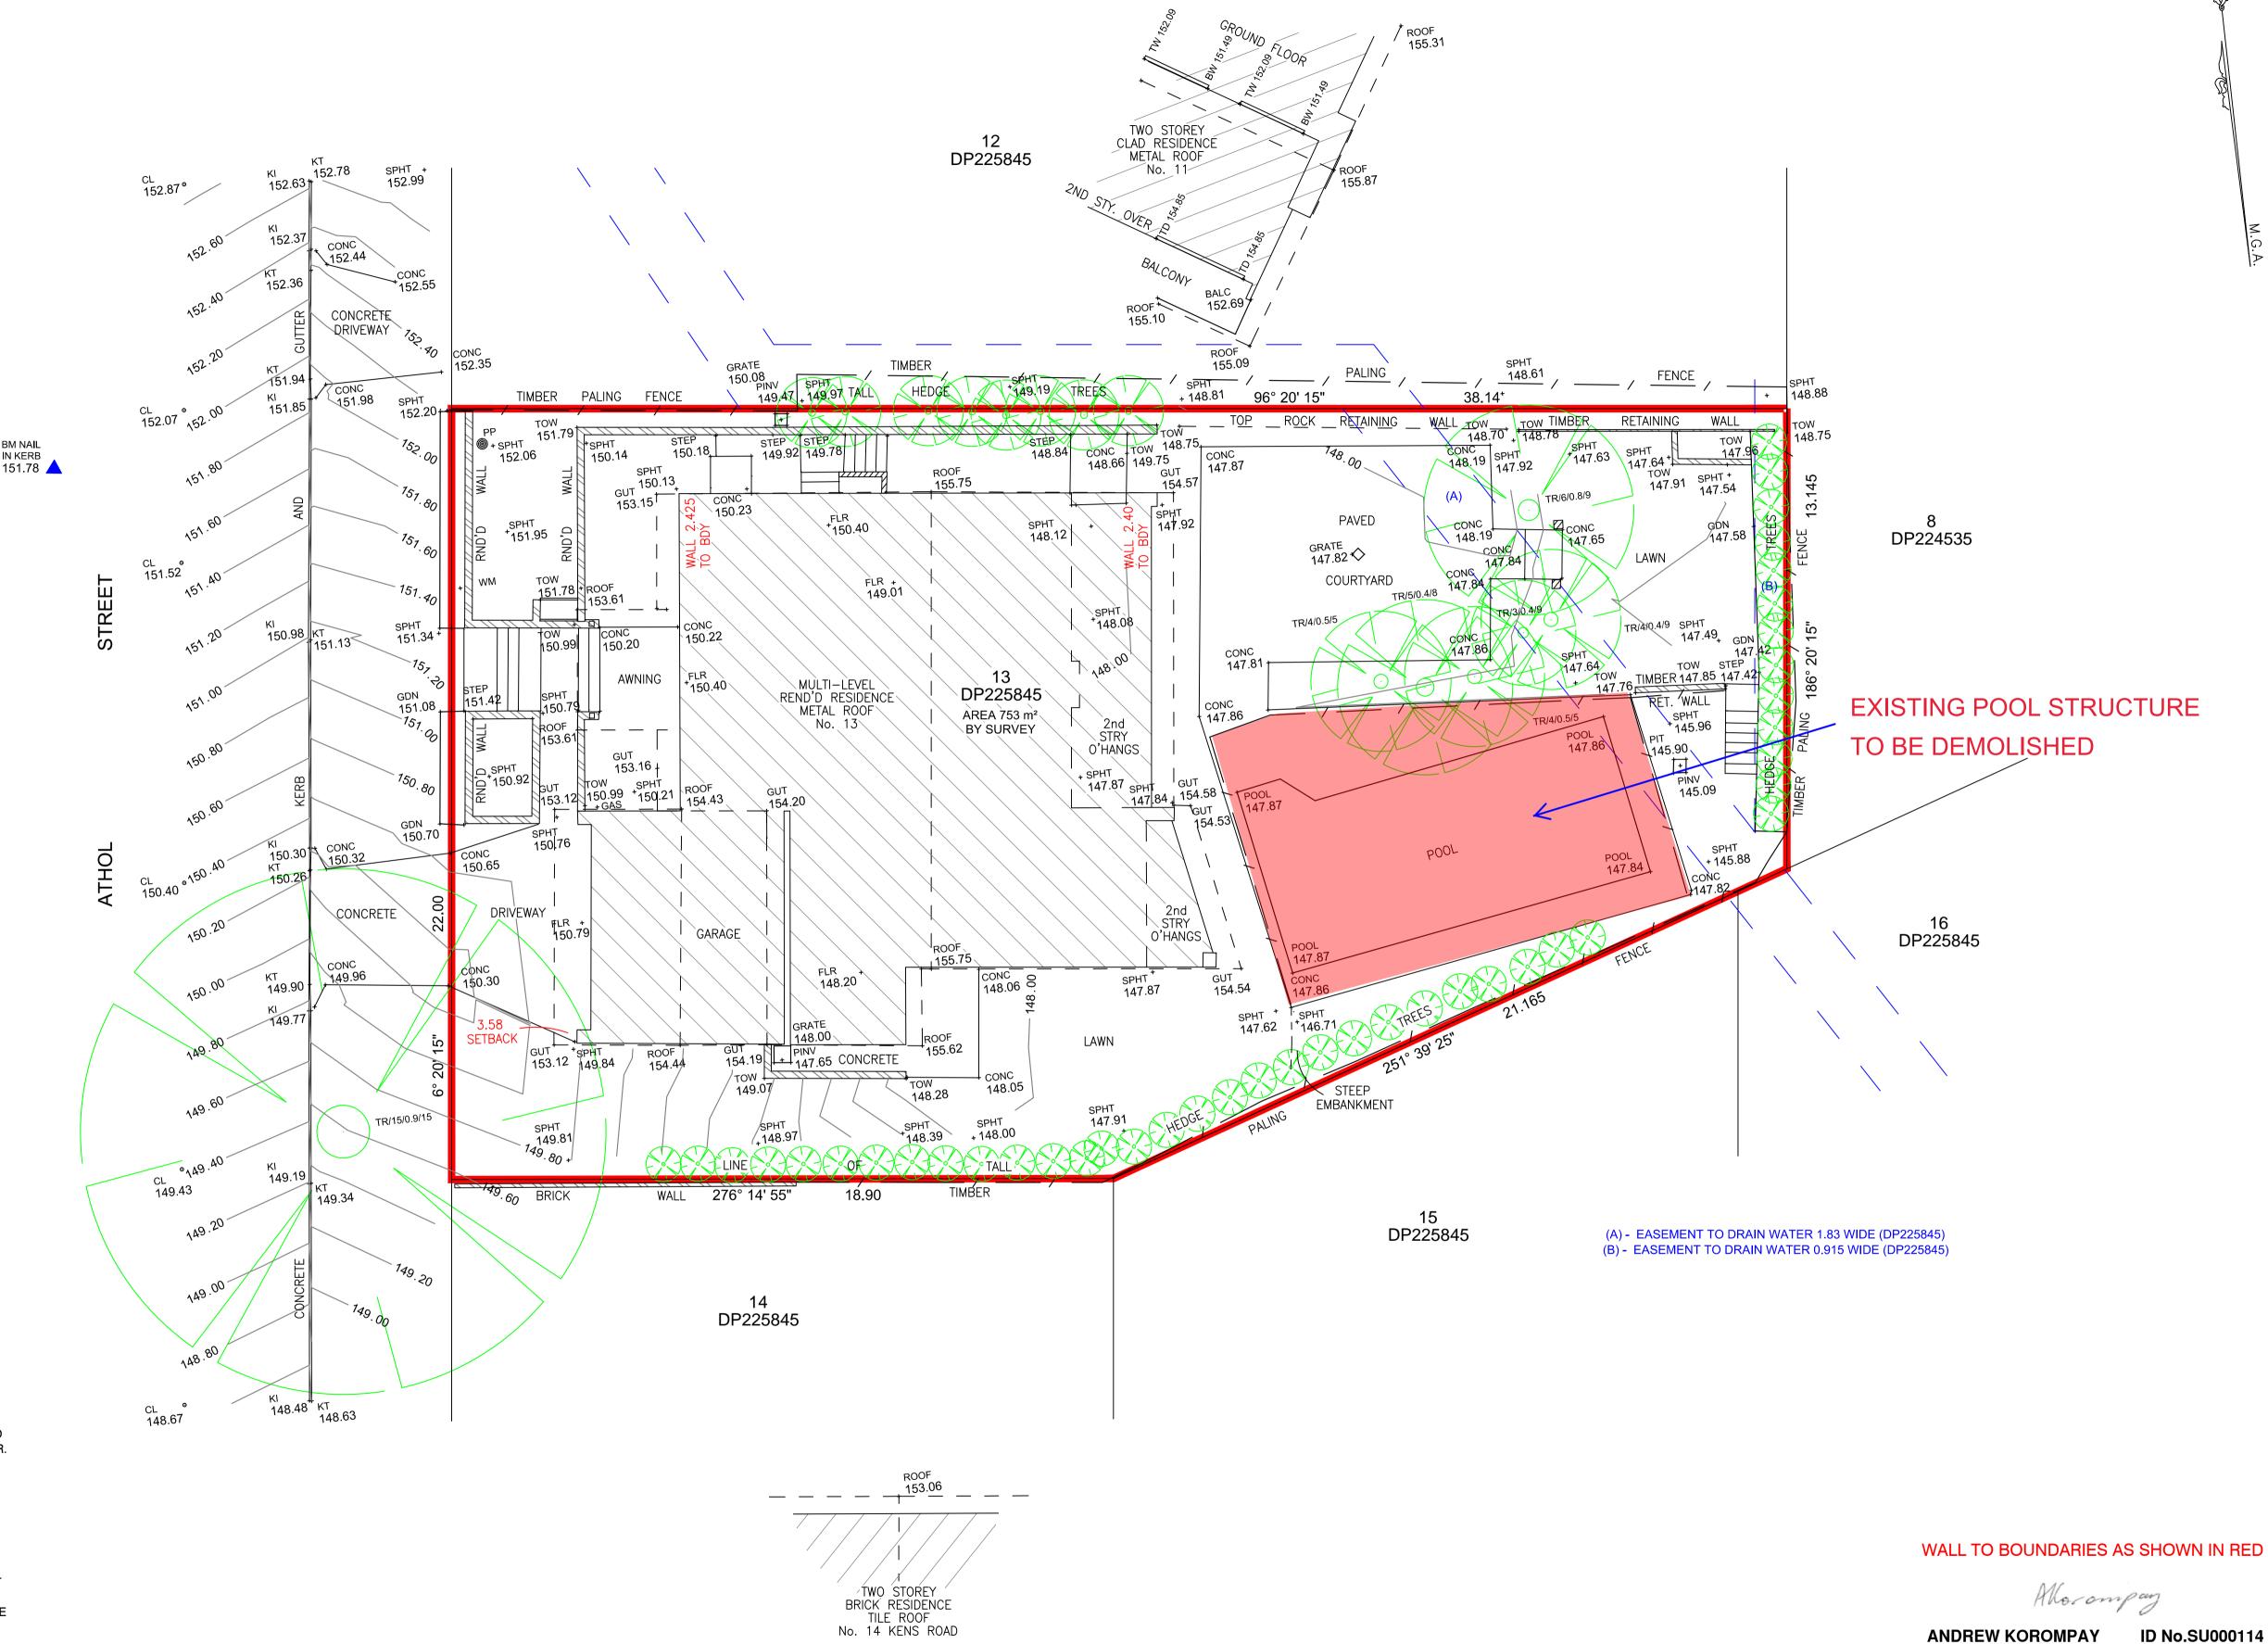

INITIAL ISSUE 19/01/23 **REVISION DESCRIPTION** DATE REVISION

PLAN OF DETAIL OVER No. 13, ATHOL STREET, FRENCHS FOREST, NSW, 2086.



TRUENORTH SURVEY GROUP A.B.N. 97 106 447 198 Registered Consulting Surveyors

16/9 Narabang Way Belrose NSW 2085 Tel: (02) 9450 0868 Mob: (0412) 353 784

Email: andrew@truenorthsurveys.com.au

SCALE: 1:100 @ A1 : 1:200	DATE: 19/01/2023	
CLIENT: TIMOTHY AND AIR	DATUM: AHD	
JOB No. 2639	PAGE 1 OF 1	
DRAWN	CHECKED	APPROVED
KS	AK	AK
DRAWING No. 2639		REVISION 0

Surveyor Registered under The Surveying Act, 2002.

Section 2 - Construction


This section must be completed in accordance with 'Chapter 2 – Construction' of the Waste Management Guidelines


MATERIALS ON SITE	DESTINATION Evidence such as weighbridge dockets and invoices for waste disposal or recycling must be retained on site for inspection					
	REUSE	AND RECYCLING (N	G (MOST FAVOURABLE) DISPOSAL (L FAVOURAB			
Types of Waste Material	Estimated Volume (m³) or Weight (t)	ONSITE RE-USE ✓ Specify how material will be reused on site	✓ Specify recycling outlet (RO)		OFFSITE D ✓ Specify site (LS ✓ Specify Transpo Contract	landfill) Waste
* Please specify			WTC	RO	WTC	LS
Excavated Material	52					
Garden Organics						
Bricks						
Tiles					OPTION NO)Τ
Concrete					AVAILABLE: These materials must be re-used or separated on or off site and sent for	
Timber*						
Plasterboard					recycling.	
Metals*						
Asbestos						
Other waste*						
Estimated Total % Recovered						

Refer to the estimation tables in 'Chapter 2 – Construction' of the Guidelines for assistance in completing this table.

The applicant must submit a Site Plan showing the structures to be demolished and storage areas for waste and construction materials (if the development also includes construction).

Have you included the following:	Applicant Tick
 A site plan showing: The structures to be demolished. Potential storage areas for waste to be reused, recycled, or disposed of. Materials storage 	X
The table on the previous page, completed in accordance with 'Chapter 2 – Construction' in the guidelines.	x

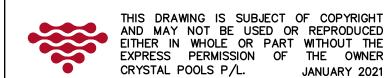

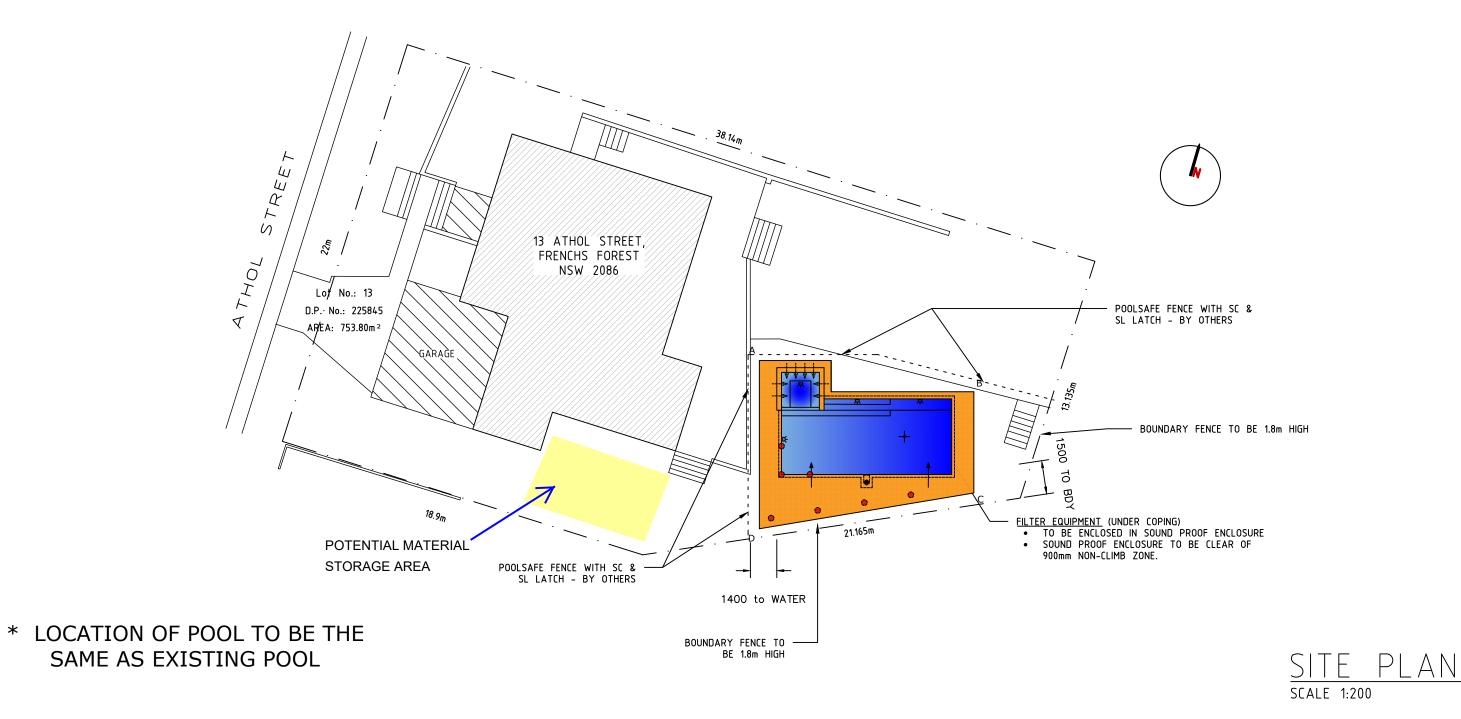

•	•	•	•
REVI	S EB.10 00P	INDIFWIDTHS	•
В	09.10	REVISED POOL PLAN, BDY OFFSET	CMF
Α	25.03	ISSUED FOR CONSTRUCTION	CMF
REV.	DATE	AMENDMENT	DRAWN

Consulting Engineer:



Innovative Building Systems Australia Pty Ltd 14 Monterey Parade, Ermington Heights NSW 2115 ACN: 44 124 486 497 Ph: (02) 9804 8725

CHRISTIAAN FITZSIMON BSc BE MIEAust # 987546



1 CENTRAL AVENUE THORNLEIGH NSW 2120

(02) 9875 4555 | SALES@CRYSTALPOOLS.COM.AU PO BOX 271 PENNANT HILLS NSW 1715

PROPOSED SWIMMING POOL

FOR: AIR & TIM KIEHNE

#: 0423 328 617

AT: 13 ATHOL STREET, FRENCHS FOREST NSW 2086

DATE 25.03.2022

JOB NUMBER

14718

DWG No. P02

REV.

Section 3 – On-going waste management for one or two dwellings

This section is to be completed in accordance with 'Chapter 3 – On-going waste management for one or two dwellings' of the Waste Management Guidelines.

Type of development:	
Number of dwellings:	•

Do your architectural and landscape plans include the following:	Applicant Tick
Waste Storage Area design requirements (Chapter 3.2.)	
Waste Storage Area location requirements (Chapter 3.3.)	

Section 4 - On-going waste management for three or more dwellings

This section is to be completed in accordance with 'Chapter 4 – On-going waste management for three or more dwellings' of the Waste Management Guidelines.

Type of development:	
	•
Number of dwellings:	

WMP Checklist and Applicant Declaration

Do your architectural/landscape plans include the following:	Applicant Tick	N/A
Waste Storage Area design requirements (Chapter 4.2.)		-
Waste Storage Area location requirements (Chapter 4.3.)		-
Pathway, access and door requirements (Chapter 4.4.)	9	-
Clean-up waste requirements (Chapter 4.5.)		
Kerbside (on-street) waste collection requirements (Chapter 4.6.)		
On-site (off-street) waste collection requirements (Chapter 4.7.)		

Section 5 - On-going waste management for non-residential and mixed use developments

This section is to be completed in accordance with 'Chapter 5 – On-going waste management for non-residential developments' and 'Chapter 6 – On-going waste management for mixed use developments' of the Waste Management Guidelines.

Type of development:	
Number of commercial premises:	
Number of Waste Storage Areas:	

Do your architectural/landscape plans include the following:	Applicant Tick	N/A
Waste Storage Area design requirements (Chapter 5.2.)		-
Waste Storage Area location requirements (Chapter 5.3.)		1

Section 6 - Private roadway developments

This section is to be completed in accordance with 'Chapter 7 – Private roadway developments' of the Waste Management Guidelines.

Type of development:	
Number of dwellings:	
(Only applicable for sub-divisions)	

WMP Checklist and Applicant Declaration

Do your sub-division plans include the following:	Applicant Tick	N/A
Council's waste vehicle design requirements (Chapter 7.2.)	9	
Waste Storage Area requirements (Chapter 7.3.)		