
Note: Proposed stormwater is to connect into the existing stormwater system.

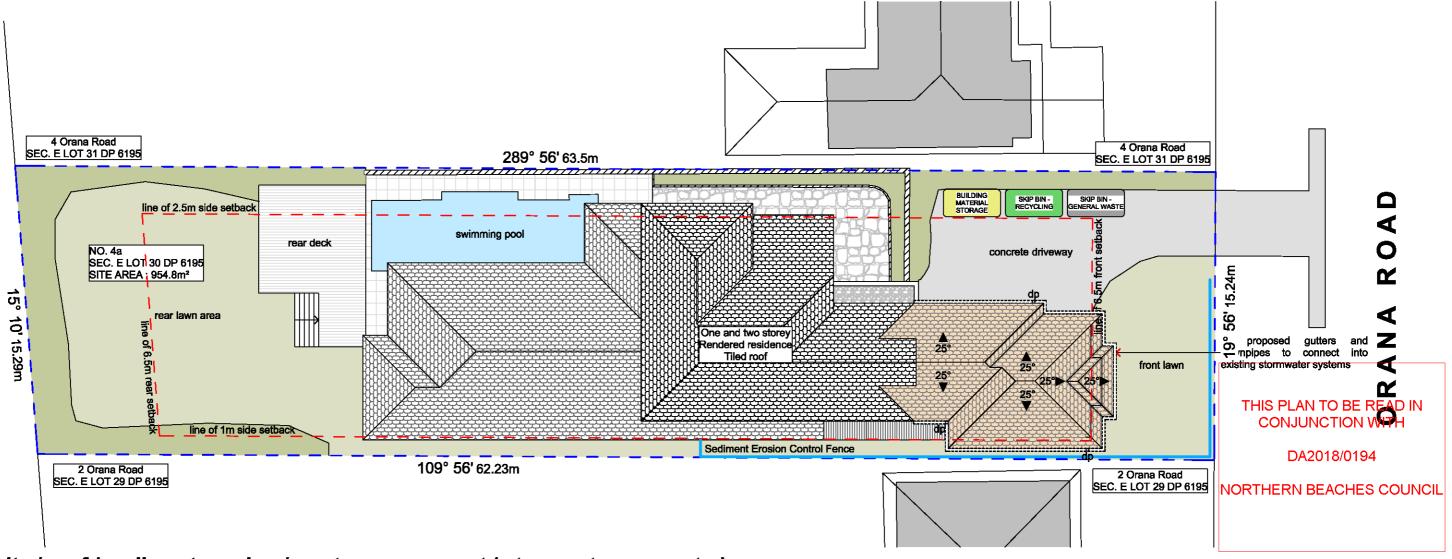

site / roof / sediment erosion / waste management / stormwater concept plan

1:200 @ A3

DUST CONTROL:

TO REDUCE DUST GENERATED BY WIND ACTION, THE REMOVAL OF THE TOP SOIL IS TO BE MINIMISED. TO PREVENT DUST GENERATION, WATERING DOWN OF THE SITE. ESPECIALLY DURING THE MOVEMENT OF MACHINERY IS REQUIRED. WHERE EXCAVATING INTO ROCK. KEEP THE SURFACE MOIST TO MINIMISE DUST. 3. ALL MATERIAL STOCKPILE TO BE CLEAR FROM CONSTRUCT A GRAVEL ENTRY/EXIT POINT USING BLUE DRAINS, GUTTERS AND FOOTPATHS, OR WITHIN METALAND RESTRICT ALL VEHICLE MOVEMENTS WITHIN THE SITE TO A MINIMUM. ENSURE WIND BREAKS, SUCH AS EXISTING FENCES ARE MAINTAINED SOON AS POSSIBLE, IF STORED ON SITE, IT MUST BE IF REQUIRED PROVIDE DIVERSION DRAIN & BANK DURING THE CONSTRUCTION PHASE UNTIL NEW LANDSCAPING IS PROVIDED OR REINSTATED. PREVENT DUST BY COVERING STOCKPILES

SEDIMENT NOTE:

1. ALL EROSION AND SEDIMENT CONTROL MEASURES ALL STOCKPILES ARE TO BE KEPT ON-SITE WHERE TO BE INSPECTED AND MAINTAINED DAILY BY THE SITE POSSIBLE. ANY MATERIALS PLACED ON THE MANAGER.

2. MINIMISE DISTURBED AREAS, REMOVE EXCESS SOIL PERMISSION. FROM EXCAVATEDAREA AS SOON AS POSSIBLE. SEDIMENT FENCE AREA.

4. DRAINAGE TO BE CONNECTED TO STORMWATERAS OVER STOCKPILES. FILTERED BEFORE RELEASING INTO STORMWATER SYSTEM OR WATERWAYS.

5. ROADS AND FOOTPATHS TO BE SWEPT DAILY.

STOCKPILES:


FOOTPATHS OR NATURE STRIPS REQUIRE COUNCIL'S

ALL STOCKPILES ARE TO BE PLACED AWAY FROM THE DRAINAGE LINES AND STREET GUTTERS. IT IS BEST TO LOCATE THESE ON THE HIGHEST PART OF THE SITE IF POSSIBLE. PLACE WATERPROOF COVERING

AROUND STOCKPILES.

GUTTER PROTECTION:

PROVIDE PROTECTION TO DOWNHILL GRATE IN GUTTER BY MEANS OF SAND BAGS OR BLUE METAL WRAPPED IN GEOTEXTILE FABRIC. WHEN SOIL OR SAND BUILDS UP AROUND THIS SEDIMENT BARRIER, THE MATERIAL SHOULD BE RELOCATED BACK TO THE SITE FOR DISPOSAL.

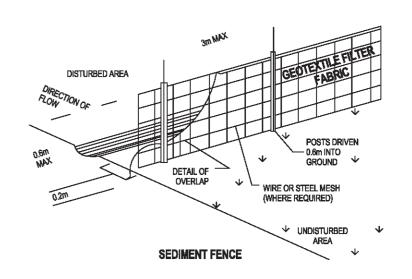

ACTION PLANS

m: 0403957518 e:design@actionplans.com.au

This drawing is the copyright of Action Plans and not be altered, reproduced or transmitted in any form or by any means in part or in whole with the written permission of Action Plans.

All levels and dimensions are to be checked and verified on site prior to commencement of any work, making of shop drawings or fabrication of compnents

Do no scale on drawings. Use figured dimensions.



CLIENT

Annie Pogson & Wayne

PROJECT ADDRESS 4A Orana Rd, Mona Vale NSW 2103

DRAWING NO.

DA02

DATE 07 September 2017


DRAWING NAME

SITE / ROOF / SEDIMENT EROSION PLAN

SCALE

1:200, 1:100, 1:1.46



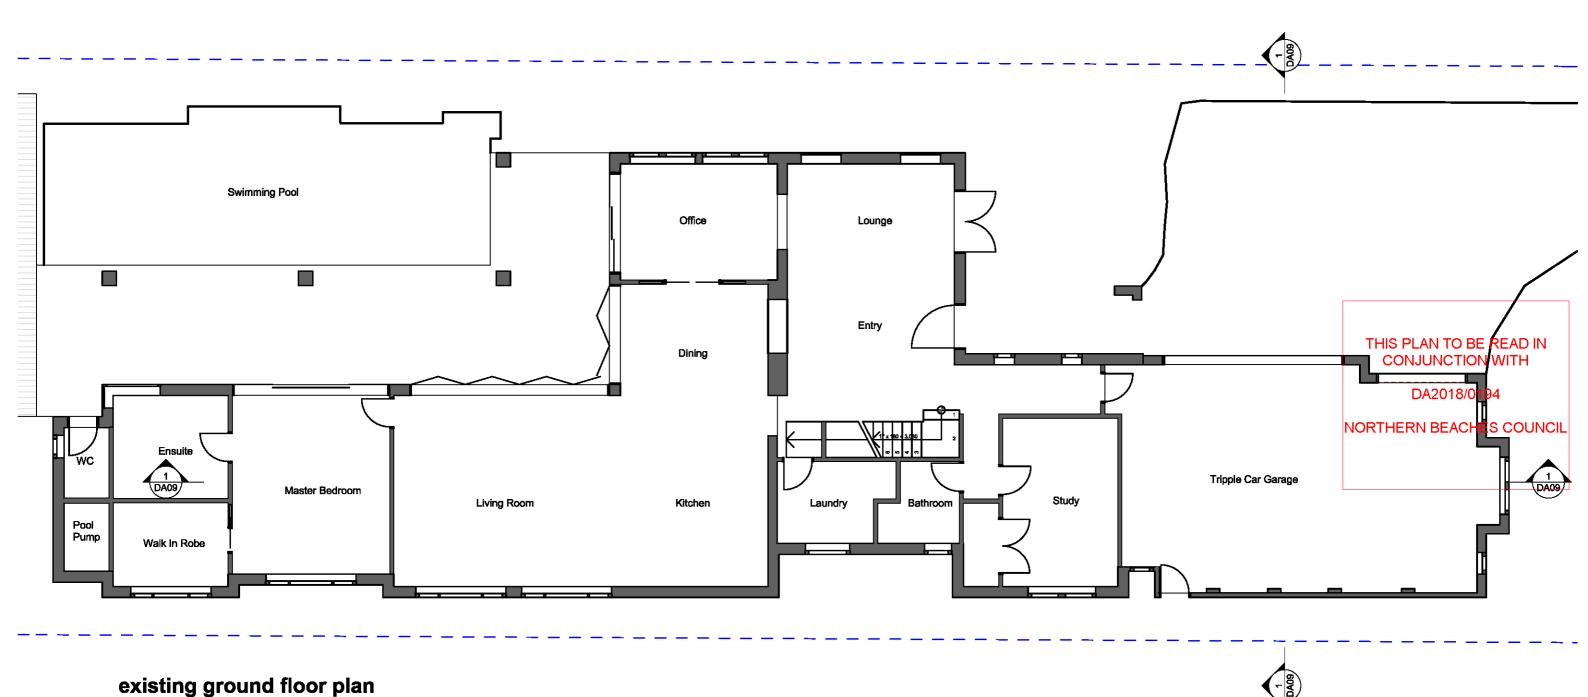




1:100 @A3

m: 0403957518 e:design@actionplans.com.au w: www.actionplans.com.au NOTES

This drawing is the copyright of Action Plans and not be altered, reproduced or transmitted in any form or by any means in part or in whole with the written permission of Action Plans.

All levels and dimensions are to be checked and verified on site prior to commencement of any work, making of shop drawings or fabrication of compnents.

Do no scale on drawings. Use figured dimensions.

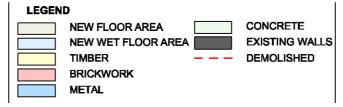

CLIENT

Annie Pogson & Wayne

PROJECT ADDRESS 4A Orana Rd, Mona Vale NSW 2103 DRAWING NO.

DA03


DATE

FLOOR PLAN

DATE 07 September 2017 DRAWING NAME EXISTING GROUND FLOOR PLAN

SCALE 1:100 @A3



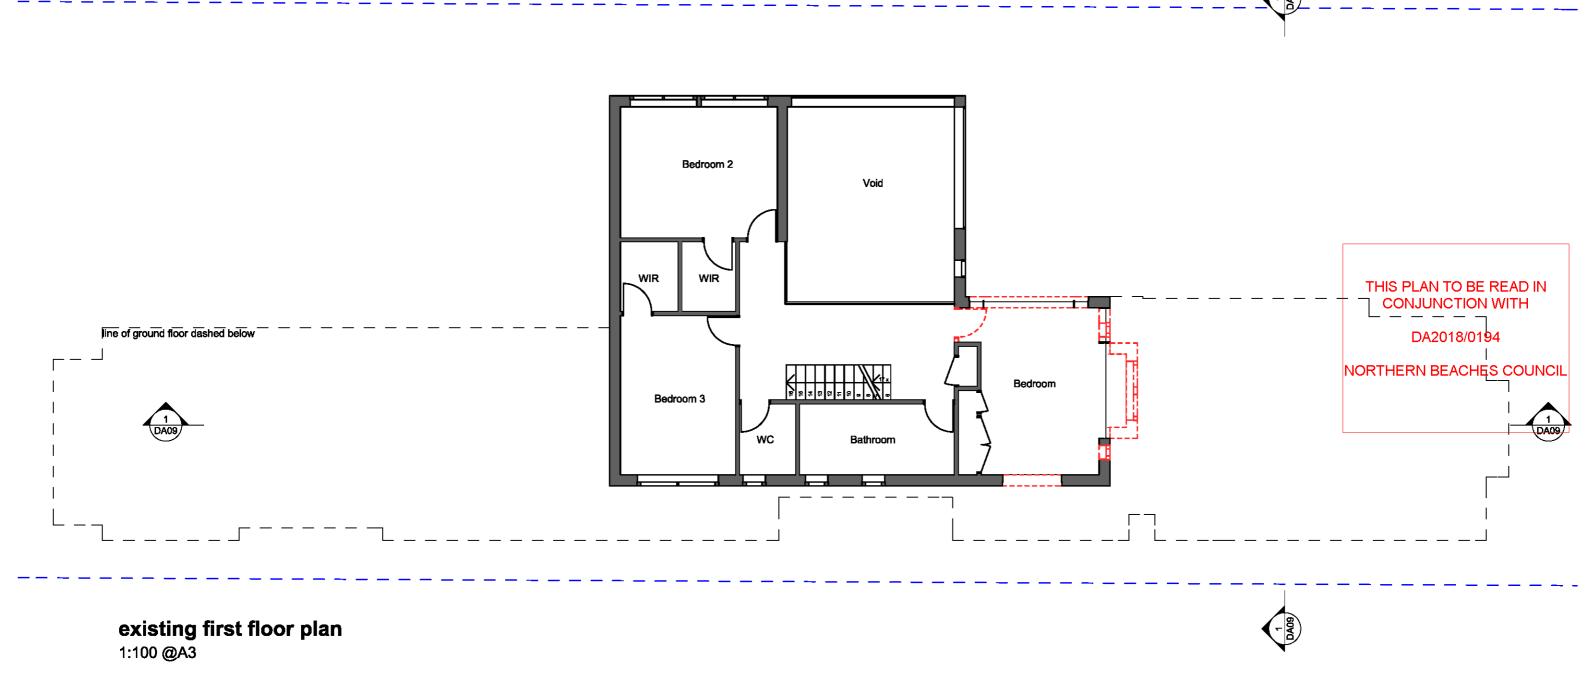

CLIENT

NSW 2103

Annie Pogson & Wayne

PROJECT ADDRESS

4A Orana Rd, Mona Vale

CONCRETE

DEMOLISHED

EXISTING WALLS

LEGEND

NEW FLOOR AREA

TIMBER

METAL

BRICKWORK

NEW WET FLOOR AREA

This drawing is the copyright of Action Plans and not be altered, reproduced or transmitted in any form or by any means in part or in whole with the written permission of Action Plans.

All levels and dimensions are to be checked and verified on site

Do no scale on drawings. Use figured dimensions.

fabrication of compnents.

prior to commencement of any work, making of shop drawings or

ACTION PLANS

e:design@actionplans.com.au

m: 0403957518

Note: Demolition to Engineer's specifications and to comply with AS 2601 - 2001

DRAWING NAME

EXISTING FIRST FLOOR PLAN

SCALE


1:100 @A3

DRAWING NO.

07 September 2017

DA05

DATE

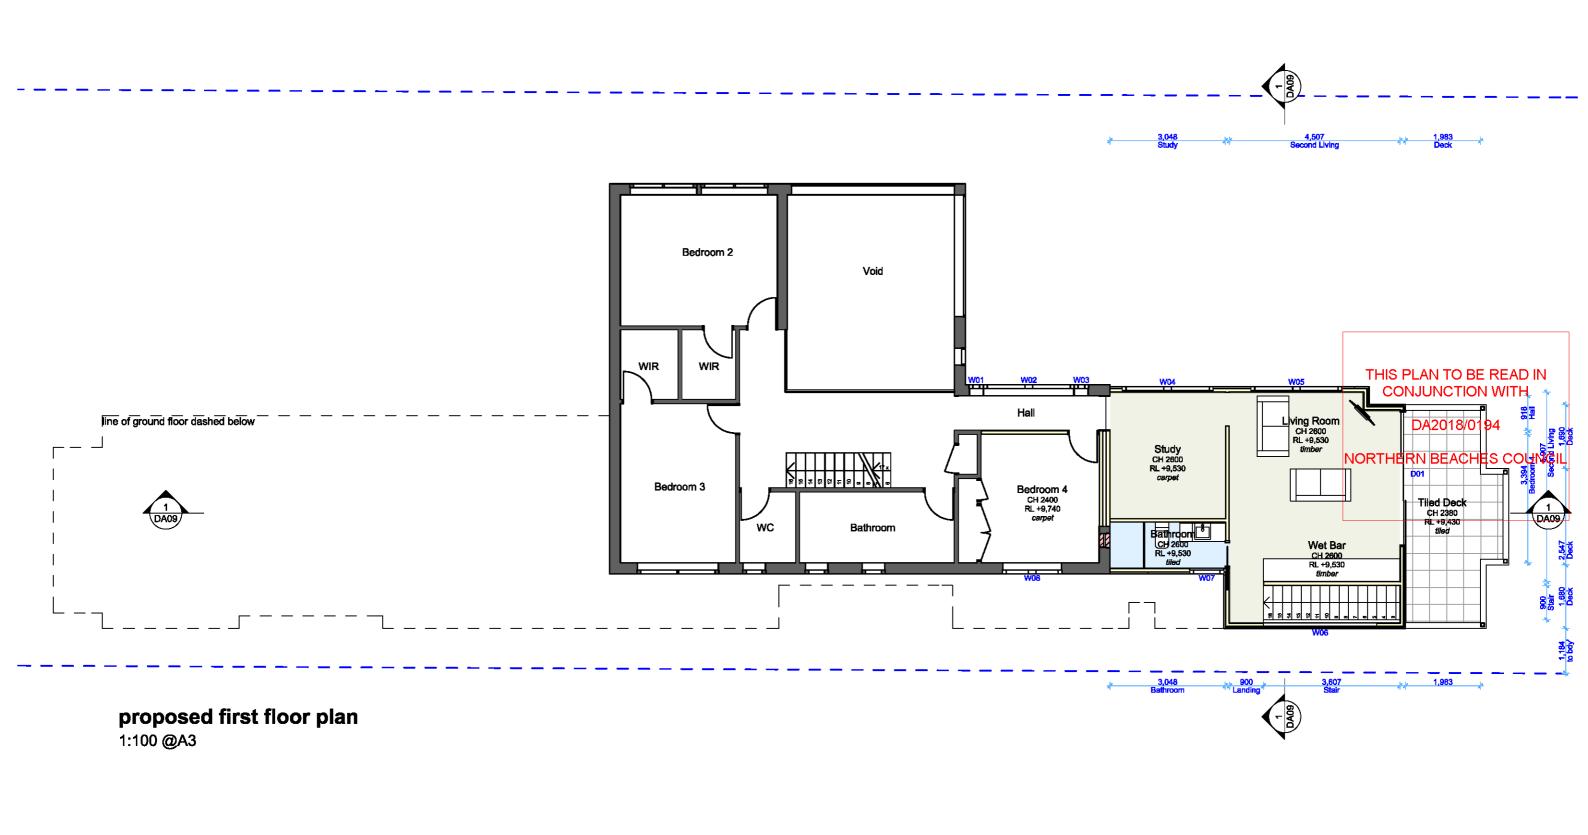



This drawing is the copyright of Action Plans and not be altered, reproduced or transmitted in any form or by any means in part or in whole with the written permission of Action Plans.

All levels and dimensions are to be checked and verified on site prior to commencement of any work, making of shop drawings or fabrication of compnents.

Do no scale on drawings. Use figured dimensions.



CLIENT

Annie Pogson & Wayne

PROJECT ADDRESS 4A Orana Rd, Mona Vale NSW 2103

DRAWING NO.


DA06


DRAWING NAME PROPOSED FIRST FLOOR PLAN


DATE

SCALE 07 September 2017 1:100 @A3



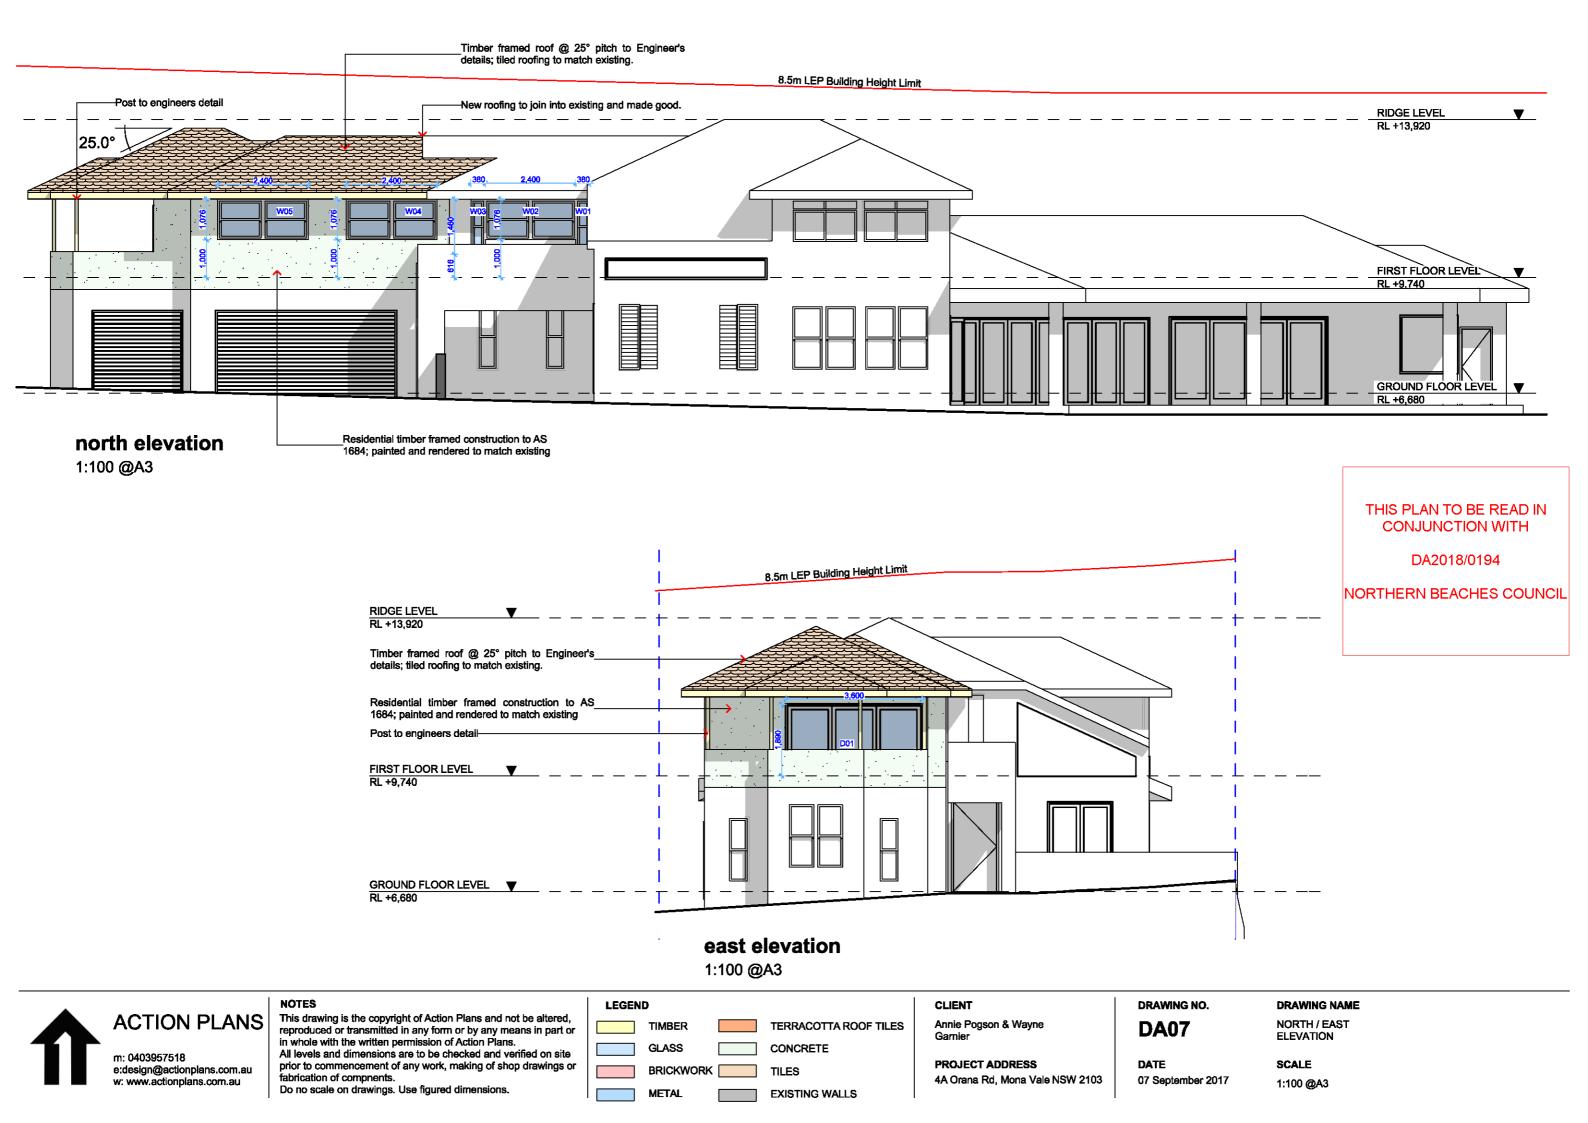

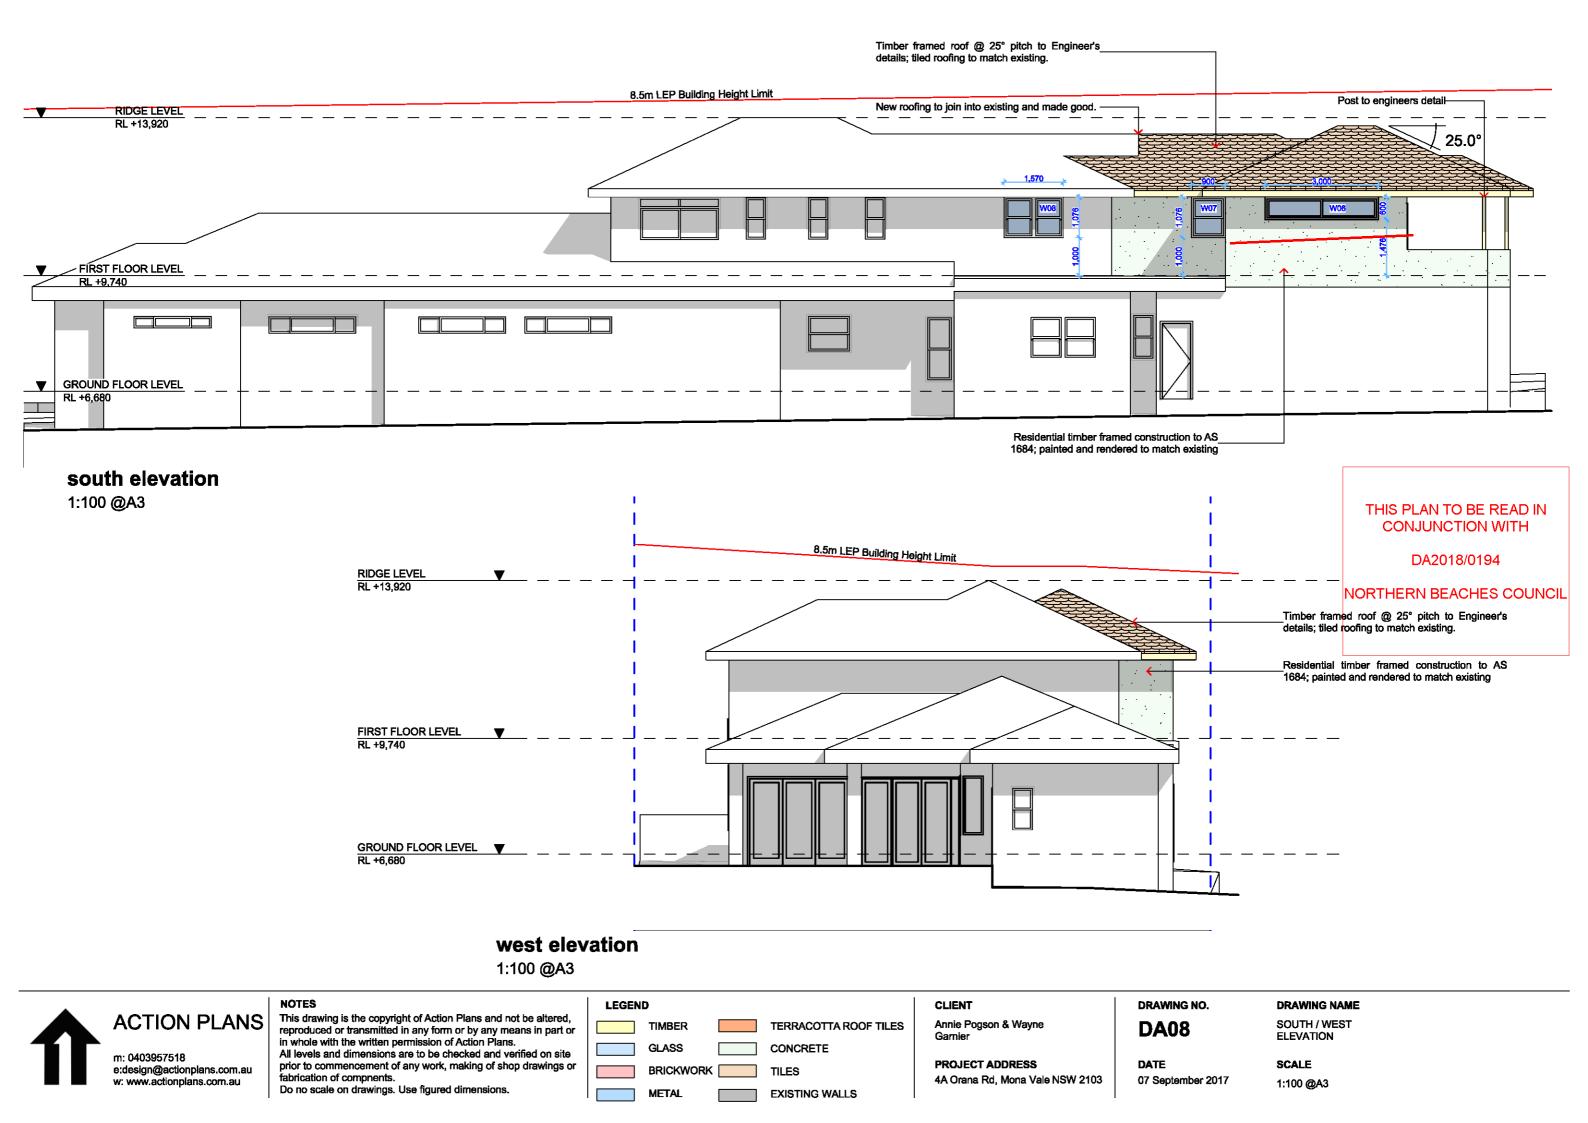

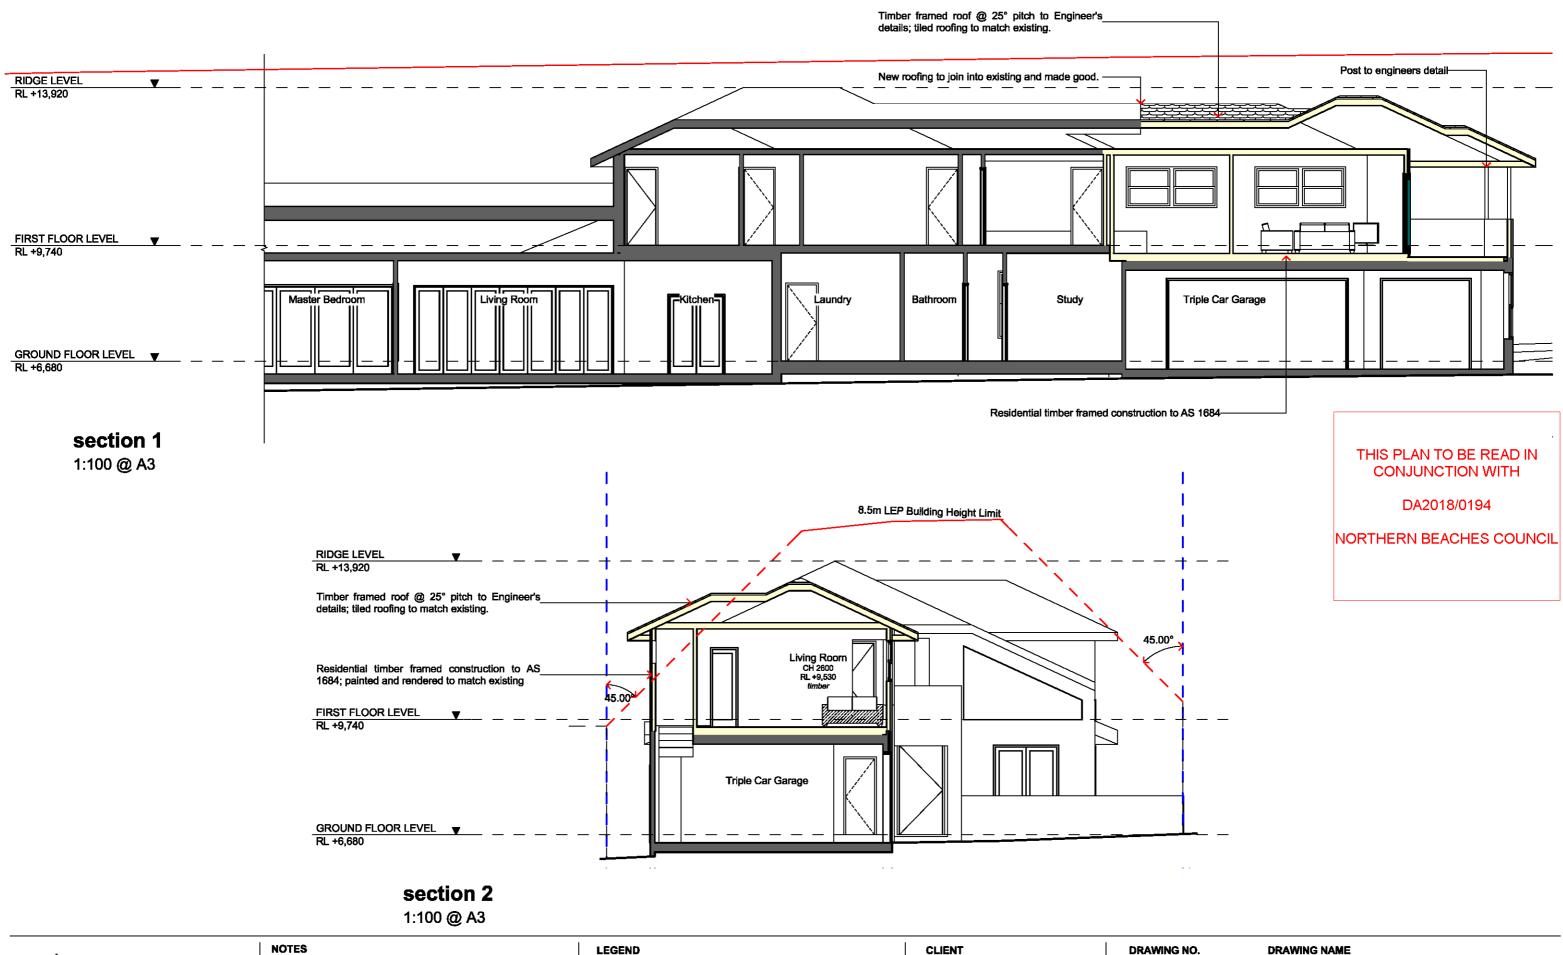

ACTION PLANS

m: 0403957518 e:design@actionplans.com.au w: www.actionplans.com.au

This drawing is the copyright of Action Plans and not be altered, reproduced or transmitted in any form or by any means in part or in whole with the written permission of Action Plans.

All levels and dimensions are to be checked and verified on site prior to commencement of any work, making of shop drawings or fabrication of compnents. Do no scale on drawings. Use figured dimensions.

TIMBER TERRACOTTA ROOF TILES GLASS CONCRETE BRICKWORK **TILES** METAL **EXISTING WALLS**

Annie Pogson & Wayne Garnier

PROJECT ADDRESS 4A Orana Rd, Mona Vale NSW 2103 **DA09**

LONG / CROSS SECTION

DATE 07 September 2017 SCALE

1:100 @A3