

SITE ANALYSIS PLAN

SITE AREA - 794.4m2 LOT 38 B DP 402032

- All structure including stormwater & drainage to engineers details
- Do not obtain dimensions by scaling drawings

 All dimensions are to be checked on site prior to starting work. These drawings are to be read in conjunction with all other consultants
- All workmanship &materials shall be in accordance with the requirements of current editions including amendments of the relevant SAA Codes of Practice, the Building Code of Australia & loements
- New materials are to be used throughout unless otherwise noted Concrete footings, slab, structural beams or any other structural members are to be designed & endorsed by a practising engineer.

JJDrafting

PO Box 687 Dec Why 2009 M - 0414 717 541

Email - jjdraft a tpg com au

PROPOSED ALTERATIONS AND ADDITIONS TO AN EXISTING DWELLING AT


27B MAcDONALD STREET, FRESHWATER


Title: SITE ANALYSIS PLAN

Scale: 1:200 Date: April. 2015

Job No. : 464/15

Dwg No. DA 1

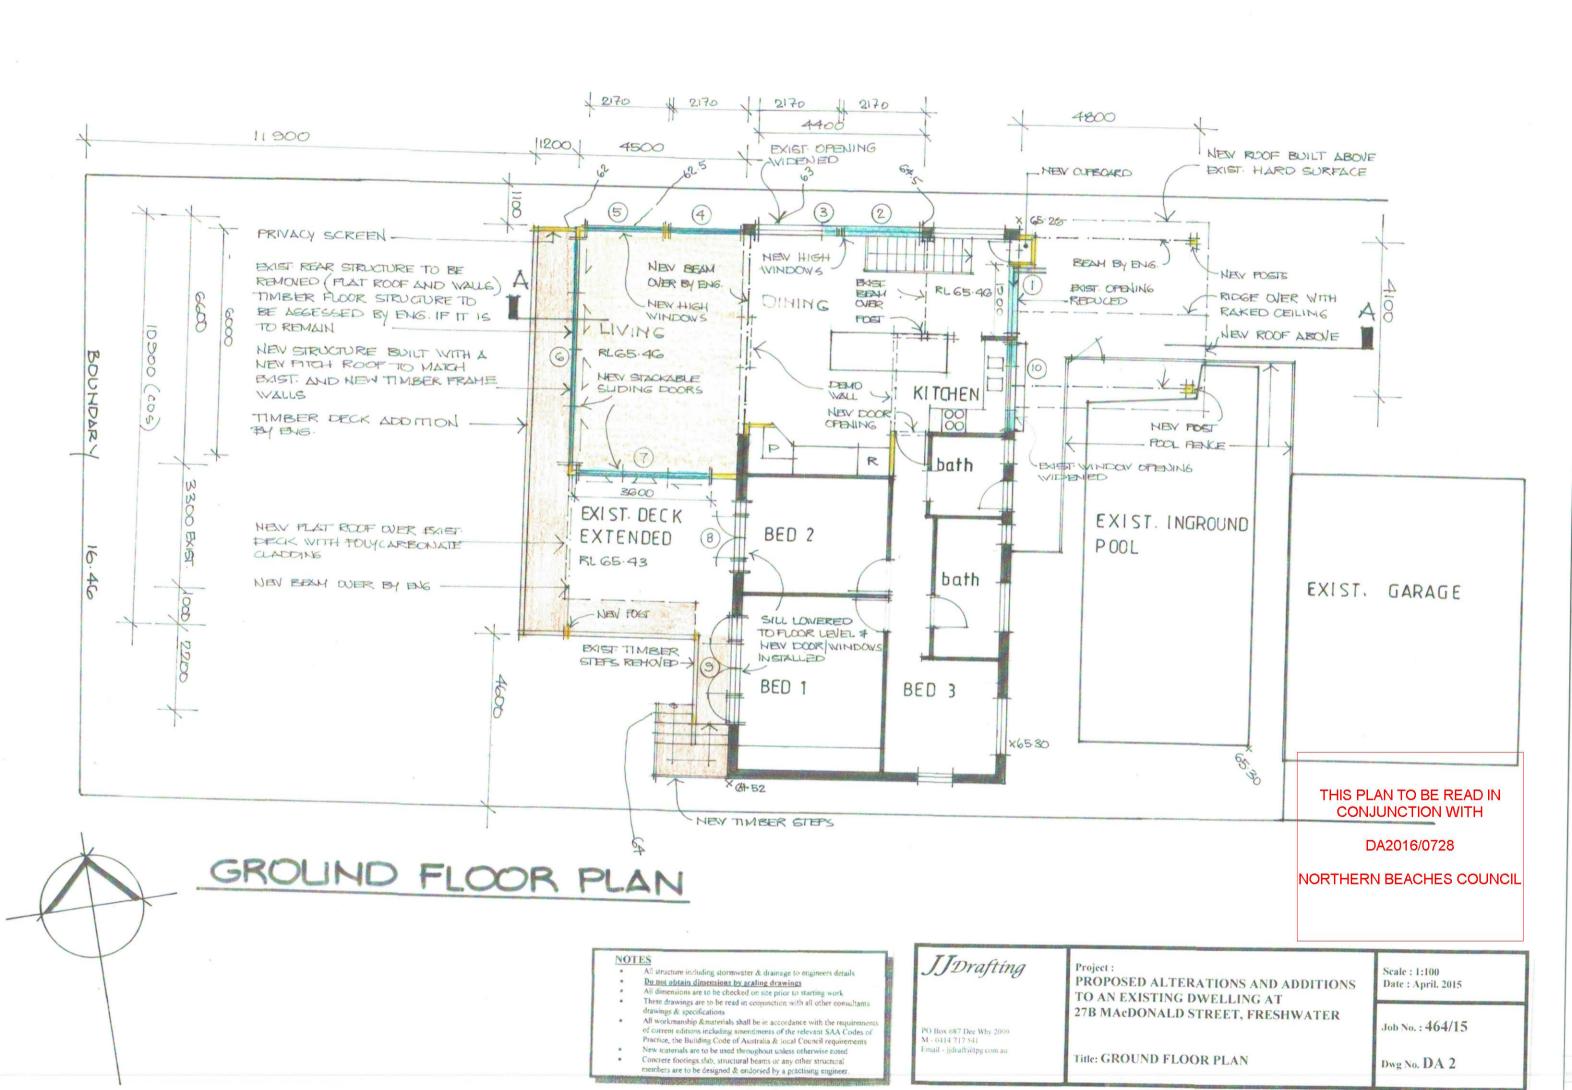

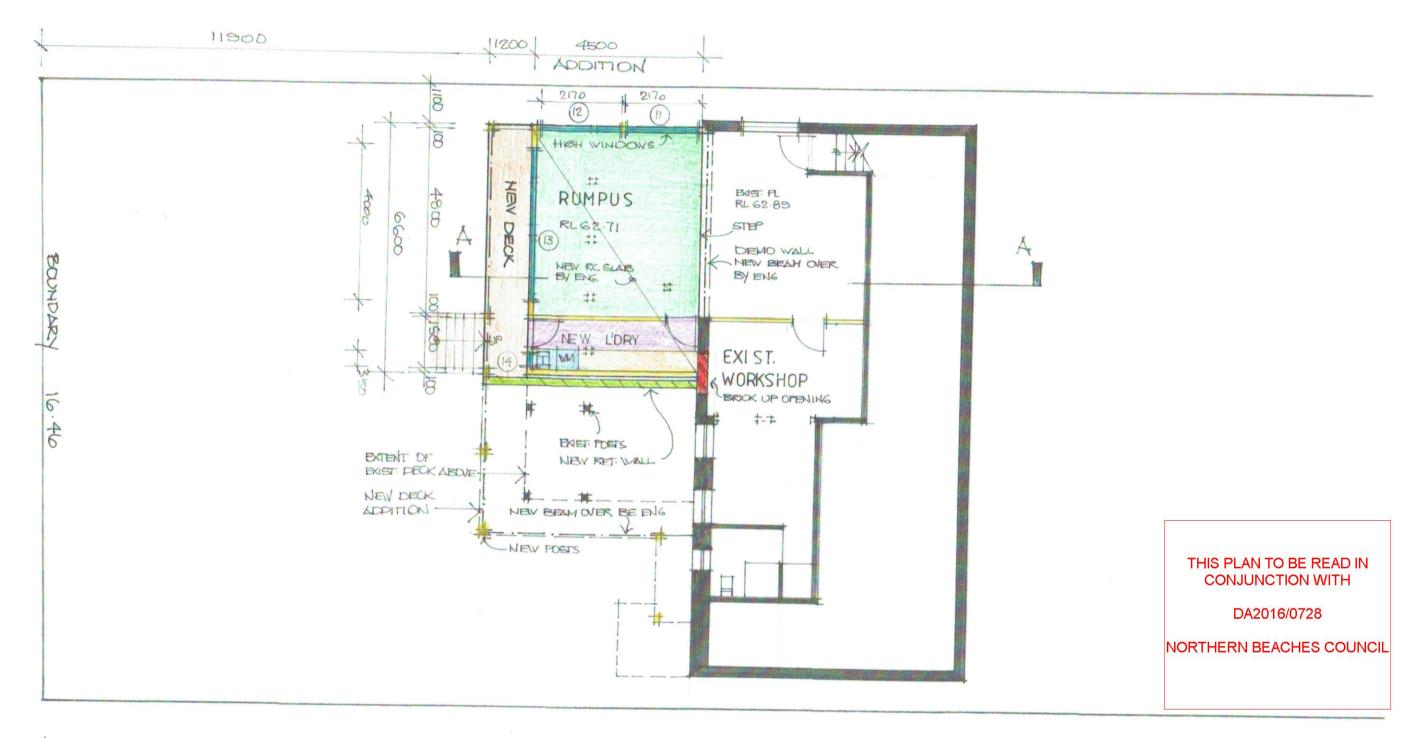



LOWER GROUND FLOOR PLAN

- All structure including stormwater & drainage to engineers details
- Do not obtain dimensions by scaling drawings
 All dimensions are to be checked on site prior to starting work.
- These drawings are to be read in conjunction with all other consultants drawings & specifications
- All workmanship &materials shall be in accordance with the requirement of current editions including amendments of the relevant SAA Codes of Practice, the Building Code of Australia & loements
- New materials are to be used throughout unless otherwise noted Concrete footings, slab, structural beams or any other structural members are to be designed & endorsed by a practising engine

IIDrafting

PROPOSED ALTERATIONS AND ADDITIONS TO AN EXISTING DWELLING AT 27B MACDONALD STREET, FRESHWATER


PO Box 687 Dee Why 2009 M - 0414 717 541 Email - jjdraft@tpg.com.au


Scale: 1:100 Date: April. 2015


Job No.: 464/15

Dwg No. DA 3

Title: LOWER GROUND FLOOR PLAN

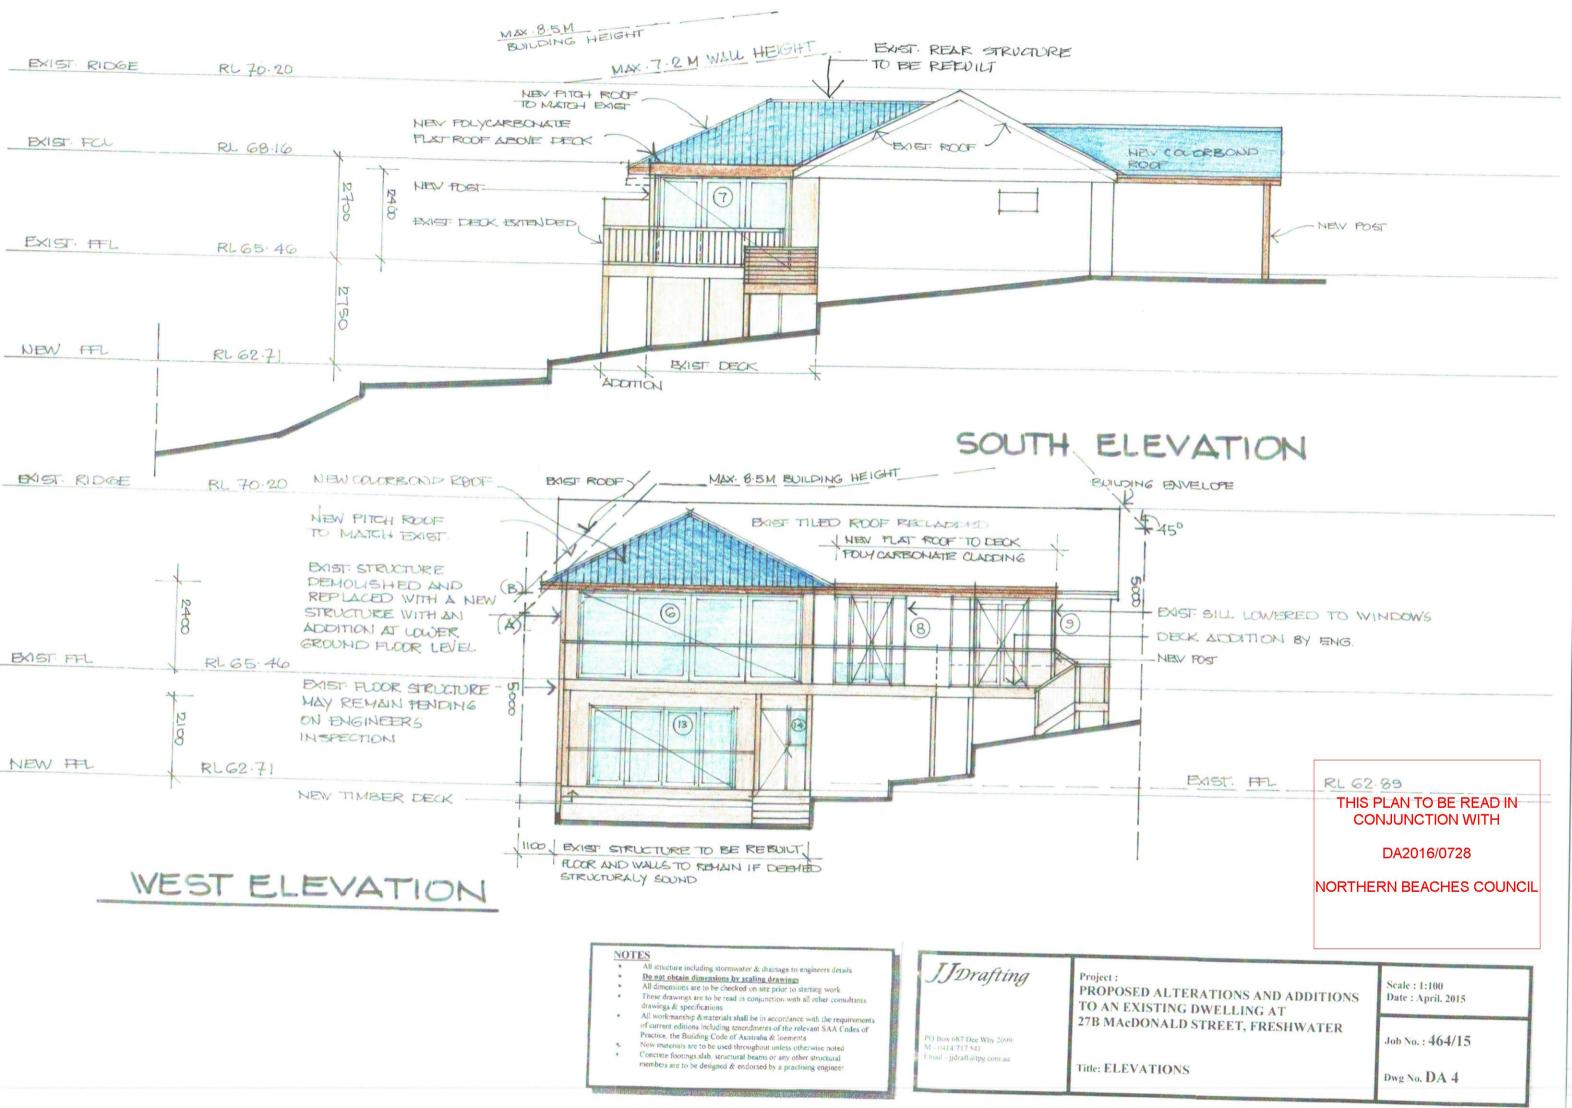

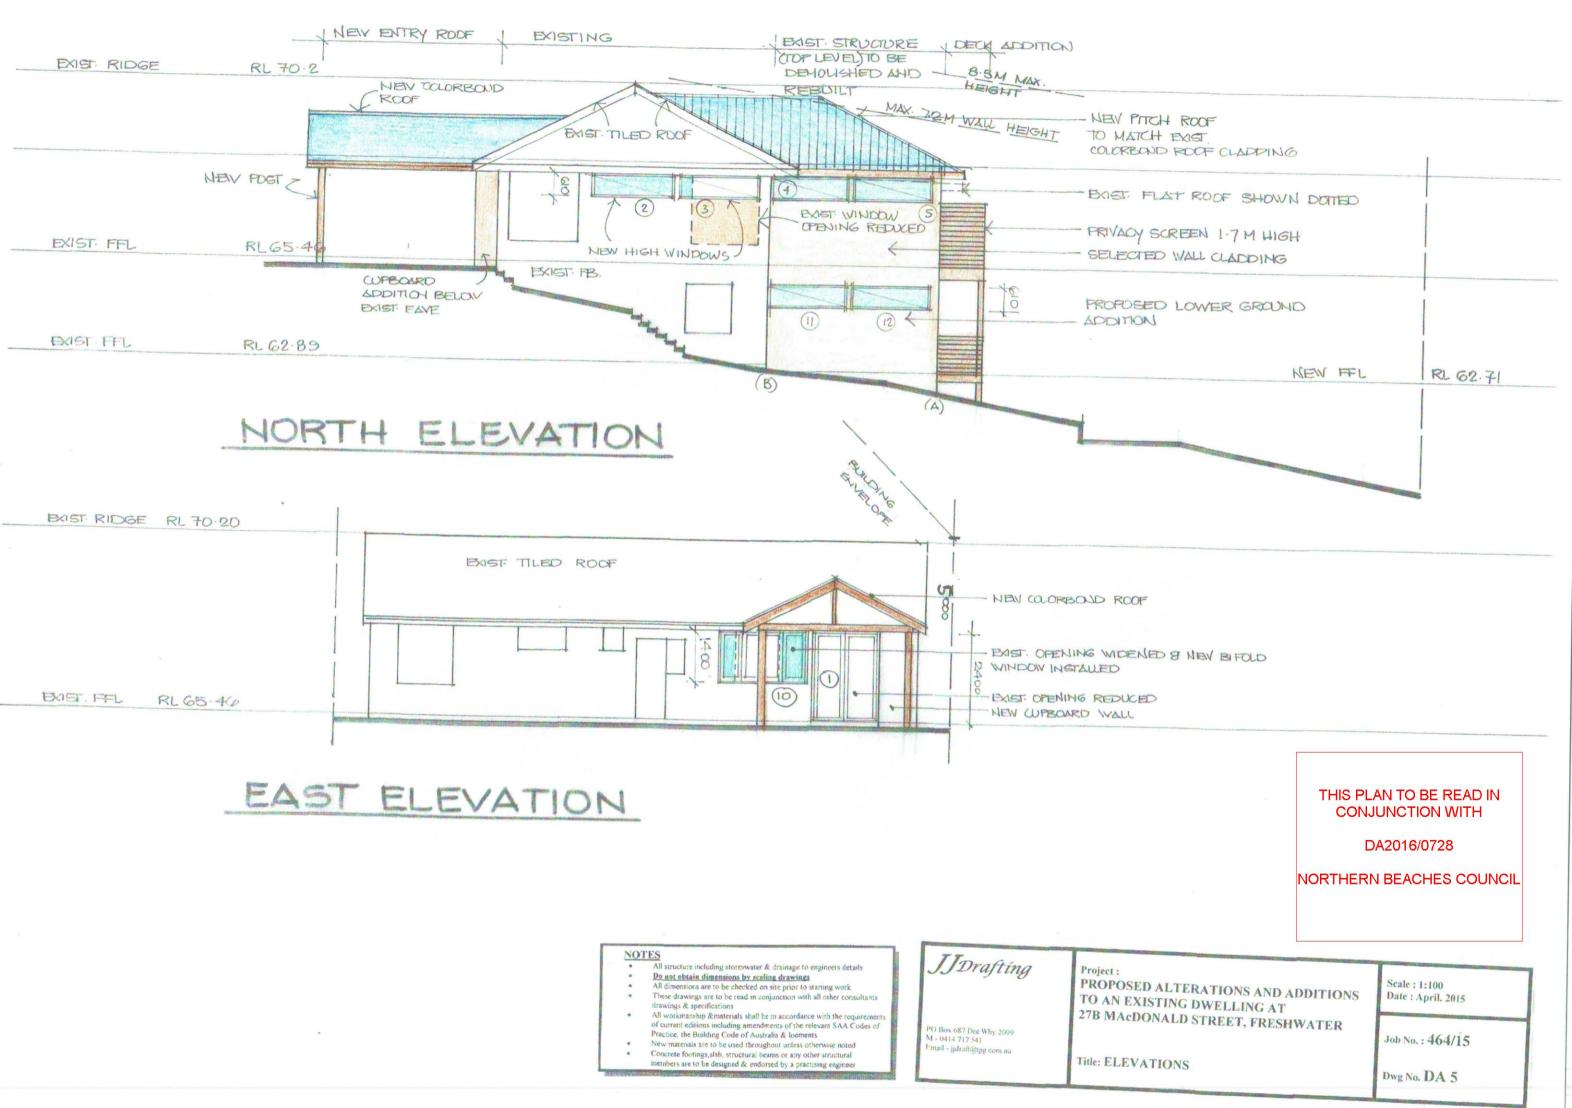

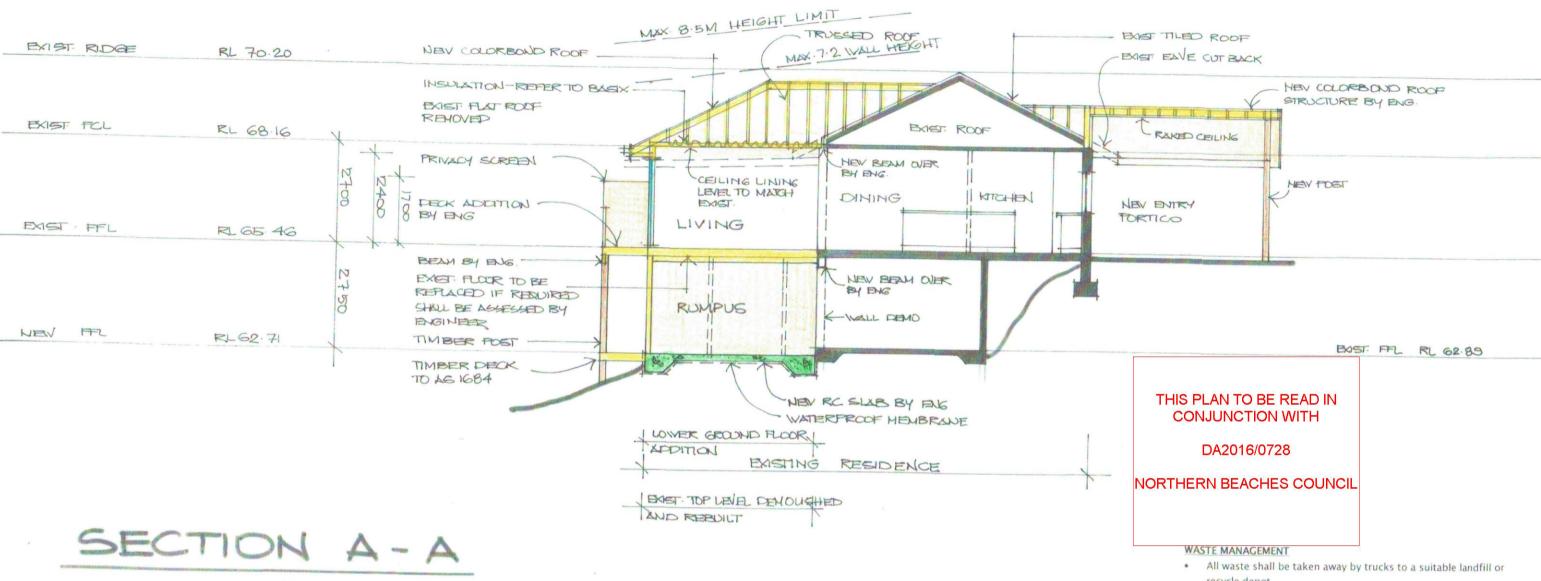

SPECIFICATION NOTES

EXTERNAL WALLS

 Light frame walls finished off with selected cladding DOORS AND WINDOWS

- Aluminium frame windows & doors
- Weather stripping is to be provided to all external windows & doors. **FLOORS**
- Timber floor framing finished off with selected floor finish to living
- Concrete slab to rumpus room on lower ground floor
- Tiles on waterproof membrane to laundry

BALUSTRADE

1000mm high balustrade to BCA

STORMWATER

- New downpipes to be connected into new absorption trench LAUNDRY
- All waterproofing to AS 3740
- Provide a guaranteed flexible waterproof membrane to all wet area floors &shower walls to manufacturers instructions
- · Provide fibre cement sheeting to laundry

DECK

- Timber decking with rounded edge & 3mm gap
- Tiled roof cladding to match existing

GUTTERS AND DOWNPIPES

- Colorbond gutters and downpipes to match existing
- Minimum slope of eaves and gutters 1:200

FLASHING AND CAPPINGS

- Selection and installation of metal rainwater goods refer to AS 2180
- Flash projections above the roof with two part flashings consisting of an apron flashing & over flashing, with at least 100mm overlap. Provide for independent movement between roof and projection.

TERMITE CONTROL

To AS 3660.1

TIMBER FRAMING

- · Use treated timber where required for durability
- Do not use timber unsuitable for exposure to moisture in exposed
- · All workmanship & materials shall be in accordance with AS 1684 and 1720 as applicable
- Provide structure bracing in accordance with AS 1684
- Provide structure tie down in accordance with AS 1684 use galvanised fixings where exposed to weather.

CONCRETE

- · All workmanship &materials shall be in accordance with current editions of the AS 3600
- Footings to be in accordance with AS 1480
- All reinforcement shall conform to AS 1302, AS 1303 & AS 1304

INTERNAL LININGS

Provide plasterboard linin

SMOKE ALARMS

 Connect to consumer mains power & install to AS 1670.6. 1997 (Fire detection, warning control and intercom systems- systems design, installation and commissioning- Smoke Alarms) and AS 3786-1996 (Smoke Alarms)

- recycle depot.
- All waste shall be covered during transportation.
- Waste generated during construction shall be placed in steel bins & taken away by an approved contractor to an approved land fill site.

SEDIMENT CONTROL

· A filter cloth system shall be installed to stop any sediment entering councils stormwater system

THESE DRAWINGS ARE TO BE READ IN CONJUNCTION WITH THE BASIX REPORT

BASIX COMMITMENTS FOR MAIN RESIDENCE

WATER

TAP RATING - Minimum 3 STAR

INSULATION REQUIREMENTS

- External wall framed (weatherboard, fibre cement, metal clad)
 - 1.30 (or 1.70 including construction)
- · Flat ceiling, pitched roof: framed
 - Ceiling R2.50 (up), Roof-foil/sarking
- Floor above existing dwelling nil
- Concrete slab on ground nil

LIGHTING REQUIREMENTS

40% of new or altered light fixtures to be fitted with fluorescent, compact fluorescent, or light-emitting-diode(LED) lamps

- cture including stormwater & drainage to engineers details
- Do not obtain dimensions by scaling drawings
- All dimensions are to be checked on site prior to starting work.

 These drawings are to be read in conjunction with all other consultants drawings & specifications
- All workmanship &materials shall be in accordance with the requirement of current editions including amendments of the relevant SAA Codes of Practice, the Building Code of Australia & Joements
- Concrete footings, slab, structural beams or any other structural members are to be designed & endorsed by a practising engineer
- PO Box 687 Dee Why 2009 M 0414 717 541 New materials are to be used throughout unless otherwise noted Email - jjdraft a tpg com au

JJDrafting

PROPOSED ALTERATIONS AND ADDITIONS TO AN EXISTING DWELLING AT

27B MACDONALD STREET, FRESHWATER

Job No. : 464/15

Scale: 1:100

Date: April. 2015

Title: SECTION

Dwg No. DA 6