



GARAGE ADDITIONS AND ALTERATION WORKS 112 ILUKA ROAD, PALM BEACH NSW 2108

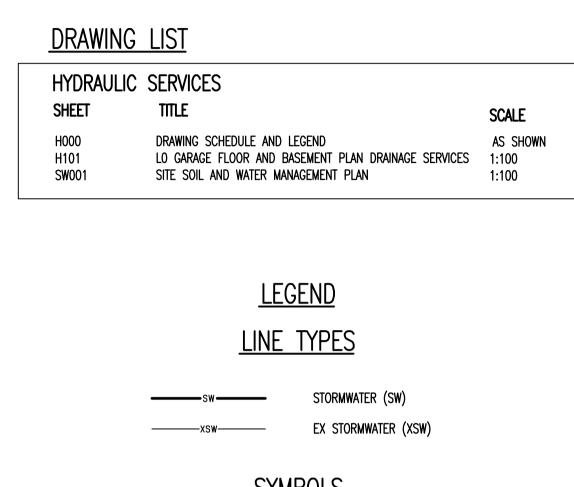

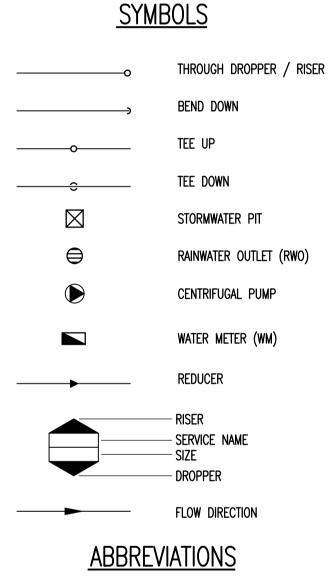


DOWNPIPE

INVERT LEVEL

PLANTER DRAIN


POLYVINYL CHLORIDE

EXISTING

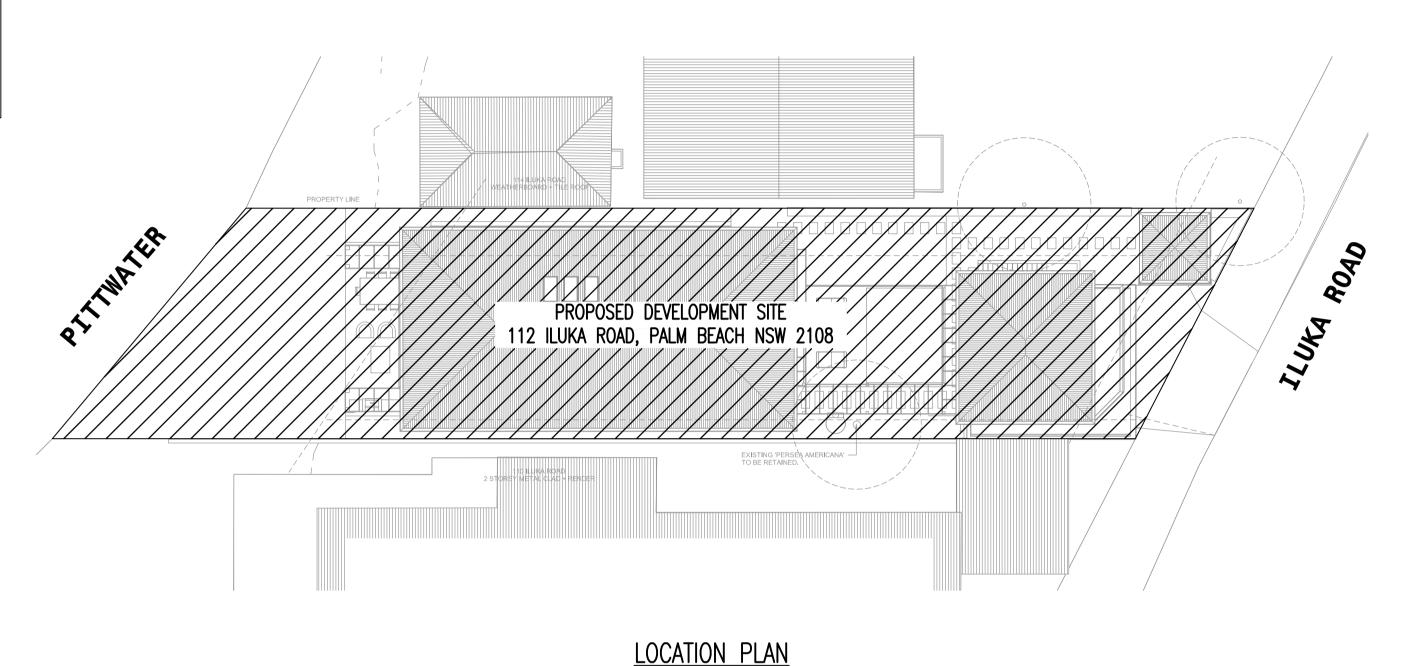


SCALE 1:200

- 1 ALL WORKS TO BE INSTALLED IN ACCORDANCE WITH LOCAL COUNCIL REQUIREMENTS.
- AS3500 NATIONAL PLUMBING & DRAINAGE CODE. 2 THE CONTRACTOR IS TO CONFIRM LOCATION & DEPTH OF EXISTING SERVICES ON SITE PRIOR TO
- CONSTRUCTION. IF ANY CONFLICT EXISTS NOTIFY BUILDER IMMEDIATELY. 3 THE CONTRACTOR IS TO CONFIRM EXISTING & PROPOSED SURFACE LEVELS PRIOR TO
- INSTALLATION OF PIPEWORK, SUMPS, MANHOLES, PITS, ETC. 4 BACKFILLING
- BACKFILL SERVICE TRENCHES AS SOON AS POSSIBLE AFTER SERVICE HAS BEEN LAID AND BEDDED. PLACE THE BACKFILL IN LAYERS <150mm THICK AND COMPACT TO THE DENSITY WHICH APPLIES TO THE LOCATION OF THE TRENCHES TO MINIMISE SETTLEMENT.
- 5 BACKFILL MATERIAL GENERAL FILL WITH NO STONES GREATER THAN 25mm OCCURING WITHIN 150mm OF THE SERVICE
- UNDER ROADS AND PAVED AREAS AND WITHIN 4 METRES OF BUILDING: COARSE SAND, CONTROLLED LOW STRENGTH MATERIAL OR FINE CRUSHED ROCK.
- 6 ON COMPLETION OF PIPE INSTALLATION, ALL DISTURBED AREAS MUST BE RESTORED TO ORIGINAL CONDITION
- INCLUDING: KERBS, FOOTPATHS, CONCRETE AREAS, GRAVEL AREAS & ROAD PAVEMENTS.
- 7 CARE SHALL BE TAKEN WHEN EXCAVATING NEAR EXISTING SERVICES. EXCAVATE BY HAND IN THESE AREAS.
- 8 THE PLUMBING CONTRACTOR SHALL OBTAIN ALL AUTHORITY APPROVALS AND PAY ALL FEES. 9 INVERT LEVELS SHOWN ARE INDICATIVE ONLY. CONFIRM ALL LEVELS ON SITE BEFORE COMMENCING CONSTRUCTION.

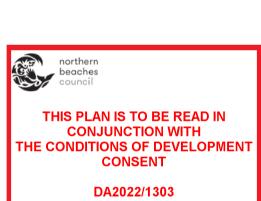



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ARCHITECT :

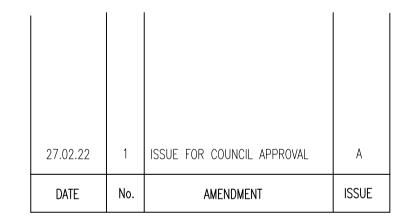WALTER BARDA DESIGN

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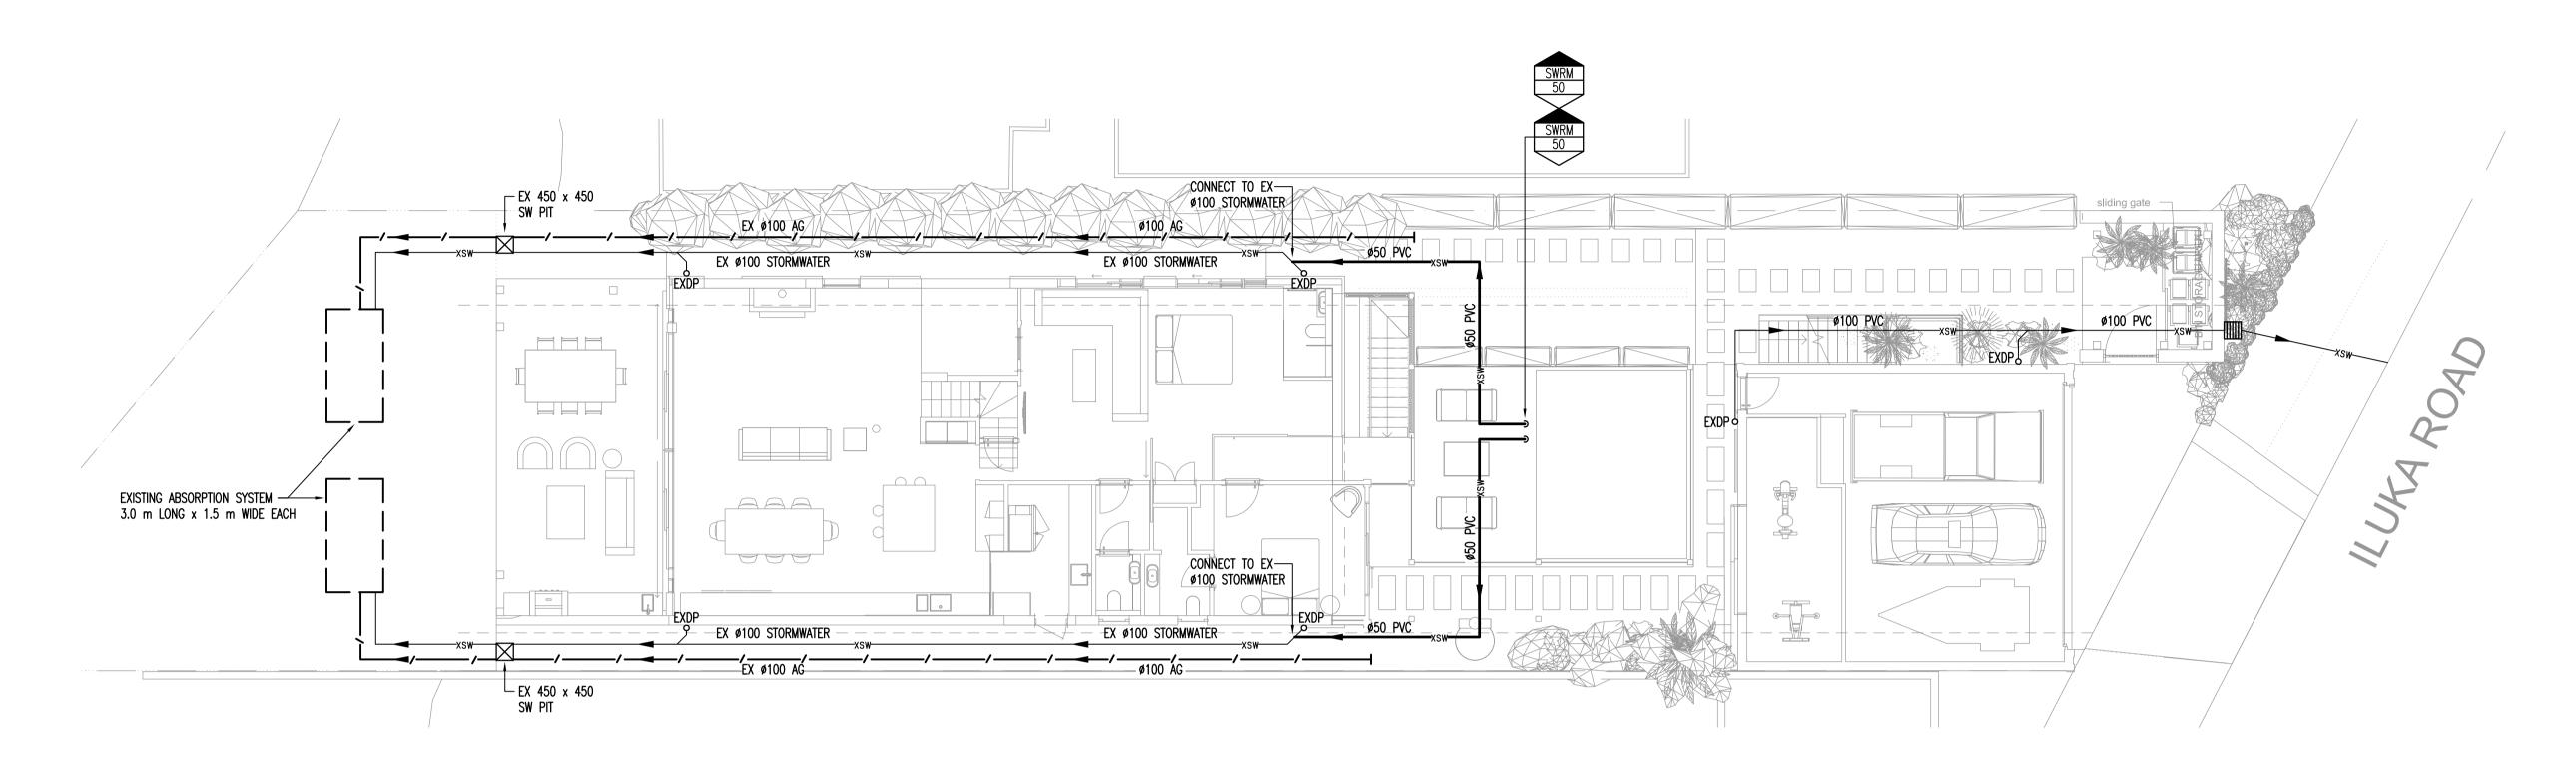
P: 02 9310 1352

DRAWING SCHEDULE AND LEGEND

HYDRAULIC SERVICES

Drawn : JULY 22 Checked AS SHOWN @ A1 Cad File No. : Drawing No. : 223626 223626H000






<u>LO GARAGE FLOOR PLAN – DRAINAGE SERVICES</u>

SCALE 1:100



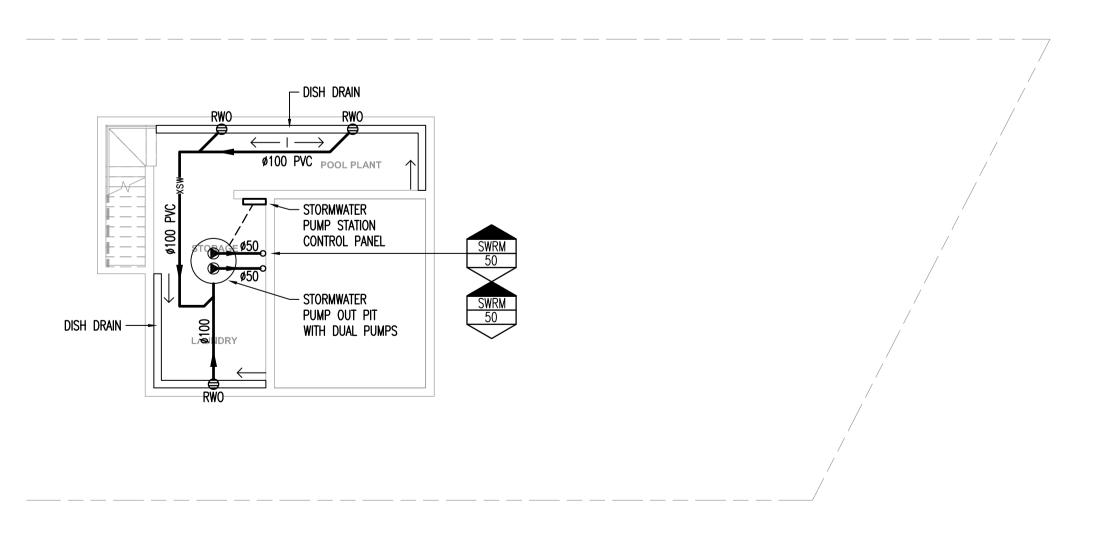

BASEMENT PLAN — DRAINAGE SERVICES

SCALE 1:100

DEVELOPMENT APPLICATION / CONCEPT DESIGN DOCUMENTATION

= DOCUMENTATION :

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DATE	No.	AMENDMENT	ISSUE
27.02.22	1	ISSUE FOR COUNCIL APPROVAL	A
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ARCHITECT :

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PROJECT :

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TITLE : HYDRAULIC SERVICES

LO GARAGE FLOOR AND BASEMENT PLAN DRAINAGE SERVICES

Scales : 1:100	Checked A1	d: GH
Job No. :	Cad File No. :	Drawing No. :
223626	223626H101	H101



<u>LEGEND</u>

STABILISED CONSTRUCTION ENTRANCE

—— c ——

DISTURBED AREA CATCHMENT AREA PROCEDURE FOR SILTATION CONTROL DURING CONSTRUCTION

1. CONSTRUCT SILT TRAP FENCE WHERE INDICATED ON PLAN. CONSTRUCT STABILIZED CONSTRUCTION ENTRANCES. CONSTRUCT SEDIMENT CATCHMENT BASIN.

2. COMMENCE CONSTRUCTION PROVIDING DRAINAGE FROM TRENCH EXCAVATION TO SEDIMENT CATCHMENT BASIN.


3. SHOULD S.C.B. FILL TO WITHIN 60% OF CAPACITY, REMOVE SILT FROM SITE TO APPROVED DISPOSAL SITE.

4. CARRY OUT DAILY SITE INSPECTION OF SILT FENCES FOR STRUCTURAL DAMAGE.


5. PROVIDE SITE WATERING SHOULD WIND EROSION OCCUR. 6. REMOVE SILT FENCES AFTER LANDSCAPE IS COMPLETED & LAWN IS FULLY ESTABLISHED.

SEDIMENT CONTROL

- 1. ALL PRECAUTIONS SHALL BE TAKEN BY THE CONTRACTOR TO PREVENT THE TRANSPORTATION OF MATERIAL FROM THE AREA OF THE WORKS BY WINDS, STORMWATERS OR ARTIFICIAL MEANS.
- 2. THE SITE SHALL BE WATERED IN DRY PERIODS & SHOULD CLEARED AREAS BECOME BARREN. THEY SHALL BE SEEDED & WATERED TO PROMOTE VEGETATION COVER OF GRASS.
- 3. THE SEDIMENT CONTROL FABRIC OF FENCES INDICATED ON THE DRAWING SHALL BE TAKEN AS A MINIMUM PROTECTION MEASURE ONLY. EXTRA CONTROLS SHALL BE EDTABLISHED TO PROVIDE AN EFFECTIVE PROTECTION.
- 4. SUPPORT MEASURES SUCH AS HAY BALES SHALL BE USED IN AREAS OF STEEP SLOPES OR WHERE STREAM FLOW MAY OCCUR.

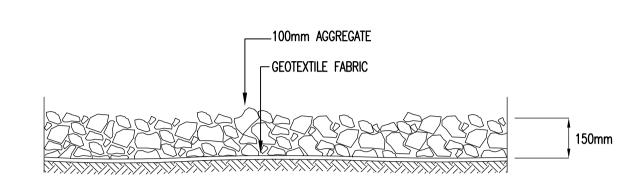

STABILISED CONSTRUCTION ENTRANCE N.T.S.

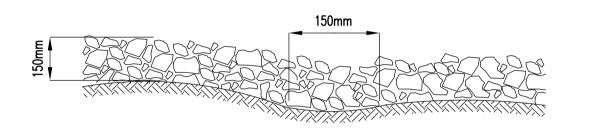


SECTION A-A


THIS PLAN IS TO BE READ IN **CONJUNCTION WITH** THE CONDITIONS OF DEVELOPMENT CONSENT DA2022/1303



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SITE SOIL AND WATER MANAGEMENT PLAN SCALE 1:100

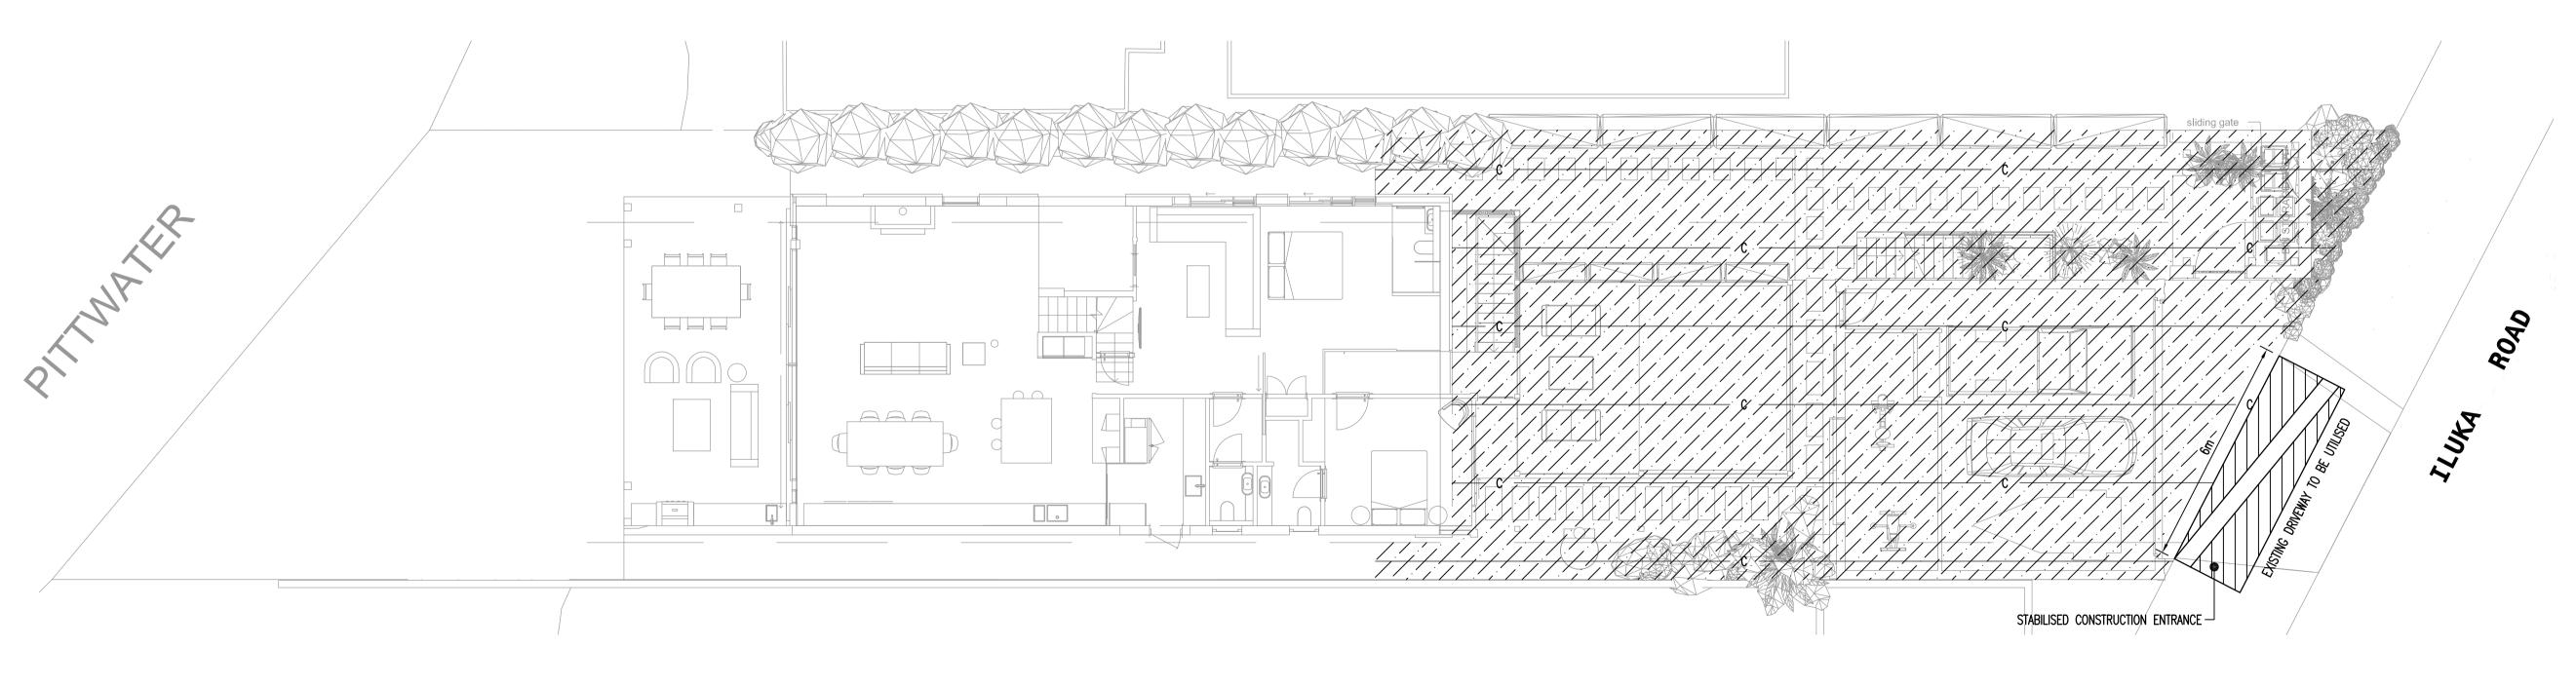

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HYDRAULIC SERVICES SITE SOIL AND WATER MANAGEMENT PLAN

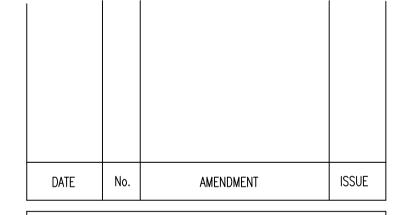Date : Drawn : JULY 22 Scales : Checked: GH 1:100 @ A1 Job No. Drawing No. : 223626 SW001

223626H000