199-205 PITTWATER ROAD, MANLY



DRAWING LIST

DRAWING NO.	TITLE	SCALE		REV
DA-000	COVER PAGE		@A3	03
DA-001	SURVEY	1:200	@A3	01
DA-002	SITE ANALYSIS	1:200	@A3	01
DA-003	SITE PLAN	1:200	@A3	02
DA-004	DEMOLITION PLAN - GROUND FLOOR	1:100	@A3	01
DA-005	DEMOLITION PLAN - LEVEL 1	1:100	@A3	01
DA-006	SEDIMENT & EROSION CONTROL PLAN	1:100	@A3	01
DA-010	BASIX	1:2	@A3	01
DA-101	GROUND FLOOR PLAN	1:100	@A3	03
DA-102	FIRST FLOOR PLAN	1:100	@A3	03
DA-103	ROOF PLAN	1:100	@A3	02
DA-104	LANDSCAPE PLAN	1:150	@A3	02
DA-151	SHADOW PLANS	1:500	@A3	03
DA-201	ELEVATIONS - SHEET 1	1:100	@A3	03
DA-202	ELEVATIONS - SHEET 2	1:100	@A3	02
DA-203	ELEVATIONS - SHEET 3	1:100	@A3	03
DA-204	ELEVATIONS - SHEET 4	1:100	@A3	03
DA-205	SIGNAGE	1:50		01
DA-301	SECTIONS - SHEET 1	1:100	@A3	01
DA-302	SECTIONS - SHEET 2	1:100	@A3	01
DA-400	AREA SCHEDULES		@A3	02
DA-900	EXISTING EXTERIOR VIEW		@A3	01
DA-901	INDICATIVE EXTERIOR VIEW		@A3	01
DA-902	INDICATIVE COURTYARD VIEW		@A3	01
DA-904	MATERIALS & FINISHES		@A3	01

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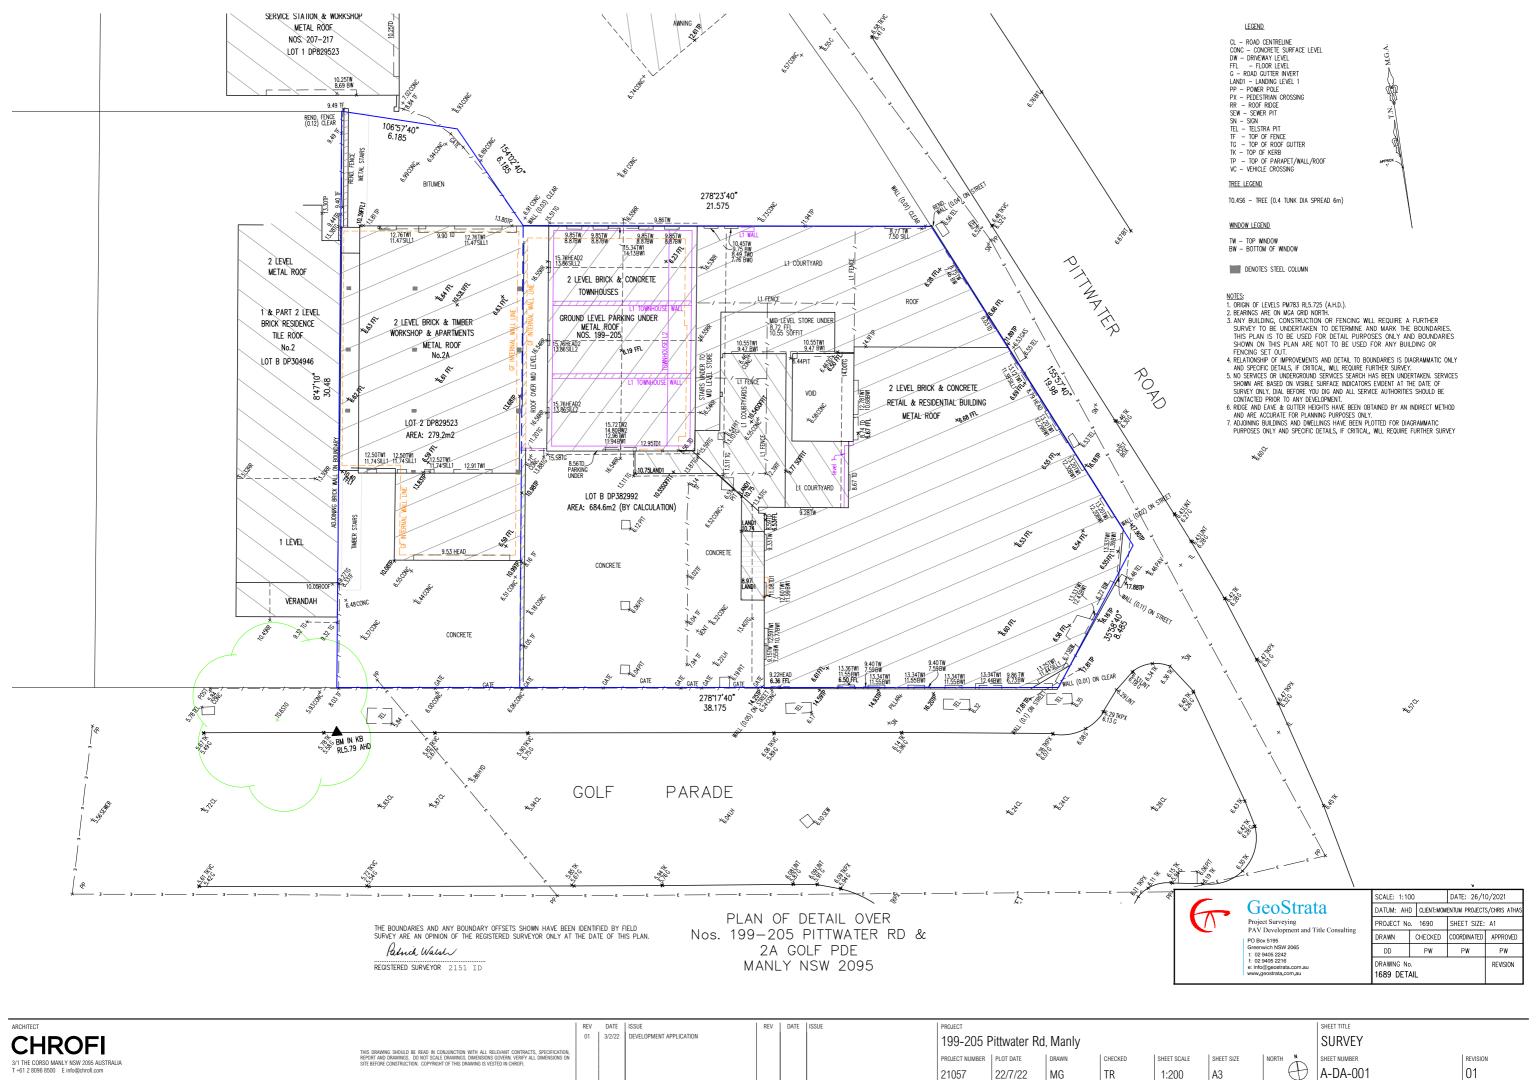
CHROFI 3/1 THE CORSO MANLY NSW 2095 AUSTRALIA T +61 2 8096 8500 E info@chrofi.com 199-205 Pittwater Rd, Manly

22/7/22 MG 21057

SHEET SIZE SHEET SCALE A3

SHEET NUMBER A-DA-000


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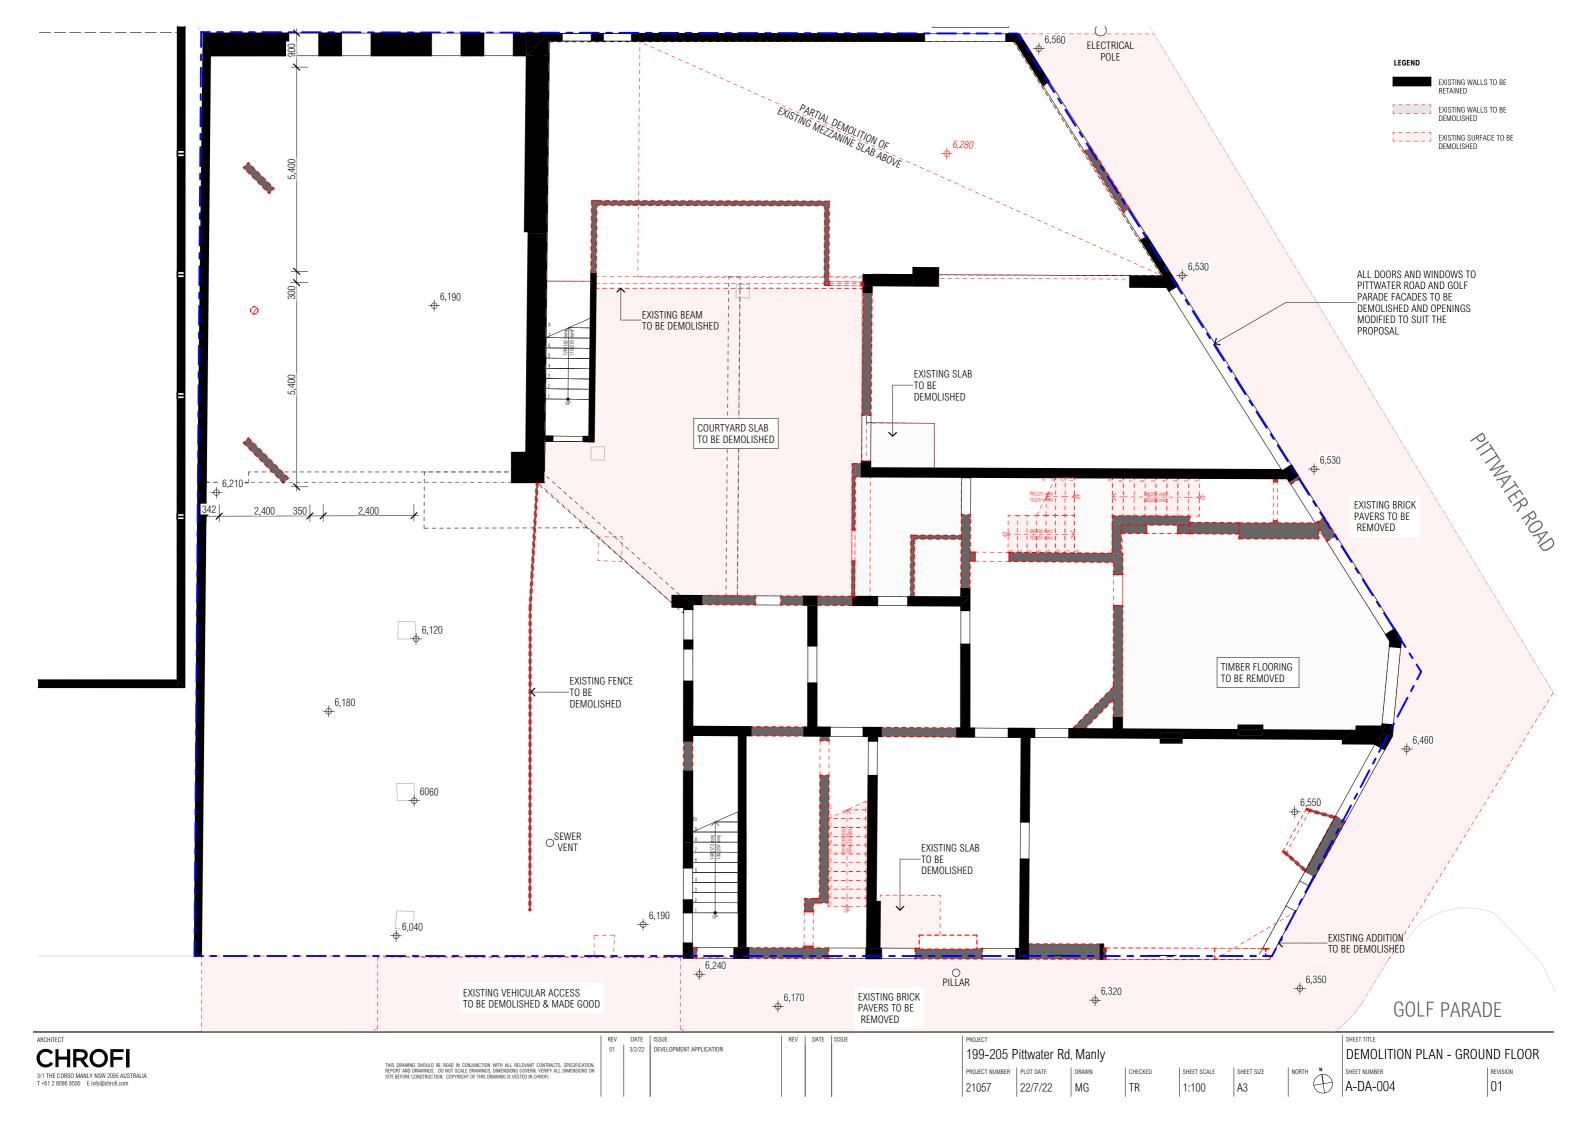
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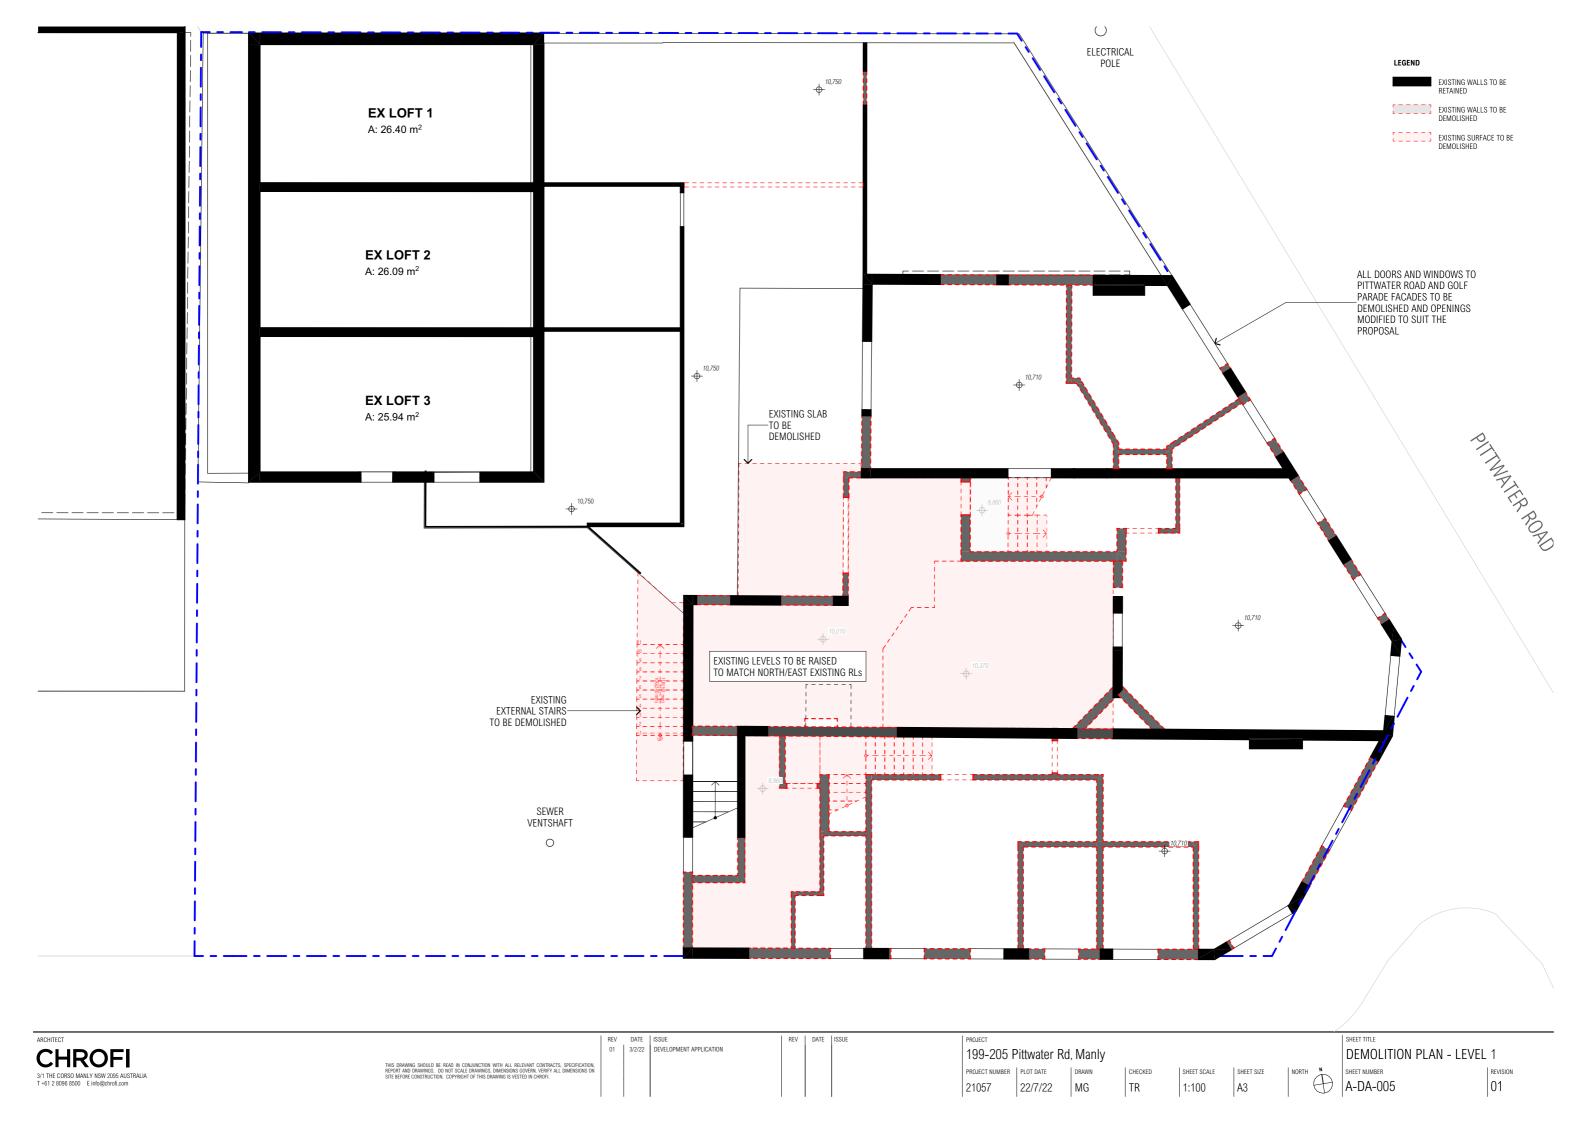
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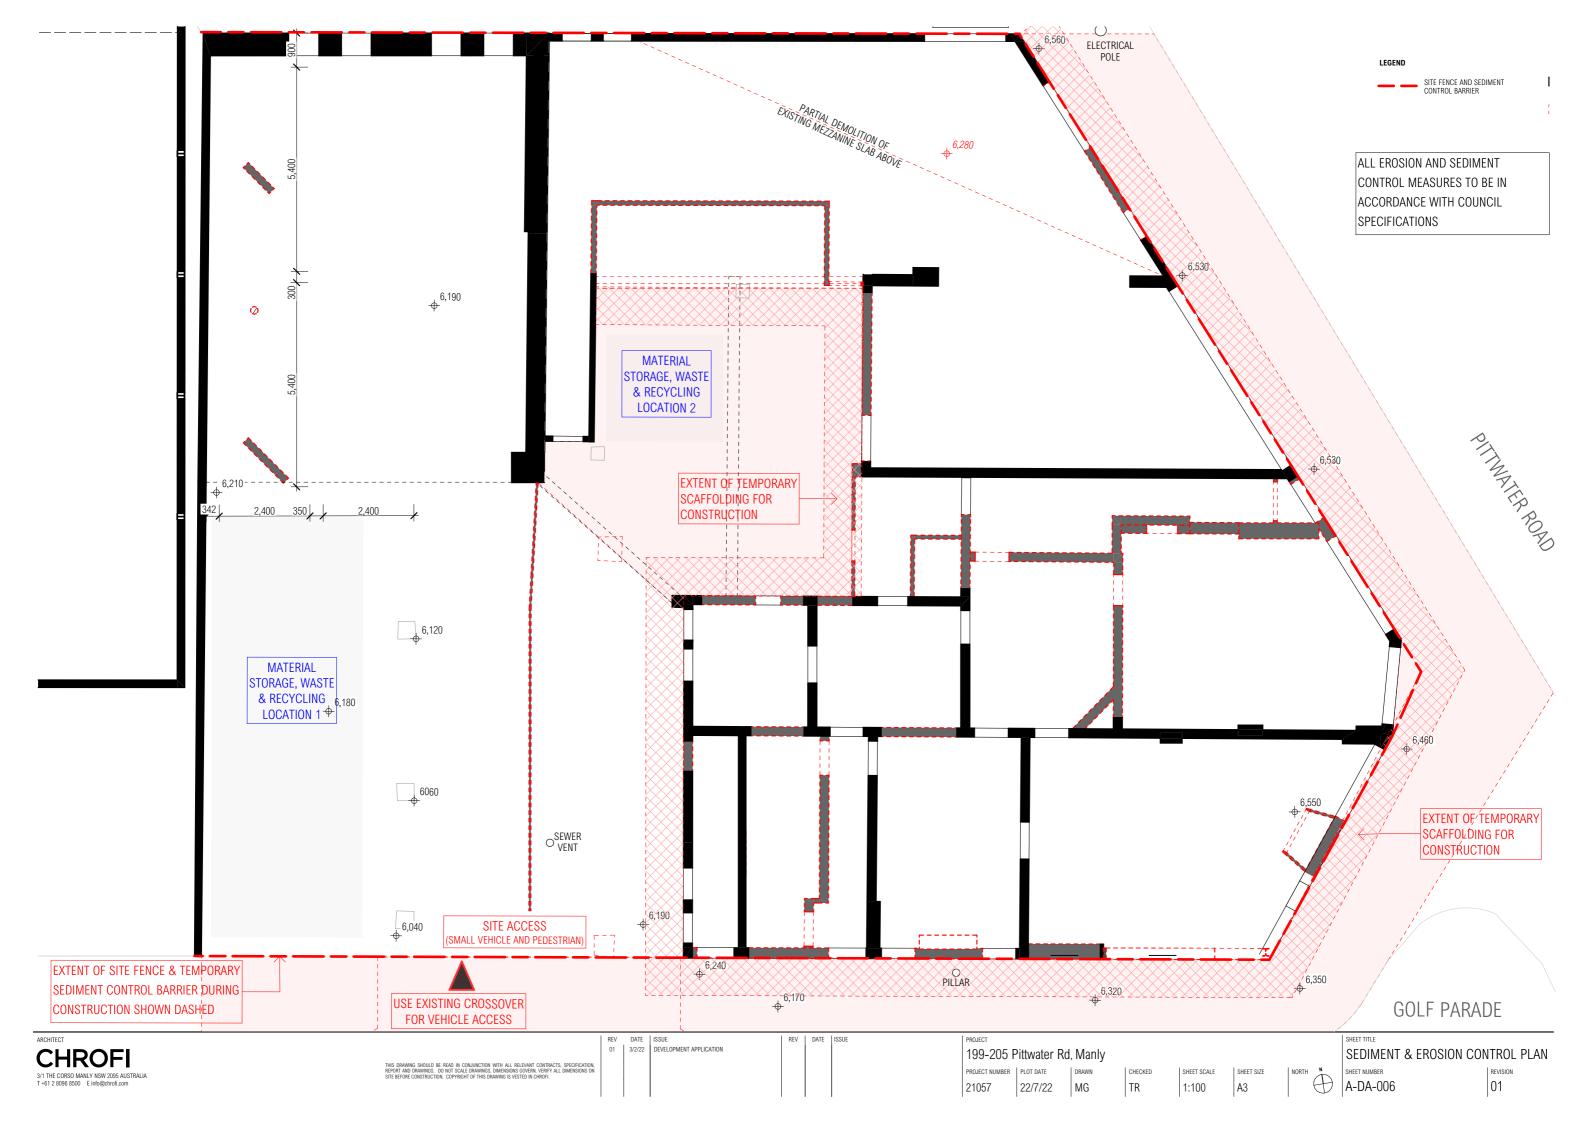
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Schedule of BASIX commitments

The commitments set out below regulate how the proposed development is to be carried out. It is a condition of any development consent granted, or complying development certificate issued, for the proposed development, that BASIX commitments be complied with.

1. Commitments for Residential flat buildings - Building1

(a) Dwellings

(i) Water	Show on DA plans	Show on CC/CDC plans & specs	Certifier check
(a) The applicant must comply with the commitments listed below in carrying out the development of a dwelling listed in a table below.			
(b) The applicant must plant indigenous or low water use species of vegetation throughout the area of land specified for the dwelling in the "Indigenous species" column of the table below, as private landscaping for that dwelling. (This area of indigenous vegetation is to be contained within the "Area of garden and lawn" for the dwelling specified in the "Description of Proit Table).	~	~	
(c) If a rating is specified in the table below for a fixture or appliance to be installed in the dwelling, the applicant must ensure that each such fixture and appliance meets the rating specified for it.		~	~
(d) The applicant must install an on demand hot water recirculation system which regulates all hot water use throughout the dwelling, where indicated for a dwelling in the "HW recirculation or diversion" column of the table below.		~	~
(e) The applicant must install:			
(aa) a hot water diversion system to all showers, kitchen sinks and all basins in the dwelling, where indicated for a dwelling in the "HW recirculation or diversion" column of the table below; and		•	-
(bb) a separate diversion tank (or tanks) connected to the hot water diversion systems of at least 100 litres. The applicant must connect the hot water diversion tank to all toilets in the dwelling.		•	-
(e) The applicant must not install a private swimming pool or spa for the dwelling, with a volume exceeding that specified for it in the table below.	~	~	
(f) If specified in the table, that pool or spa (or both) must have a pool cover or shading (or both).		~	
(g) The pool or spa must be located as specified in the table.	~	~	
(h) The applicant must install, for the dwelling, each alternative water supply system, with the specified size, listed for that dwelling in the table below. Each system must be configured to collect run-off from the areas specified (excluding any area which supplies any other alternative water supply system), and to divert overflow as specified. Each system must be connected as specified.	~	~	~

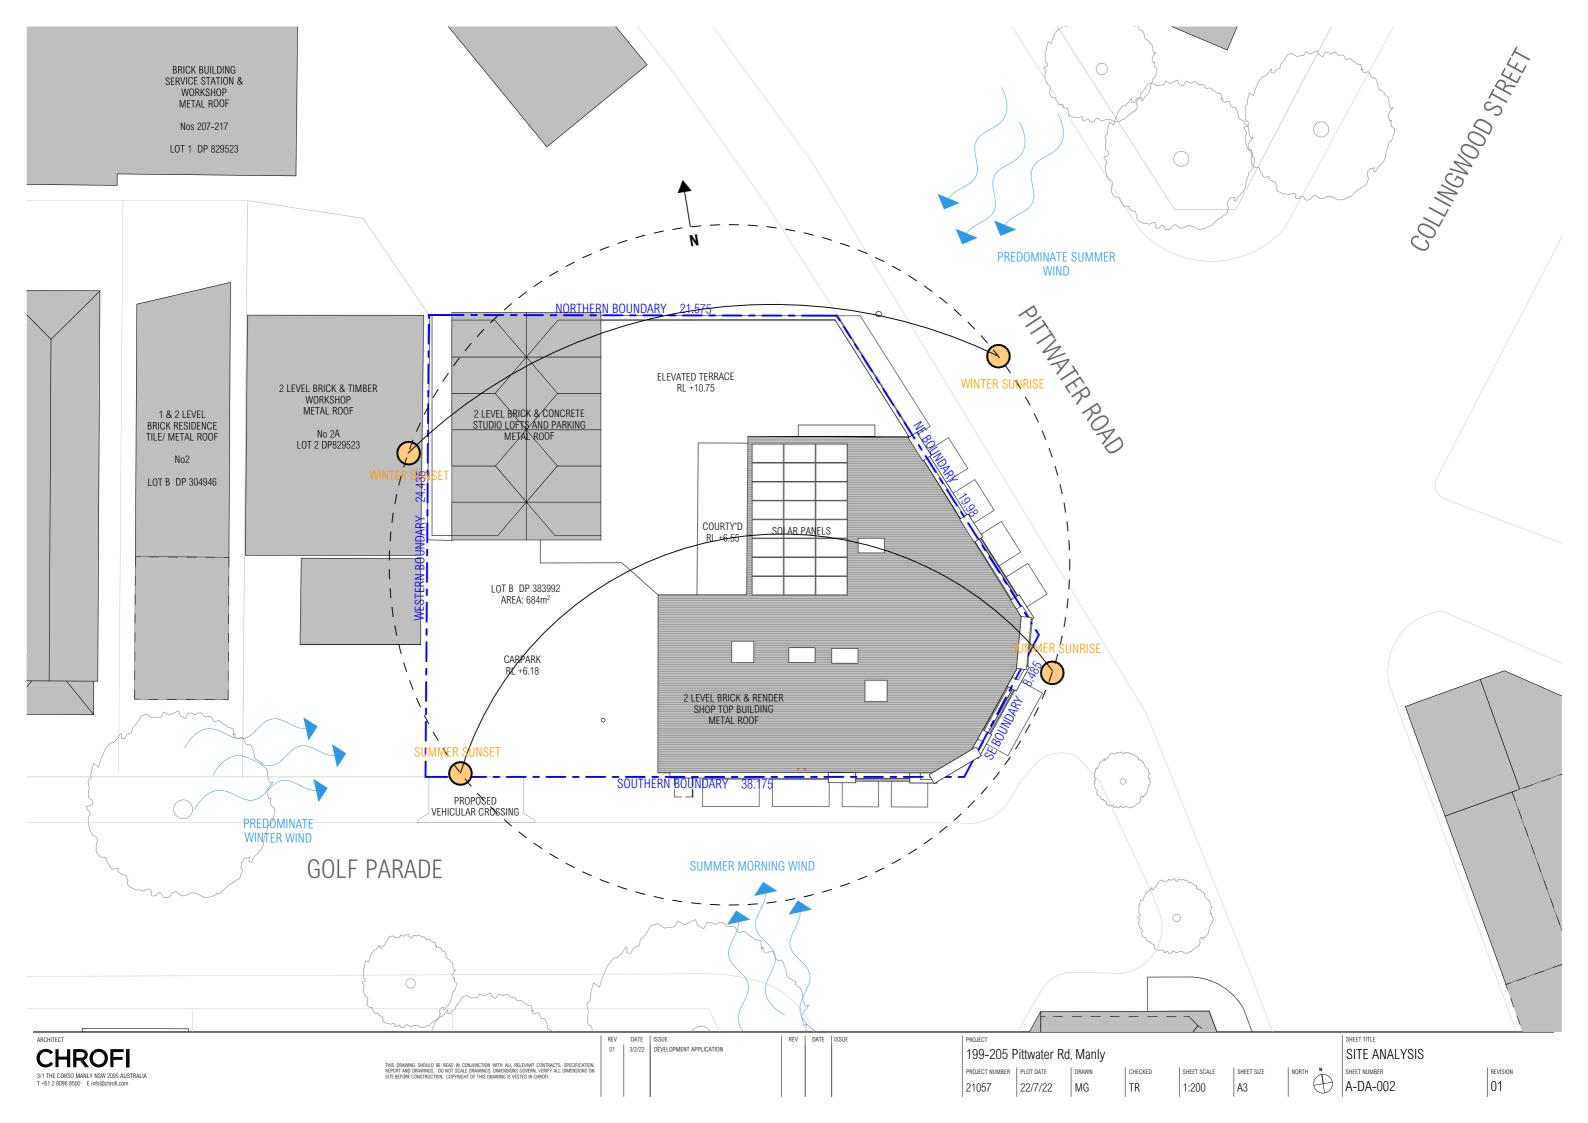		Fixtures					Appliances		Individual pool				Individual spa		
Dwelling no.	All shower- heads	All toilet flushing systems	All kitchen taps	All bathroom taps	HW recirculation or diversion	All clothes washers	All dish- washers	Volume (max volume)	Pool cover	Pool location	Pool shaded	Volume (max volume)	Spa cover	Spa shaded	
All dwellings	4 star (> 6 but <= 7.5 L/min)	4 star	4 star	4 star	no	-	4 star	-	-	-	-	-	-	-	

		Alternative water source										
Dwelling no.	Alternative water supply systems	Size	Configuration	Landscape connection	Toilet connection (s)	Laundry connection	Pool top-up	Spa top-up				
All dwellings	central water tank (no. 1)	See central systems	See central systems	no	no	yes	no	no				
None	-	-	-	-	-	-	-	-				

(ii) Energy	Show on DA plans	Show on CC/CDC plans & specs	Certifier check
(a) The applicant must comply with the commitments listed below in carrying out the development of a dwelling listed in a table below.			
(b) The applicant must install each hot water system specified for the dwelling in the table below, so that the dwelling's hot water is supplied by that system. If the table specifies a central hot water system for the dwelling, then the applicant must connect that central system to the dwelling, so that the dwelling's hot water is supplied by that central system.	~	~	~
(c) The applicant must install, in each bathroom, kitchen and laundry of the dwelling, the ventilation system specified for that room in the table below. Each such ventilation system must have the operation control specified for it in the table.		~	~
(d) The applicant must install the cooling and heating system/s specified for the dwelling under the "Living areas" and "Bedroom areas' headings of the "Cooling" and "Heating" columns in the table below, in/for at least 1 living/bedroom area of the dwelling. If no cooling or heating system is specified in the table for "Living areas" or "Bedroom areas", then no systems may be installed in any such areas. If the term "zoned" is specified beside an air conditioning system, then the system must provide for day/night zoning between living areas and bedrooms.		~	~
(e) This commitment applies to each room or area of the dwelling which is referred to in a heading to the "Artificial lighting" column of the table below (but only to the extent specified for that room or area). The applicant must ensure that the "primary type of artificial lighting" for each such room in the dwelling is fluorescent lighting or light entiting diode (LED) lighting. If there "dedicated" is specified for a particular room or area, then the light fittings in that room or area must only be capable of being used for fluorescent lighting or light entiting diode (LED) lighting. If		~	~

(ii) Energy	Show on DA plans	Show on CC/CDC plans & specs	Certifier check
(f) This commitment applies to each room or area of the dwelling which is referred to in a heading to the "Natural lighting" column of the table below (but only to the extent specified for that room or area). The applicant must ensure that each such room or area is fitted with a window and/or skylight.	~	~	~
(g) This commitment applies if the applicant installs a water heating system for the dwelling's pool or spa. The applicant must:			
(aa) install the system specified for the pool in the "Individual Pool" column of the table below (or alternatively must not install any system for the pool). If specified, the applicant must install a timer, to control the pool's pump; and		~	
(bb) install the system specified for the spa in the "Individual Spa" column of the table below (or alternatively must not install any system for the spa). If specified, the applicant must install a timer to control the spa's pump.		~	
(h) The applicant must install in the dwelling:			
(aa) the kitchen cook-top and oven specified for that dwelling in the "Appliances & other efficiency measures" column of the table below;		~	
(bb) each appliance for which a rating is specified for that dwelling in the "Appliances & other efficiency measures" column of the table, and ensure that the appliance has that minimum rating; and		~	-
(cc) any clothes drying line specified for the dwelling in the "Appliances & other efficiency measures" column of the table.		~	
(i) If specified in the table, the applicant must carry out the development so that each refrigerator space in the dwelling is "well ventilated".		~	

	Hot water	Bathroom ven	tilation system	Kitchen venti	lation system	Laundry ventilation system		
Dwelling no.	Hot water system	Each bathroom	Operation control	Each kitchen	Operation control	Each laundry	Operation control	
All dwellings	gas instantaneous 5 star	individual fan, ducted to façade or roof	manual switch on/off	individual fan, ducted to façade or roof	manual switch on/off	individual fan, ducted to façade or roof	manual switch on/off	

	Coo	ling	Hea	ting	Artificial lighting							Natural lighting	
Dwelling no.	living areas	bedroom areas	living areas	bedroom areas	No. of bedrooms &/or study	No. of living &/or dining rooms	Each kitchen	All bathrooms/ toilets	Each laundry	All hallways	No. of bathrooms &/or toilets	Main kitche	
1, 4	1-phase airconditioning 2.5 Star (old label)	1-phase airconditioning 2.5 Star (old label)	1-phase airconditioning 2.5 Star (old label)	1-phase airconditioning 2.5 Star (old label)	2 (dedicated)	1 (dedicated)	yes (dedicated)	yes (dedicated)	yes (dedicated)	yes (dedicated)	1	no	
All other dwellings	1-phase airconditioning 2.5 Star (old label)	1-phase airconditioning 2.5 Star (old label)	1-phase airconditioning 2.5 Star (old label)	1-phase airconditioning 2.5 Star (old label)	1 (dedicated)	1 (dedicated)	yes (dedicated)	yes (dedicated)	yes (dedicated)	yes (dedicated)	1	no	

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BASIX TR SHEET SCALE SHEET SIZE NORTH SHEET NUMBER A-DA-010

REVISION

01

SHEET TITLE

	Individual pool Individual spa			Appliances & other efficiency measures								
Dwelling no.	Pool heating system	Timer	Spa heating system	Timer	Kitchen cooktop/oven	Refrigerator	Well ventilated fridge space	Dishwasher	Clothes washer	Clothes dryer	Indoor or sheltered clothes drying line	Private outdoor or unsheltered clothes drying line
All dwellings	-	-	-	-	electric cooktop &	1.5 star	no	3 star	-	-	no	no

(iii) Thermal Comfort	Show on DA plans	Show on CC/CDC plans & specs	Certifier check
(a) The applicant must attach the certificate referred to under "Assessor details" on the front page of this BASIX certificate (the "Assessor Certificate") to the development application and construction certificate application for the proposed development (or, if the applicant is applying for a complying development certificate for the proposed development, to have application). The applicant must also attach the Assessor Certificate to the application for a final occupation certificate for the proposed development.			
(b) The Assessor Certificate must have been issued by an Accredited Assessor in accordance with the Thermal Comfort Protocol.			
(c) The details of the proposed development on the Assessor Certificate must be consistent with the details shown in this BASIX Certificate, including the details shown in the "Thermal Loads" table below.			

(iii) Thermal Comfort	Show on DA plans	Show on CC/CDC plans & specs	Certifier check
(d) The applicant must show on the plans accompanying the development application for the proposed development, all matters which the Thermid Control Protocol requires to be shown on those plans. Those plans must bear a stamp of endorsement from the Accredited Assessor, to certify that this is the case.	~		
(e) The applicant must show on the plans accompanying the application for a construction certificate (or complying development certificate, if applicable), all thermal performance specifications set out in the Assessor Certificate, and all aspects of the proposed development which were used to calculate those specifications.		~	
(f) The applicant must construct the development in accordance with all thermal performance specifications set out in the Assessor Certificate, and in accordance with those aspects of the development application or application for a complying development certificate which were used to calculate those specifications.		~	~
(g) Where there is an in-slab heating or cooling system, the applicant must:	~	~	~
(aa) Install insulation with an R-value of not less than 1.0 around the vertical edges of the perimeter of the slab; or			
(bb) On a suspended floor, install insulation with an R-value of not less than 1.0 underneath the slab and around the vertical edges of the perimeter of the slab.			
(h) The applicant must construct the floors and walls of the development in accordance with the specifications listed in the table below.	~	~	~
(i) The applicant must show on the plans accompanying the development application for the proposed development, the locations of ceiling fans set out in the Assessor Certificate.	~		
(j) The applicant must show on the plans accompanying the application for a construction certificate (or complying development certificate, if applicable), the locations of ceiling fans set out in the Assessor Certificate.		✓	

	Thermal loads		
Dwelling no.	Area adjusted heating load (in mJ/m²/yr)	Area adjusted cooling load (in mJ/m²/yr)	
1	29.2	17.0	
2	14.4	23.9	
3	45.1	27.3	
All other dwellings	45.4	21.2	


(b) Common areas and central systems/facilities


(i) Water	Show on DA plans	Show on CC/CDC plans & specs	Certifier check
(a) If, in carrying out the development, the applicant installs a showerhead, toilet, tap or clothes washer into a common area, then that item must meet the specifications listed for it in the table.		~	~
(b) The applicant must install (or ensure that the development is serviced by) the alternative water supply system(s) specified in the "Central systems" column of the table below. In each case, the system must be sized, be configured, and be connected, as specified in the table.	~	~	~
(c) A swimming pool or spa listed in the table must not have a volume (in kLs) greater than that specified for the pool or spa in the table.	~	~	
(d) A pool or spa listed in the table must have a cover or shading if specified for the pool or spa in the table.		~	
(e) The applicant must install each fire sprinkler system listed in the table so that the system is configured as specified in the table.		~	~
(f) The applicant must ensure that the central cooling system for a cooling tower is configured as specified in the table.		<u> </u>	_


Common area	Showerheads rating	Toilets rating	Taps rating	Clothes washers rating
All common areas	no common facility	4 star	4 star	no common laundry facility


Central systems	Size	Configuration	Connection (to allow for)
Central water tank - rainwater or stormwater (No. 1)	1500.0	To collect run-off from at least: - 50.0 square metres of roof area of buildings in the development - 0.0 square metres of impervious area in the development - 0.0 square metres of garden/lawn area in the development - 0.0 square metres of planter box area in the development (excluding, in each case, any area which drains to, or suppose to the control of the cont	- irrigation of 0.0 square metres of common landscaped area on the site - car washing in 0 car washing bays on the site


(ii) Energy	Show on DA plans	Show on CC/CDC plans & specs	Certifier check
(a) If, in carrying out the development, the applicant installs a ventilation system to service a common area specified in the table below, then that ventilation system must be of the type specified for that common area, and must meet the efficiency measure specified.		~	~
(b) In carrying out the development, the applicant must install, as the "primary type of artificial lighting" for each common area specified in the table below, the lighting specified for that common area. This lighting must meet the efficiency measure specified. The applicant must also install a centralised lighting control system or Building Management System (BMS) for the common area, where specified.		~	•
(c) The applicant must install the systems and fixtures specified in the "Central energy systems" column of the table below. In each case, the system or fixture must be of the type, and meet the specifications, listed for it in the table.	_	_	_

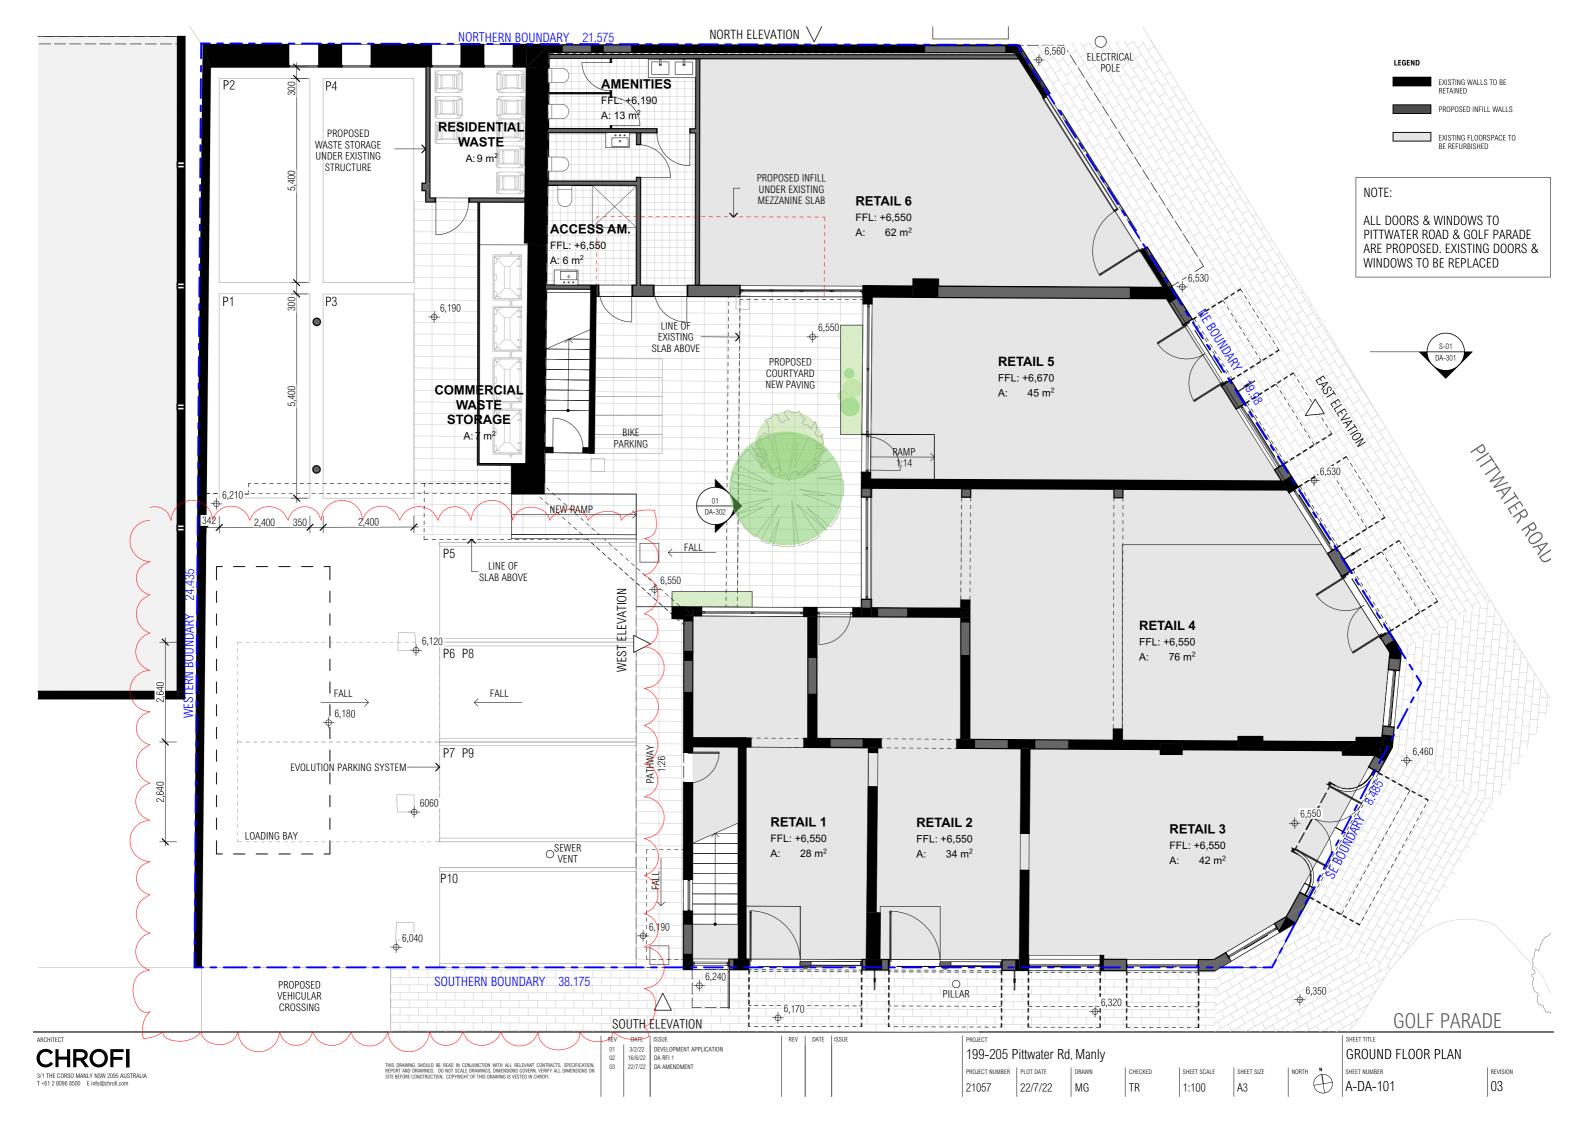

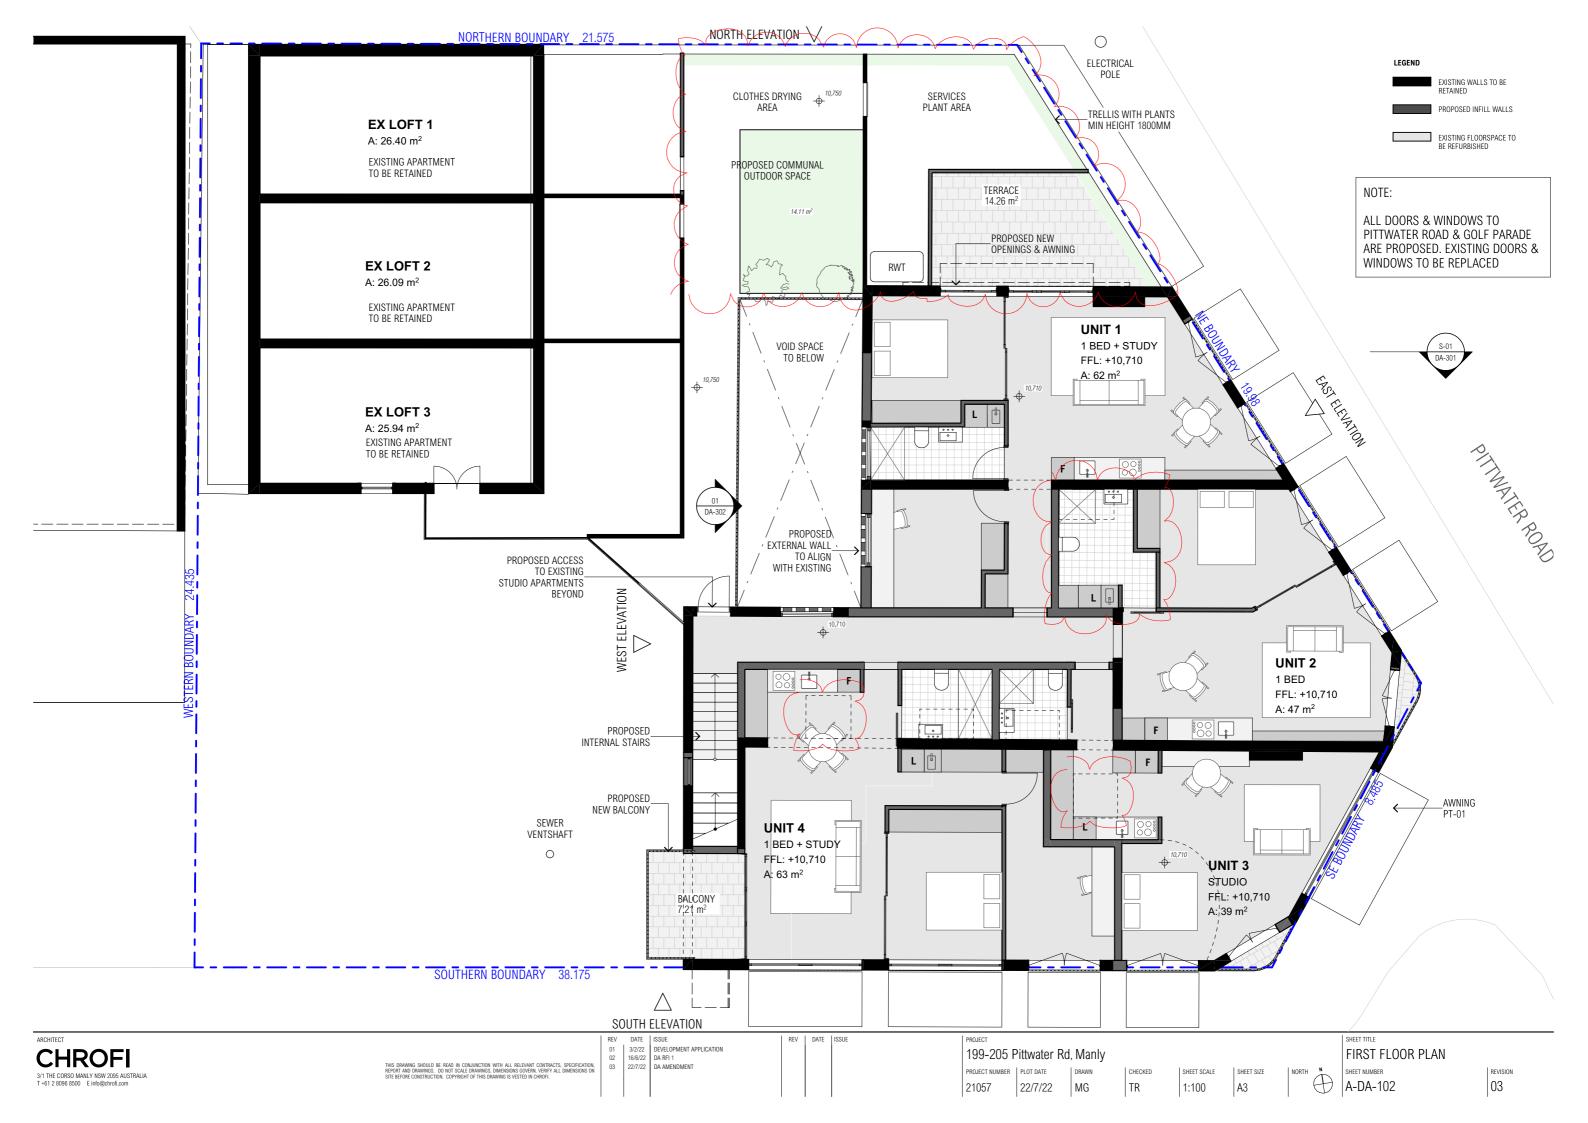

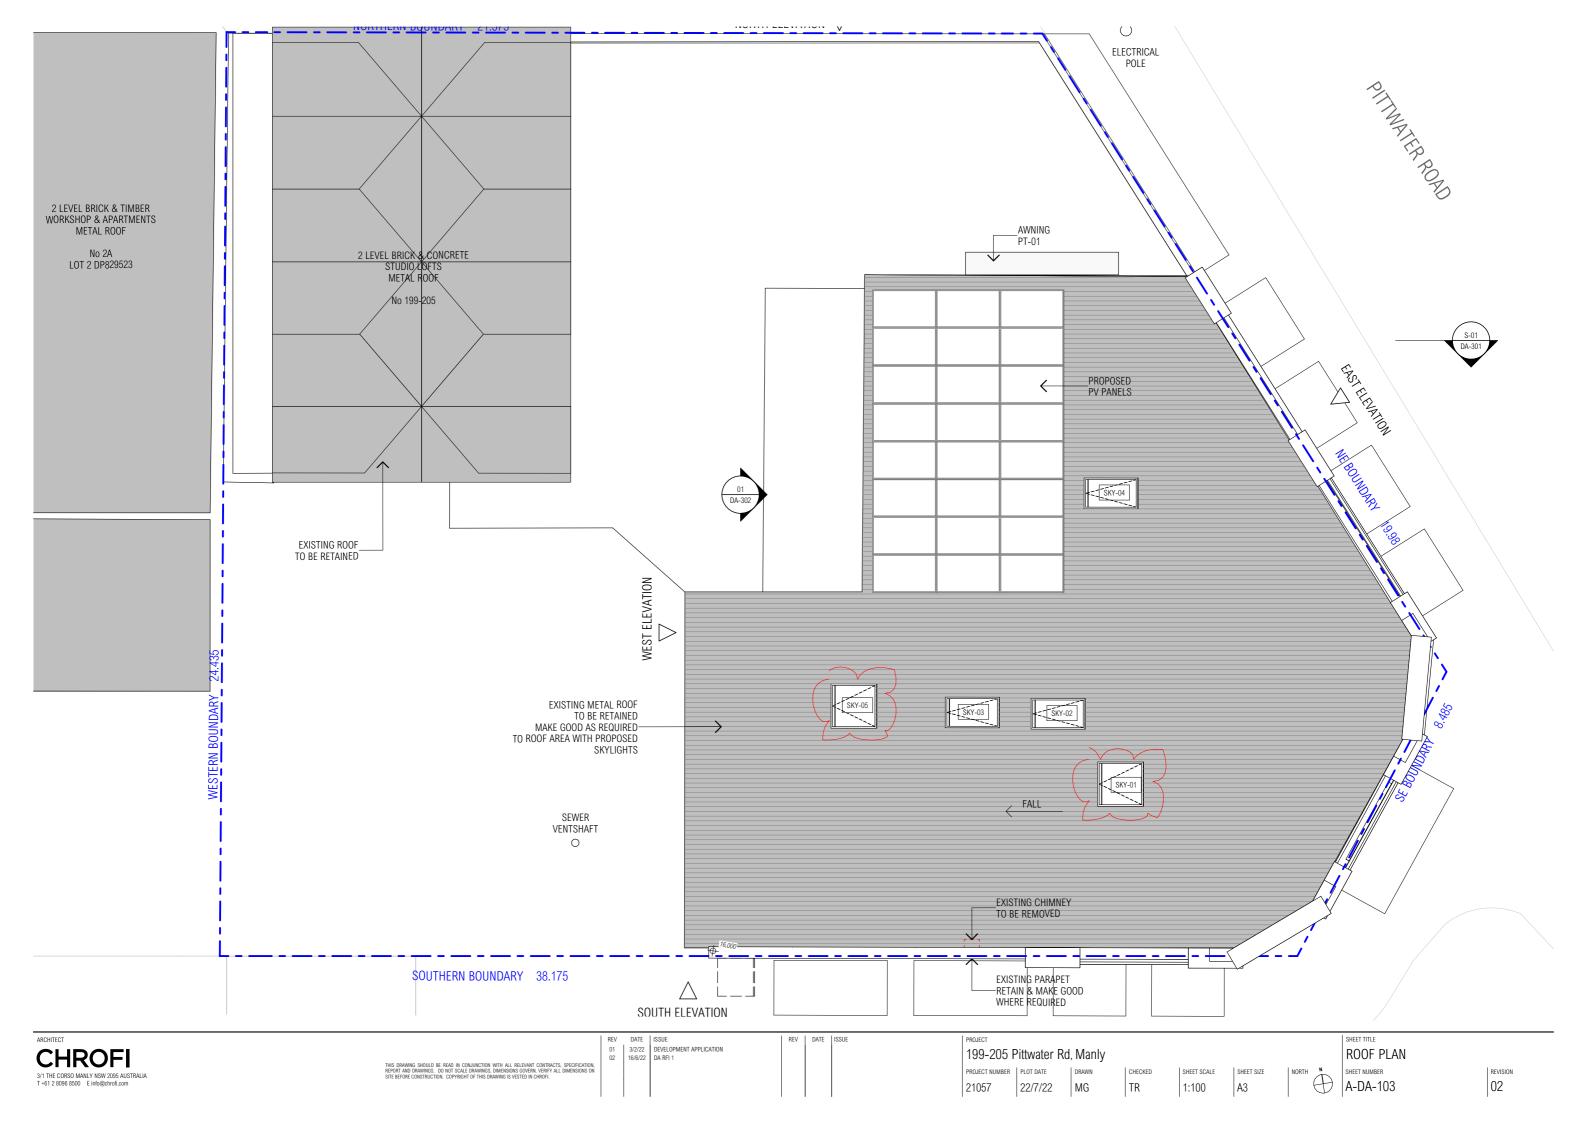

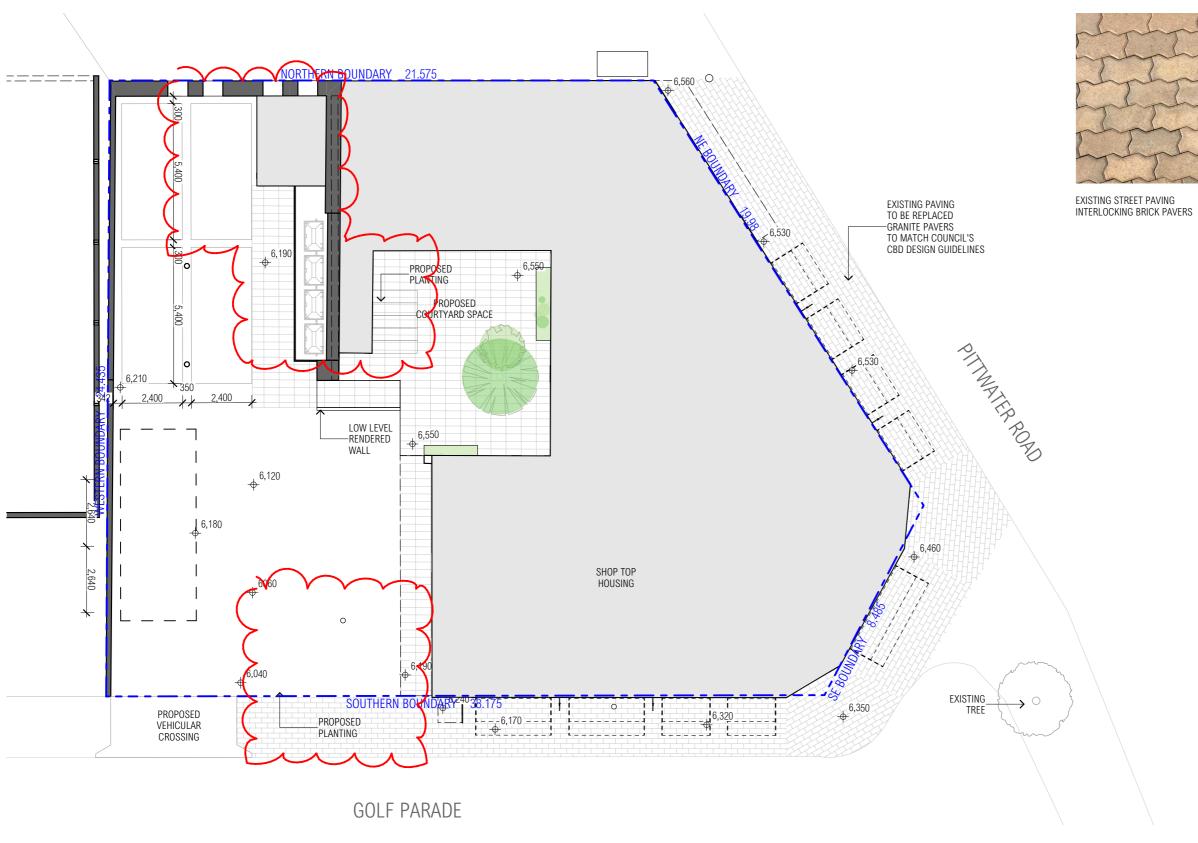

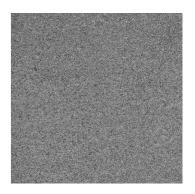

PROPOSED STREET PAVING GREY GRANITE PAVERS




PROPOSED COURTYARD PAVING CONCRETE PAVERS, LARGE FORMAT



CONCRETE DRIVEWAY/ PARKING AREA



LOW LEVEL PLANTING TO GOLF PDE AND PROPOSED COURTYARD

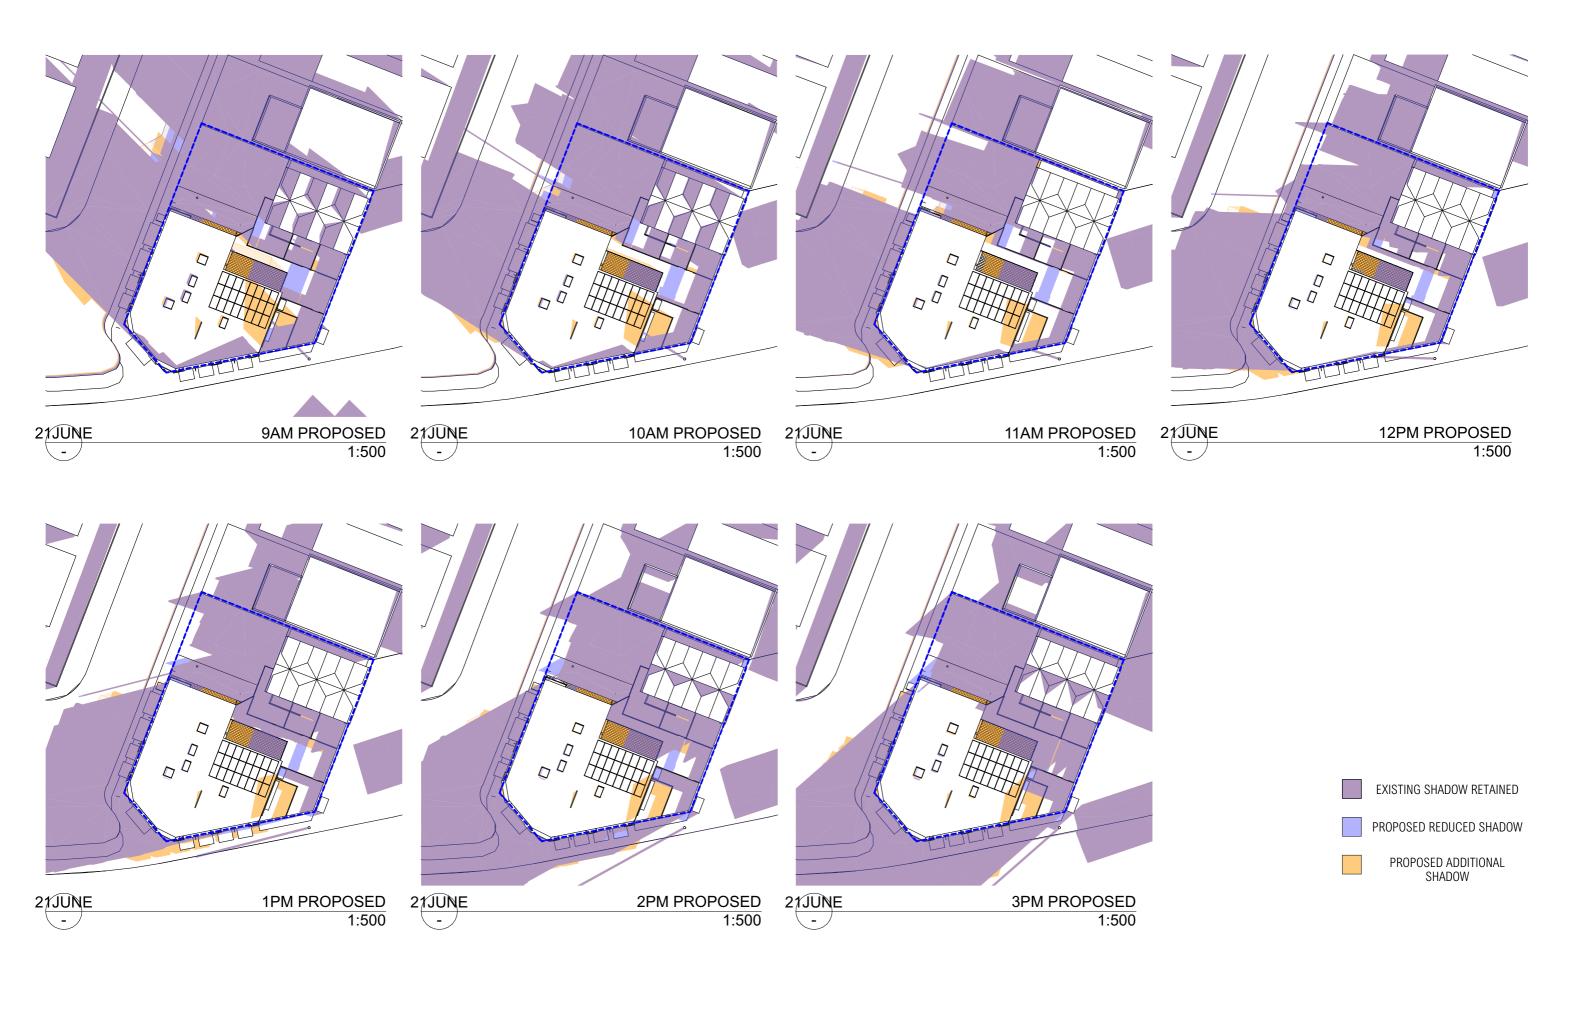


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NOTE:

ALL DOORS & WINDOWS TO PITTWATER ROAD & GOLF PARADE ARE PROPOSED. EXISTING DOORS & WINDOWS TO BE REPLACED



BAL-01 METAL BALUSTRADE BR-01 EXISTING BRICK BR-02 NEW BRICK TO MATCH EXISTING BRS-01 BRICK SCREEN CN-01 EXISTING EXPOSED CONCRETE CN-02 PROPOSED CONCRETE AWNINGS LC-01 LIGHTWEIGHT CLADDING PT-01 POWDERCOATED METAL SHEET PT-02 POWDERCOATED METAL SHEET RE-01 RENDER OFF-WHITE RE-02 RENDER TEXTURED OFF-WHITE RE-03 RENDER MEDIUM DARK ST-01 TERRAZZO TILE TF-01 TIMBER FENCE

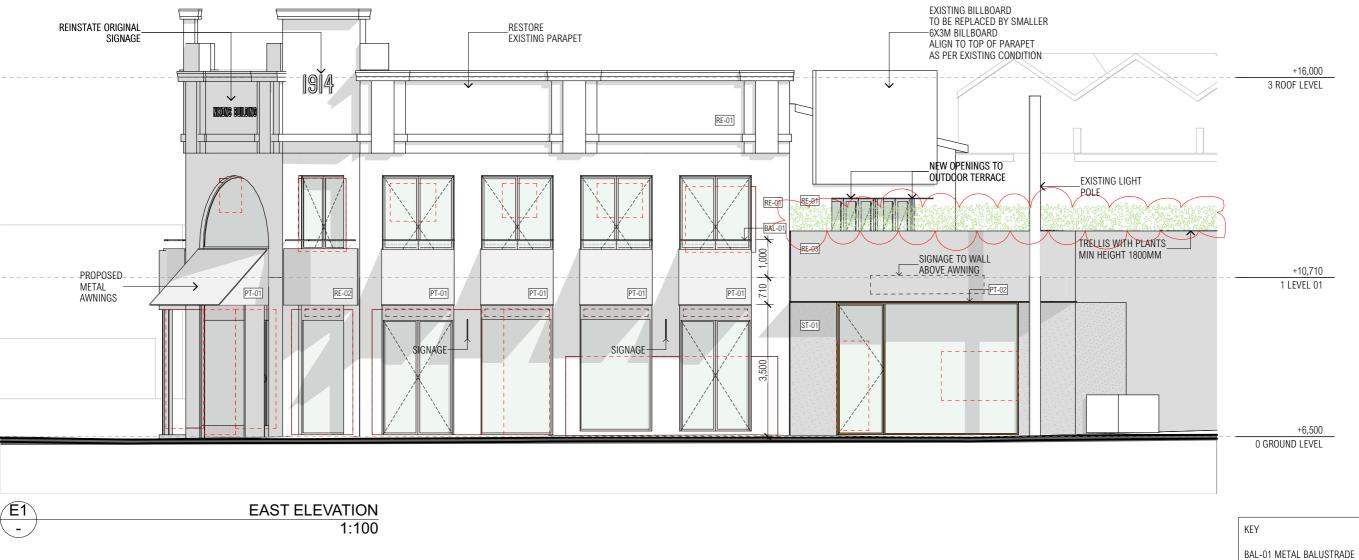A-DA-201

REVISION


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REV DATE ISSUE



ALL DOORS & WINDOWS TO
PITTWATER ROAD & GOLF PARADE
ARE PROPOSED. EXISTING DOORS &
WINDOWS TO BE REPLACED



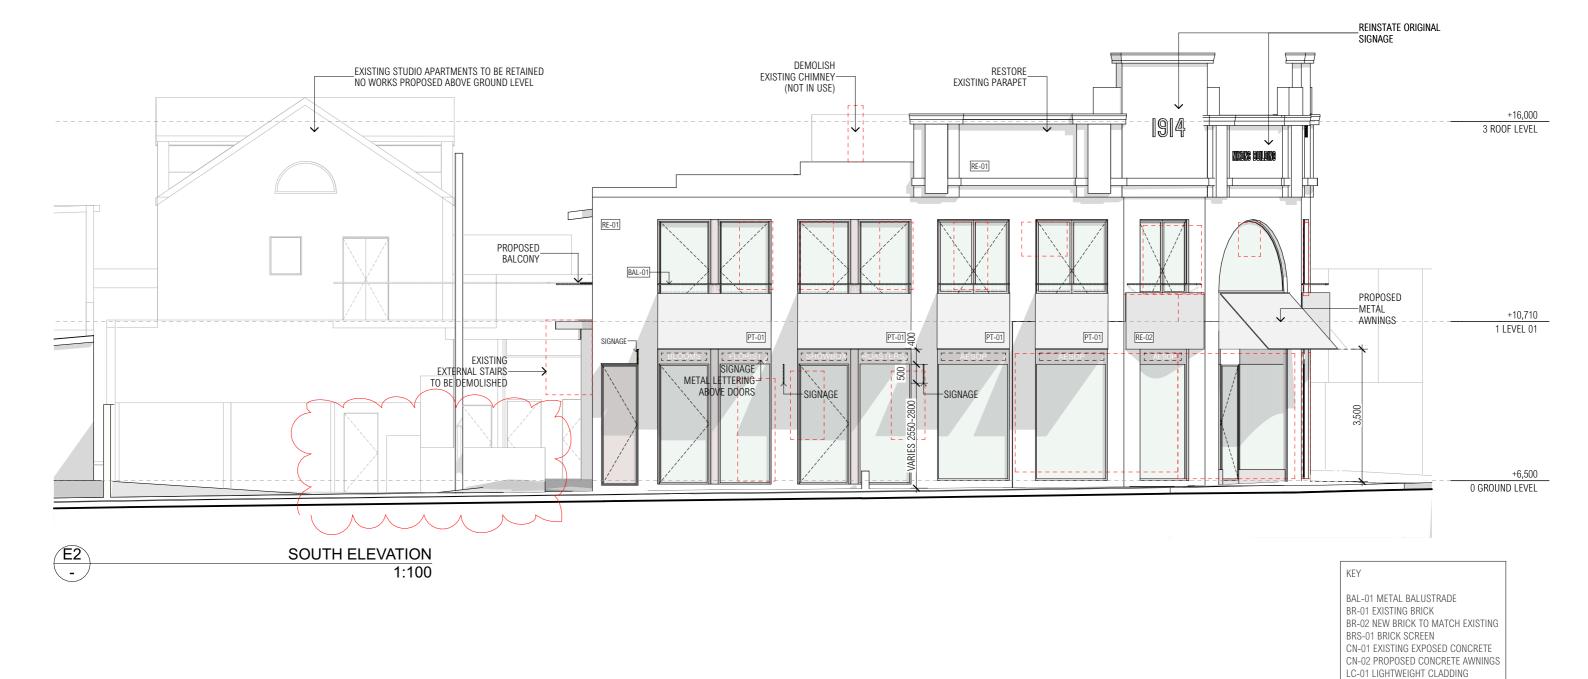

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REV DATE ISSUE

199-205 Pittwater Rd, Manly
PROJECT NUMBER | PLOT DATE | DRAWN
21057 | 22/7/22 | MG

SHEET SCALE 1:100

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SHEET SIZE NORTH


ELEVATIONS - SHEET 2
SHEET NUMBER

PT-01 POWDERCOATED METAL SHEET
PT-02 POWDERCOATED METAL SHEET
RE-01 RENDER OFF-WHITE
RE-02 RENDER TEXTURED OFF-WHITE
RE-03 RENDER MEDIUM DARK
ST-01 TERRAZZO TILE
TF-01 TIMBER FENCE

A-DA-202

REVISION 02



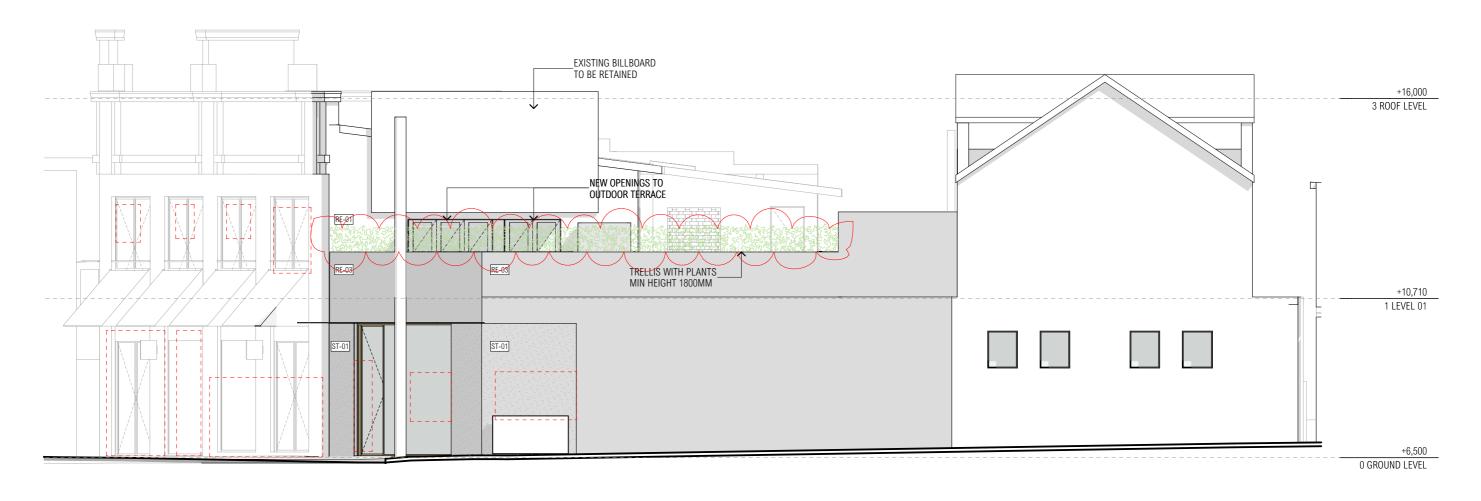

REV DATE ISSUE

NORTH ELEVATION 1:100

BAL-01 METAL BALUSTRADE
BR-01 EXISTING BRICK
BR-02 NEW BRICK TO MATCH EXISTING
BRS-01 BRICK SCREEN
CN-01 EXISTING EXPOSED CONCRETE
CN-02 PROPOSED CONCRETE AWNINGS
LC-01 LIGHTWEIGHT CLADDING
PT-01 POWDERCOATED METAL SHEET
PT-02 POWDERCOATED METAL SHEET
RE-01 RENDER OFF-WHITE
RE-02 RENDER TEXTURED OFF-WHITE
RE-03 RENDER MEDIUM DARK
ST-01 TERRAZZO TILE
TF-01 TIMBER FENCE

REVISION

03

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KEY

BAL-01 METAL BALUSTRADE BR-01 EXISTING BRICK BR-02 NEW BRICK TO MATCH EXISTING BRS-01 BRICK SCREEN CN-01 EXISTING EXPOSED CONCRETE CN-02 PROPOSED CONCRETE AWNINGS LC-01 LIGHTWEIGHT CLADDING PT-01 POWDERCOATED METAL SHEET PT-02 POWDERCOATED METAL SHEET RE-01 RENDER OFF-WHITE RE-02 RENDER TEXTURED OFF-WHITE RE-03 RENDER MEDIUM DARK ST-01 TERRAZZO TILE TF-01 TIMBER FENCE





SHEET SCALE 1:100

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SHEET SIZE

ELEVATIONS - SHEET 4 SHEET NUMBER

REVISION







PT-01 PT-01 SHOWBOX BLOOMS **FLORIST** ROASTERS SIGNAGE METAL LETTERING ABOVE DOORS -SIGNAGE \ -SIGNAGE

INTEGRATED SIGNAGE FRAME METAL FINISH 75 500

TYPICAL SIGNAGE DESIGN INTENT ELEVATION 1:50

03 TYPICAL SIGNAGE DETAIL INTENT 1:50

21057

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02

| REV | DATE | ISSUE | | 01 | 16/6/22 | DA RFI 1

199-205 Pittwater Rd, Manly PROJECT NUMBER | PLOT DATE

22/7/22 MG TR


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SHEET SIZE

SHEET TITLE SIGNAGE SHEET NUMBER A-DA-205



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199-205 Pittwater Rd, Manly PROJECT NUMBER | PLOT DATE 21057 22/7/22 MG

CHECKED SHEET SCALE 1:100
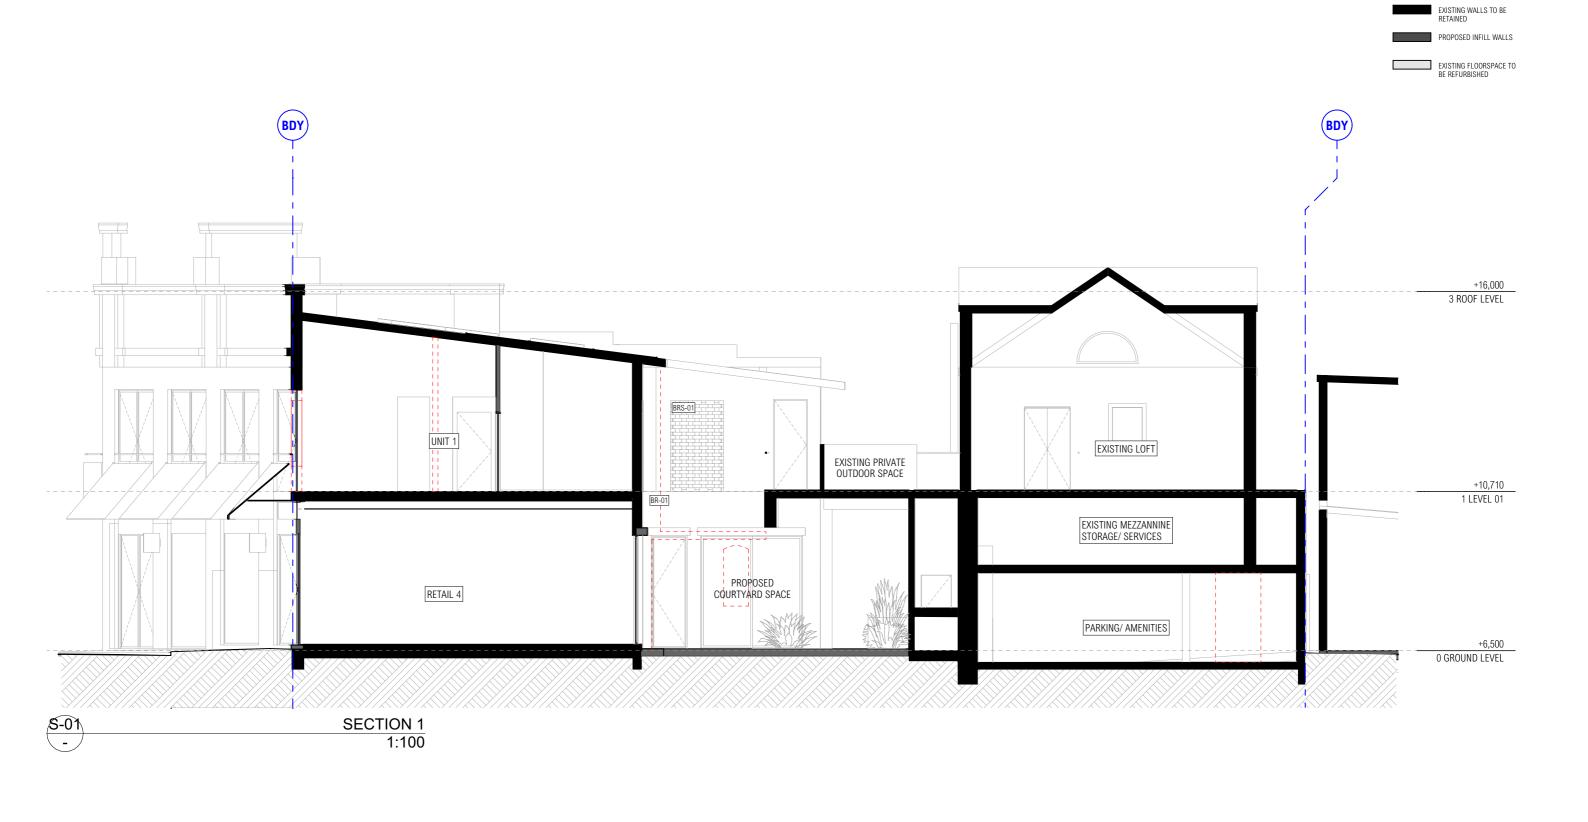
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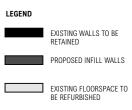
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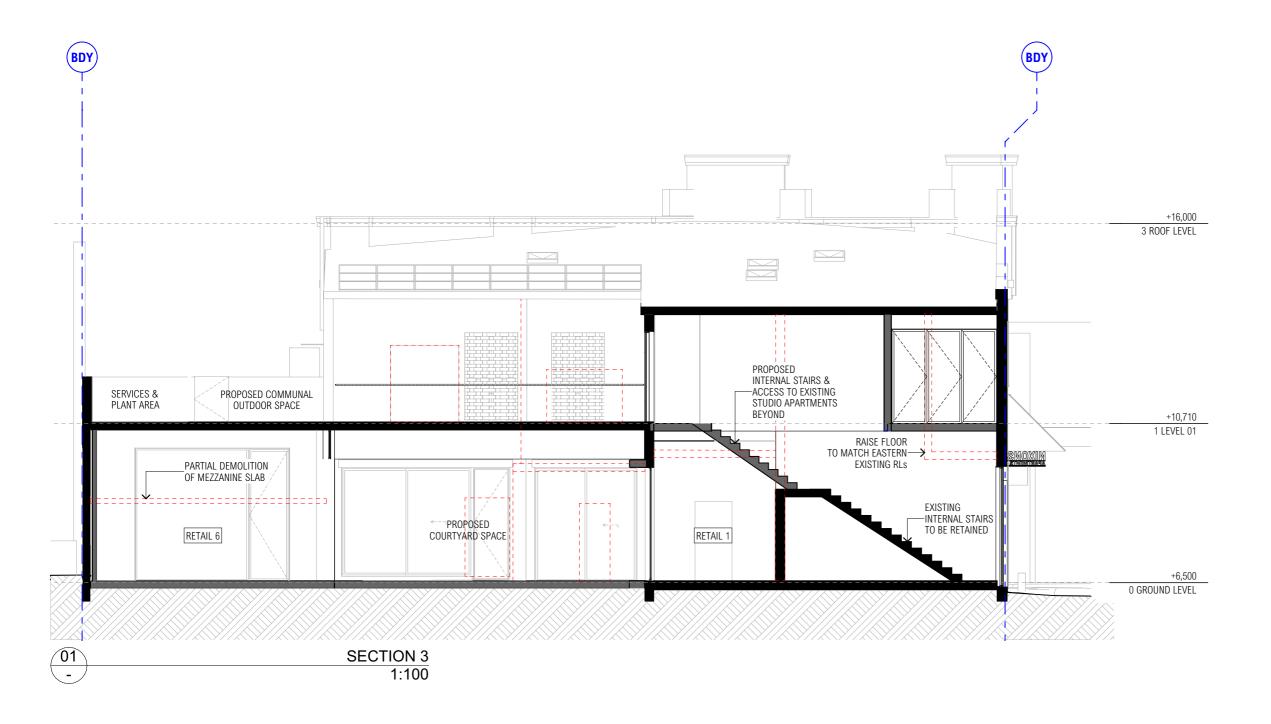
SECTIONS - SHEET 1 SHEET NUMBER A-DA-301

REVISION

01

LEGEND







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| REV DATE | ISSUE | 01 | 3/2/22 | DEVELOPMENT APPLICATION

199-205 Pittwater Rd, Manly PROJECT NUMBER | PLOT DATE 21057 22/7/22 MG


CHECKED SHEET SCALE 1:100

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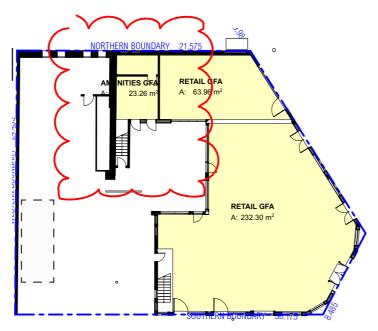
SHEET SIZE

A3


SECTIONS - SHEET 2 SHEET NUMBER A-DA-302

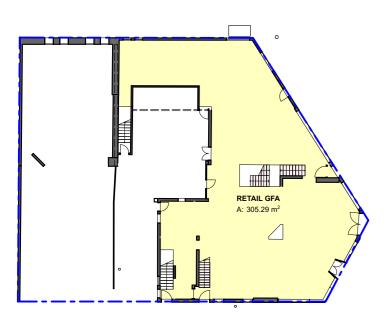


GROUND LEVEL EXISTING GFA




GROUND LEVEL PROPOSED GFA

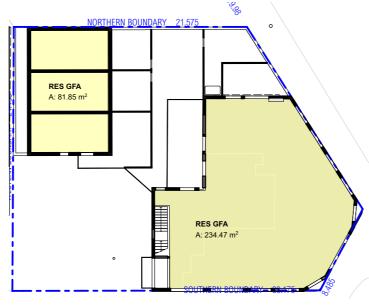


LEVEL 1 PROPOSED GFA

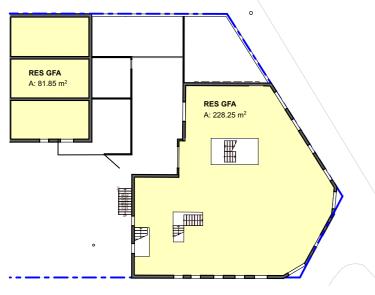

LEVEL 1 EXISTING GFA

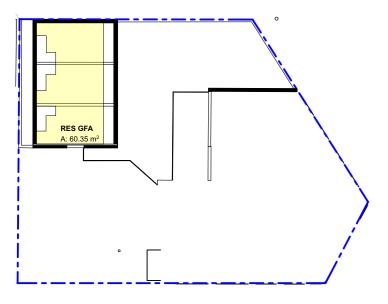

LEVEL 02 EXISTING GFA

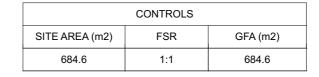

	EXISTING FSR	
SITE AREA (m2)	FSR	GFA (m2)
684.6	0.99:1	675.7

PROPOSED FSR		
SITE AREA (m2)	FSR	GFA (m2)
684.6	1.02:1	696.2m2

GFA - EXISTING			\geq
LEVEL	TYPE	GFA EXISTING	
GROUND LEVEL	RETAIL GFA	305	>
LEVEL 01	RES GFA	310	
LEVEL 02	RES GFA	60	
	•	675 m²	

GFA PROPOSED			
LEVEL	TYPE	GFA PROPOSED	
GROUND LEVEL	AMENITIES GFA	23	
GROUND LEVEL	RETAIL GFA	296	
LEVEL 01	RES GFA	316	
LEVEL 02	RES GFA	60	

695 m²

21057

A3

REVISION 02



GOLF PARADE EXISTING

PITTWATTER ROAD EXISTING

21057 22/7/22 MG



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| REV DATE | ISSUE | 01 | 3/2/22 | DEVELOPMENT APPLICATION

199-205 Pittwater Rd, Manly

PROJECT NUMBER | PLOT DATE 21057 22/7/22 MG

SHEET NUMBER SHEET NUMBER
A-DA-901

INDICATIVE EXTERIOR VIEW REVISION



ARCHITECT

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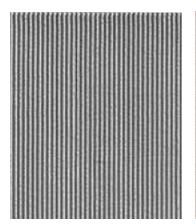
PROJECT NUMBER | PLOT DATE 21057 22/7/22 MG

SHEET NUMBER
A-DA-902

INDICATIVE COURTYARD VIEW REVISION








RENDER TEXTURED OFF-WHITE RE-02




RENDER MEDIUM DARK RE-03



TERRAZZO TILES ST-01

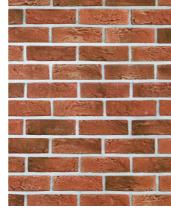

EXISTING MASONRY BR-01

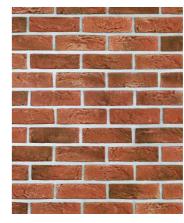

NEW MASONRY TO MATCH EXISTING BR-02



EXISTING EXPOSED CONCRETE CON-01



METAL AWNINGS PT-01



DOOR FRAMES - POWDERCOAT FINISH



METAL BALUSTRADES BAL-01

21057

REVISION