BIRDWOOD

ARCHITECTURAL DRAWING SCHEDULE

DRAWING #	CATEGORY	DRAWING NAME	REVISION
DA00.1	COVER	COVER	Α
DA00.2	COVER	LEGEND	Α
DA00.3	COVER	BASIX	Α
DA00.4	COVER	SCHEDULE OF MATERIALS AND FINISHES	Α
DA01.1	SITE PLAN	SITE ANALYSIS	Α
DA01.2	SITE PLAN	SITE PLAN	Α
DA01.3	SITE PLAN	LANDSCAPE PLAN	Α
DA02.1	FLOOR PLANS	GROUND FLOOR PLAN	Α
DA02.2	FLOOR PLANS	FIRST FLOOR PLAN	Α
DA02.3	FLOOR PLANS	SECOND FLOOR PLAN	Α
DA02.4	FLOOR PLANS	ROOF PLAN	Α
DA03.1	ELEVATIONS	NORTH & SOUTH ELEVATION	Α
DA03.2	ELEVATIONS	EAST & WEST ELEVATION	Α
DA04.1	SECTIONS	SECTION A	A
DA04.2	SECTIONS	SECTION B	Α
DA04.3	SECTIONS	SECTION C & D	Α
DA09.1	SHADOW DIAGRAMS	SHADOW DIAGRAM 21 JUNE 9AM/12PM/3	Α
DA10.1	3D IMAGES	BUILDING HEIGHT PLANE 8.5M	A
DA10.2	3D IMAGES	BUILDING ENVELOPE 45°	Α
DA10.3	3D IMAGES	WALL HEIGHT - 7.2M	Α
DA10.4	3D IMAGES	1065 PITTWATER RD VIEW ANALYSIS	Α
DA11.1	CALCULATIONS	LANDSCAPE AREA CALCULATIONS	Α





MACCORMICK + ASSOCIATES ARCHITECTS,
13 VICTORIA STREET QUEENS PARK NSW 2022
T9037 0437 E hello@maccormickarchitects.com.au
ACN 147 572 807 ARCHITECT REG 6702
THE BUILDER SHALL CHECK & VERIFY ALL DIMENSIONS & VERIFY ALL ERRORS AND OMISSIONS TO THE ARCHITECT. CONTRACTOR TO REPORT DISCREPANCIES IMMEDIATELY. THIS DRAWING IS TO BE USED IN CONJUNCTION WITH ALL RELEVANT CONTRACTS. DO NOT SCALE OFF DRAWINGS. DRAWINGS SHALL NOT BE USED FOR CONSTRUCTION. THIS DRAWING IS COPYRIGHT AND MAY NOT BE USED WITHOUT WRITTEN CONSENT FROM THE ARCHITECT

PROJECT BIRDWOOD

Matthew & Shona Adamo
1 Birdwood Ave Collaroy NSW 2097

PROJECT NO REVISION | DATE PRINTED: 18/06/2025 | A | DA SUBMISSION | 18/06/2025 | PAPER SIZE: A3 | DRAWN BY: LH, RL | CHECKED BY: MM

NOT FOR CONSTRUCTION

DRAWING TITLE
COVER

DEVELOPMENT APPLICATION

DRAWING NO

DA00.1



DRAWING LEGEND

WALL TYPE

L____.

EXISTING WALL DEMOLISHED WALL

NEW SINGLE BRICK WALL NEW CAVITY BRICK WALL

NEW BLOCKWORK WALL NEW CONCRETE WALL

0000000 NEW DINCEL WALL

NEW FRAMED WALL

- SW -— F — F —

— S —

STORMWATER ELECTRICAL LINES - OVERHEAD FLECTRICAL LINES - IN GROUND — FG — FG —

SEWER UNDERGROUND

NBN/TELSTRA LINE

LANDSCAPE LEGEND



TREE TO REMAIN



TREE TO BE REMOVED



NEW TREE

LEVEL LEGEND

⊕^{EL}

EXISTING LEVEL



DEMOLISHED LEVEL RELATIVE LEVEL



FLOOR LEVEL



SET DOWN IN FLOOR

____15

FINISH

SITE SERVICES LEGEND

一 $\begin{bmatrix} \overline{} \end{bmatrix}$ R

HOSE COCK CONNECTED TO TOWN WATER HOSE COCK CONNECTED



PIT



HOT WATER UNIT

FREE-TO-AIR AERIAL

TO RAIN WATER

(S))

SMOKE ALARM

ABBREVIATIONS LEGEND

TERMS - GENERAL Air Lock Adjustable Accessible

Back Of House CH CL CNR DIM Ceiling Height Centre Line Corner Dimension Drawer Existing Level

Equal Existing Externa Finished Ceiling Height Finished Floor Level

EL EX. EXT FCH FFL FRL INT O/A OPP Finished Ground Level Floor Level Finished Pelmet Level Fire Resistant Level Internal Low Voltage Not to Scale

Overall Opposite RL SFL SIM TMEX Reduced Level Structural Floor Level Similar To Match Existing

TYP U/C UNO U/S WL WR Undercut Unless Noted Otherwise Under Side Water Level Water Resistant

ELECTRICAL/MECHANICAL

Air Conditioning Boiling Water Unit Circuit Breaker BB BFR DL DW EDB E/F ELEC EM FA FIB FR GPO GPO3 HTR Down Light Dryer Dishwasher Electrical Distribution Board Exhaust Fan

Electrical Meter Fire Alarm Fire Indicator Board Fridge Freezer General Power Outlet GPO 3 Phase Heated Towel Rail Heated Wall Panel HWP

Joinery Light Light Switch Mechanical MSB MW OV RH R/A S/A TEL TV Main Switch Board Microwave Oven Rangehood Return Air Supply Air Telephone Television WFR Wine Fridge Washing Machine

CONSTRUCTIONS/FITTINGS Acoustic Ceiling System Aluminium Framed Glazing ACS ALFG Aluminium Framed Louvres Access Panel AS BAL BHD BKS Adjustable Shelving Balustrade Rulkhead Books Shelves CG CHR CJ CL COL CRN Cable Gromet Clothes Hanging Rail Clothes Line Structural Column Cornice Cavity Slider

Damproof Course

Drainage cell

Equal Angle Expansion Joint

D.CELL

CONSTRUCTIONS/FITTINGS CONT.

FD(1) FG FGSS FLR FP FS Fire Door (hours) Frameless Glass Shower Screen Fixed Shelves FW GB GG Floor Waste Gutter Guard HK HL HR HT Hook Horizontal Louver Handrail Hand Towel IGS JU LV Internal Glazed Screen Joinery Unit Louvre Adjustable Fixed Retractable MIR Mirror

MX Mixer MC MH MJ Metal Cladding Manhole Movement Joint MLD Moulding Microwave Open Shelves Pelmet / Curtain / Rollerblind

Pool Fence Pre formed Flashing Picture Rail Reflective Foil Board insulation Roller Blind

Recessed Shelf Roller Shutter Retaining Wall Suspended Acoustic Ceiling Panel Slot Drain

Soap Holder Shower Shower Rose Sky Light Suspended Plasterboard Toilet Brush

TR TRH UA UB UC Towel Rail Toilet Roll Holder Unequal Angle Universal Beam Universal Column Vent Vertical Louver Window Window - High light WL WPM Wall Light

Waterproof Membrane HYDRAULIC
AG Agric
BG Box
BSN Basin
BT Bour
BTH Bath
CO Clea
CS Clea
DP Dow Agricultural Drain Box Gutter Basin **Boundary Trap** Cleanout

Cleaners Sink Down Pipe EG Eaves Gutter FE FH FHR Fire Extinguisher Fire Hydrant Fire Hose Reel GD GM GT Grease Drain Gas Meter Grease Trap HWI I-# Hot Water Unit (#) Inspection Opening
Hydronic Heating Manifold (#) IO MFD-# O/F OFG RWH-# RWO RWT SD SNK SP SWD LT TD VP WC WS Over Flow Gulley Rainwater Head (#) Rainwater Outlet Rainwater Tank Spreader Storm Water

MATERIALS / FINISHES

Δluminium Acrylic Render BAT BIT BK-2 BK BLK BP CFC CONC CPT CR CT DAR FBK FC FG FGR Battens Bagged Brick Chips Bagged Brick Blockwork Brick Pavers Compressed Fibre Cement Copper Concrete

Carpet
Carpet
Cement Render
Cement Topping with Epoxy Sealer
Dressed All Round Face Brick Fibre Cement Sheeting Product Fixed Glass Fibre Glass Roofing

Galvanised Granolithic Finish

Granolithic Topping / Epoxy Sealer Hardwood

G GALV GRF GRT HWD INSUL LAM MCT MR MS OFC Laminate Micro Cement Metal Roofing Mild Steel Off Form Concrete PT PB PFL Plasterboard Padded Flooring Patterned Glass Plywood

Pólyurethane Reinforced Concrete(Type refer to spec)) Recycled Timber

PG PLY POL RC RT RUB SC SCP SCR SJ SK SKT SP SS STN TC Shingle Cladding Satin Chrome Plate Screed Silicon Joint Skirting Skirting Tile Set Plaster Stainless Steel Stone Texture Coating Translucent Glass

TG TFL TB TIM Timber Floor Boards Timber Batten Timber TLE TLE-# TMB TRT TZ VBM Tile Type #(Type refer to spec)
Termite Moisture Barrier

Terracotta Floor Tiles Terrazzo
Vapour Barrier/Damp Proof Membrane

VEN VYL VT WBC Vinyl Tiles Weatherboard Cladding WRC WP WPB Western Red Cedar Wall Paper Waterproof Plasterboard Waterproof Membrane

LANDSCAPE

Decomposed Granite
Decorative Rock Mulch
Garden Bed Edge as specified GBE GB PB PP PS PV Pebbles TOW Top of Wall

NOT FOR CONSTRUCTION

MACCORMICK + ASSOCIATES ARCHITECTS, 13 VICTORIA STREET QUEENS PARK NSW 2022 T 9037 0437 E hello@maccormickarchitects.com.au ACN 147 572 807 ARCHITECT RE6 572
THE BUILDER SHALL CHECK & VERIFY ALL DIMENSIONS & VERIFY ALL ERRORS AND OMISSIONS TO THE ARCHITECT. CONTRACTOR TO REPORT DISCREPANCIES IMMEDIATELY. THIS DRAWING IS TO BE USED IN CONJUNCTION WITH ALL RELEVANT CONTRACTS. DO NOT SCALE OFF DRAWINGS. DRAWINGS SHALL NOT BE USED FOR CONSTRUCTION PURPOSES UNTIL ISSUED BY THE ARCHITECT FOR CONSTRUCTION. HIS DRAWING IS COPYRIGHT AND MAY NOT BE USED WITHOUT WRITTEN CONSENT FROM THE ARCHITECT

PROJECT

BIRDWOOD Matthew & Shona Adamo 1 Birdwood Ave Collaroy NSW 2097

Storm Water Drain

Laundry Tub Trench Drain

Waste Stack

Vent Pipe

A DA SUBMISSION 2408

PROJECT NO REVISION DATE PRINTED: 18/06/2025 | SCALE 18/06/2025 PAPER SIZE: A3 DRAWN BY: LH, RL CHECKED BY: MM

DRAWING TITLE **LEGEND**

DRAWING STATUS **DEVELOPMENT APPLICATION**

DA00

Fixtures and systems	Show on DA Plans	Show on CC/CDC Plans & specs	Certifier Check
Hot water			
The applicant must install the following hot water system in the development: gas instantaneous.	~	~	~
Lighting			
The applicant must ensure a minimum of 40% of new or altered light fixtures are fitted with fluorescent, compact fluorescent, or light- emitting-diode (LED) lamps.		~	~
Fixtures			
The applicant must ensure new or altered showerheads have a flow rate no greater than 9 litres per minute or a 3 star water rating.		~	~
The applicant must ensure new or altered toilets have a flow rate no greater than 4 litres per average flush or a minimum 3 star water rating.		~	~
The applicant must ensure new or altered taps have a flow rate no greater than 9 litres per minute or minimum 3 star water rating.		~	
Construction	Show on DA Plans	Show on CC/CDC Plans & specs	Certifier Check
Insulation requirements		·	
	1		T

nsulation requirements					
he applicant must construct the new or alte sted in the table below, except that a) addit insulation specified is not required for parts		•	~	~	
Construction	Additional insulation required (R-value)	Other specifications			
concrete slab on ground floor.	nil	N/A			
floor above existing dwelling or building.	nil	N/A			
external wall: brick veneer	R1.16 (or R1.70 including construction)				
external wall: cavity brick	nil				
external wall: framed (weatherboard, fibro, metal clad)	R1.30 (or R1.70 including construction)				
flat ceiling, pitched roof	ceiling: R2.50 (up), roof: foil/sarking	medium (solar absorptance 0.475 - 0.70)			

Glazing requirements	Show on DA Plans	Show on CC/CDC Plans & specs	Certifie Check
Windows and glazed doors			
The applicant must install the windows, glazed doors and shading devices, in accordance with the specifications listed in the table below. Relevant overshadowing specifications must be satisfied for each window and glazed door.	~	~	~
The following requirements must also be satisfied in relation to each window and glazed door:		~	~
Each window or glazed door with standard aluminium or timber frames and single clear or toned glass may either match the description, or, have a U-value and a Solar Heat Gain Coefficient (SHGC) no greater than that listed in the table below. Total system U-values and SHGCs must be calculated in accordance with National Fenestration Rating Council (NFRC) conditions.		~	~
Each window or glazed door with improved frames, or pyrolytic low-e glass, or clear/air gap/clear glazing, or toned/air gap/clear glazing must have a U-value and a Solar Heat Gain Coefficient (SHGC) no greater than that listed in the table below. Total system U-values and SHGCs must be calculated in accordance with National Fenestration Rating Council (NFRC) conditions. The description is provided for information only. Alternative systems with complying U-value and SHGC may be substituted.		~	~
For projections described in millimetres, the leading edge of each eave, pergola, verandah, balcony or awning must be no more than 500 mm above the head of the window or glazed door and no more than 2400 mm above the sill.	~	~	~
For projections described as a ratio, the ratio of the projection from the wall to the height above the window or glazed door sill must be at least that shown in the table below.	~	~	~
Pergolas with polycarbonate roof or similar translucent material must have a shading coefficient of less than 0.35.		~	~
External louvres and blinds must fully shade the window or glazed door beside which they are situated when fully drawn or closed.		~	~
Pergolas with fixed battens must have battens parallel to the window or glazed door above which they are situated, unless the pergola also shades a perpendicular window. The spacing between battens must not be more than 50 mm.		~	~
Overshadowing buildings or vegetation must be of the height and distance from the centre and the base of the window and glazed door, as specified in the 'overshadowing' column in the table below.	v	_	-

lazing requir	ements						Show on DA Plans				
indows and gla	zed doors glazing	y requirements									
Window/door number	Orientation	Area of glass including frame (m2)	Overshadowing height (m)	Overshadowing distance (m)	Shading device	Frame and glass type					
D0.3	N	13.85	0	0	external louvre/blind (adjustable)	standard aluminium, single clear, (or U-value: 7.63, SHGC: 0.75)					
D1.1	N	10.75	0	0	eave/ verandah/ pergola/balcony >=900 mm	standard aluminium, single clear, (or U-value: 7.63, SHGC: 0.75)					
D1.2	N	10	0	0	awning (fixed) >=900 mm	standard aluminium, single clear, (or U-value: 7.63, SHGC: 0.75)					
D2.1	NE	8.16	0	0	eave/ verandah/ pergola/balcony >=900 mm	standard aluminium, single clear, (or U-value: 7.63, SHGC: 0.75)					
W2.2	NE	4	0	0	eave/ verandah/ pergola/balcony >=900 mm	standard aluminium, single clear, (or U-value: 7.63, SHGC: 0.75)					

lazing requir	ements						Show on DA Plans	Show on CC/CDC Plans & specs	Certifier Check
Window/door number	Orientation	Area of glass including frame (m2)	Overshadowing height (m)	Overshadowing distance (m)	Shading device	Frame and glass type			
W2.10	NE	2	0	0	awning (fixed) >=900 mm	standard aluminium, single clear, (or U-value: 7.63, SHGC: 0.75)			
W0.1	E	3.96	0	0	external louvre/ blind (fixed)	standard aluminium, single clear, (or U-value: 7.63, SHGC: 0.75)			
W0.2	E	1.02	0	0	external louvre/blind (adjustable)	standard aluminium, single clear, (or U-value: 7.63, SHGC: 0.75)			
W0.3	E	0.9	7.2	7	projection/ height above sill ratio >=0.23	standard aluminium, single clear, (or U-value: 7.63, SHGC: 0.75)			
W0.4	E	0.9	7.2	7	projection/ height above sill ratio >=0.23	standard aluminium, single clear, (or U-value: 7.63, SHGC: 0.75)			

Blazing requir			Show on DA Plans	Show on CC/CDC Plans & specs	Certifie Check				
Vindows and gla	zed doors glazing	g requirements							
Window/door number	Orientation	Area of glass including frame (m2)	Overshadowing height (m)	Overshadowing distance (m)	Shading device	Frame and glass type			
W0.5	E	2.04	0	0	external louvre/blind (adjustable)	standard aluminium, single clear, (or U-value: 7.63, SHGC: 0.75)			
D0.4	E	3.84	0	0	external louvre/blind (adjustable)	standard aluminium, single clear, (or U-value: 7.63, SHGC: 0.75)			
W1.1	E	1.26	0	0	external louvre/ blind (fixed)	standard aluminium, single clear, (or U-value: 7.63, SHGC: 0.75)			
W1.2	E	1.26	0	0	external louvre/ blind (fixed)	standard aluminium, single clear, (or U-value: 7.63, SHGC: 0.75)			
W1.3	Е	0.9	0	0	eave/ verandah/ pergola/balcony >=450 mm	standard aluminium, toned/air gap/ clear, (U-value: 5.31, SHGC: 0.48)			

lazing requir	ements						Show on DA Plans	Show on CC/CDC Plans & specs	Certifier Check
Window/door number	Orientation	Area of glass including frame (m2)	Overshadowing height (m)	Overshadowing distance (m)	Shading device	Frame and glass type			
W2.11	E	2.65	0	0	eave/ verandah/ pergola/balcony >=750 mm	standard aluminium, clear/air gap/ clear, (U-value: 5.34, SHGC: 0.67)			
W2.1	SE	1.07	0	0	eave/ verandah/ pergola/balcony >=900 mm	standard aluminium, single clear, (or U-value: 7.63, SHGC: 0.75)			
W1.7	s	0.93	0	0	eave/ verandah/ pergola/balcony >=900 mm	standard aluminium, single clear, (or U-value: 7.63, SHGC: 0.75)			
W2.4	s	4.32	0	0	eave/ verandah/ pergola/balcony >=600 mm	standard aluminium, single clear, (or U-value: 7.63, SHGC: 0.75)			
W1.8	W	0.55	0	0	eave/ verandah/ pergola/balcony >=900 mm	standard aluminium, single clear, (or U-value: 7.63, SHGC: 0.75)			

Glazing requir	ements		Show on DA Plans	Show on CC/CDC Plans & specs	Certifier Check				
Windows and gla	s and glazed doors glazing requirements								
Window/door number	Orientation	Area of glass including frame (m2)	Overshadowing height (m)	Overshadowing distance (m)	Shading device	Frame and glass type			
W1.9	W	1.35	0	0	eave/ verandah/ pergola/balcony >=900 mm	standard aluminium, single clear, (or U-value: 7.63, SHGC: 0.75)			
W2.5	NW	1.2	0	0	external louvre/blind (adjustable)	standard aluminium, single clear, (or U-value: 7.63, SHGC: 0.75)			
W2.6	NW	1.2	0	0	external louvre/blind (adjustable)	standard aluminium, single clear, (or U-value: 7.63, SHGC: 0.75)			
W2.8	NW	1.26	0	0	eave/ verandah/ pergola/balcony >=450 mm	aluminium, single Lo- Tsol low-e, (U-value: 5.6, SHGC: 0.36)			
W2.9	NW	1.89	0	0	eave/ verandah/ pergola/balcony >=450 mm	aluminium, single Lo- Tsol low-e, (U-value: 5.6, SHGC: 0.36)			

Blazing requir	ements						Show on DA Plans	Show on CC/CDC Plans & specs	Certifier Check
Window/door number	Orientation	Area of glass including frame (m2)	Overshadowing height (m)	Overshadowing distance (m)	Shading device	Frame and glass type			
D2.2	S	11.34	0	0	eave/ verandah/ pergola/balcony >=600 mm	standard aluminium, single clear, (or U-value: 7.63, SHGC: 0.75)			
W0.6	E	0.85	0	0	external louvre/blind (adjustable)	standard aluminium, single clear, (or U-value: 7.63, SHGC: 0.75)			
W2.7	NW	1.2	0	0	external louvre/blind (adjustable)	standard aluminium, single clear, (or U-value: 7.63, SHGC: 0.75)			
W2.3	Е	3.04	0	0	eave/ verandah/ pergola/balcony >=450 mm	standard aluminium, toned/air gap/ clear, (U-value: 5.31, SHGC: 0.48)			
W0.7	N	1.48	0	0	projection/ height above sill ratio >=0.43	standard aluminium, single clear, (or U-value: 7.63, SHGC: 0.75)			

Glazing require	ements	Show on DA Plans	Show on CC/CDC Plans & specs	Certifier Check					
Windows and glaz	zed doors glazing	requirements							
Window/door number	Orientation	Area of glass including frame (m2)	Overshadowing height (m)	Overshadowing distance (m)	Shading device	Frame and glass type			
W2.12	N	1.71	0	0	projection/ height above sill ratio >=0.43	standard aluminium, single clear, (or U-value: 7.63, SHGC: 0.75)			

Legend
In these commitments, "applicant" means the person carrying out the development.
Commitments identified with a 🔻 in the "Show on DA plans" column must be shown on the plans accompanying the development application for the proposed development (if a development application is to be lodged for the proposed development).
Commitments identified with a 🔻 in the "Show on CCICDC plans & specs" column must be shown in the plans and specifications accompanying the application for a construction certificate / complying development certificate for the proposed development.
Commitments identified with a 🗸 in the "Certifier check" column must be certified by a certifying authority as having been fulfilled, before a final occupation certificate for the development may be issued.

NOT FOR CONSTRUCTION

118

MACCORMICK + ASSOCIATES ARCHITECTS, 13 VICTORIA STREET QUEENS PARK NSW 2022

T 9037 0437 E hello@maccormickarchitects.com.au ACN 147 572 807 ARCHITECT REG 6702

THE BUILDER SHALL CHECK & VERIFY ALL DIMENSIONS & VERIFY ALL ERRORS AND OMISSIONS TO THE ARCHITECT. CONTRACTOR TO REPORT DISCREPANCIES IMMEDIATELY. THIS DRAWING IS TO BE USED IN CONJUNCTION WITH ALL RELEVANT CONTRACTS. DO NOT SCALE OFF DRAWINGS. BRAWINGS SHALL NOT BE USED FOR CONSTRUCTION PURPOSES UNTIL ISSUED BY THE ARCHITECT FOR CONSTRUCTION. THIS DRAWING IS COPYRIGHT AND MAY NOT BE USED WITHOUT WRITTEN CONSENT FROM THE ARCHITECT

PROJECT
BIRDWOOD
Matthew & Shona Adamo
1 Birdwood Ave Collaroy NSW 2097

DRAWING TITLE
BASIX

DRAWING STATUS

DEVELOPMENT APPLICATION

DA00.3


Α



BK - LIGHT COLOURED BAGGING TO EXISTING BRICKWORK




MR - MEDIUM GREY COLOUR METAL ROOF WITH SAME COLOUR WALLS

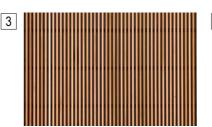

TB - TIMBER BATTEN SCREENS + ROOF SOFFIT



VS GLASS BALUSTRADE ON TOP OF BRICK WALL

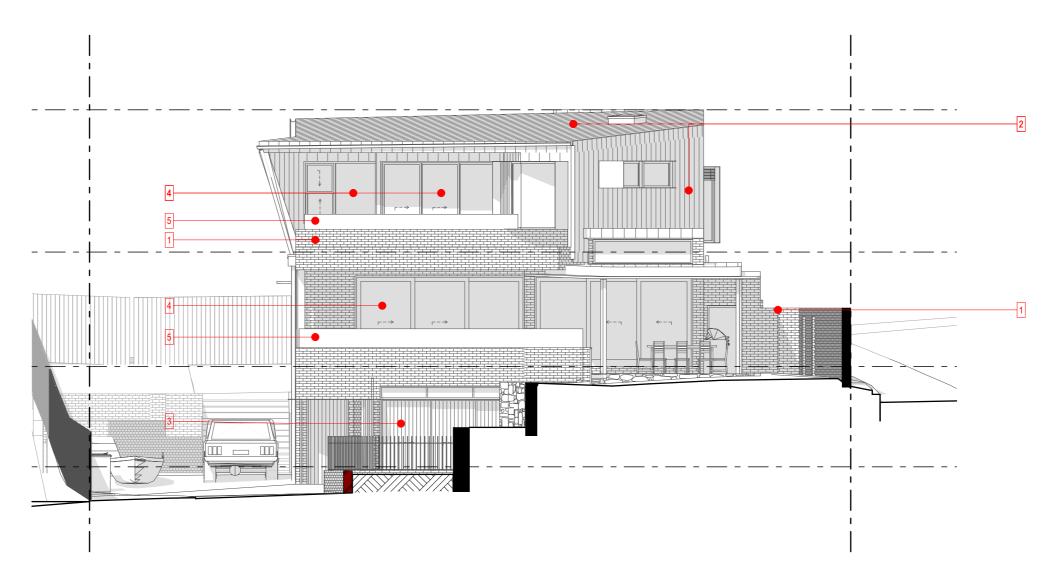

NORTH ELEVATION - MATERIALS & FINISHES
1:100



MACCORMICK + ASSOCIATES ARCHITECTS, 13 VICTORIA STREET QUEENS PARK NSW 2022
T 9037 0437 E hello@maccormickarchitects.com.au

ACN 147 572 807
ARCHITECT REG 6702
THE BUILDER SHALL CHECK & VERIFY ALL DIMENSIONS & VERIFY ALL ERRORS AND OMISSIONS TO THE ARCHITECT. CONTRACTOR TO REPORT DISCREPANCIES IMMEDIATELY. THIS DRAWING IS TO BE USED IN CONJUNCTION WITH ALL RELEVANT CONTRACTS. DO NOT SCALE OFF DRAWINGS. DRAWINGS SHALL NOT BE USED FOR CONSTRUCTION PURPOSES UNTIL ISSUED BY THE ARCHITECT FOR CONSTRUCTION.
THIS DRAWING IS COPYRIGHT AND MAY NOT BE USED WITHOUT WRITTEN CONSENT FROM THE ARCHITECT

PROJECT
BIRDWOOD
Matthew & Shona Adamo

1 Birdwood Ave Collaroy NSW 2097


DRAWING TITLE
SCHEDULE OF MATERIALS AND
FINISHES


DEVELOPMENT APPLICATION

NOT FOR CONSTRUCTION

DA00.4



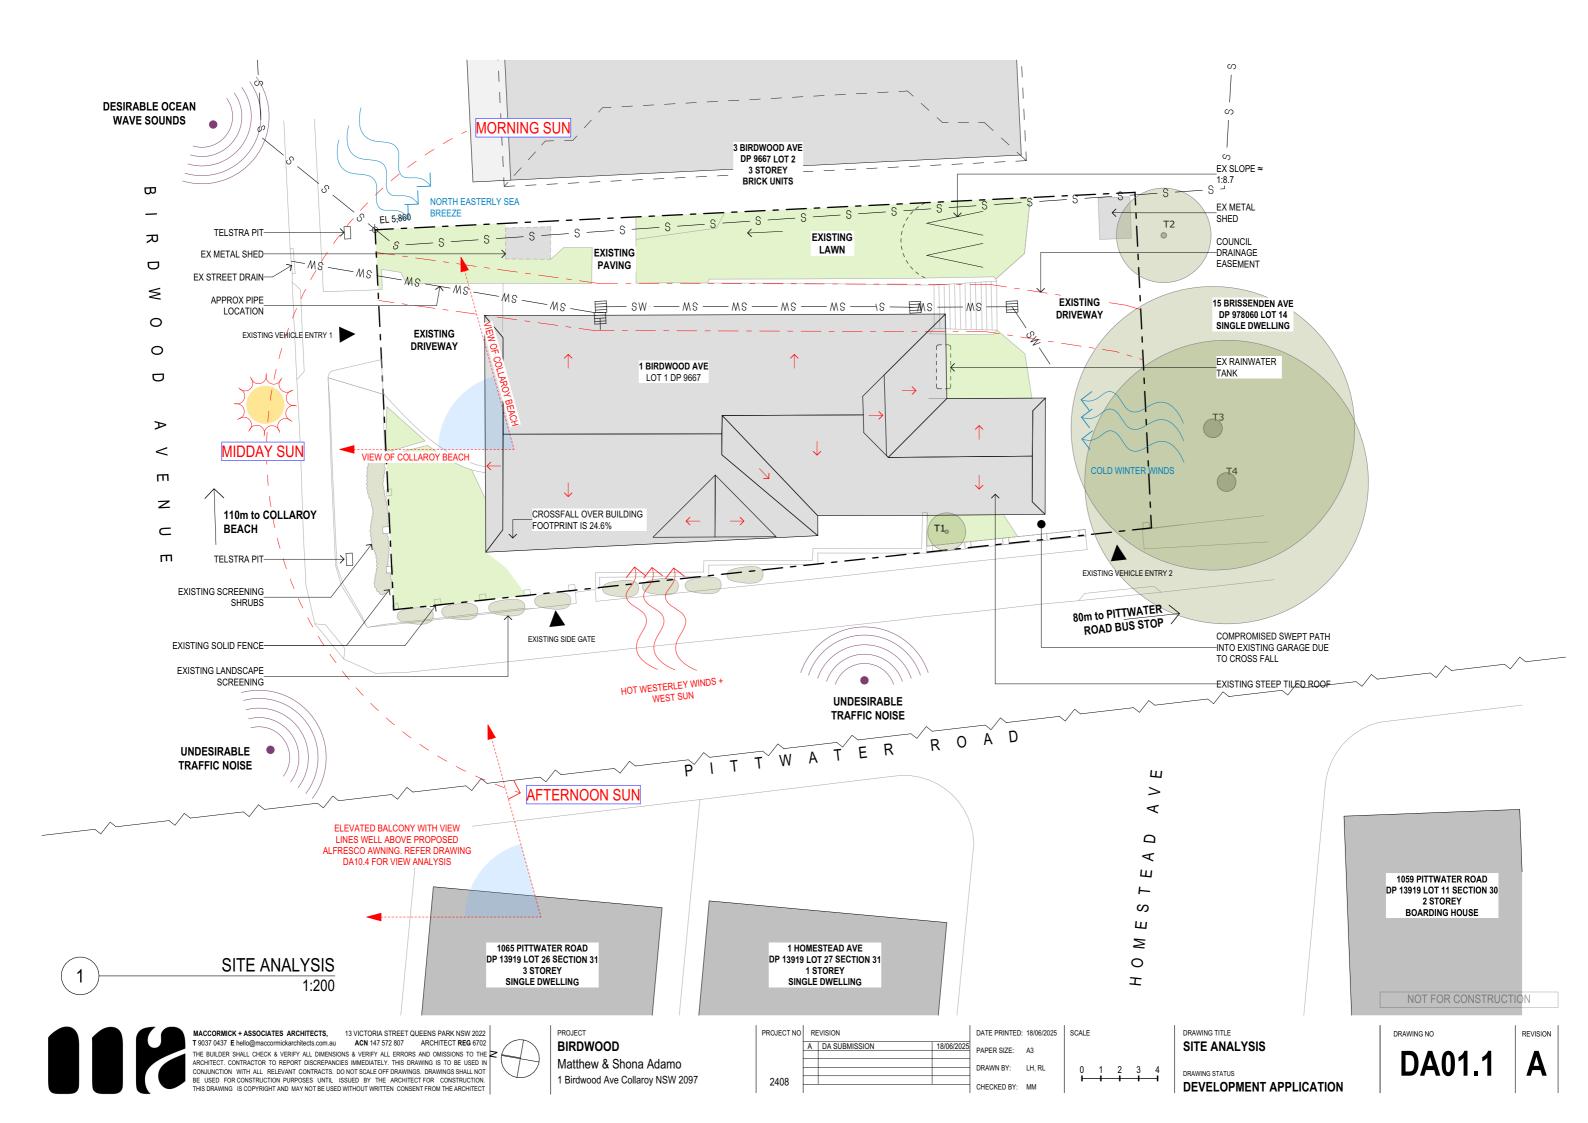

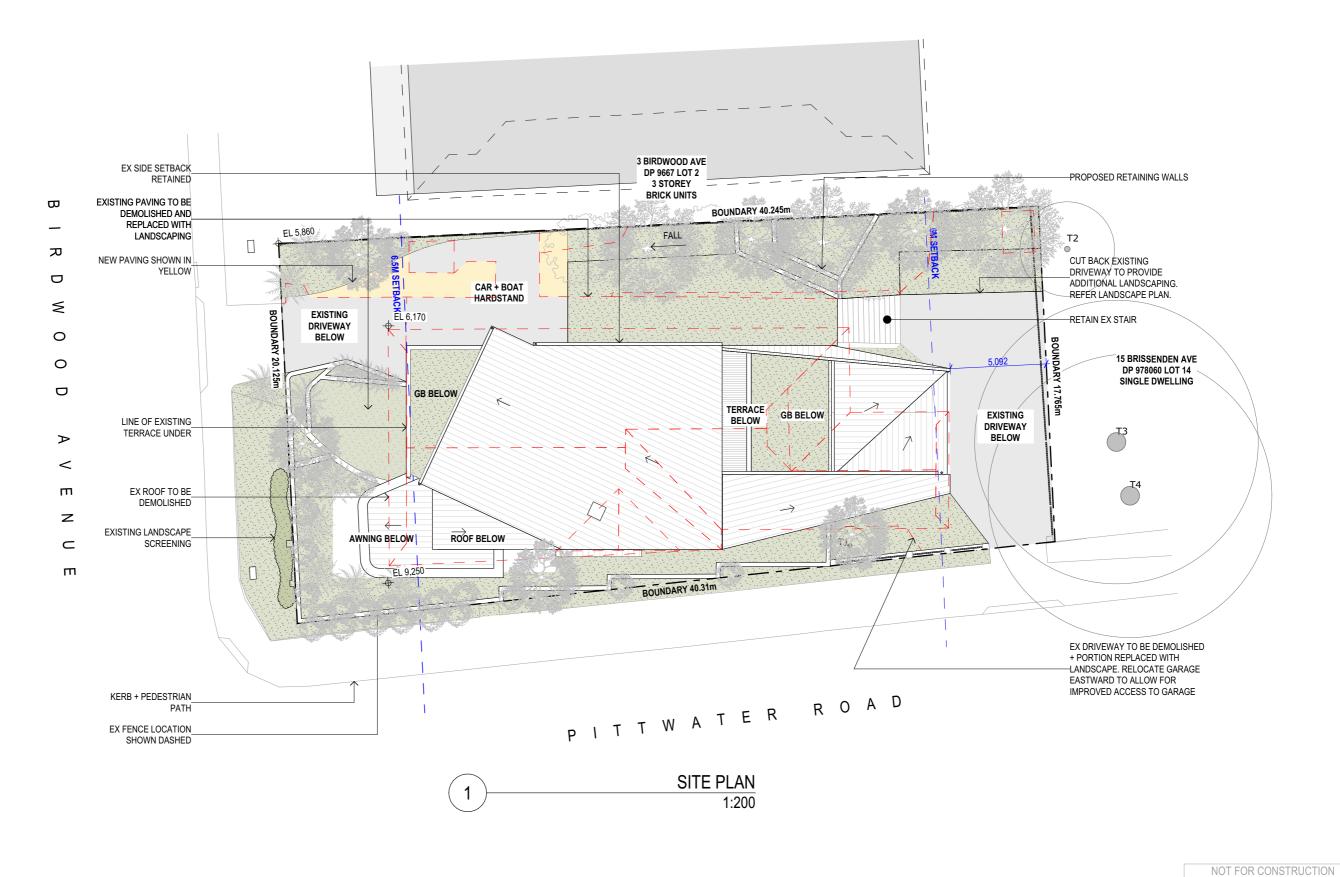

118

MACCORMICK + ASSOCIATES ARCHITECTS, 13 VICTORIA STREET QUEENS PARK NSW 2022
T 9037 0437 E hello@maccormickarchitects.com.au ACN 147 572 807 ARCHITECT REG 6702
THE BUILDER SHALL CHECK & VERIFY ALL DIMENSIONS & VERIFY ALL ERRORS AND OMISSIONS TO THE ARCHITECT. CONTRACTOR TO REPORT DISCREPANCIES IMMEDIATELY. THIS DRAWING IS TO BE USED IN CONJUNCTION WITH ALL RELEVANT CONTRACTS. DO NOT SCALE OFF DRAWINGS. DRAWINGS SHALL NOT BE USED FOR CONSTRUCTION. PURPOSES UNTIL ISSUED BY THE ARCHITECT FOR CONSTRUCTION. THIS DRAWING IS COPYRIGHT AND MAY NOT BE USED WITHOUT WRITTEN CONSENT FROM THE ARCHITECT

HE Z

BIRDWOOD

Matthew & Shona Adamo

1 Birdwood Ave Collaroy NSW 2097

0 1 2 3 4


DRAWING TITLE
SITE PLAN

DRAWING STATUS

DEVELOPMENT APPLICATION

DRAWING NO REVISION

DA01.2

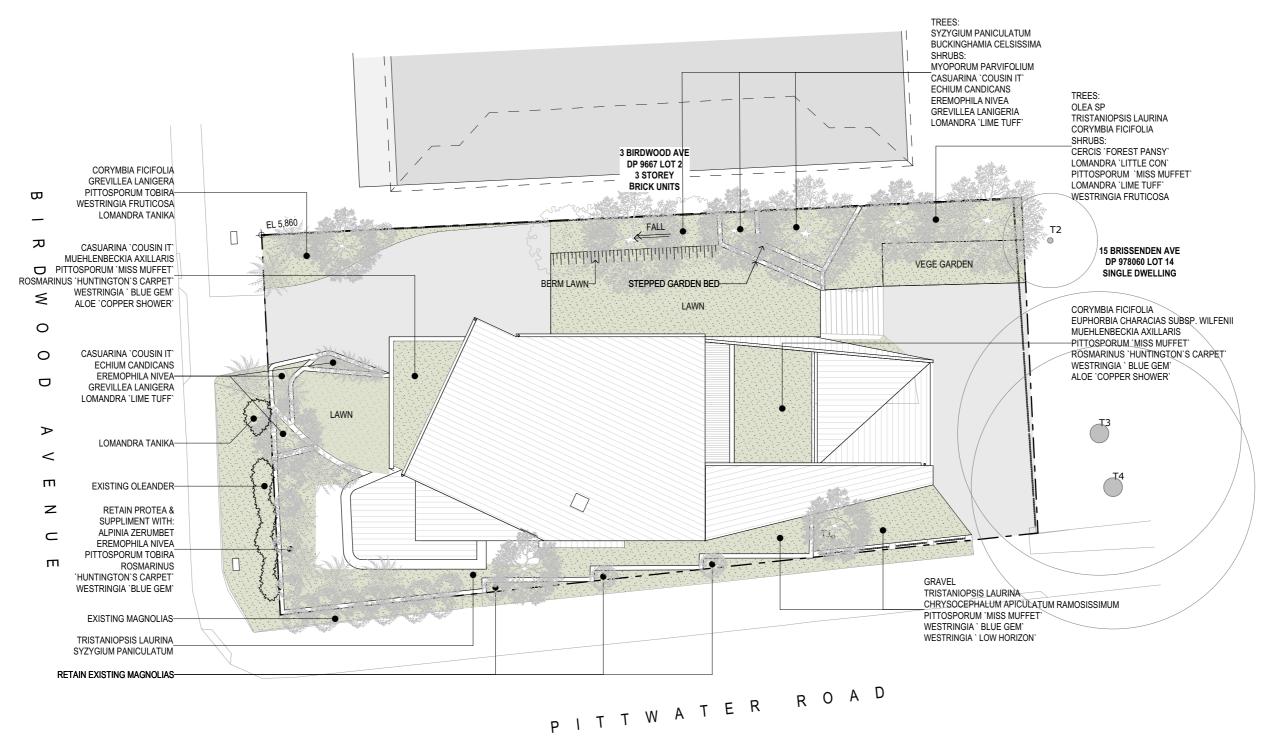

1 LANDSCAPE PLAN 1:200

MACCORMICK + ASSOCIATES ARCHITECTS, 13 VICTORIA STREET QUEENS PARK NSW 2022
T 9037 0437 E hello@maccormickarchitects.com.au ACN 147 572 807 ARCHITECT REG 6702
THE BUILDER SHALL CHECK & VERIFY ALL DIMENSIONS & VERIFY ALL ERRORS AND OMISSIONS TO THE ARCHITECT. CONTRACTOR TO REPORT DISCREPANCIES IMMEDIATELY. THIS DRAWING IS TO BE USED IN CONJUNCTION WITH ALL RELEVANT CONTRACTS. DO NOT SCALE OFF DRAWINGS. DRAWINGS SHALL NOT BE USED FOR CONSTRUCTION. PURPOSES UNTIL ISSUED BY THE ARCHITECT FOR CONSTRUCTION. THIS DRAWING IS COPYRIGHT AND MAY NOT BE USED WITHOUT WRITTEN CONSENT FROM THE ARCHITECT

2

PROJECT
BIRDWOOD
Matthew & Shona Adamo
1 Birdwood Ave Collaroy NSW 2097

SCALE 1:200 0 1 2 3 4

DRAWING TITLE

LANDSCAPE PLAN


DRAWING STATUS


DEVELOPMENT APPLICATION


NOT FOR CONSTRUCTION


DRAWING NO REVISION


DA01.3

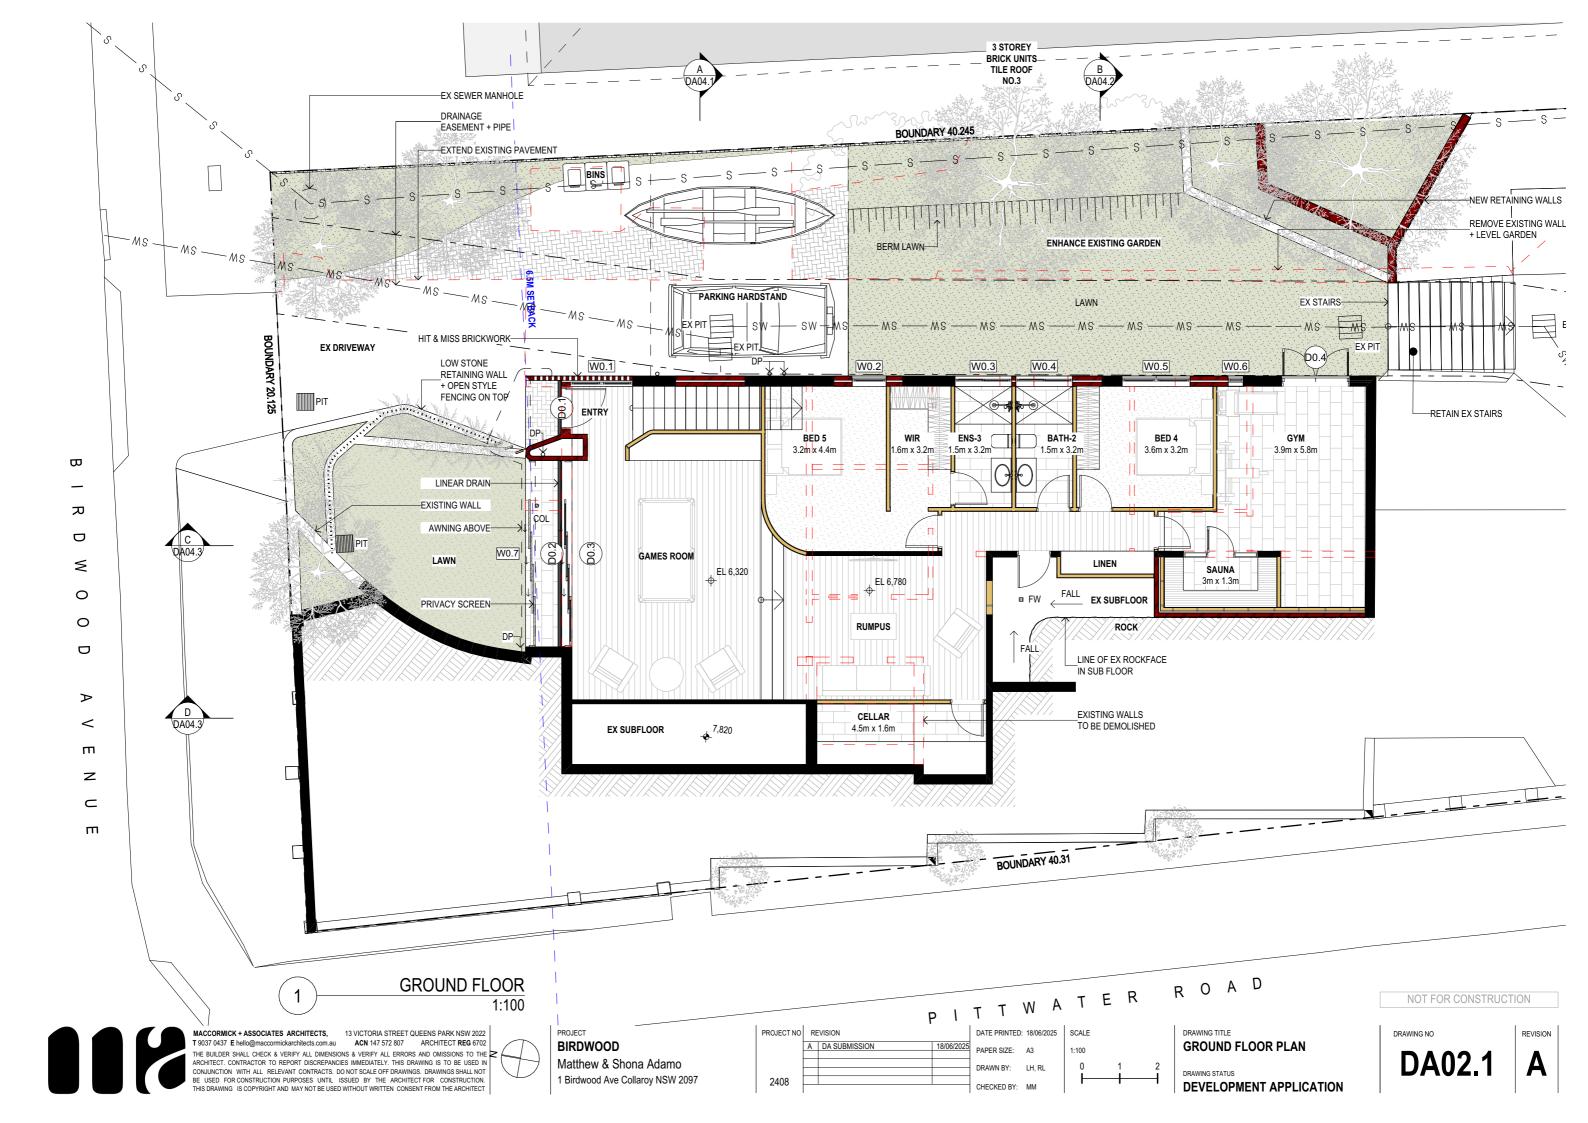


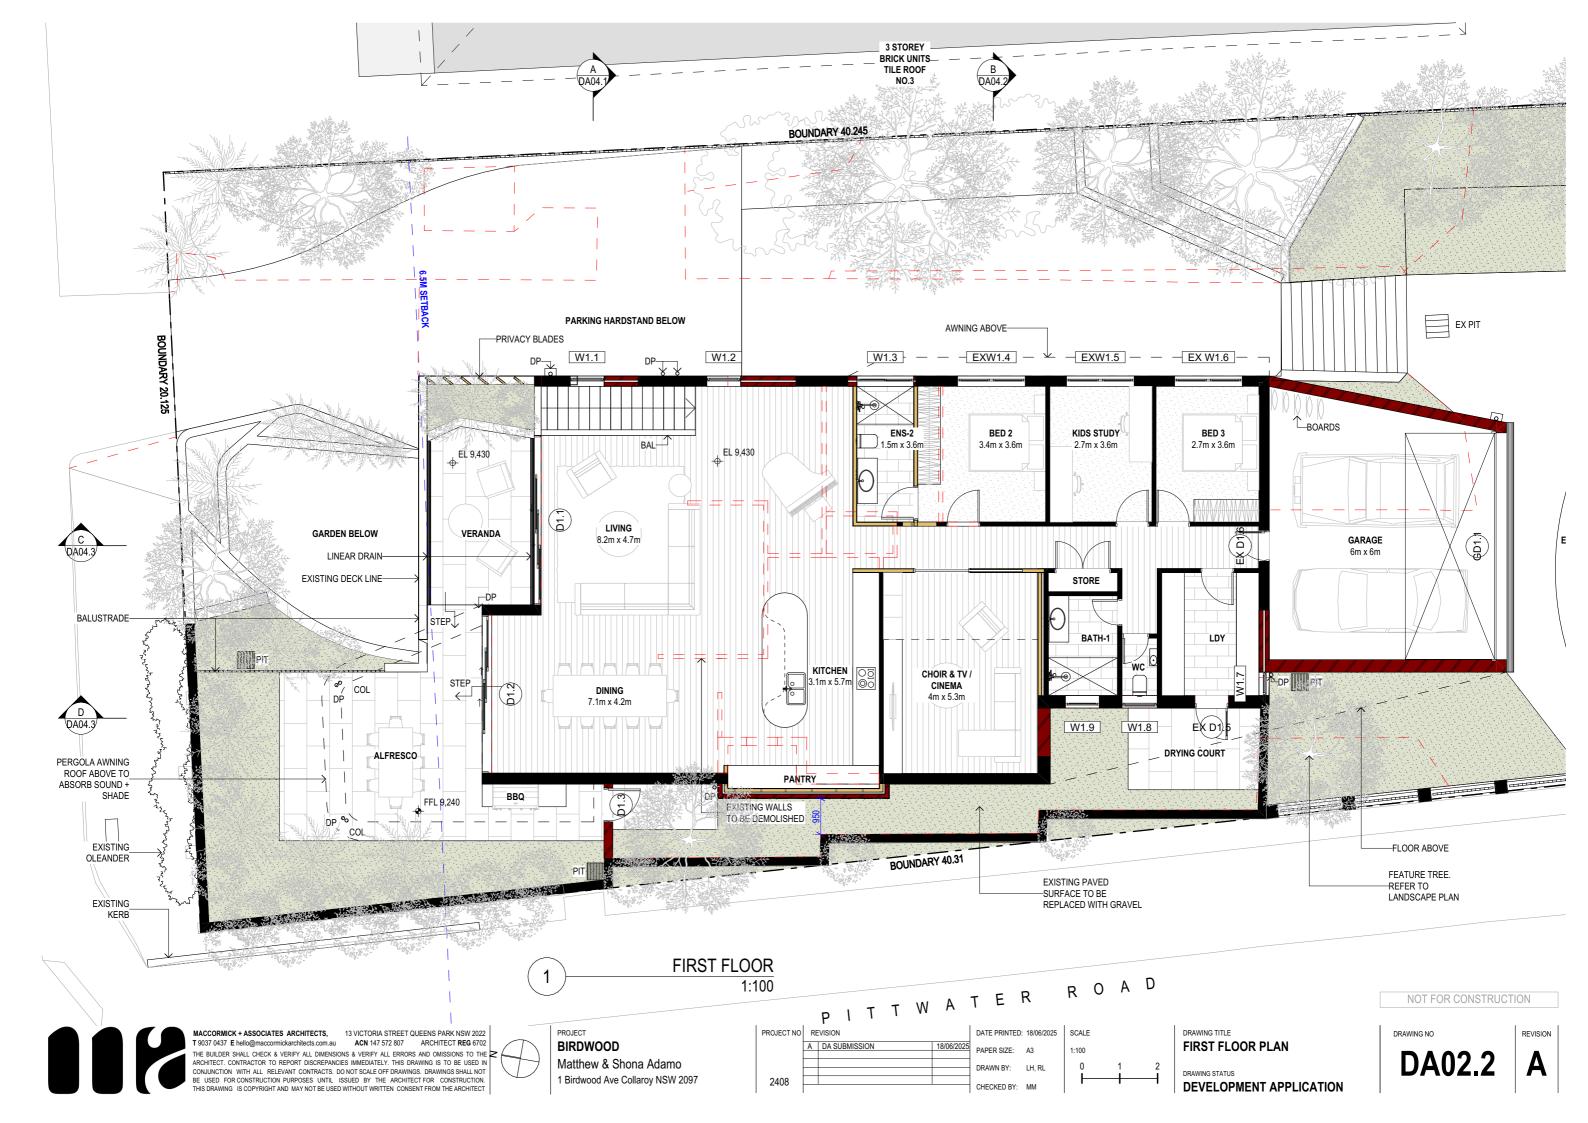


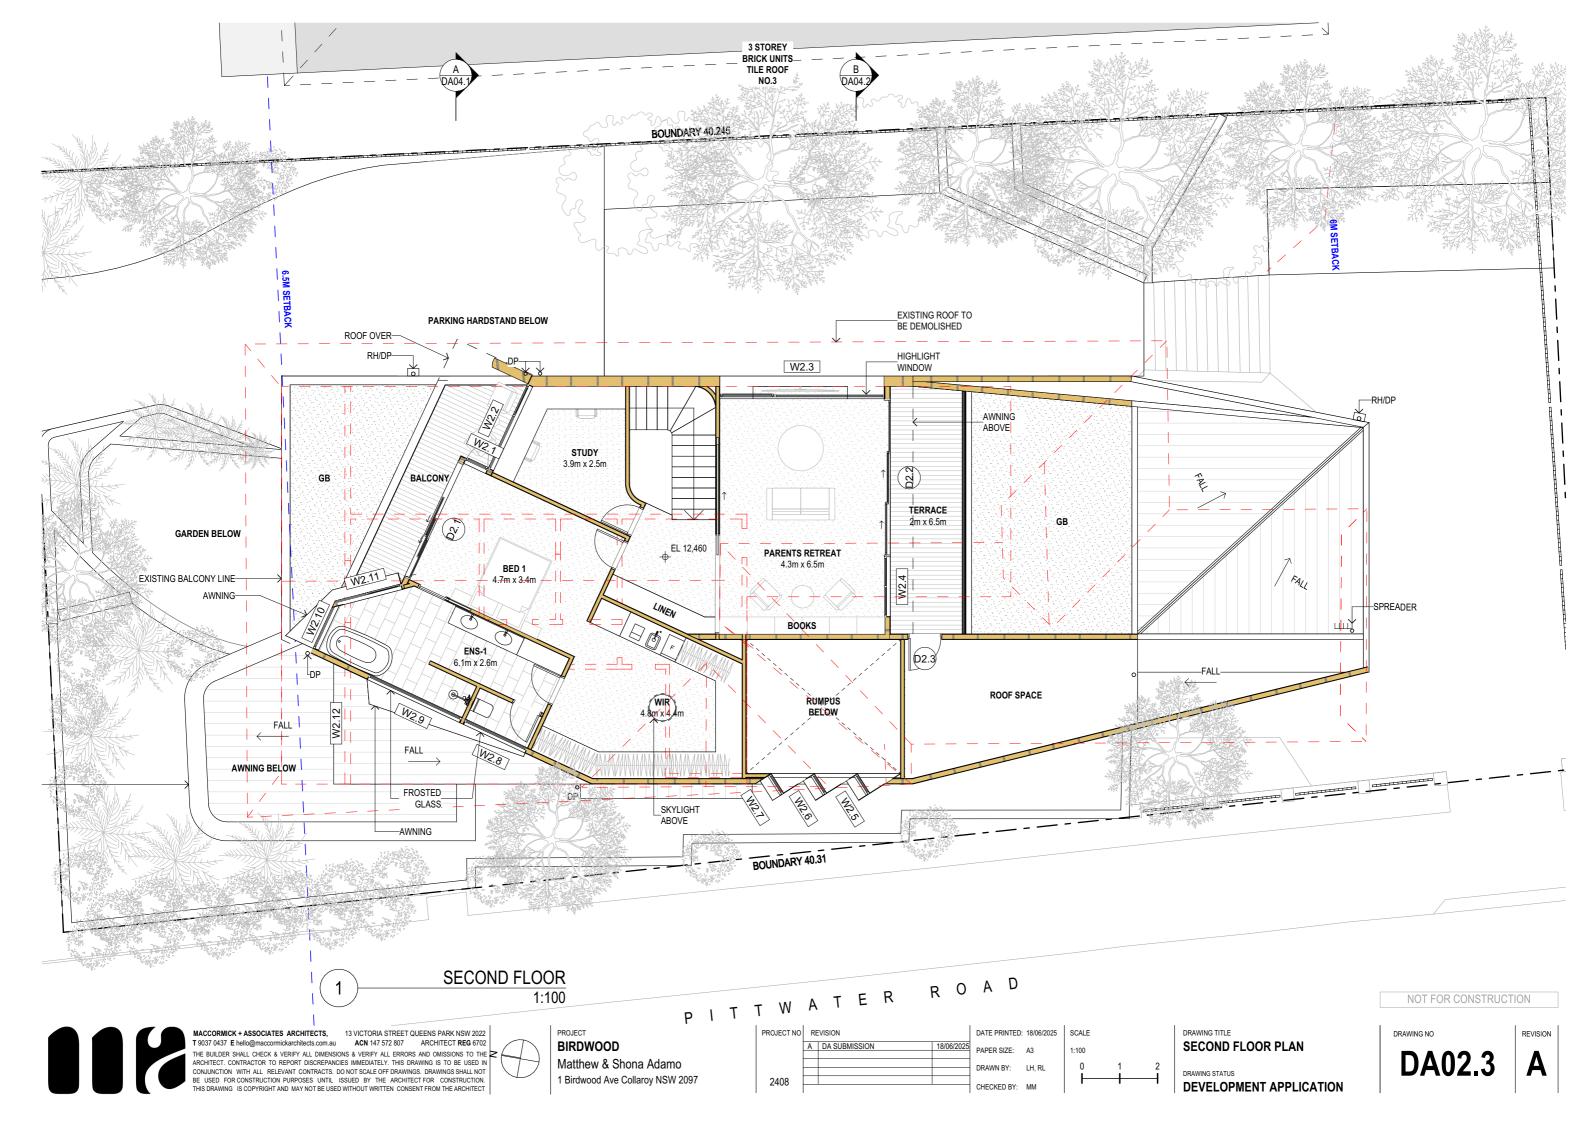

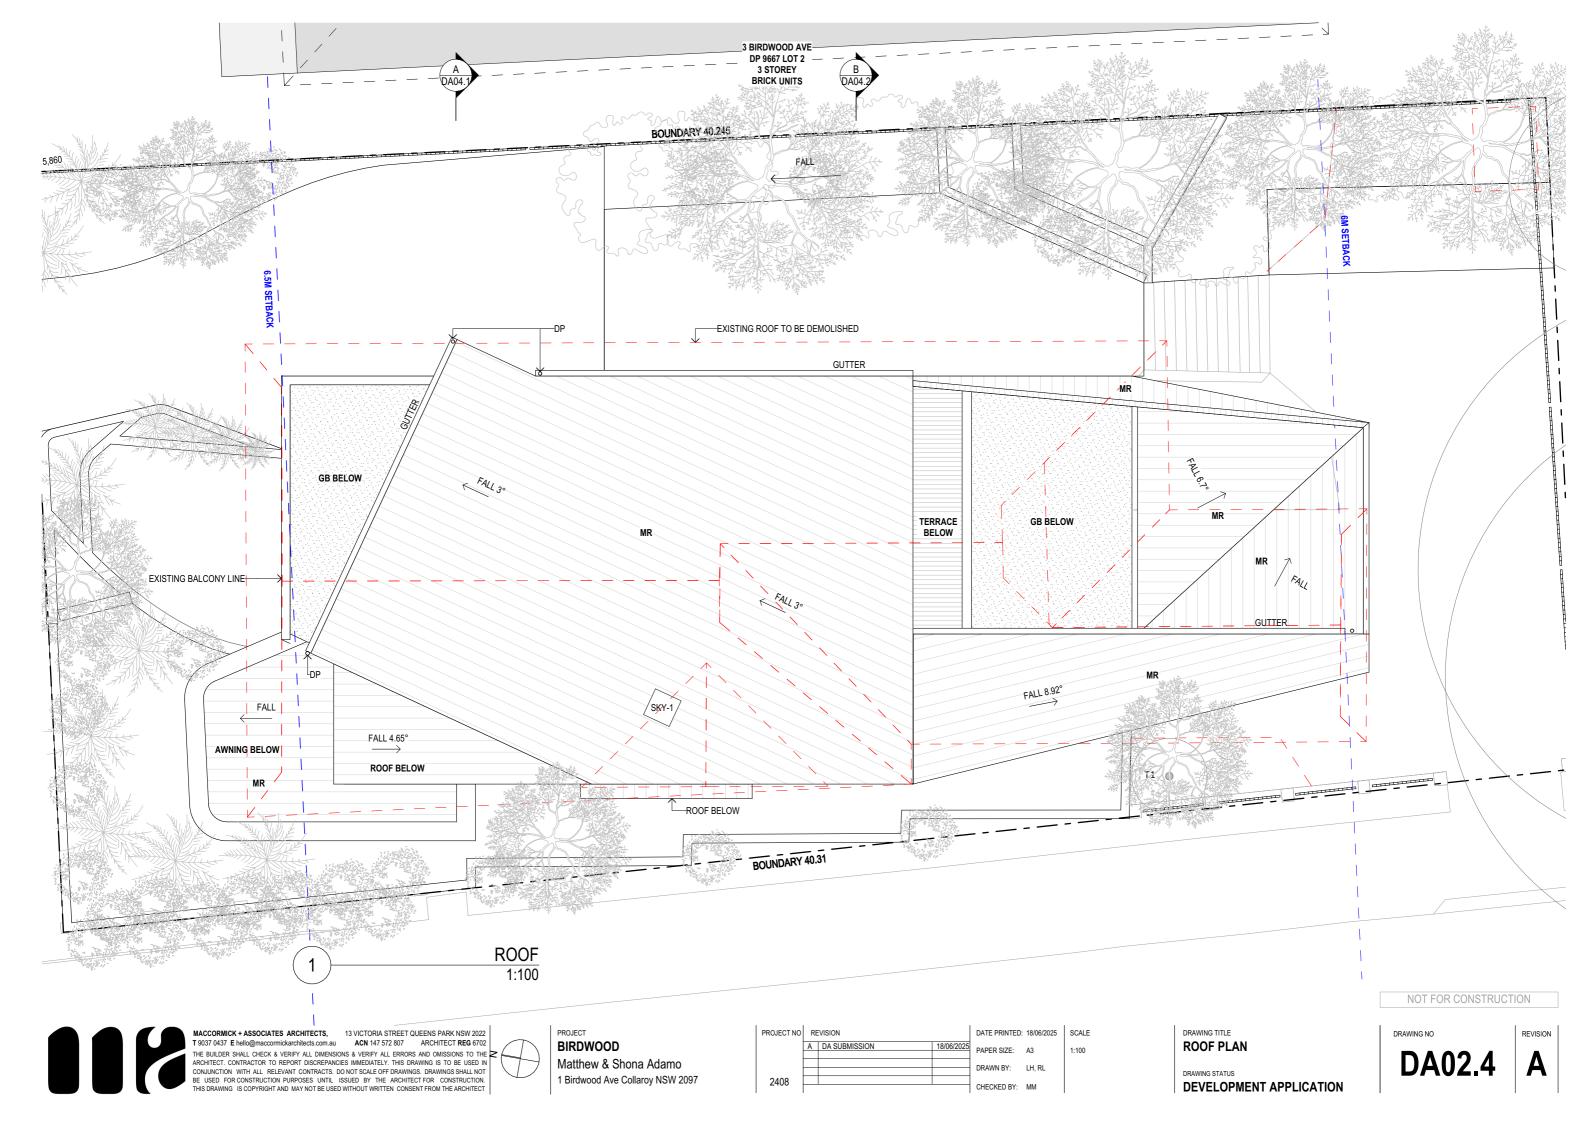

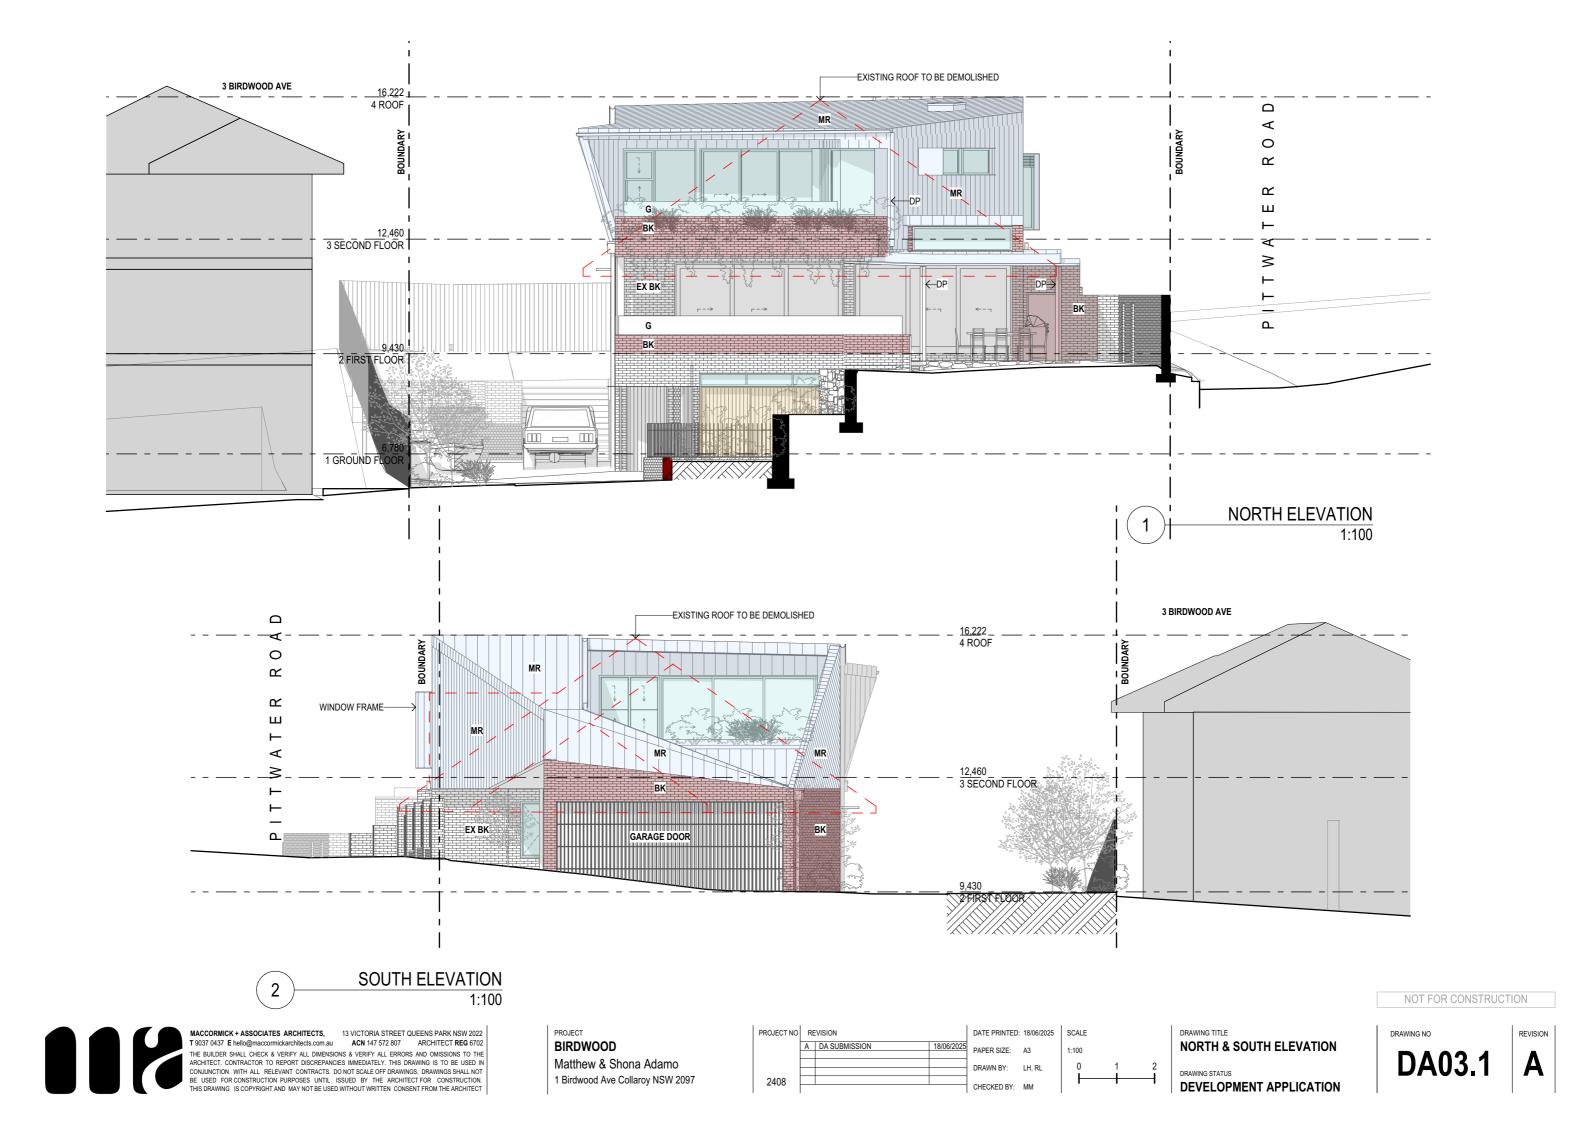

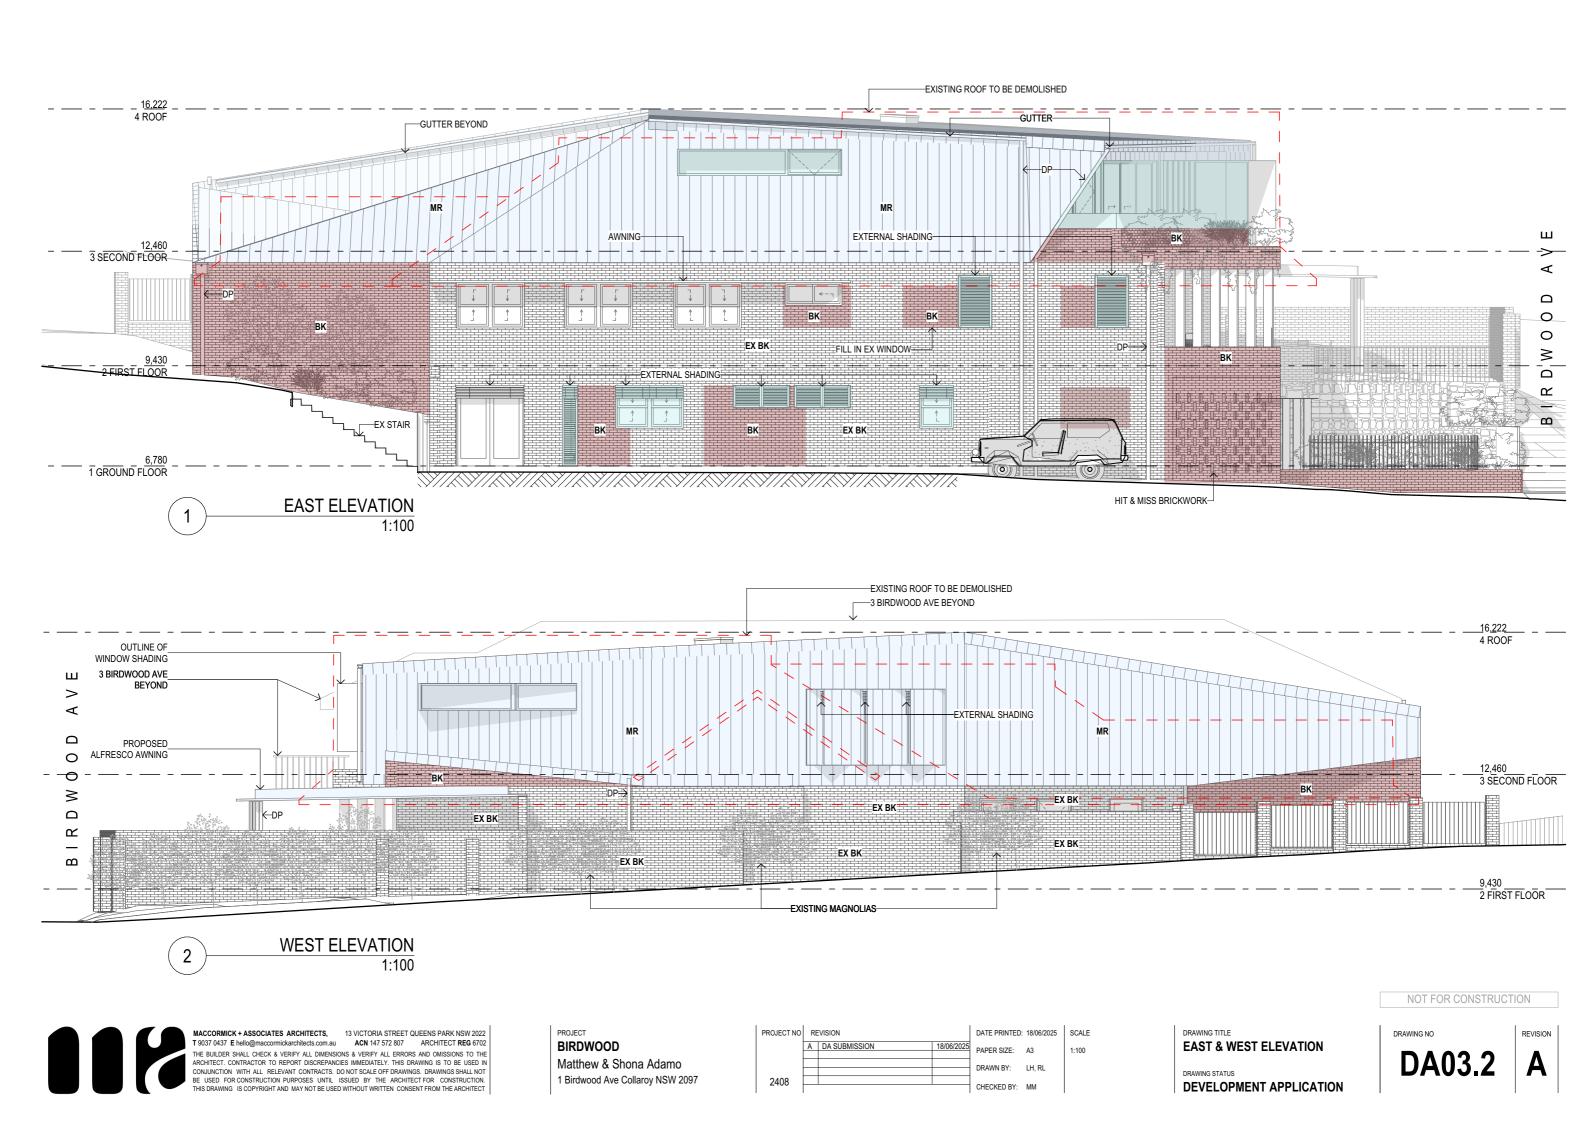

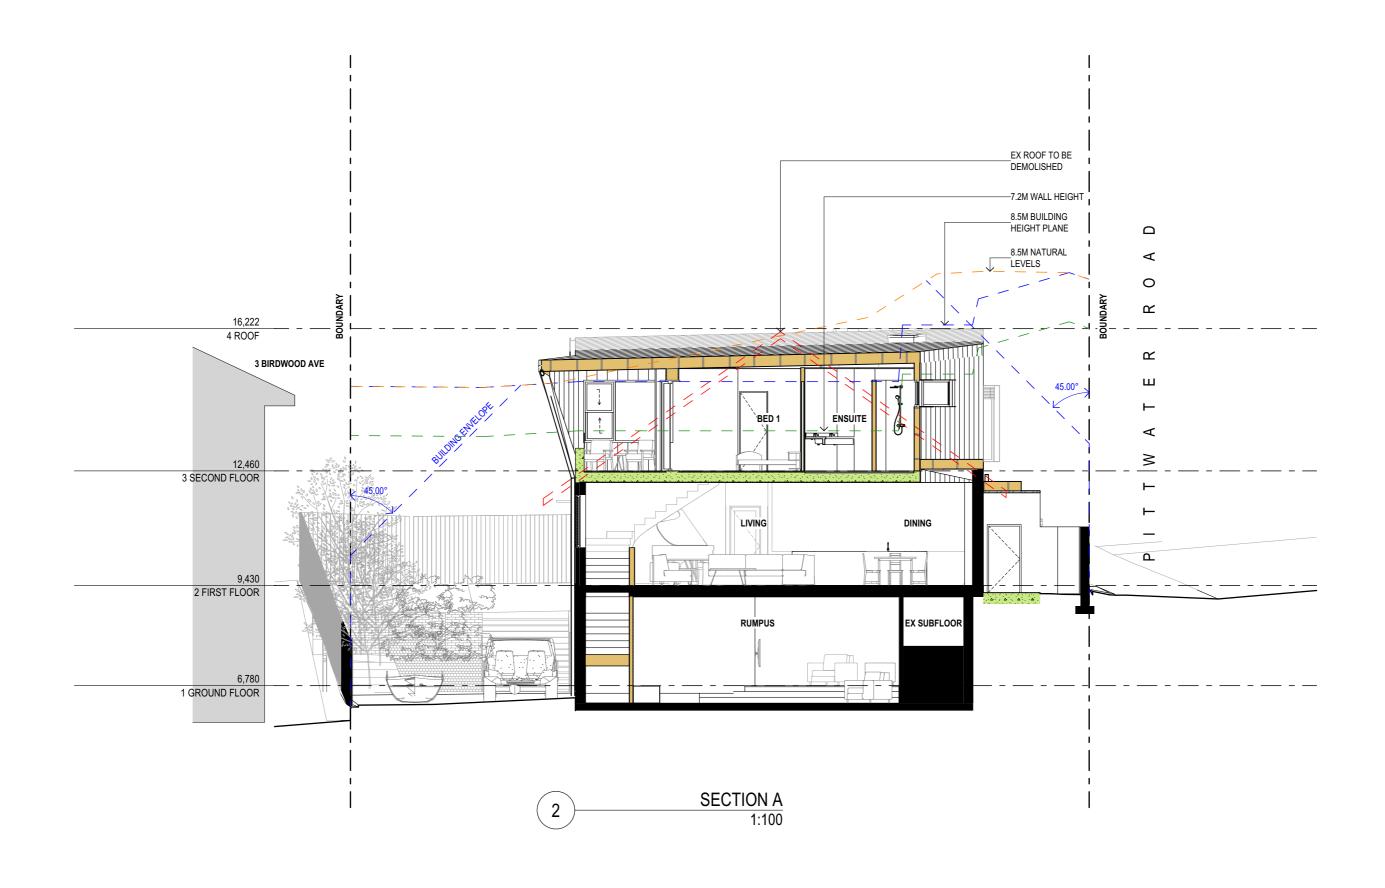

MACCORMICK + ASSOCIATES ARCHITECTS,

13 VICTORIA STREET QUEENS PARK NSW 2022
T 9037 0437 E hello@maccomickarchitects.com.au


ACN 147 572 807

ARCHITECT REG 6702
THE BUILDER SHALL CHECK & VERIFY ALL DIMENSIONS & VERIFY ALL ERRORS AND OMISSIONS TO THE ARCHITECT. CONTRACTOR TO REPORT DISCREPANCIES IMMEDIATELY. THIS DRAWING IS TO BE USED IN CONJUNCTION WITH ALL RELEVANT CONTRACTS. DO NOT SCALE OFF DRAWINGS. DRAWINGS SHALL NOT BE USED FOR CONSTRUCTION. THIS DRAWING IS COPYRIGHT AND MAY NOT BE USED WITHOUT WRITTEN CONSENT FROM THE ARCHITECT

PROJECT **BIRDWOOD** Matthew & Shona Adamo 1 Birdwood Ave Collaroy NSW 2097

PROJECT NO	REVISION			DATE PRINTED:	18/06/2
	Α	DA SUBMISSION	18/06/2025	PAPER SIZE:	A3
				DRAWN BY:	LH, RL
2408				CHECKED BY:	MM

/2025 SCALE DRAWING TITLE **SECTION A** 1:100 DRAWING STATUS DEVELOPMENT APPLICATION NOT FOR CONSTRUCTION REVISION

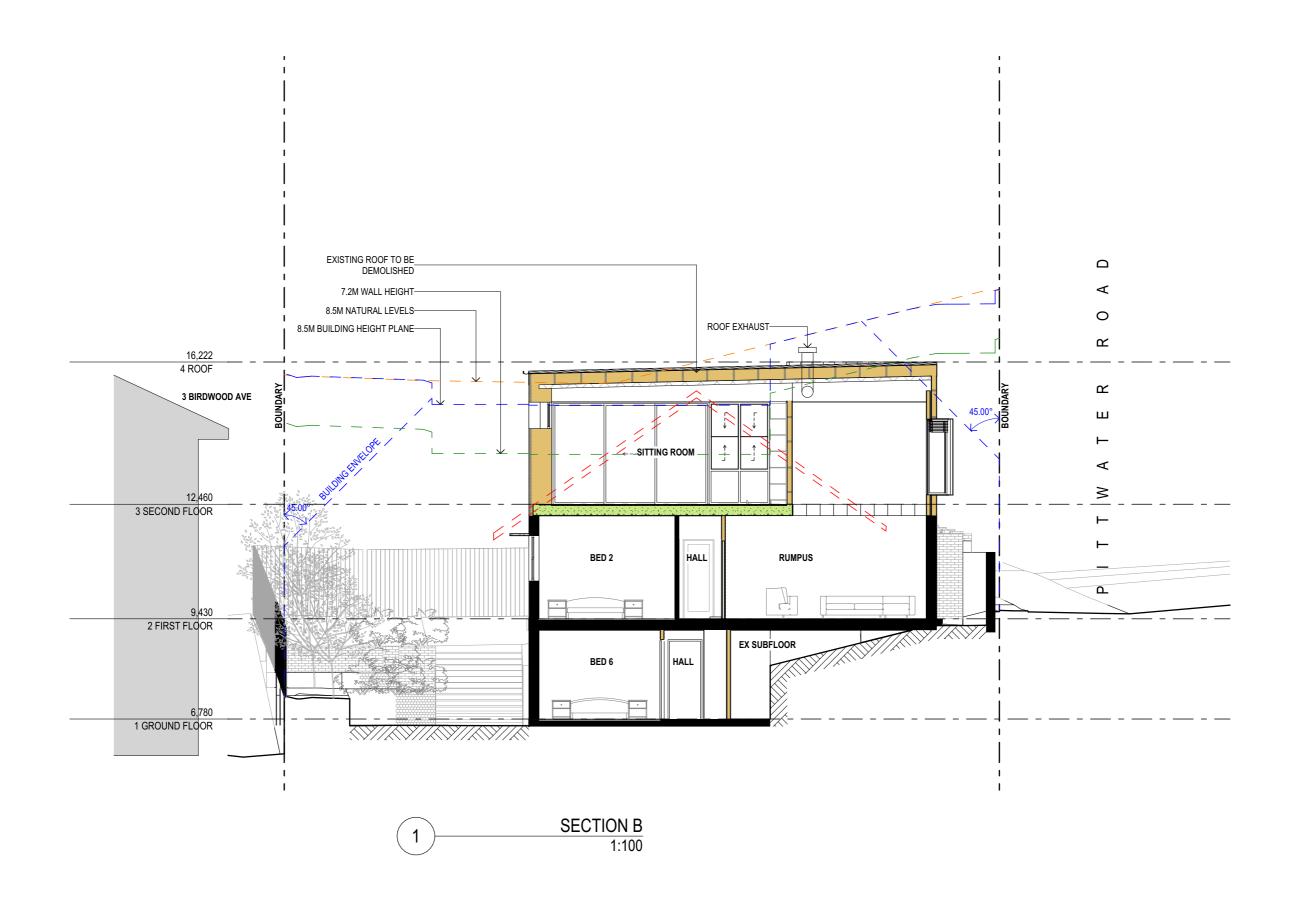

118

MACCORMICK + ASSOCIATES ARCHITECTS, 13 VICTORIA STREET QUEENS PARK NSW 2022
T 9037 0437 E hello@maccormickarchitects.com.au

ACN 147 572 807
ARCHITECT REG 6702
THE BUILDER SHALL CHECK & VERIFY ALL DIMENSIONS & VERIFY ALL ERRORS AND OMISSIONS TO THE ARCHITECT. CONTRACTOR TO REPORT DISCREPANCIES IMMEDIATELY. THIS DRAWING IS TO BE USED IN CONJUNCTION WITH ALL RELEVANT CONTRACTS. DO NOT SCALE OFF DRAWINGS. DRAWINGS SHALL NOT BE USED FOR CONSTRUCTION PURPOSES UNTIL ISSUED BY THE ARCHITECT FOR CONSTRUCTION.
THIS DRAWING IS COPYRIGHT AND MAY NOT BE USED WITHOUT WRITTEN CONSENT FROM THE ARCHITECT

BIRDWOOD

Matthew & Shona Adamo

1 Birdwood Ave Collaroy NSW 2097


DRAWING TITLE
SECTION B
DRAWING STATUS
DEVELOPMENT APPLICATION


DRAWING NO REVISION

NOT FOR CONSTRUCTION

DA04.2

A

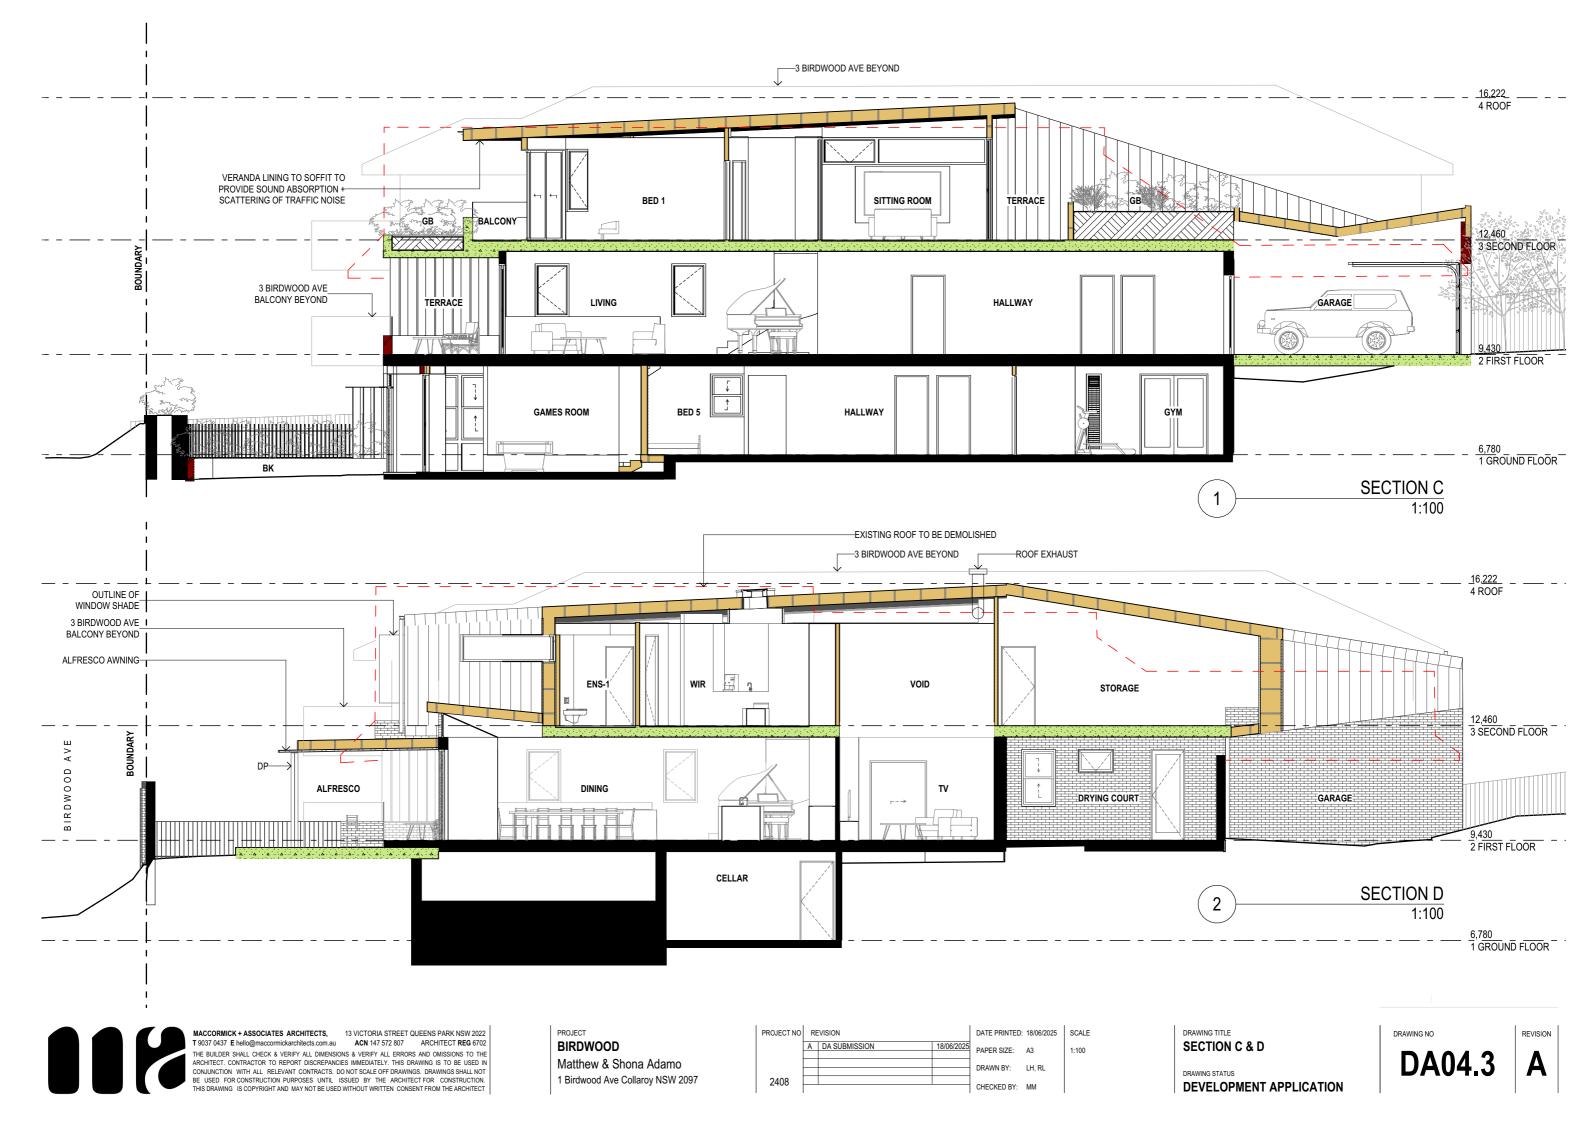

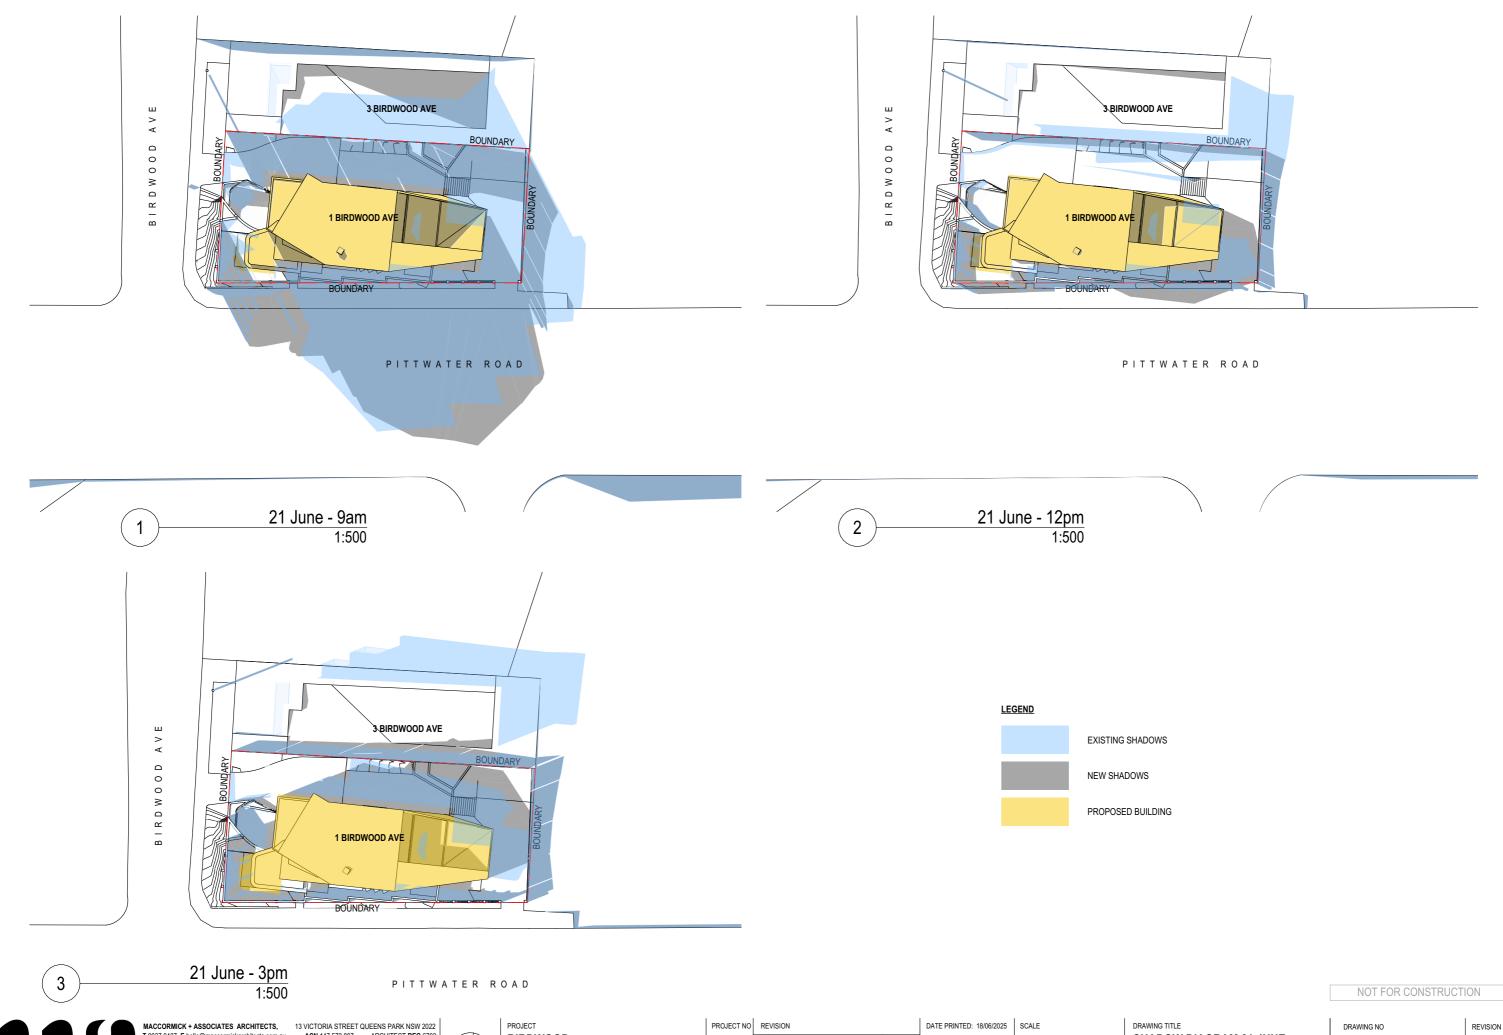



BIRDWOOD Matthew & Shona Adamo

1 Birdwood Ave Collaroy NSW 2097

A DA SUBMISSION 18/06/2025 2408

1:500 PAPER SIZE: A3 DRAWN BY: LH, RL CHECKED BY: MM

SHADOW DIAGRAM 21 JUNE 9AM/12PM/3PM DEVELOPMENT APPLICATION

DA09.





BUILDING HEIGHT PLANE SOUTH - 8.5M



BUILDING HEIGHT PLANE - 8.5M NATURAL LEVELS

MACCORMICK + ASSOCIATES ARCHITECTS, 13 VICTORIA STREET QUEENS PARK NSW 2022

T 9037 0437 E hello@maccormickarchitects.com.au ACM 147 572 807 ARCHITECT REG 6702

THE BUILDER SHALL CHECK & VERIFY ALL DIMENSIONS & VERIFY ALL ERRORS AND OMISSIONS TO THE ARCHITECT. CONTRACTOR TO REPORT DISCREPANCIES IMMEDIATELY. THIS DRAWING IS TO BE USED IN CONJUNCTION WITH ALL RELEVANT CONTRACTS. DO NOT SCALE OFF DRAWINGS. DRAWINGS SHALL NOT BE USED FOR CONSTRUCTION PURPOSES UNTIL ISSUED BY THE ARCHITECT FOR CONSTRUCTION. THIS DRAWING IS COPYRIGHT AND MAY NOT BE USED WITHOUT WRITTEN CONSENT FROM THE ARCHITECT

PROJECT **BIRDWOOD** Matthew & Shona Adamo

1 Birdwood Ave Collaroy NSW 2097

A DA SUBMISSION 2408


PROJECT NO REVISION DATE PRINTED: 18/06/2025 | SCALE PAPER SIZE: A3 DRAWN BY: LH, RL CHECKED BY: MM


DRAWING TITLE **BUILDING HEIGHT PLANE 8.5M**

DRAWING STATUS DEVELOPMENT APPLICATION

DA10.

NOT FOR CONSTRUCTION

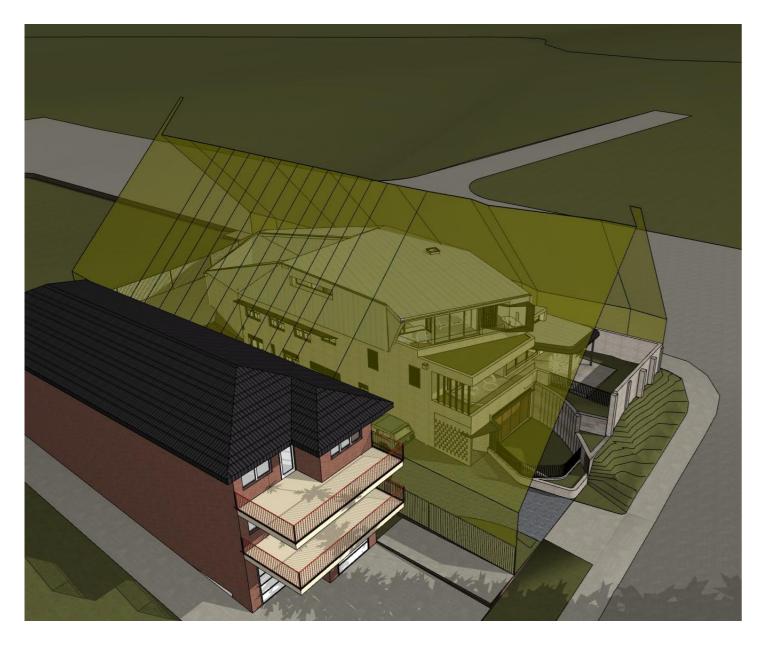

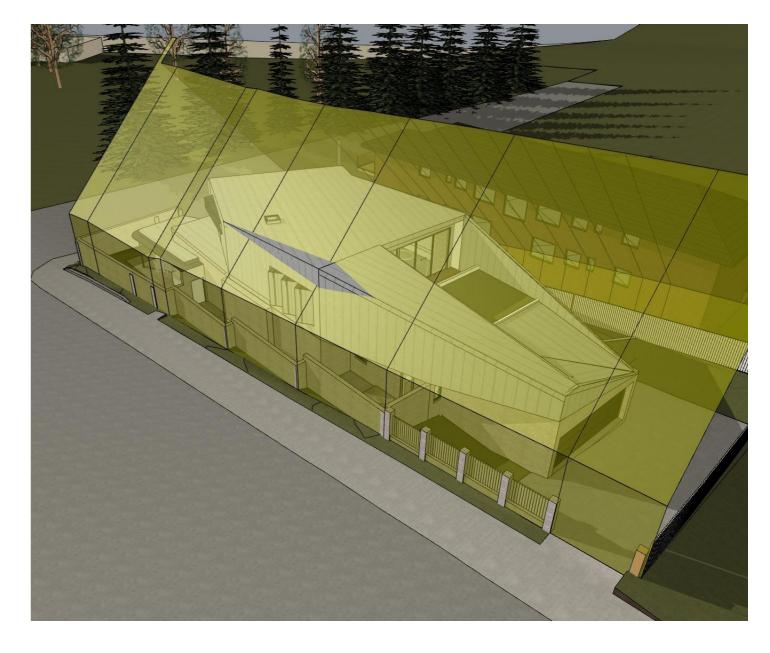

BUILDING ENVELOPE NORTH 45°

BUILDING ENVELOPE SOUTH 45°

118

MACCORMICK + ASSOCIATES ARCHITECTS, 13 VICTORIA STREET QUEENS PARK NSW 2022
T 9037 0437 E hello@maccormickarchitects.com.au ACN 147 572 807 ARCHITECT REG 6702
THE BUILDER SHALL CHECK & VERIFY ALL DIMENSIONS & VERIFY ALL ERRORS AND OMISSIONS TO THE ARCHITECT. CONTRACTOR TO REPORT DISCREPANCIES IMMEDIATELY. THIS DRAWING IS TO BE USED IN CONJUNCTION WITH ALL RELEVANT CONTRACTS. DO NOT SCALE OFF DRAWINGS. DRAWINGS SHALL NOT BE USED FOR CONSTRUCTION PURPOSES UNTIL. ISSUED BY THE ARCHITECT FOR CONSTRUCTION. THIS DRAWING IS COPYRIGHT AND MAY NOT BE USED WITHOUT WRITTEN CONSENT FROM THE ARCHITECT

PROJECT
BIRDWOOD
Matthew & Shona Adamo

1 Birdwood Ave Collaroy NSW 2097

PROJECT NO REVISION DATE PRINTED: 18/06/2025 SCALE

| A | DA SUBMISSION | 18/06/2025 | PAPER SIZE: A3 |
| DRAWN BY: LH, RL | CHECKED BY: MM

DRAWING TITLE

BUILDING ENVELOPE 45°

DEVELOPMENT APPLICATION

DA10.2

NOT FOR CONSTRUCTION





WALL HEIGHT EAST 7.2M

WALL HEIGHT WEST 7.2M

112

MACCORMICK + ASSOCIATES ARCHITECTS,

13 VICTORIA STREET QUEENS PARK NSW 2022
T 9037 0437 E hello@maccormickarchitects.com.au

ACN 147 572 807

ARCHITECT REG 6702
THE BUILDER SHALL CHECK & VERIFY ALL DIMENSIONS & VERIFY ALL ERRORS AND OMISSIONS TO THE ARCHITECT. CONTRACTOR TO REPORT DISCREPANCIES IMMEDIATELY. THIS DRAWING IS TO BE USED IN CONJUNCTION WITH ALL RELEVANT CONTRACTS. DO NOT SCALE OFF DRAWINGS. DRAWINGS SHALL NOT BE USED FOR CONSTRUCTION PURPOSES UNTIL ISSUED BY THE ARCHITECT FOR CONSTRUCTION. THIS DRAWING IS COPYRIGHT AND MAY NOT BE USED WITHOUT WRITTEN CONSENT FROM THE ARCHITECT

PROJECT BIRDWOOD

Matthew & Shona Adamo 1 Birdwood Ave Collaroy NSW 2097 DRAWING TITLE

WALL HEIGHT - 7.2M

DEVELOPMENT APPLICATION

NOT FOR CONSTRUCTION

DRAWING NO

DA10.3

A





MACCORMICK + ASSOCIATES ARCHITECTS, 13 VICTORIA STREET QUEENS PARK NSW 2022

T 9037 0437 E hello@maccormickarchitects.com.au ACM 147 572 807 ARCHITECT REG 6702

THE BUILDER SHALL CHECK & VERIFY ALL DIMENSIONS & VERIFY ALL ERRORS AND OMISSIONS TO THE ARCHITECT. CONTRACTOR TO REPORT DISCREPANCIES IMMEDIATELY. THIS DRAWING IS TO BE USED IN CONJUNCTION WITH ALL RELEVANT CONTRACTS. DO NOT SCALE OFF DRAWINGS. DRAWINGS SHALL NOT BE USED FOR CONSTRUCTION PURPOSES UNTIL ISSUED BY THE ARCHITECT FOR CONSTRUCTION. THIS DRAWING IS COPYRIGHT AND MAY NOT BE USED WITHOUT WRITTEN CONSENT FROM THE ARCHITECT

PROJECT

BIRDWOOD


Matthew & Shona Adamo 1 Birdwood Ave Collaroy NSW 2097 PROJECT NO REVISION DATE PRINTED: 18/06/2025 | SCALE 18/06/2025 PAPER SIZE: A3 DRAWN BY: LH, RL 2408 CHECKED BY: MM

DRAWING TITLE 1065 PITTWATER RD VIEW

ANALYSIS DRAWING STATUS **DEVELOPMENT APPLICATION** NOT FOR CONSTRUCTION

DA10.4




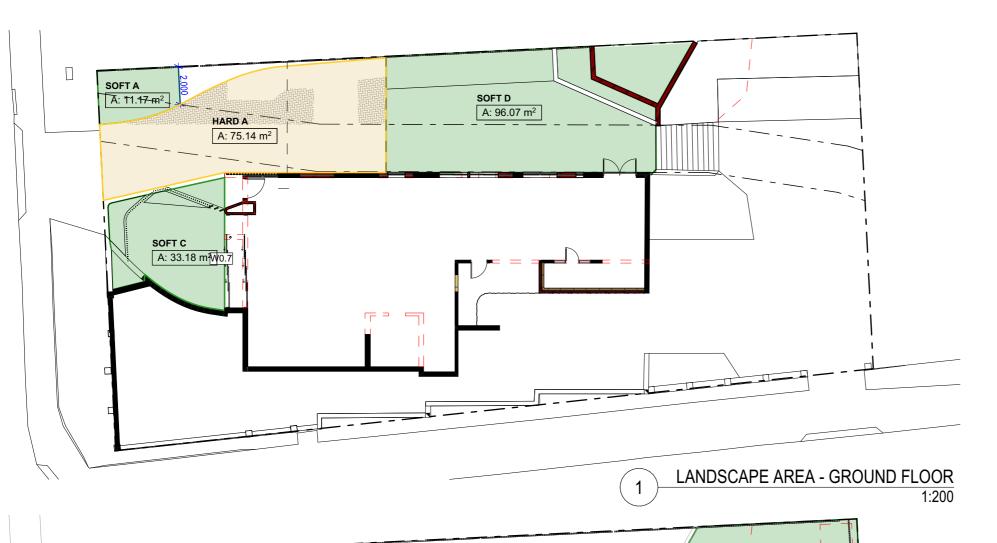

SITE AREA: 762.4m² MIN LANDSCAPE AREA: 304.96m² (40%) EXISTING LANDSCAPE AREA: 170.9m² PROPOSED LANDSCAPE AREA: 237.75m²

LANDSCAPE AREA - SOFT				
Zone Name	Measured Area			
SOFT A	11.17			
SOFT C	33.18			
SOFT D	96.07			
SOFT F	19.18			
SOFT F	12.27			
SOFT G	22.98			
SOFTI	42.90			
	237.75 m ²			

LANDSCAF	LANDSCAPE AREA - PAVED				
Zone Name	Measured Area				
HARD A	75.14				
HARD B	260.31				
HARD C	131.74				
	467.19 m²				

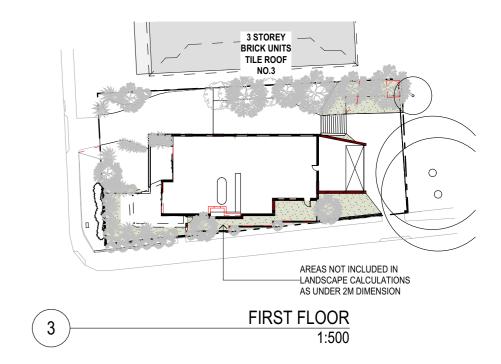

LANDSCAPE AREA - FIRST FLOOR 2 1:200

HARD C

A: 131.74 m²

SOFTI A: 42.90 m²

SOFT G

A: 22.98 m²



19.18 m²

HARD B

A: 260.31 m²

PROJECT **BIRDWOOD** Matthew & Shona Adamo 1 Birdwood Ave Collaroy NSW 2097

SOFT F

A: 12.27 m²

PROJECT NO REVISION DATE PRINTED: 18/06/2025 SCALE A DA SUBMISSION 18/06/2025 PAPER SIZE: A3 DRAWN BY: LH, RL 2408 CHECKED BY: MM

1:200, 1:1, 1:500

DRAWING TITLE LANDSCAPE AREA CALCULATIONS

DEVELOPMENT APPLICATION

DRAWING STATUS

DA11

REVISION

NOT FOR CONSTRUCTION