



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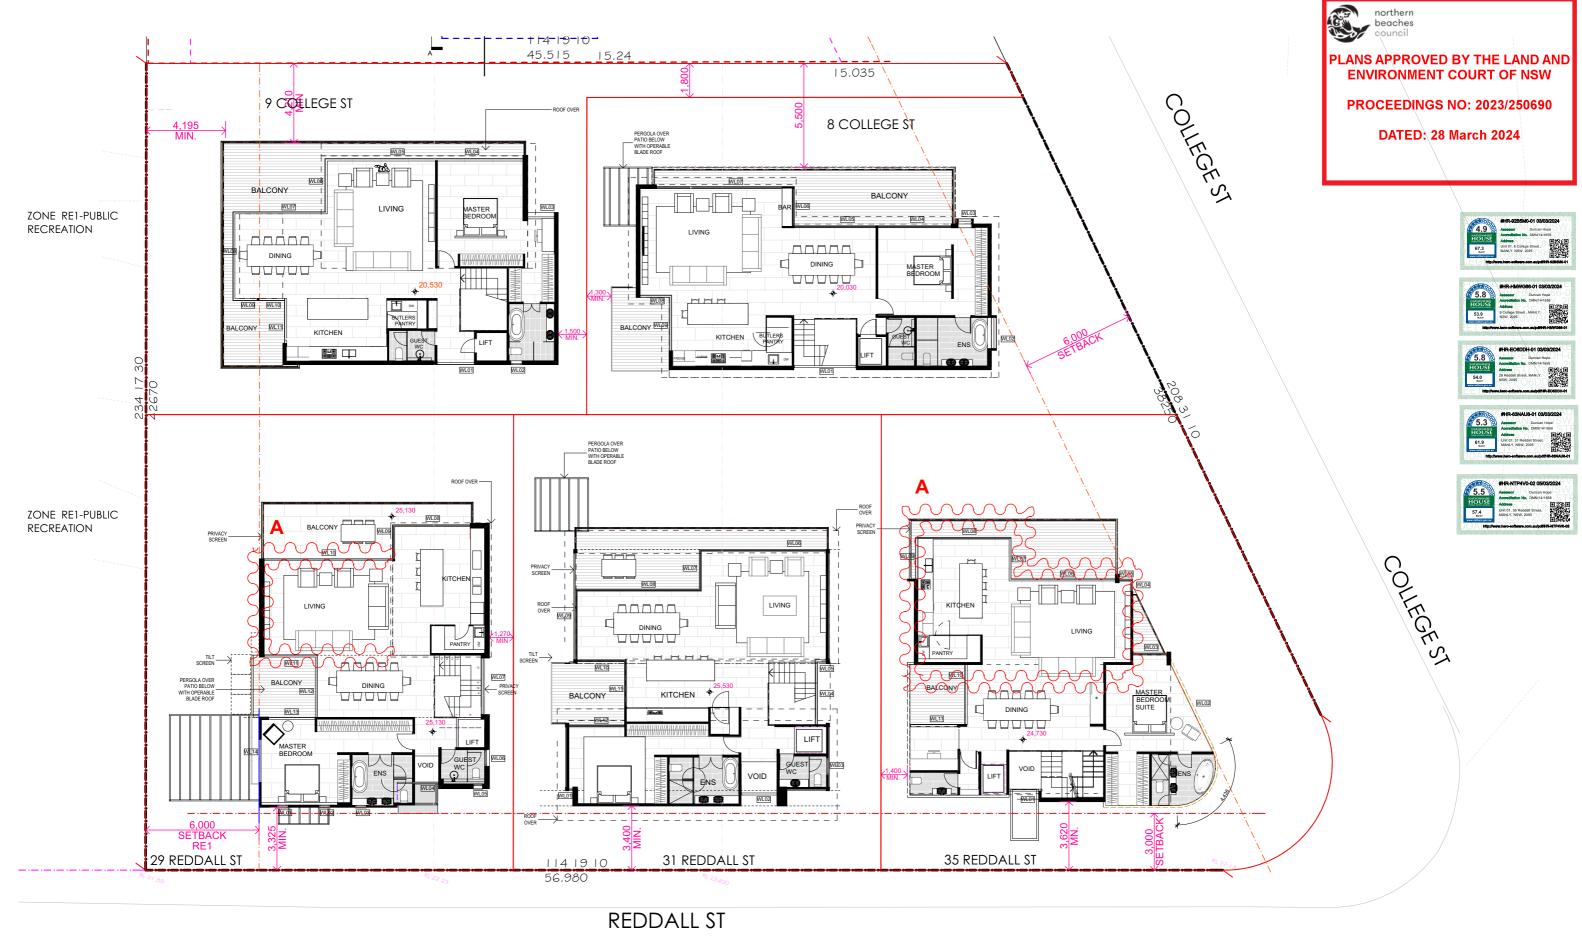
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BIM Server:	: BIMSRV01 - BIM Server 20/29-35 Reddall Street,Manly 5	5 Residences - Study 1 - 1211:	21	PLOT DATE: 4/03/2024

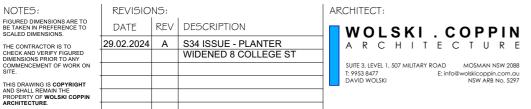




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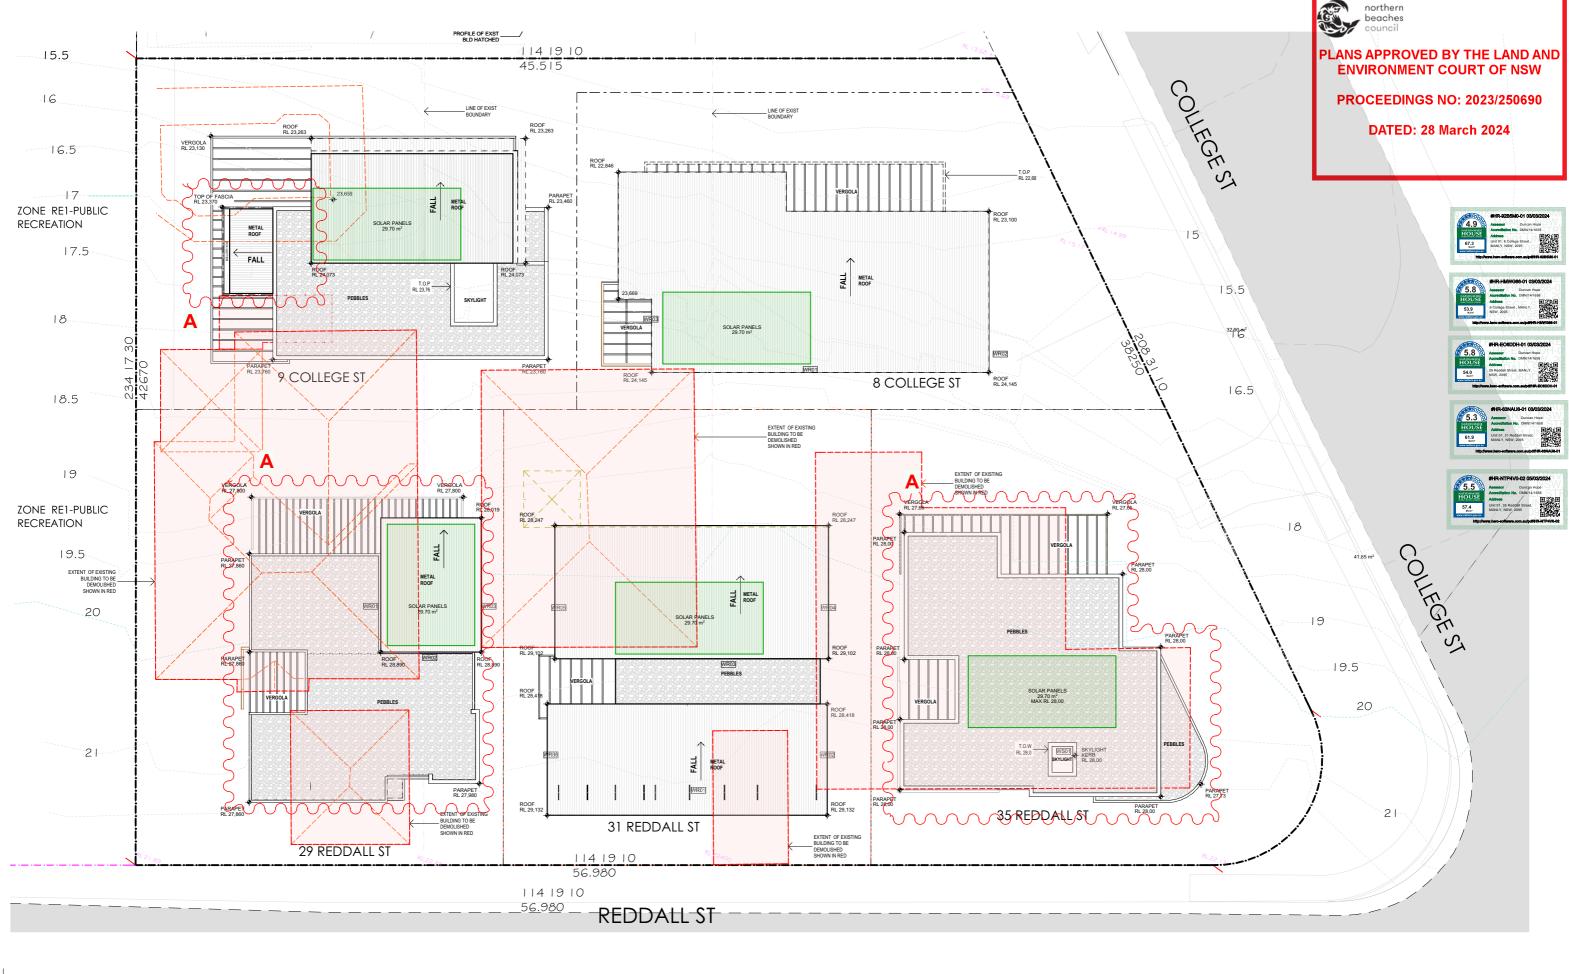
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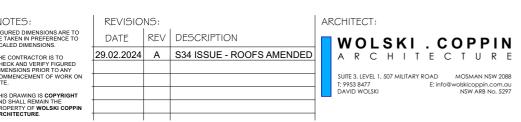


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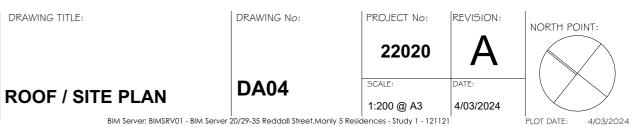


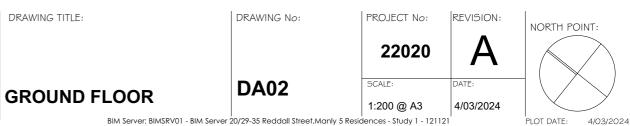

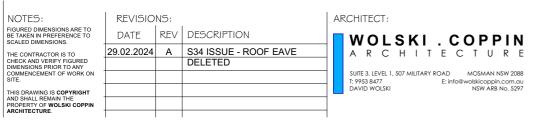

FIVE RESIDENCES for Reddall Street Pty Ltd

29, 31 & 35 Reddall St + Proposed lots 8 & 9 College St Manly











REVISIONS:

ENVIRONMENT COURT OF NSW

PROCEEDINGS NO: 2023/250690

DATED: 28 March 2024


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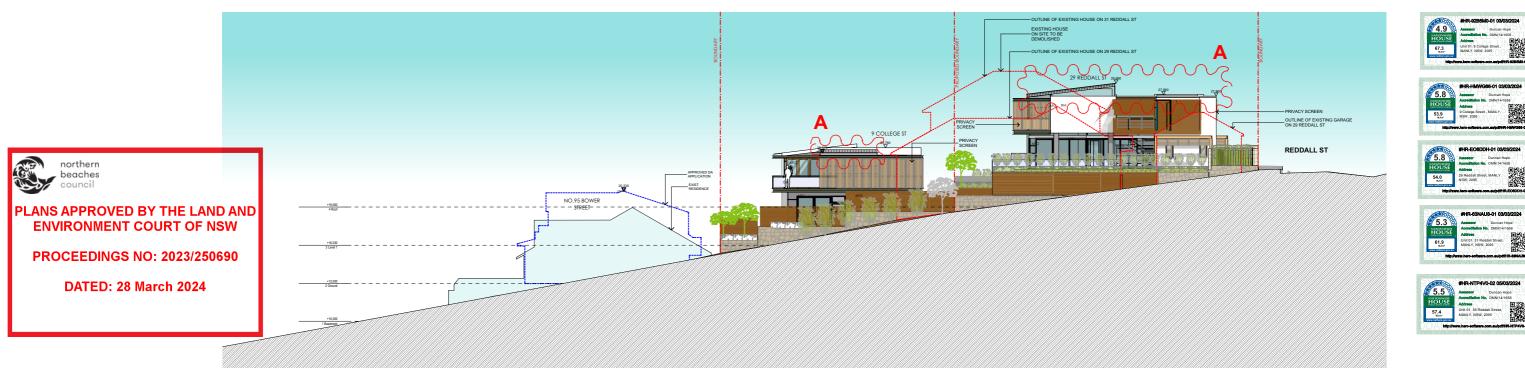
ARCHITECT: WOLSKI . COPPIN A R C H I T E C T U R E SUITE 3, LEVEL 1, 507 MILITARY ROAD MOSMAN NSW 2088
1: 9953 8477 E: info@wolskicoppin.com.au
DAVID WOLSKI NSW ARB No. 5297

PROJECT TITLE: **FIVE RESIDENCES** for Reddall Street Pty Ltd 29, 31 & 35 Reddall St + Proposed lots

8 & 9 College St Manly


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NORTH- WEST ELEVATION

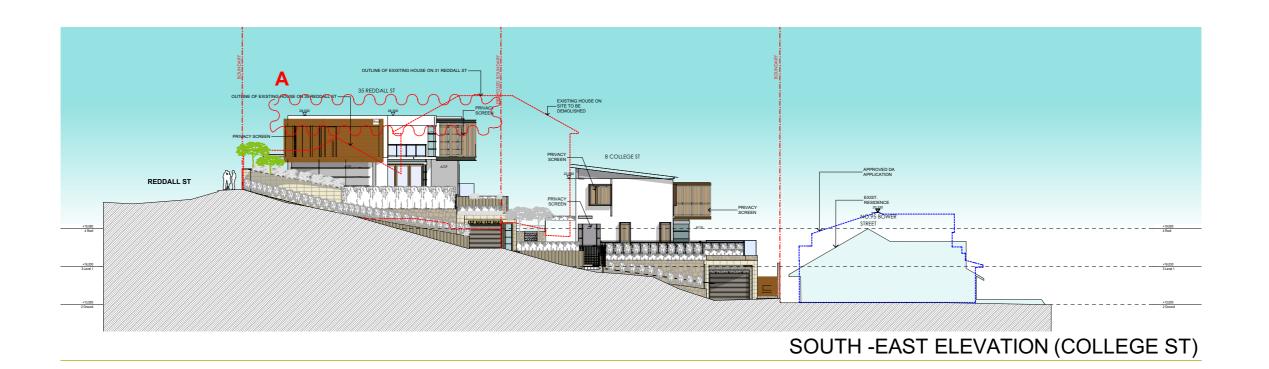


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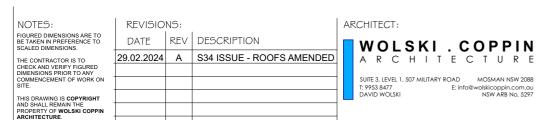






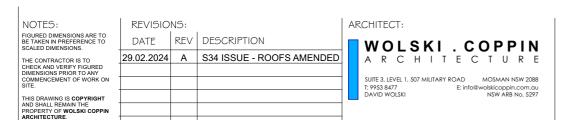



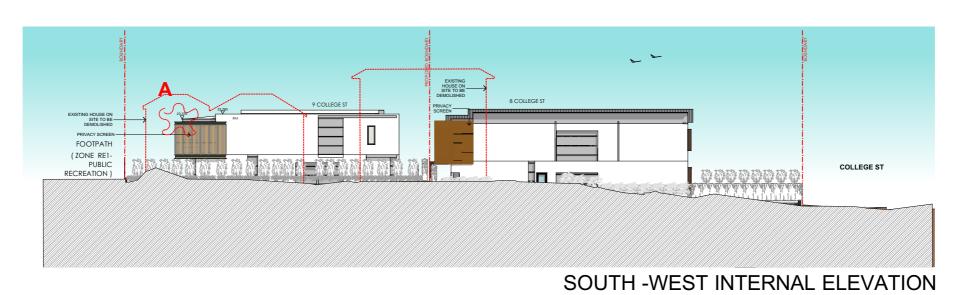

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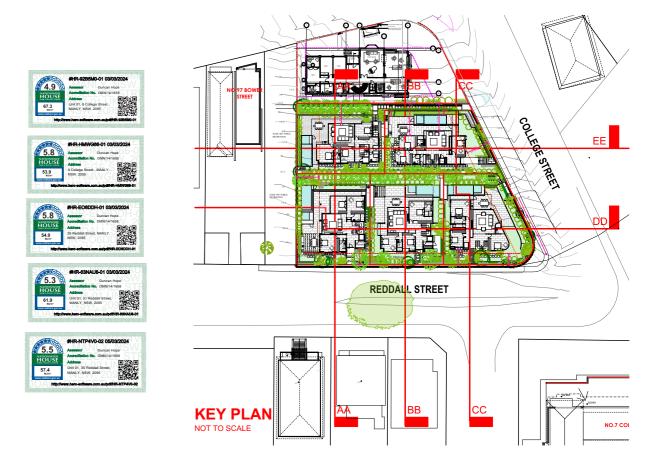
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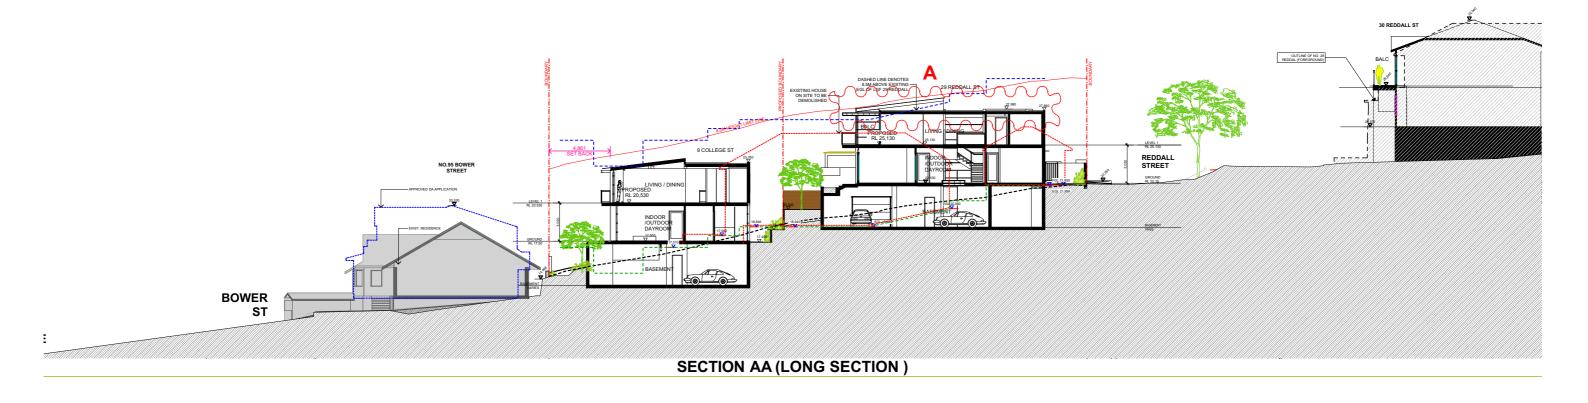
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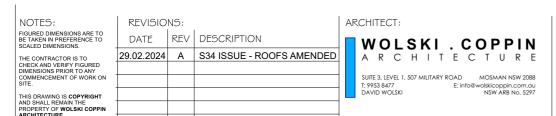
29, 31 & 35 Reddall St + Proposed lots
8 & 9 College St Manly











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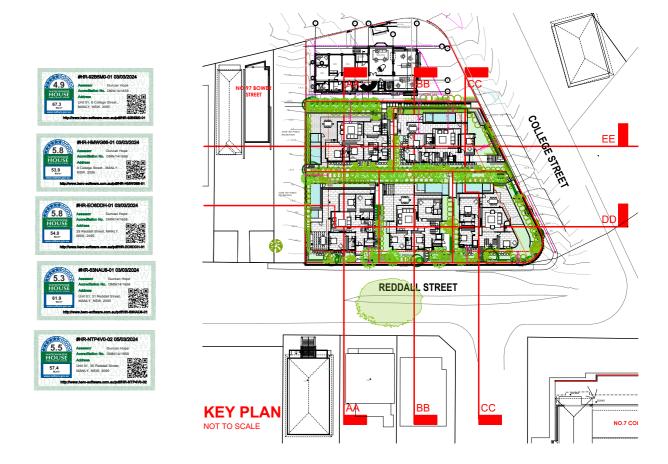
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29, 31 & 35 Reddall St + Proposed lots


8 & 9 College St Manly









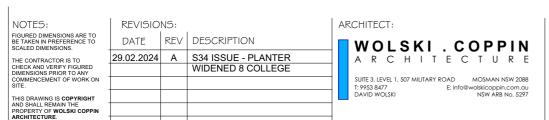

PROJECT TITLE:

FIVE RESIDENCES

for Reddall Street Pty Ltd 29, 31 & 35 Reddall St + Proposed lots 8 & 9 College St Manly

SECTION BB (LONG SECTION)	DA09
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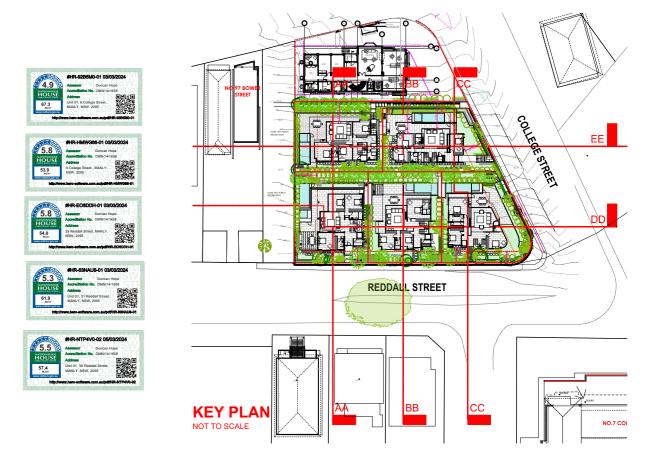



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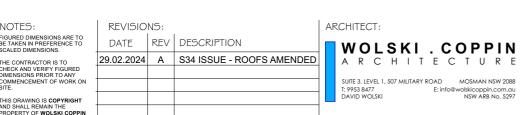
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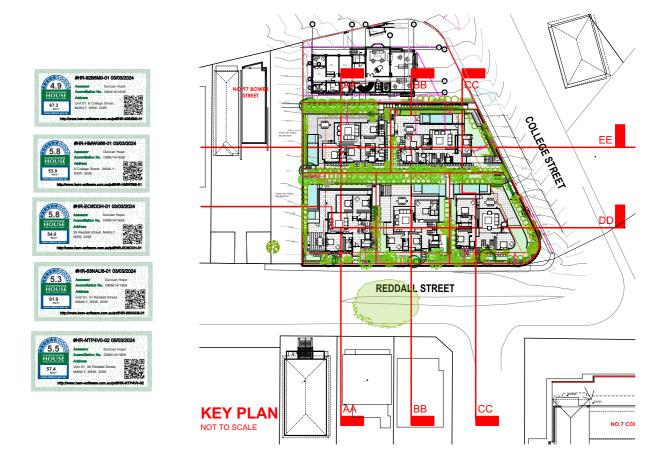



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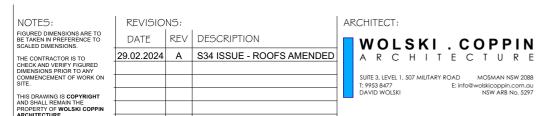
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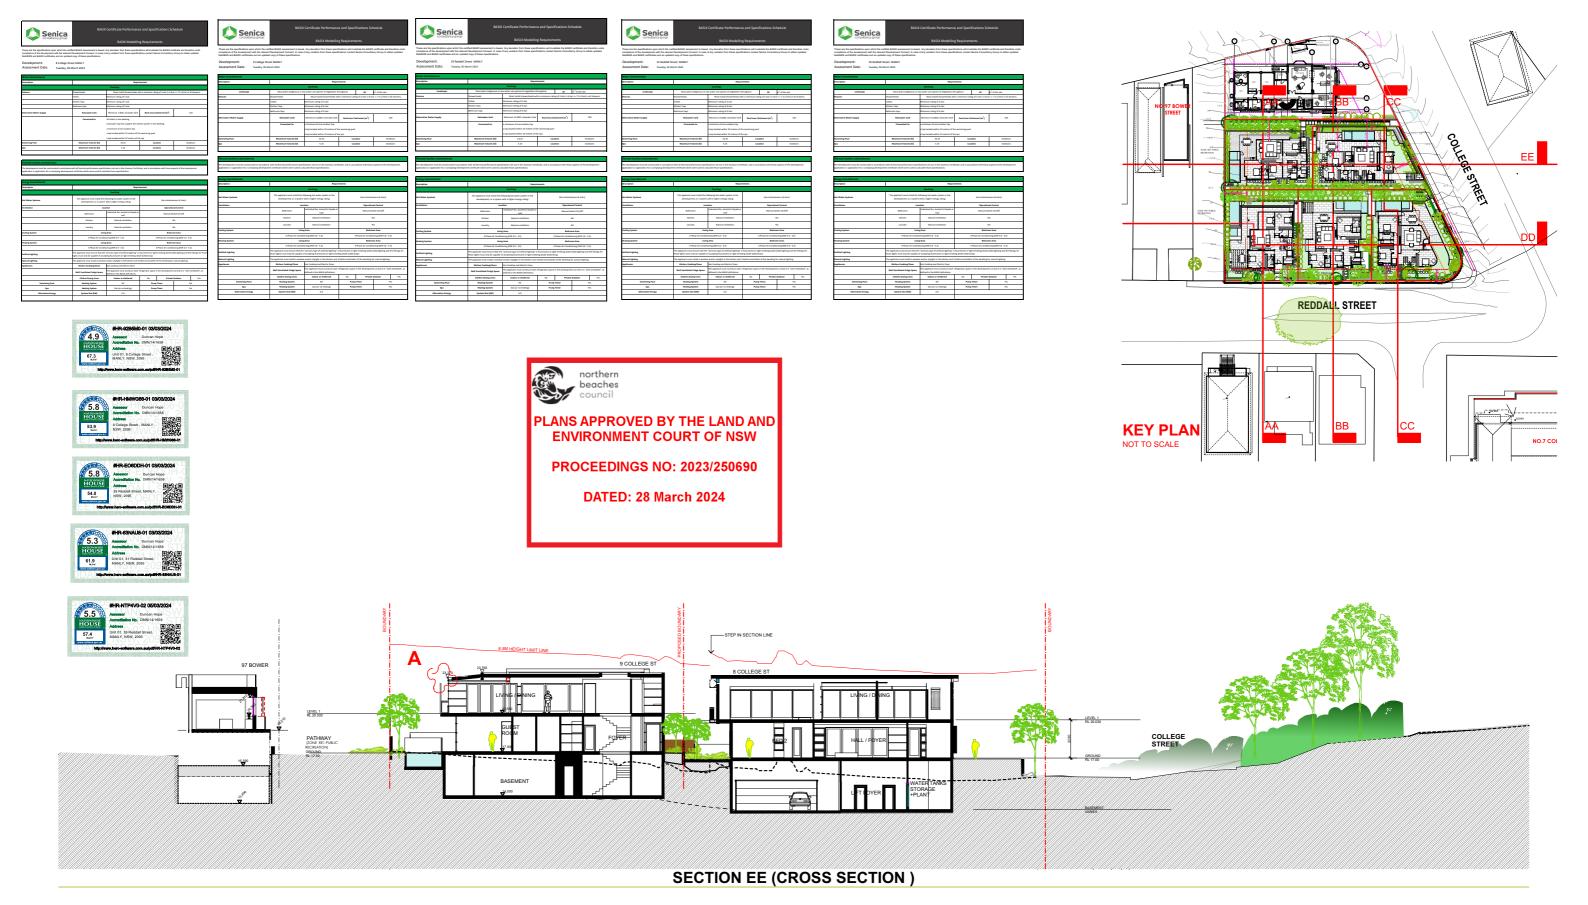
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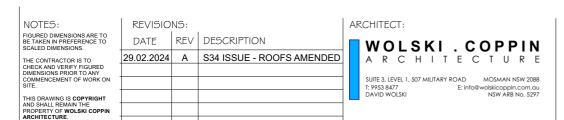
for Reddall Street Pty Ltd

29, 31 & 35 Reddall St + Proposed lots

8 & 9 College St Manly




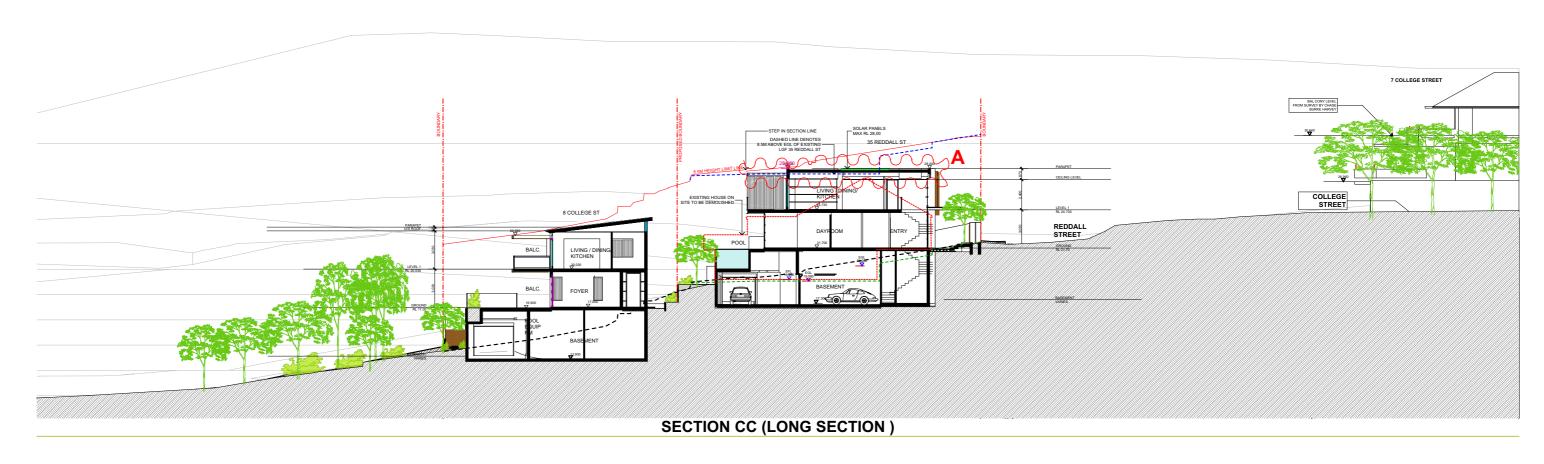


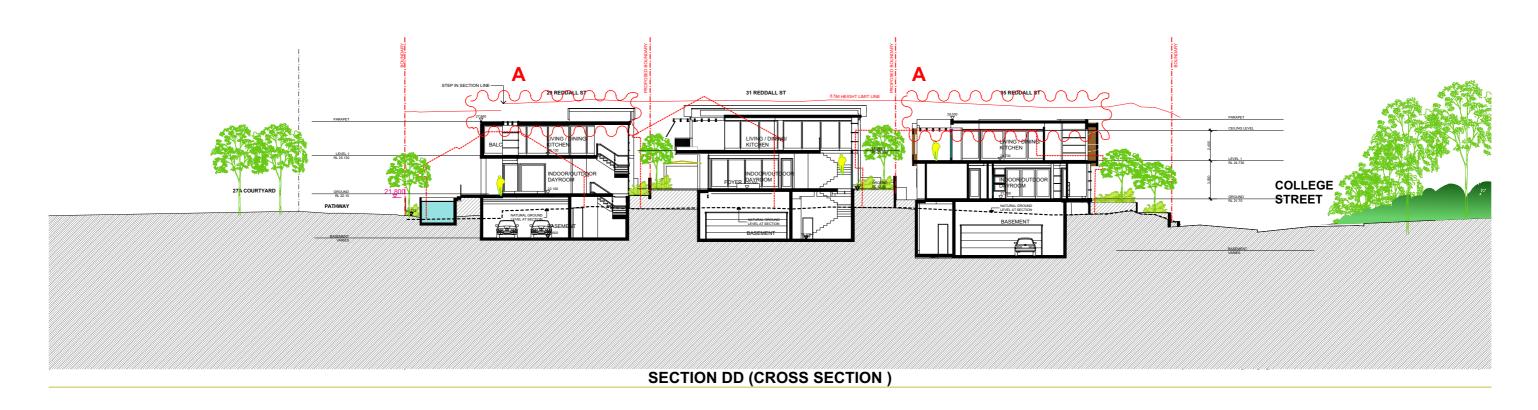


FIVE RESIDENCES



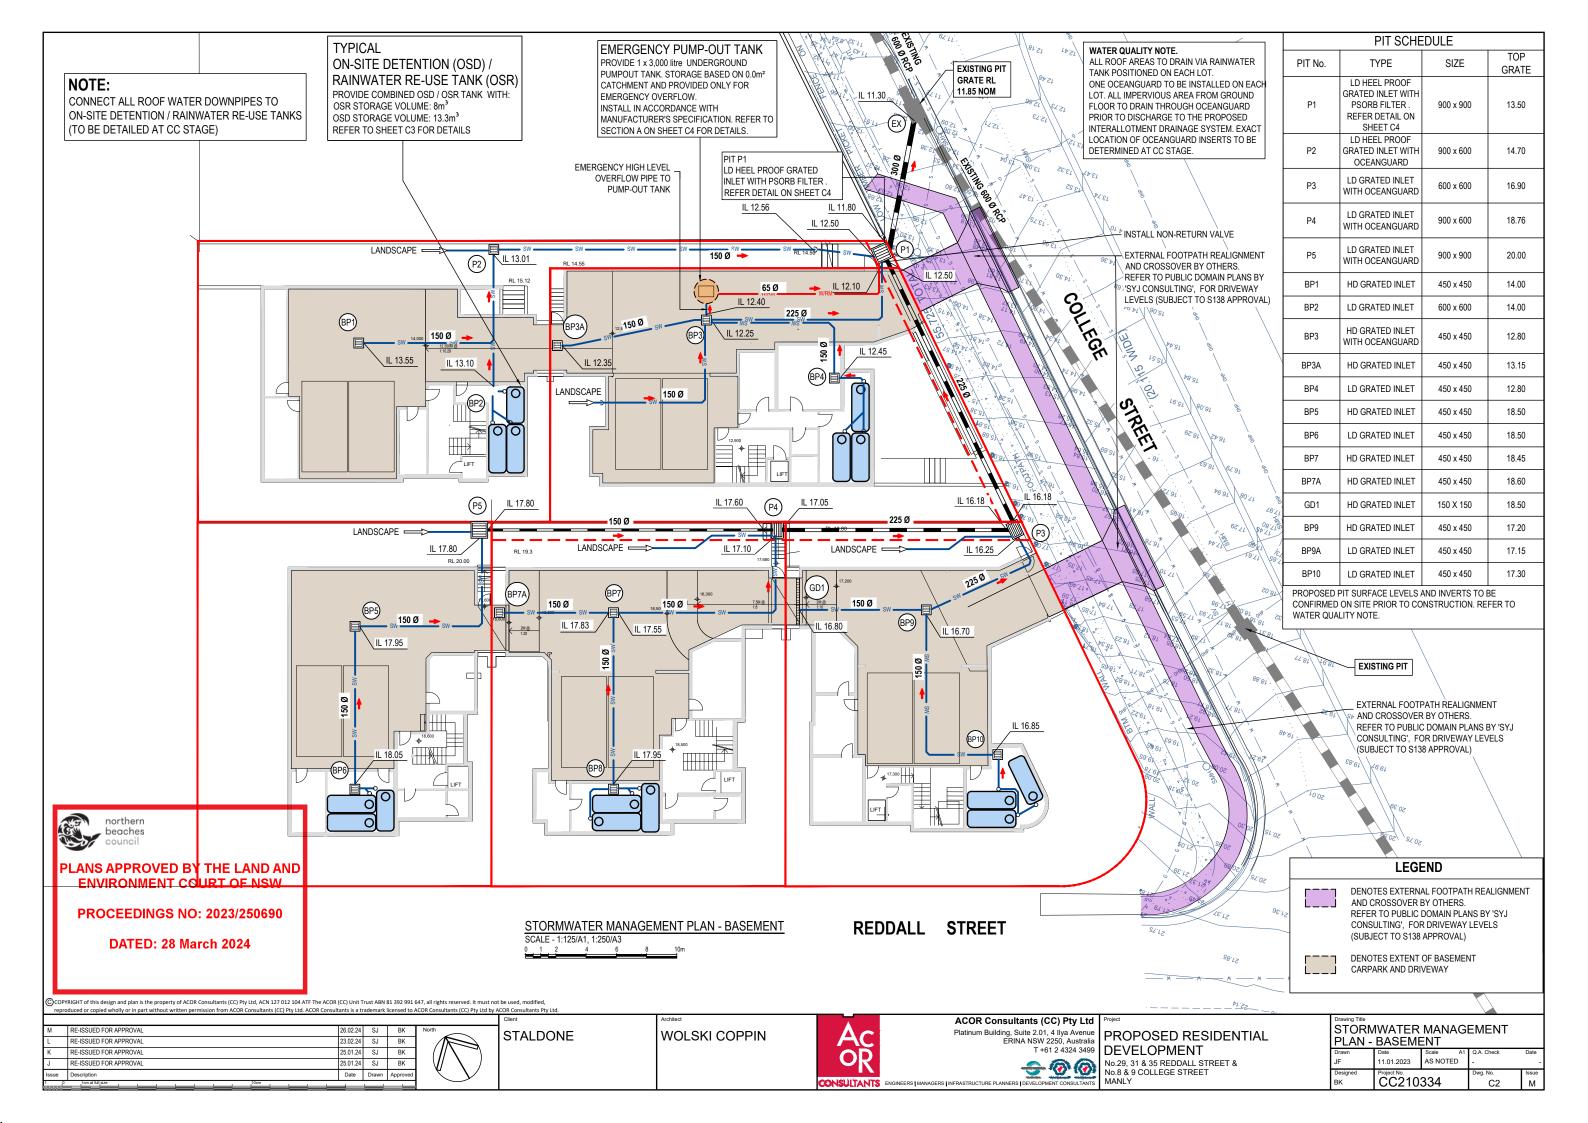

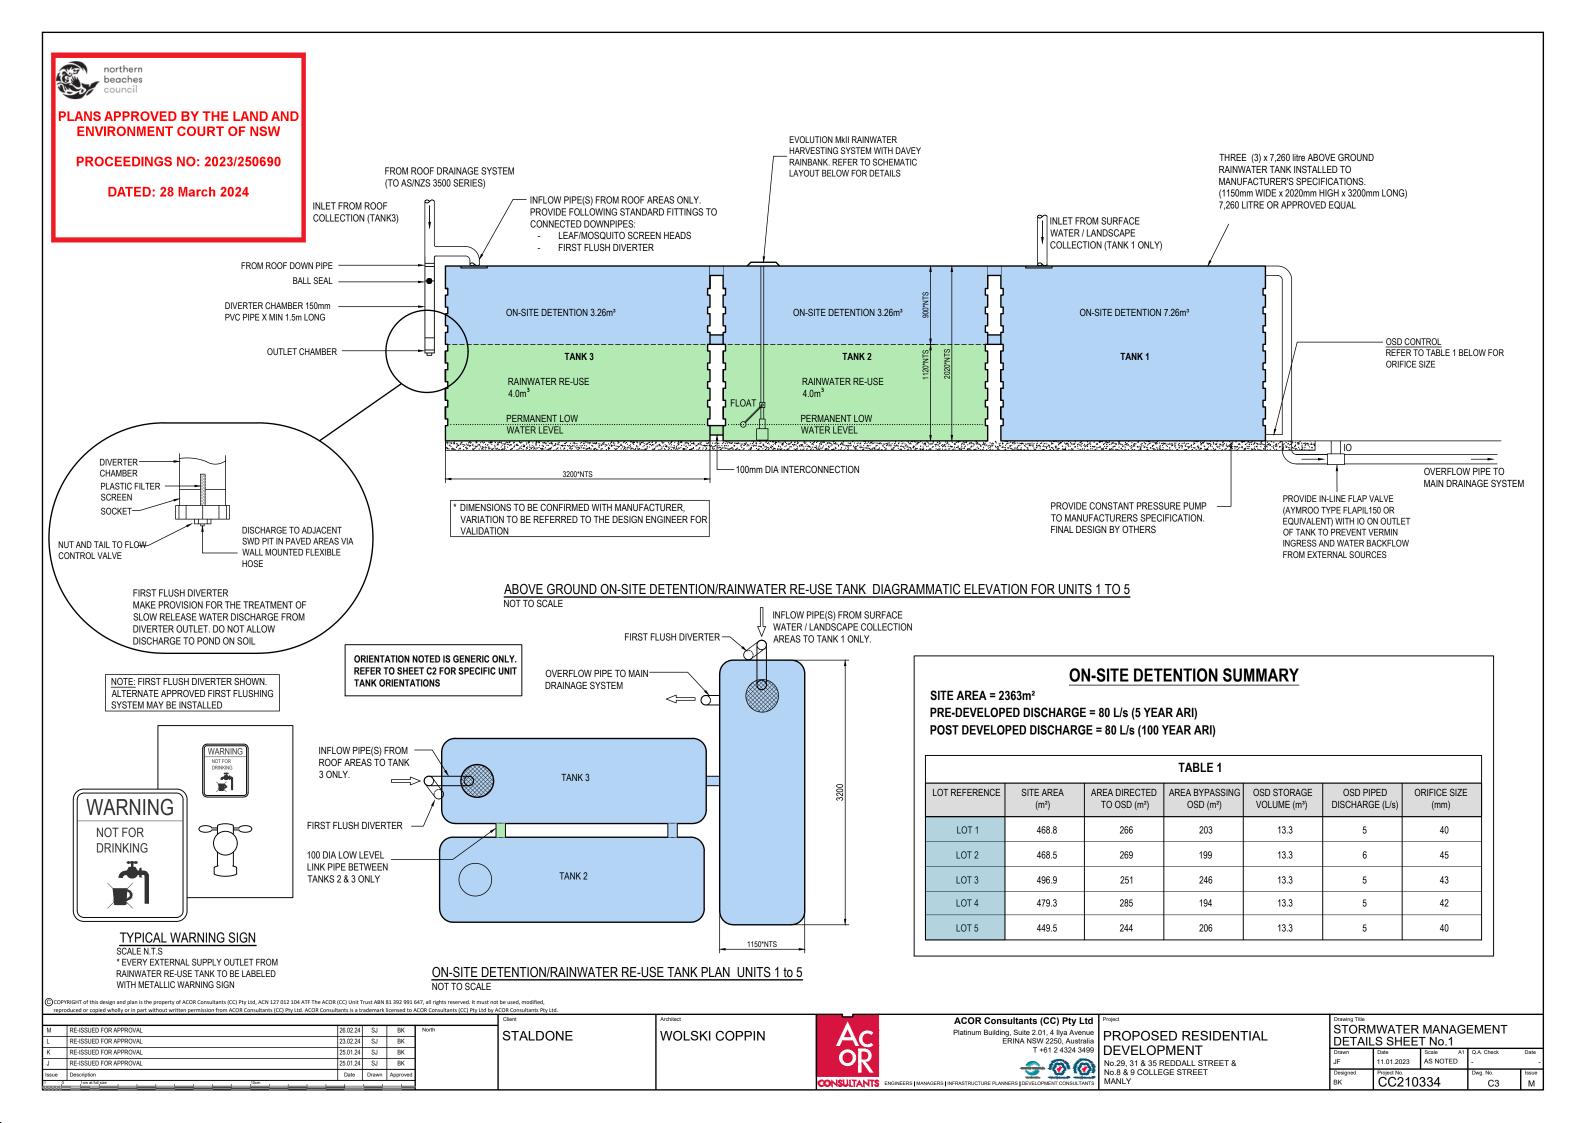

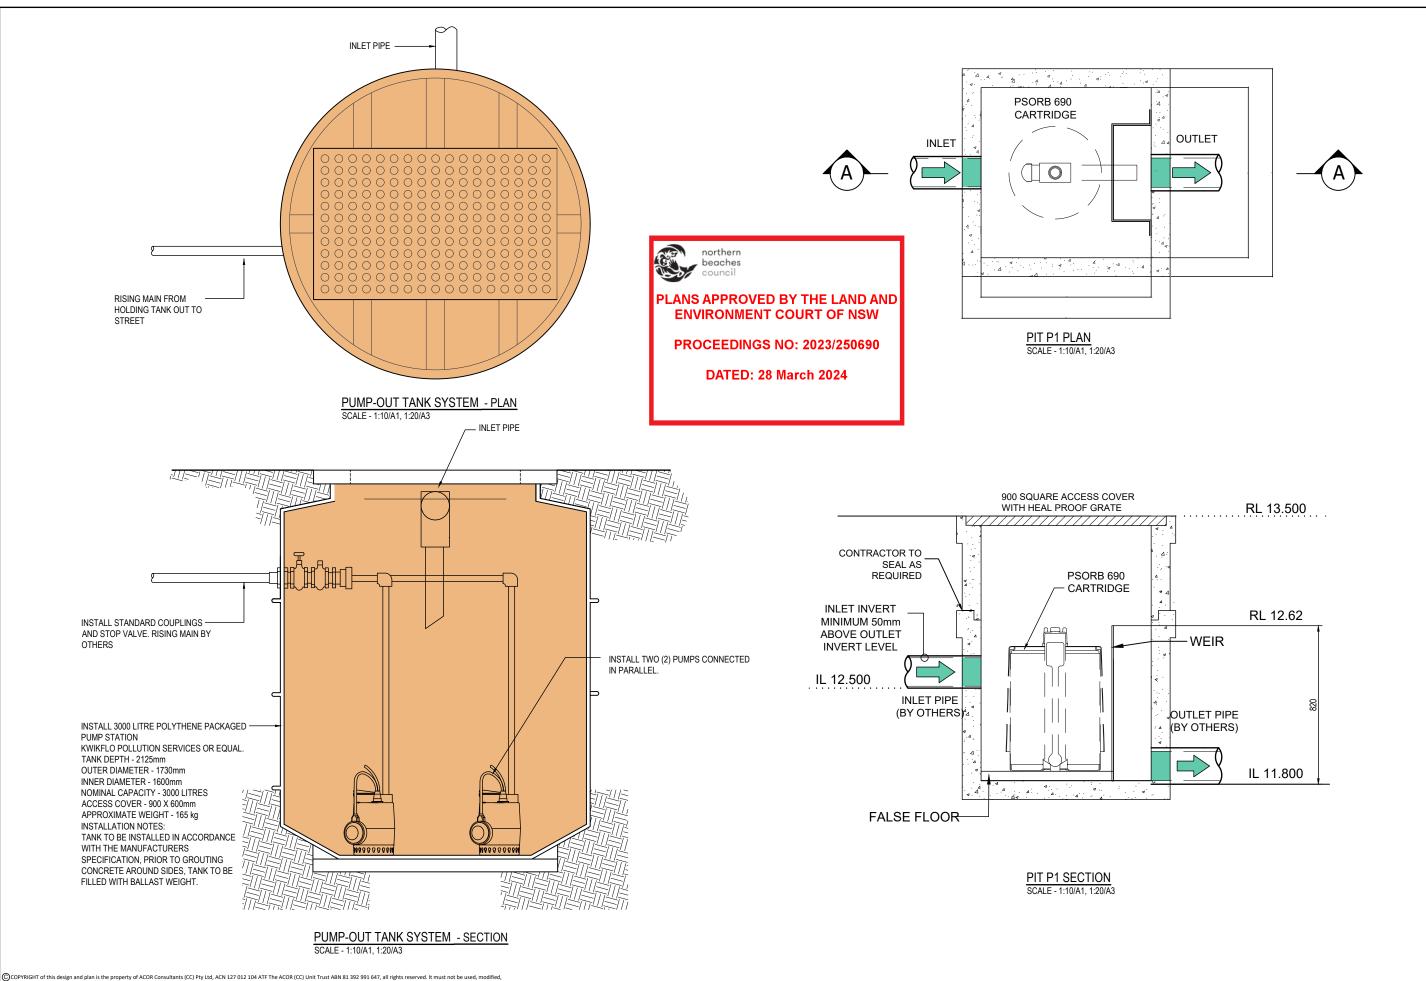

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М	RE-ISSUED FOR APPROVAL	26.02.24	SJ	BK	North	STALDONE
L	RE-ISSUED FOR APPROVAL	23.02.24	SJ	BK		STALDONE
K	RE-ISSUED FOR APPROVAL	25.01.24	SJ	BK		
J	RE-ISSUED FOR APPROVAL	25.01.24	SJ	BK		
Issue	Description	Date	Drawn	Approved		

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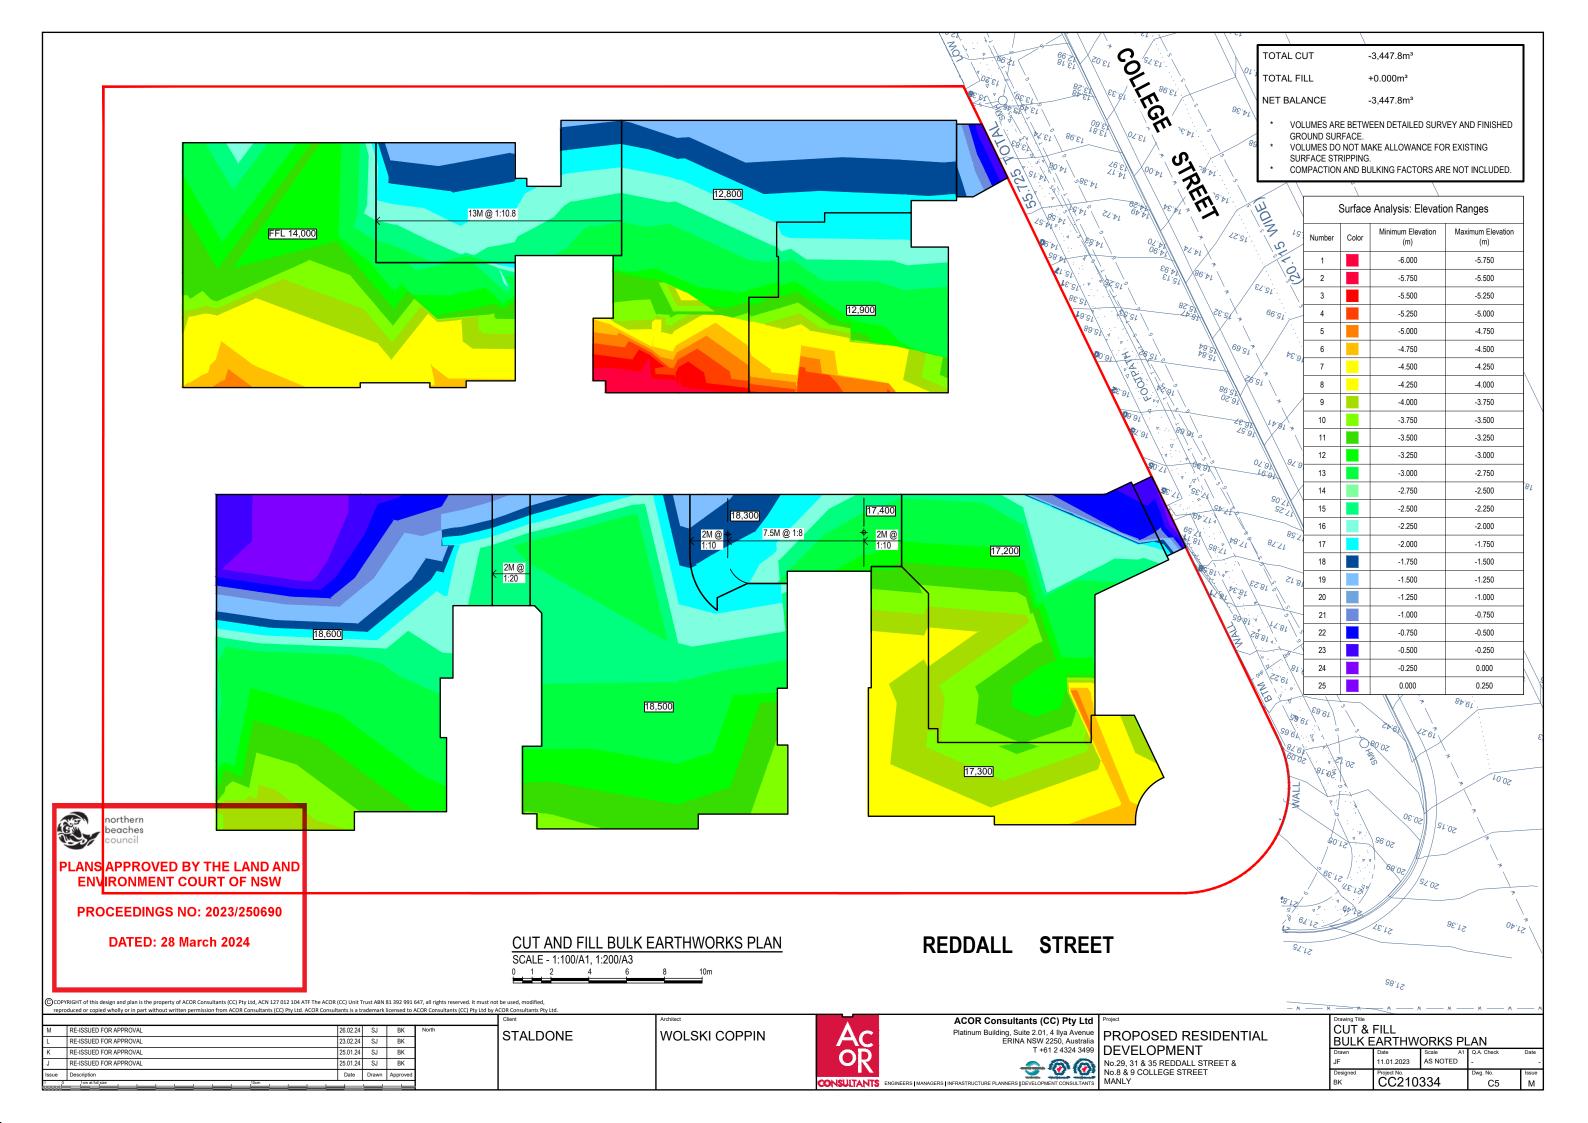



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,	PROPOSED RESIDENTIAL DEVELOPMENT
)	DEVELOPMENT
	No 29 31 & 35 REDDALL STREET &

STORMWATER MANAGEMENT DETAILS SHEET No.2										
Drawn	Date	Scale A1	Q.A. Check							
JF	11.01.2023	AS NOTED	-							
Designed	Project No.	Dwg. No.								
BK	CC210	C4								

No.29, 31 & 35 REDDALL STREET & No.8 & 9 COLLEGE STREET



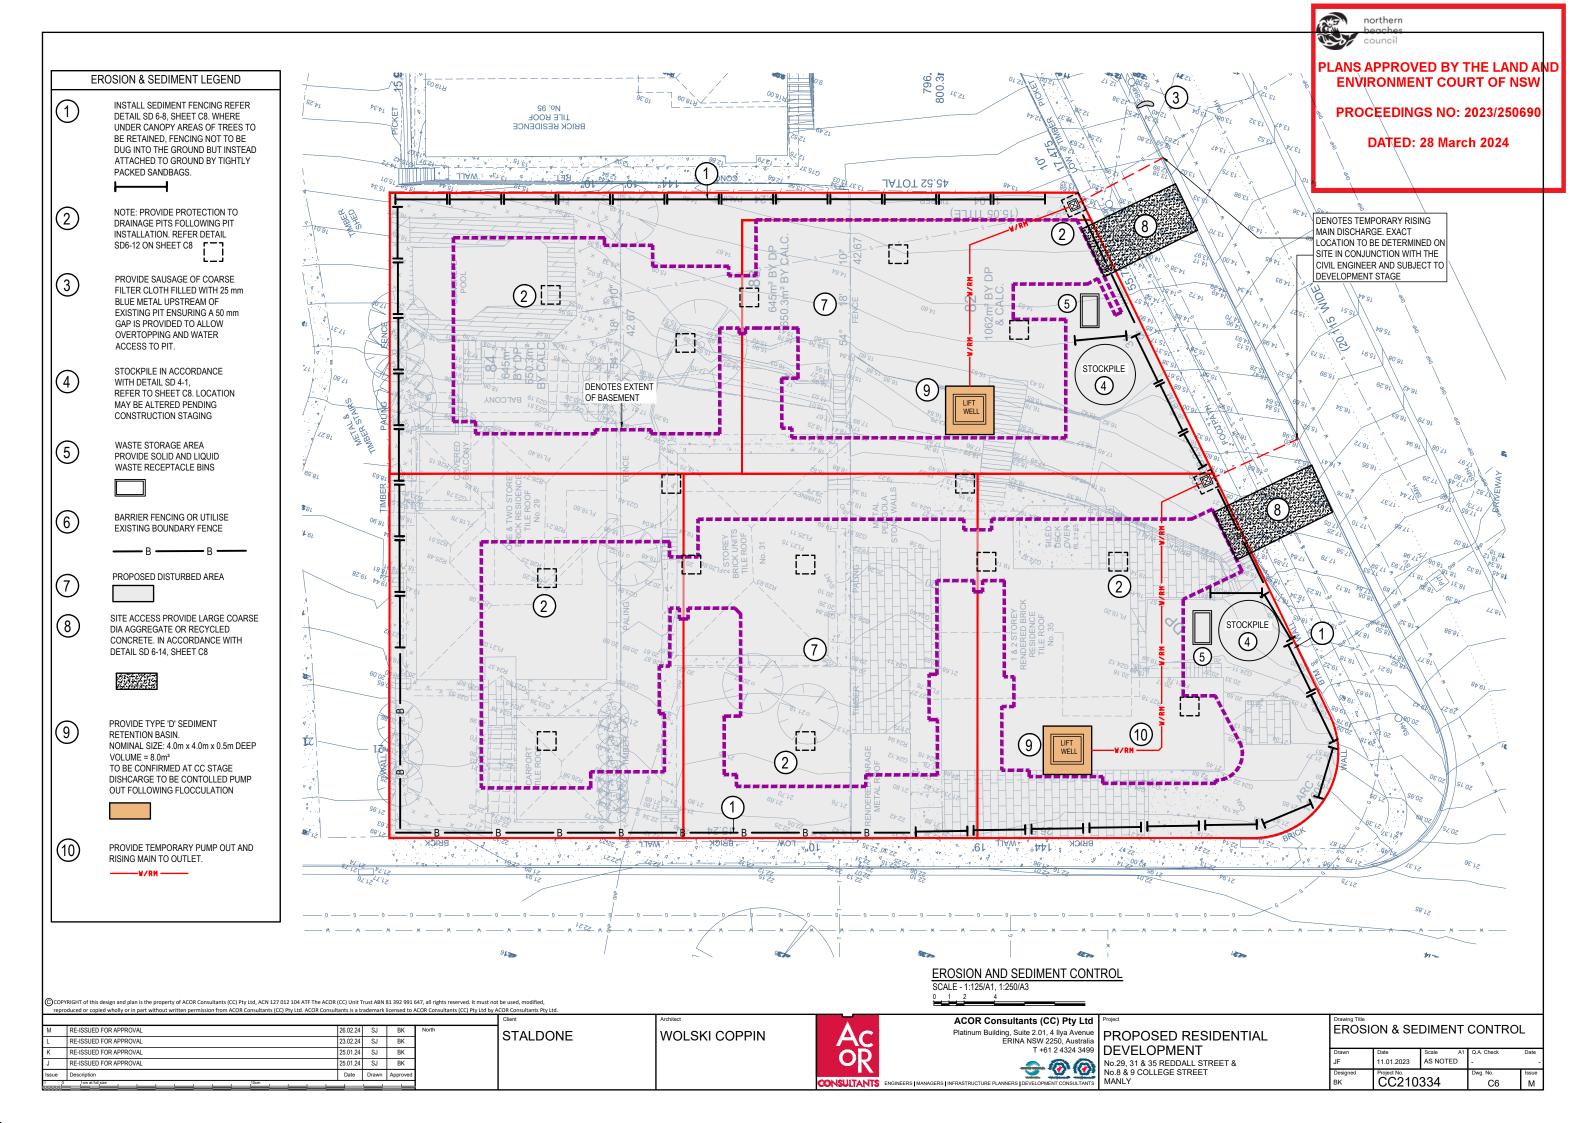

EROSION AND SEDIMENT CONTROL NOTES

GENERAL INSTRUCTIONS

- THIS SOIL AND WATER MANAGEMENT PLAN IS TO BE READ IN CONJUNCTION WITH OTHER ENGINEERING PLANS RELATING TO THIS DEVELOPMENT
- CONTRACTORS WILL ENSURE THAT ALL SOIL AND WATER MANAGEMENT WORKS ARE UNDERTAKEN AS INSTRUCTED IN THIS SPECIFICATION AND CONSTRUCTED FOLLOWING THE GUIDELINES OF "MANAGING URBAN STORMWATER SOILS AND CONSTRUCTION". DEPT OF HOUSING, 1998 (BLUE BOOK)
- ALL SUBCONTRACTORS WILL BE INFORMED OF THEIR RESPONSIBILITIES IN REDUCING THE POTENTIAL FOR SOIL EROSION AND POLLUTION TO DOWNSLOPE AREAS.

LAND DISTURBANCE INSTRUCTIONS

- DISTURBANCE TO BE NO FURTHER THAN 5 (PREFERABLY 2) METRES FROM THE EDGE OF ANY ESSENTIAL ENGINEERING ACTIVITY AS SHOWN ON APPROVED PLANS. ALL SITE WORKERS WILL CLEARLY RECOGNISE THESE ZONES THAT, WHERE APPROPRIATE, ARE IDENTIFIED WITH BARRIER FENCING (UPSLOPE) AND SEDIMENT FENCING (DOWNSLOPE) OR SIMILAR MATERIALS.
- ACCESS AREAS ARE TO BE LIMITED TO A MAXIMUM WIDTH OF 10 METRES THE SITE MANAGER WILL DETERMINE AND MARK THE LOCATION OF THESE ZONES ON-SITE. ALL SITE WORKERS WILL CLEARLY RECOGNISE THESE BOUNDARIES THAT, WHERE APPROPRIATE, ARE IDENTIFIED WITH BARRIER FENCING (UPSLOPE) AND SEDIMENT FENCING (DOWNSLOPE) OR SIMILAR MATERIALS.
- ENTRY TO LANDS NOT REQUIRED FOR CONSTRUCTION OR ACCESS IS PROHIBITED EXCEPT FOR ESSENTIAL THINNING OF PLANT GROWTH.
- WORKS ARE TO PROCEED IN THE FOLLOWING SEQUENCE: INSTALL ALL BARRIER AND SEDIMENT FENCING
 - WHERE SHOWN ON THE PLAN. CONSTRUCT THE STABILISED SITE ACCESS.
- CONSTRUCT DIVERSION DRAINS AS REQUIRED.
- INSTALL MESH AND GRAVEL INLETS FOR ANY ADJACENT KERB INLETS
- INSTALL GEOTEXTILE INLET FILTERS AROUND ANY ON-SITE DROP INLET PITS
- CLEAR SITE AND STRIP AND STOCKPILE TOPSOIL IN LOCATIONS SHOWN ON THE PLAN.
- UNDERTAKE ALL ESSENTIAL CONSTRUCTION WORKS ENSURING THAT ROOF AND/OR PAVED AREA STORMWATER SYSTEMS ARE CONNECTED TO PERMANENT DRAINAGE AS SOON AS PRACTICABLE
- GRADE LOT AREAS TO FINAL GRADES AND APPLY PERMANENT STABILISATION (LANDSCAPING) WITHIN 20 DAYS OF COMPLETION OF CONSTRUCTION WORKS.
- REMOVE TEMPORARY EROSION CONTROL MEASURES AFTER THE PERMANENT LANDSCAPING HAS BEEN COMPLETED.
- ENSURE THAT SLOPE LENGTHS DO NOT EXCEED 80 METRES WHERE PRACTICABLE. SLOPE LENGTHS ARE DETERMINED BY SILTATION FENCING AND CATCH DRAIN
- ON COMPLETION OF MAJOR WORKS LEAVE DISTURBED LANDS WITH A SCARIFIED SURFACE TO ENCOURAGE WATER INFILTRATION AND ASSIST WITH KEYING TOPSOIL

SITE MAINTENANCE INSTRUCTIONS

- 7. THE SITE SUPERINTENDENT WILL INSPECT THE SITE AT LEAST WEEKLY AND AT THE CONCLUSION OF EVERY STORM EVENT TO:
 - ENSURE THAT DRAINS OPERATE PROPERLY AND TO EFFECT ANY NECESSARY REPAIRS
 - REMOVE SPILLED SAND OR OTHER MATERIALS FROM HAZARD AREAS, INCLUDING LANDS CLOSER THAN 5 METRES FROM AREAS OF LIKELY CONCENTRATED OR HIGH VELOCITY FLOWS ESPECIALLY WATERWAYS AND PAVED AREAS.
 - REMOVE TRAPPED SEDIMENT WHENEVER THE DESIGN CAPACITY OF THAT STRUCTURE HAS BEEN
 - ENSURE REHABILITATED LANDS HAVE EFFECTIVELY REDUCED THE EROSION HAZARD AND TO INITIATE UPGRADING OR REPAIR AS
 - CONSTRUCT ADDITIONAL EROSION AND/OR SEDIMENT CONTROL WORKS AS MIGHT BECOME NECESSARY TO ENSURE THE DESIRED PROTECTION IS GIVEN TO DOWNSLOPE LANDS AND WATERWAYS. MAKE ONGOING CHANGES TO THE PLAN WHERE IT PROVES INADEQUATE IN PRACTICE OR IS SUBJECTED TO CHANGES IN CONDITIONS ON THE WORK-SITE OR ELSEWHERE IN THE CATCHMENT.
 - MAINTAIN EROSION AND SEDIMENT CONTROL STRUCTURES IN A FULLY FUNCTIONING CONDITION UNTIL ALL EARTHWORK ACTIVITIES ARE COMPLETED AND THE SITE IS REHABILITATED.
- THE SITE SUPERINTENDENT WILL KEEP A LOGBOOK MAKING ENTRIES AT LEAST WEEKLY, IMMEDIATELY BEFORE FORECAST RAIN AND AFTER RAINFALL. ENTRIES WILL INCLUDE:
 - THE VOLUME AND INTENSITY OF ANY RAINFALL **EVENTS**
 - THE CONDITION OF ANY SOIL AND WATER MANAGEMENT WORKS
 - THE CONDITION OF VEGETATION AND ANY NEED TO IRRIGATE
 - THE NEED FOR DUST PREVENTION STRATEGIES.
- ANY REMEDIAL WORKS TO BE LINDERTAKEN THE LOGBOOK WILL BE KEPT ON-SITE AND MADE AVAILABLE TO ANY AUTHORISED PERSON UPON REQUEST. IT WILL BE GIVEN TO THE PROJECT MANAGER AT THE CONCLUSION OF THE WORKS

SEDIMENT CONTROL INSTRUCTIONS

- SEDIMENT FENCES WILL BE INSTALLED AS SHOWN ON THE PLAN AND ELSEWHERE AT THE DISCRETION OF THE SITE SUPERINTENDENT TO CONTAIN SOIL AS NEAR AS POSSIBLE TO THEIR SOURCE.
- SEDIMENT FENCES WILL NOT HAVE CATCHMENT AREAS EXCEEDING 900 SQUARE METRES AND HAVE A STORAGE DEPTH OF AT LEAST 0.6 METRES.
- SEDIMENT REMOVED FROM ANY TRAPPING DEVICES WILL BE RELOCATED WHERE FURTHER POLLUTION TO DOWNSLOPE LANDS AND WATERWAYS CANNOT OCCUR.
- STOCKPILES ARE NOT TO BE LOCATED WITHIN 5 METRES OF HAZARD AREAS INCLUDING AREAS OF HIGH VELOCITY FLOWS SUCH AS WATERWAYS, PAVED AREAS AND
- WATER WILL BE PREVENTED FROM DIRECTLY ENTERING THE PERMANENT DRAINAGE SYSTEM UNLESS THE CATCHMENT AREA HAS BEEN PERMANENTLY LANDSCAPED AND/OR WATER HAS BEEN TREATED BY AN APPROVED DEVICE.
- TEMPORARY SEDIMENT TRAPS WILL REMAIN IN PLACE UNTIL AFTER THE LANDS THEY ARE PROTECTING ARE COMPLETELY REHABILITATED.
- ACCESS TO SITES SHOULD BE STABILISED TO REDUCE THE LIKELIHOOD OF VEHICLES TRACKING SOIL MATERIALS ONTO PUBLIC ROADS AND ENSURE ALL-WEATHER FNTRY/FXIT

SOIL EROSION CONTROL INSTRUCTIONS

- 16. EARTH BATTERS WILL BE CONSTRUCTED WITH AS LOW A GRADIENT AS PRACTICABLE BUT NO STEEPER, UNLESS OTHERWISE NOTED THAN
 - 2(H):1(V) WHERE SLOPE LENGTH LESS THAN 12 **METRES**
 - 2.5(H):1(V) WHERE SLOPE LENGTH BETWEEN 12 AND 16 METRES
 - 3(H):1(V) WHERE SLOPE LENGTH BETWEEN 16 AND 20 METRES
 - 4(H):1(V) WHERE SLOPE LENGTH GREATER THAN 20 METRES
- 17. ALL WATERWAYS, DRAINS, SPILLWAYS AND THEIR OUTLETS WILL BE CONSTRUCTED TO BE STABLE IN AT LEAST THE 1:20 YEAR ARI, TIME OF CONCENTRATION STORM EVENT.
- 18. WATERWAYS AND OTHER AREAS SUBJECT TO CONCENTRATED FLOWS AFTER CONSTRUCTION ARE TO HAVE A MAXIMUM GROUNDCOVER C-FACTOR OF 0.05 (70% GROUND COVER) WITHIN 10 WORKING DAYS FROM COMPLETION OF FORMATION. FLOW VELOCITIES ARE TO BE LIMITED TO THOSE SHOWN IN TABLE 5-1 OF "MANAGING URBAN STORMWATER - SOILS AND CONSTRUCTION", DEPT OF HOUSING 1998 (BLUE BOOK). FOOT AND VEHICULAR TRAFFIC WILL BE PROHIBITED IN THESE AREAS.
- 19. STOCKPILES AFTER CONSTRUCTION ARE TO HAVE A MAXIMUM GROUND-COVER C-FACTOR OF 0.1 (60% GROUND-COVER) WITHIN 10 WORKING DAYS FROM COMPLETION OF FORMATION.
- ALL LANDS, INCLUDING WATERWAYS AND STOCKPILES, DURING CONSTRUCTION ARE TO HAVE A MAXIMUM GROUND-COVER C-FACTOR OF 0.15 (50% GROUND COVER) WITHIN 20 WORKING DAYS FROM INACTIVITY EVEN THOUGH WORKS MAY CONTINUE LATER.
- FOR AREAS OF SHEET FLOW USE THE FOLLOWING GROUND COVER PLANT SPECIES FOR TEMPORARY COVER: JAPANESE MILLET 20 KG/HA AND OATS 20 KG/HA.
- PERMANENT REHABILITATION OF LANDS AFTER CONSTRUCTION WILL ACHIEVE A GROUND-COVER C-FACTOR OF LESS THAN 0.1 AND LESS THAN 0.05 WITHIN 60 DAYS. NEWLY PLANTED LANDS WILL BE WATERED REGULARLY UNTIL AN EFFECTIVE COVER IS ESTABLISHED AND PLANTS ARE GROWING VIGOROUSLY. FOLLOW-UP SEED AND FERTILISER WILL BE APPLIED AS NECESSARY.
- REVEGETATION SHOULD BE AIMED AT RE-ESTABLISHING NATURAL SPECIES, NATURAL SURFACE SOILS SHOULD BE REPLACED AND NON-PERSISTANT ANNUAL COVER CROPS SHOULD BE USED

WASTE CONTROL INSTRUCTIONS

- 24. ACCEPTABLE BINS WILL BE PROVIDED FOR ANY CONCRETE AND MORTAR SLURRIES, PAINTS, ACID WASHING, LIGHTWEIGHT WASTE MATERIALS AND LITTER. CLEARANCE SERVICES WILL BE PROVIDED AT LEAST WEEKLY. DISPOSAL OF WASTE WILL BE IN A MANNER APPROVED BY THE SITE SUPERINTENDENT.
- ALL POSSIBLE POLLUTANT MATERIALS ARE TO BE STORED WELL CLEAR OF ANY POORLY DRAINED AREAS, FLOOD PRONE AREAS, STREAMBANKS, CHANNELS AND STORMWATER DRAINAGE AREAS. STORE SUCH MATERIALS IN A DESIGNATED AREA UNDER COVER WHERE POSSIBLE AND WITHIN CONTAINMENT BUNDS.
- ALL SITE STAFF AND SUB-CONTACTORS ARE TO BE INFORMED OF THEIR OBLIGATION TO USE WASTE CONTROL FACILITIES PROVIDED.
- ANY DE-WATERING ACTIVITIES ARE TO BE CLOSELY MONITORED TO ENSURE THAT WATER IS NOT POLLUTED BY SEDIMENT, TOXIC MATERIALS OR PETROLEUM PRODUCTS.
- PROVIDE DESIGNATED VEHICULAR WASHDOWN AND MAINTENANCE AREAS WHICH ARE TO HAVE CONTAINMENT

PROCEDURE FOR DE-WATERING

- ENSURE PERMISSION FOR DE-WATERING IS RECEIVED FROM AUTHORITIES BEFORE PUMPING OUT.
- AN ON-SITE TREATMENT PROCESS DISCHARGING TO THE STORMWATER SYSTEM WILL BE IMPLEMENTED. ALL SITE WATERS DURING CONSTRUCTION WILL BE CONTAINED ON SITE AND RELEASED ONLY WHEN pH IS BETWEEN 8.5 & 6.5, SUSPENDED SOLIDS ARE LESS THAN 50mg/L, TURBIDITY LESS THAN 100 NTU'S, OIL AND GREASE LESS THAN 10mg/L AND BIOCHEMICAL OXYGEN DEMAND (BOD5) LESS THAN 30mg/L (FOR STORMS LESS INTENSE THAN 1 IN 5 YEAR EVENTS)
- METHODS OF SAMPLING AND ANALYSIS OF WATER QUALITY WILL BE IN ACCORDANCE WITH THE APPLICABLE METHOD LISTED IN THE EPA PUBLISHED APPROVED METHODS FOR THE SAMPLING ANALYSIS OF WATER POLLUTANTS IN NEW SOUTH WALES
- WHERE LABORATORY ANALYSIS IS REQUIRED AS INDICATED BY IN-SITU TESTING, APPROPRIATE SAMPLE BOTTLES AND PRESERVATIVES WILL BE USED AND GUIDANCE FOR THE SAMPLING METHOD OBTAINED FROM APPLICABLE PARTS OF AS5667.1 AND AS5667.6. ANALYSIS WILL BE UNDERTAKEN WHERE PRACTICAL BY A NATA REGISTERED LABORATORY CERTIFIED TO PERFORM THE APPLICABLE ANALYSIS.
- A FURTHER INSPECTION WILL BE CARRIED OUT DURING A STORM EVENT (DURING WORK HOURS WHERE POSSIBLE) TO ENSURE CONTROLS ARE COPING WITH THE EVENT. THIS APPLIES TO ANY RAIN EVENT AS WELL
- AS EXCAVATION TO TOP SOIL PROGRESSES, ANY WATER COLLECTED AT THE BOTTOM OF EXCAVATIONS WILL BE DIVERTED TO A TEMPORARY SEDIMENTATION BASIN OR SETTLEMENT TANK. IF THE WATER CONTAINS ONLY SEDIMENTS, IT WILL BE FILTERED AND PUMPED TO STORMWATER, BEFORE THIS CAN HAPPEN IT MUST
- CONTAIN LESS THAN 50mg/L TOTAL SUSPENDED SOLIDS.
 POLLUTED WATER MUST NOT ENTER THE STORMWATER SYSTEM. IN SOME CIRCUMSTANCES, A LIQUID WASTE COMPANY MAY BE REQUIRED TO COLLECT CONTAMINATED WATER FOR DISPOSAL AT A LICENSED TREATMENT FACILITY



PLANS APPROVED BY THE LAND AND **ENVIRONMENT COURT OF NSW**

PROCEEDINGS NO: 2023/250690


DATED: 28 March 2024

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L	RE-ISSUED FOR APPROVAL	23.02.24	SJ	BK	
K	RE-ISSUED FOR APPROVAL	25.01.24	SJ	BK	
J	RE-ISSUED FOR APPROVAL	25.01.24	SJ	BK	
Issue	Description	Date	Drawn	Approved	
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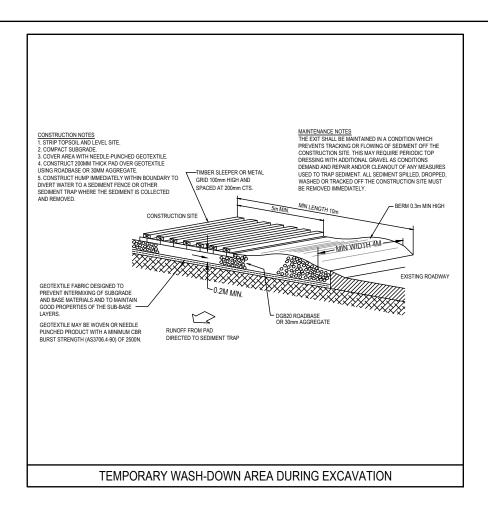
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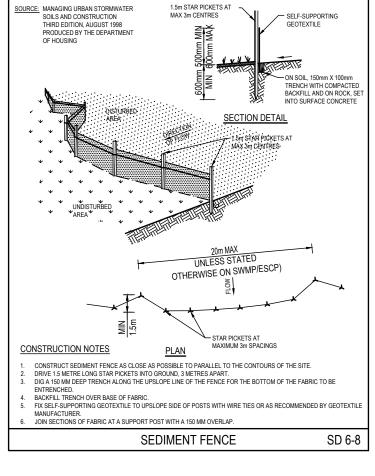



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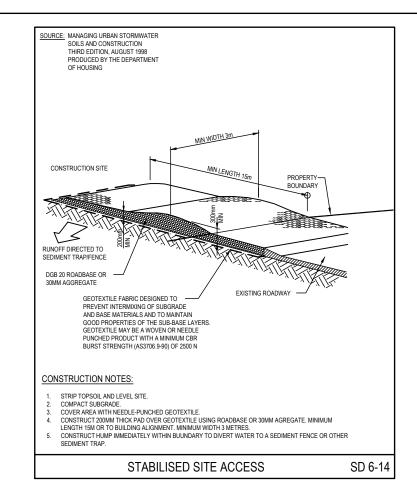
No.8 & 9 COLLEGE STREET


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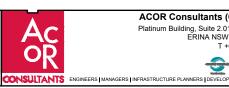


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23.02.24 SJ BK 25.01.24 SJ BK RE-ISSUED FOR APPROVAL 25.01.24 SJ BK
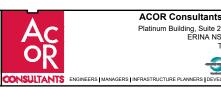
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PLANS APPROVED BY THE LAND AND

ENVIRONMENT COURT OF NSW

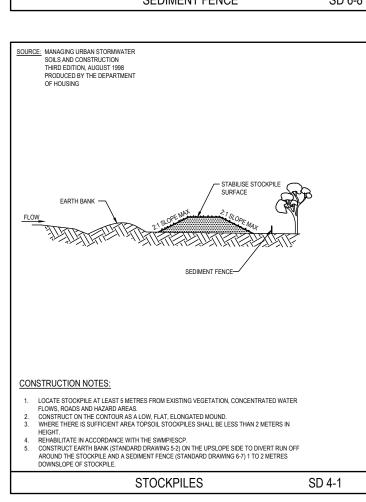PROCEEDINGS NO: 2023/250690

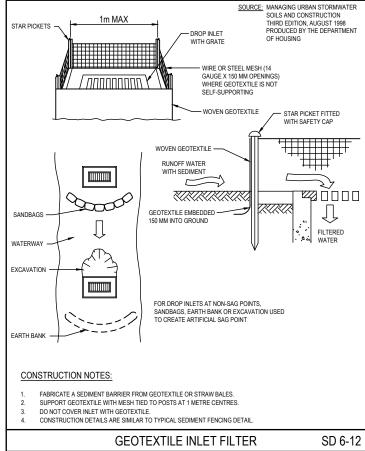DATED: 28 March 2024

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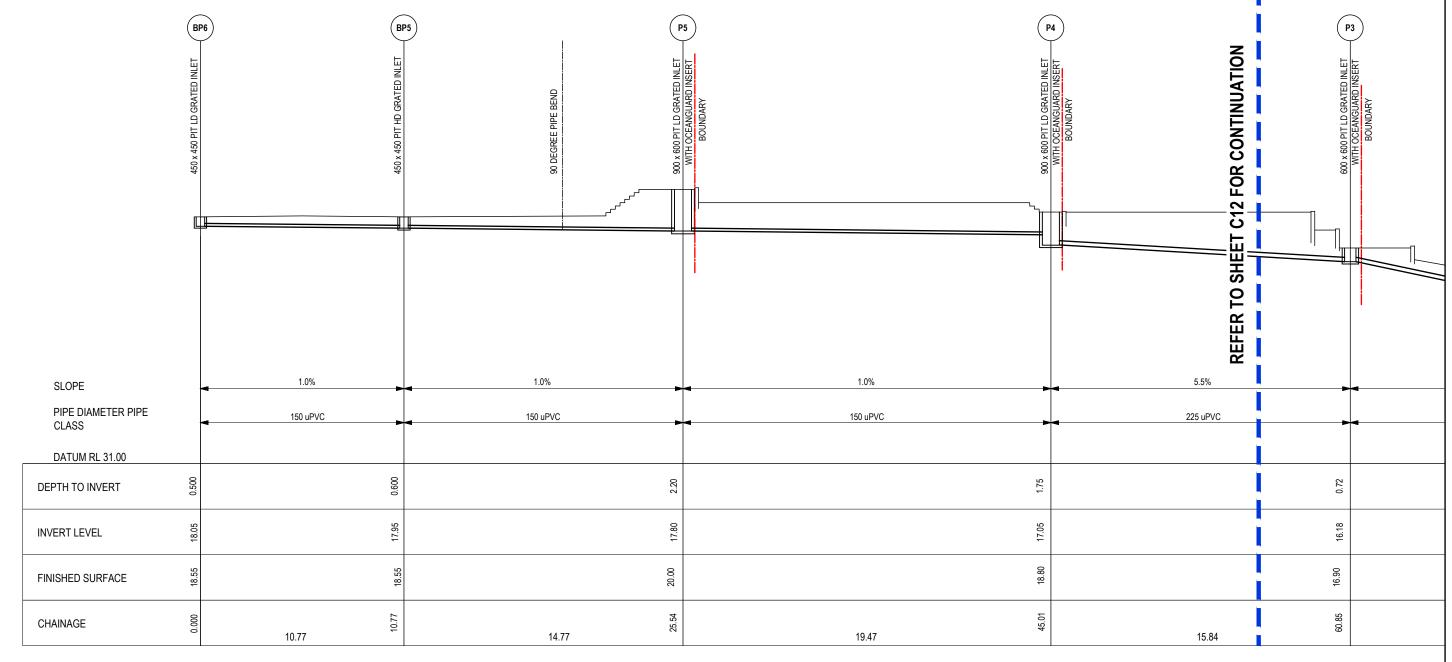
CC210334

C8

ACOR Consultants (CC) Pty Ltd Platinum Building, Suite 2.01, 4 Ilya Avenue ERINA NSW 2250, Australia

No.29, 31 & 35 REDDALL STREET & No.8 & 9 COLLEGE STREET


MANLY



DRAINAGE LONG SECTION - LINE 'A'

HORIZONTAL SCALE - 1:100/A1, 1:200/A3 VERTICAL SCALE - 1:100/A1, 1:200/A3



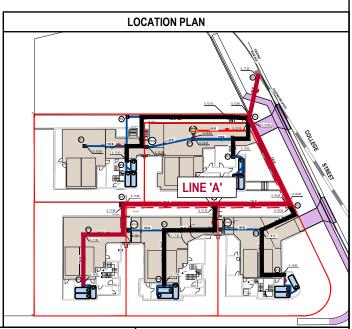

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M	RE-ISSUED FOR APPROVAL	26.02.24	SJ	BK	No
L	RE-ISSUED FOR APPROVAL	23.02.24	SJ	BK	ĺ
K	RE-ISSUED FOR APPROVAL	25.01.24	SJ	BK	ı
J	RE-ISSUED FOR APPROVAL	25.01.24	SJ	BK	ĺ
Issue	Description	Date	Drawn	Approved	ı
1 0	1cm at full size 10cm				i

STALDONE


WOLSKI COPPIN

ACOR Consultants (CC) Pty Ltd Platinum Building, Suite 2.01, 4 llya Avenue ERINA NSW 2250, Australia T +61 2 4324 3499 DEVELOPMENT

PROPOSED RESIDENTIAL No.29, 31 & 35 REDDALL STREET & No.8 & 9 COLLEGE STREET MANLY

DRAINS LONG SECTIONS SHEET 1 OF 4 11.01.2023 AS NOTED CC210334

C11

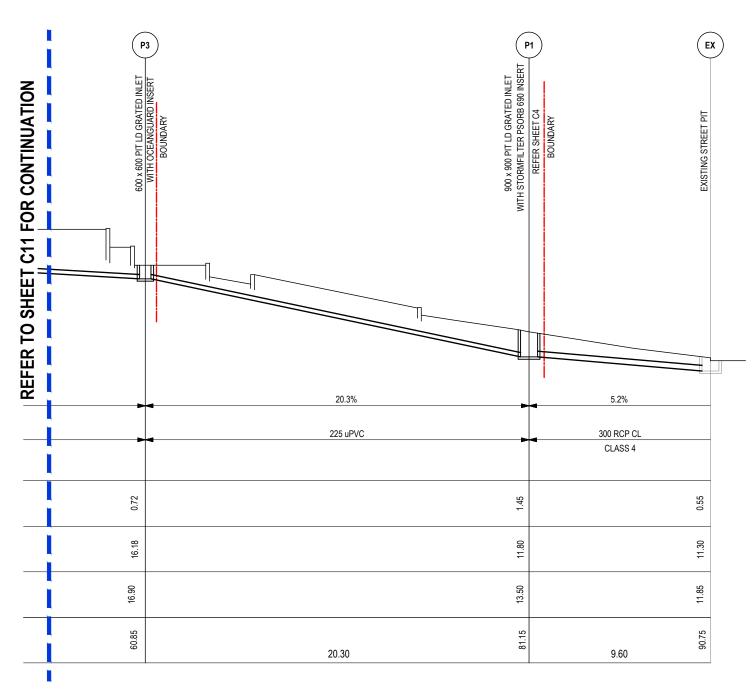

DRAINAGE LONG SECTION - LINE 'A'

HORIZONTAL SCALE - 1:100/A1, 1:200/A3 VERTICAL SCALE - 1:100/A1, 1:200/A3

beaches PLANS APPROVED BY THE LAND AND **ENVIRONMENT COURT OF NSW** PROCEEDINGS NO: 2023/250690 **DATED: 28 March 2024**


LOCATION PLAN
LINE 'A'


WOLSKI COPPIN STALDONE RE-ISSUED FOR APPROVAL 23.02.24 SJ BK RE-ISSUED FOR APPROVAL RE-ISSUED FOR APPROVAL

ACOR Consultants (CC) Pty Ltd

Platinum Building, Suite 2.01, 4 Ilya Avenue ERINA NSW 2250, Australia T +61 2 4324 3499 PROPOSED RES PROPOSED RESIDENTIAL No.29, 31 & 35 REDDALL STREET & No.8 & 9 COLLEGE STREET MANLY

DRAINS LONG SECTIONS SHEET 2 OF 4 11.01.2023 AS NOTED CC210334 C12

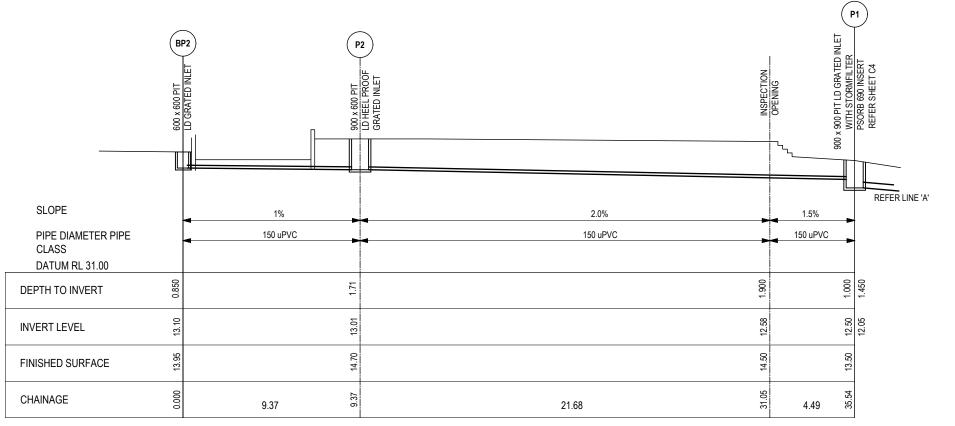

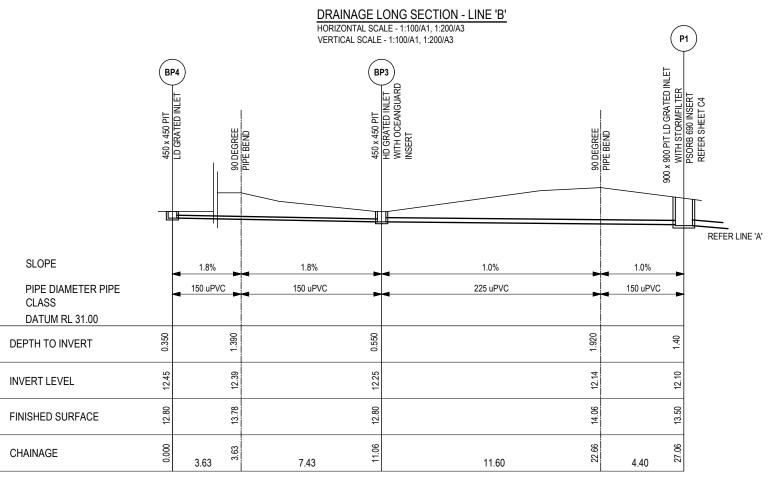

DRAINAGE LONG SECTION - LINE 'C'

HORIZONTAL SCALE - 1:100/A1, 1:200/A3 VERTICAL SCALE - 1:100/A1, 1:200/A3

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					Client	Architect
RE-ISSUED FOR APPROVAL	26.02.24	SJ	BK	North	STALDONE	WOLSKI COPPIN
RE-ISSUED FOR APPROVAL	23.02.24	SJ	BK		STALDONE	WOLSKI COPPIN
RE-ISSUED FOR APPROVAL	25.01.24	SJ	BK			
RE-ISSUED FOR APPROVAL	25.01.24	SJ	BK			
Description	Date	Drawn	Approved			



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ERINA NSW 2250, Australia
T +61 2 4324 3499



ts (C) Pty Ltd Project 2 20.1 4 llya Avenue VSW 2250, Australia T +61 2 4324 3499 DEVELOPMENT

No.29, 31 & 35 REDDALL STREET & No.8 & 9 COLLEGE STREET

DRAINS LONG SECTIONS SHEET 3 OF 4									
Drawn	Date	Scale A1	Q.A. Check						
JF	11.01.2023	AS NOTED	-						
Designed	Project No.		Dwg. No.						
BK	LCC210:	C13							


LINE 'C'




LOCATION PLAN


LOCATION PLAN

LINE 'B'

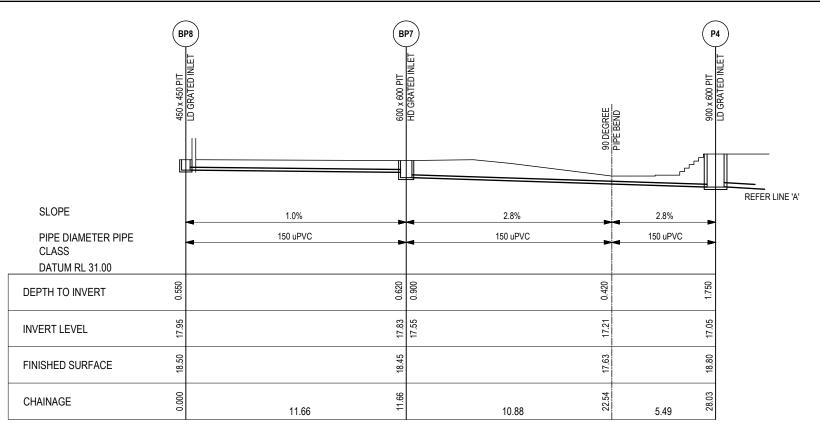

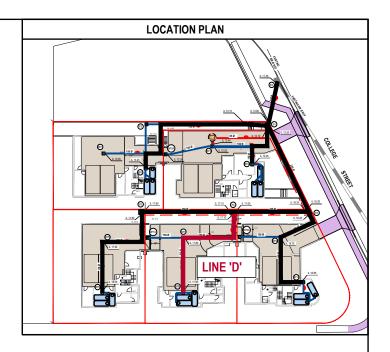

DRAINAGE LONG SECTION - LINE 'D' HORIZONTAL SCALE - 1:100/A1, 1:200/A3

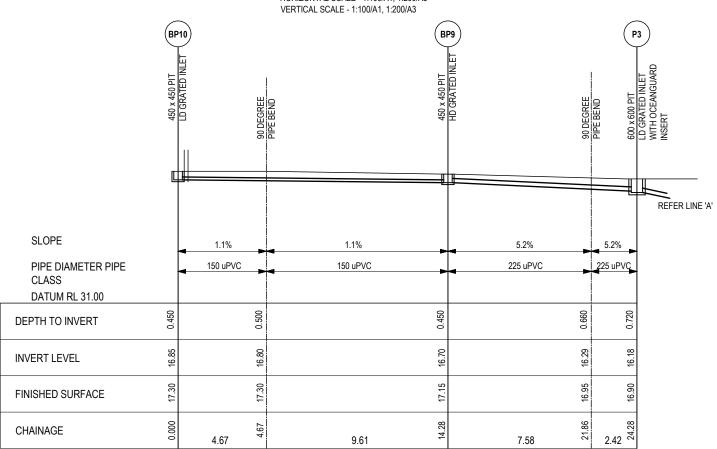




PLANS APPROVED BY THE LAND AND **ENVIRONMENT COURT OF NSW**

PROCEEDINGS NO: 2023/250690

DATED: 28 March 2024

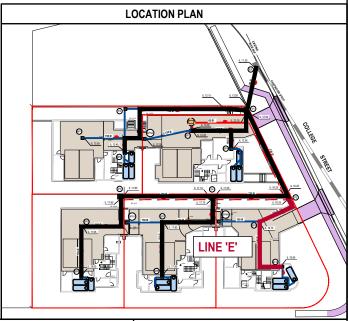

DRAINAGE LONG SECTION - LINE 'E'

HORIZONTAL SCALE - 1:100/A1, 1:200/A3

VERTICAL SCALE - 1:100/A1, 1:200/A3

STALDONE RE-ISSUED FOR APPROVAL RE-ISSUED FOR APPROVAL

WOLSKI COPPIN



ACOR Consultants (CC) Pty Ltd

Platinum Building, Suite 2.01, 4 llya Avenue ERINA NSW 2250, Australia T +61 2 4324 3499 PROPOSED RES DEVELOPMENT PROPOSED RESIDENTIAL

No.29, 31 & 35 REDDALL STREET & No.8 & 9 COLLEGE STREET

DRAINS LONG SECTIONS SHEET 4 OF 4							
Drawn	Date	Scale A1	Q.A. Check	Da			
JF	11.01.2023	AS NOTED	-				
Designed	Project No.		Dwg. No.	Iss			
BK	LCC210	334	C14	١.			

SURVEYOR

Name: COPLAND C. LETHBRIDGE

Date:

Reference: 22175 DP


PLAN OF SUBDIVISION OF LOTS 82, 83 & 84 IN D.P. 8076

L.G.A: NORTHERN BEACHES

Locality: MANLY

Reduction Ratio: 1:250 Lengths are in metres REGISTERED

DRAFT 25/01/2023

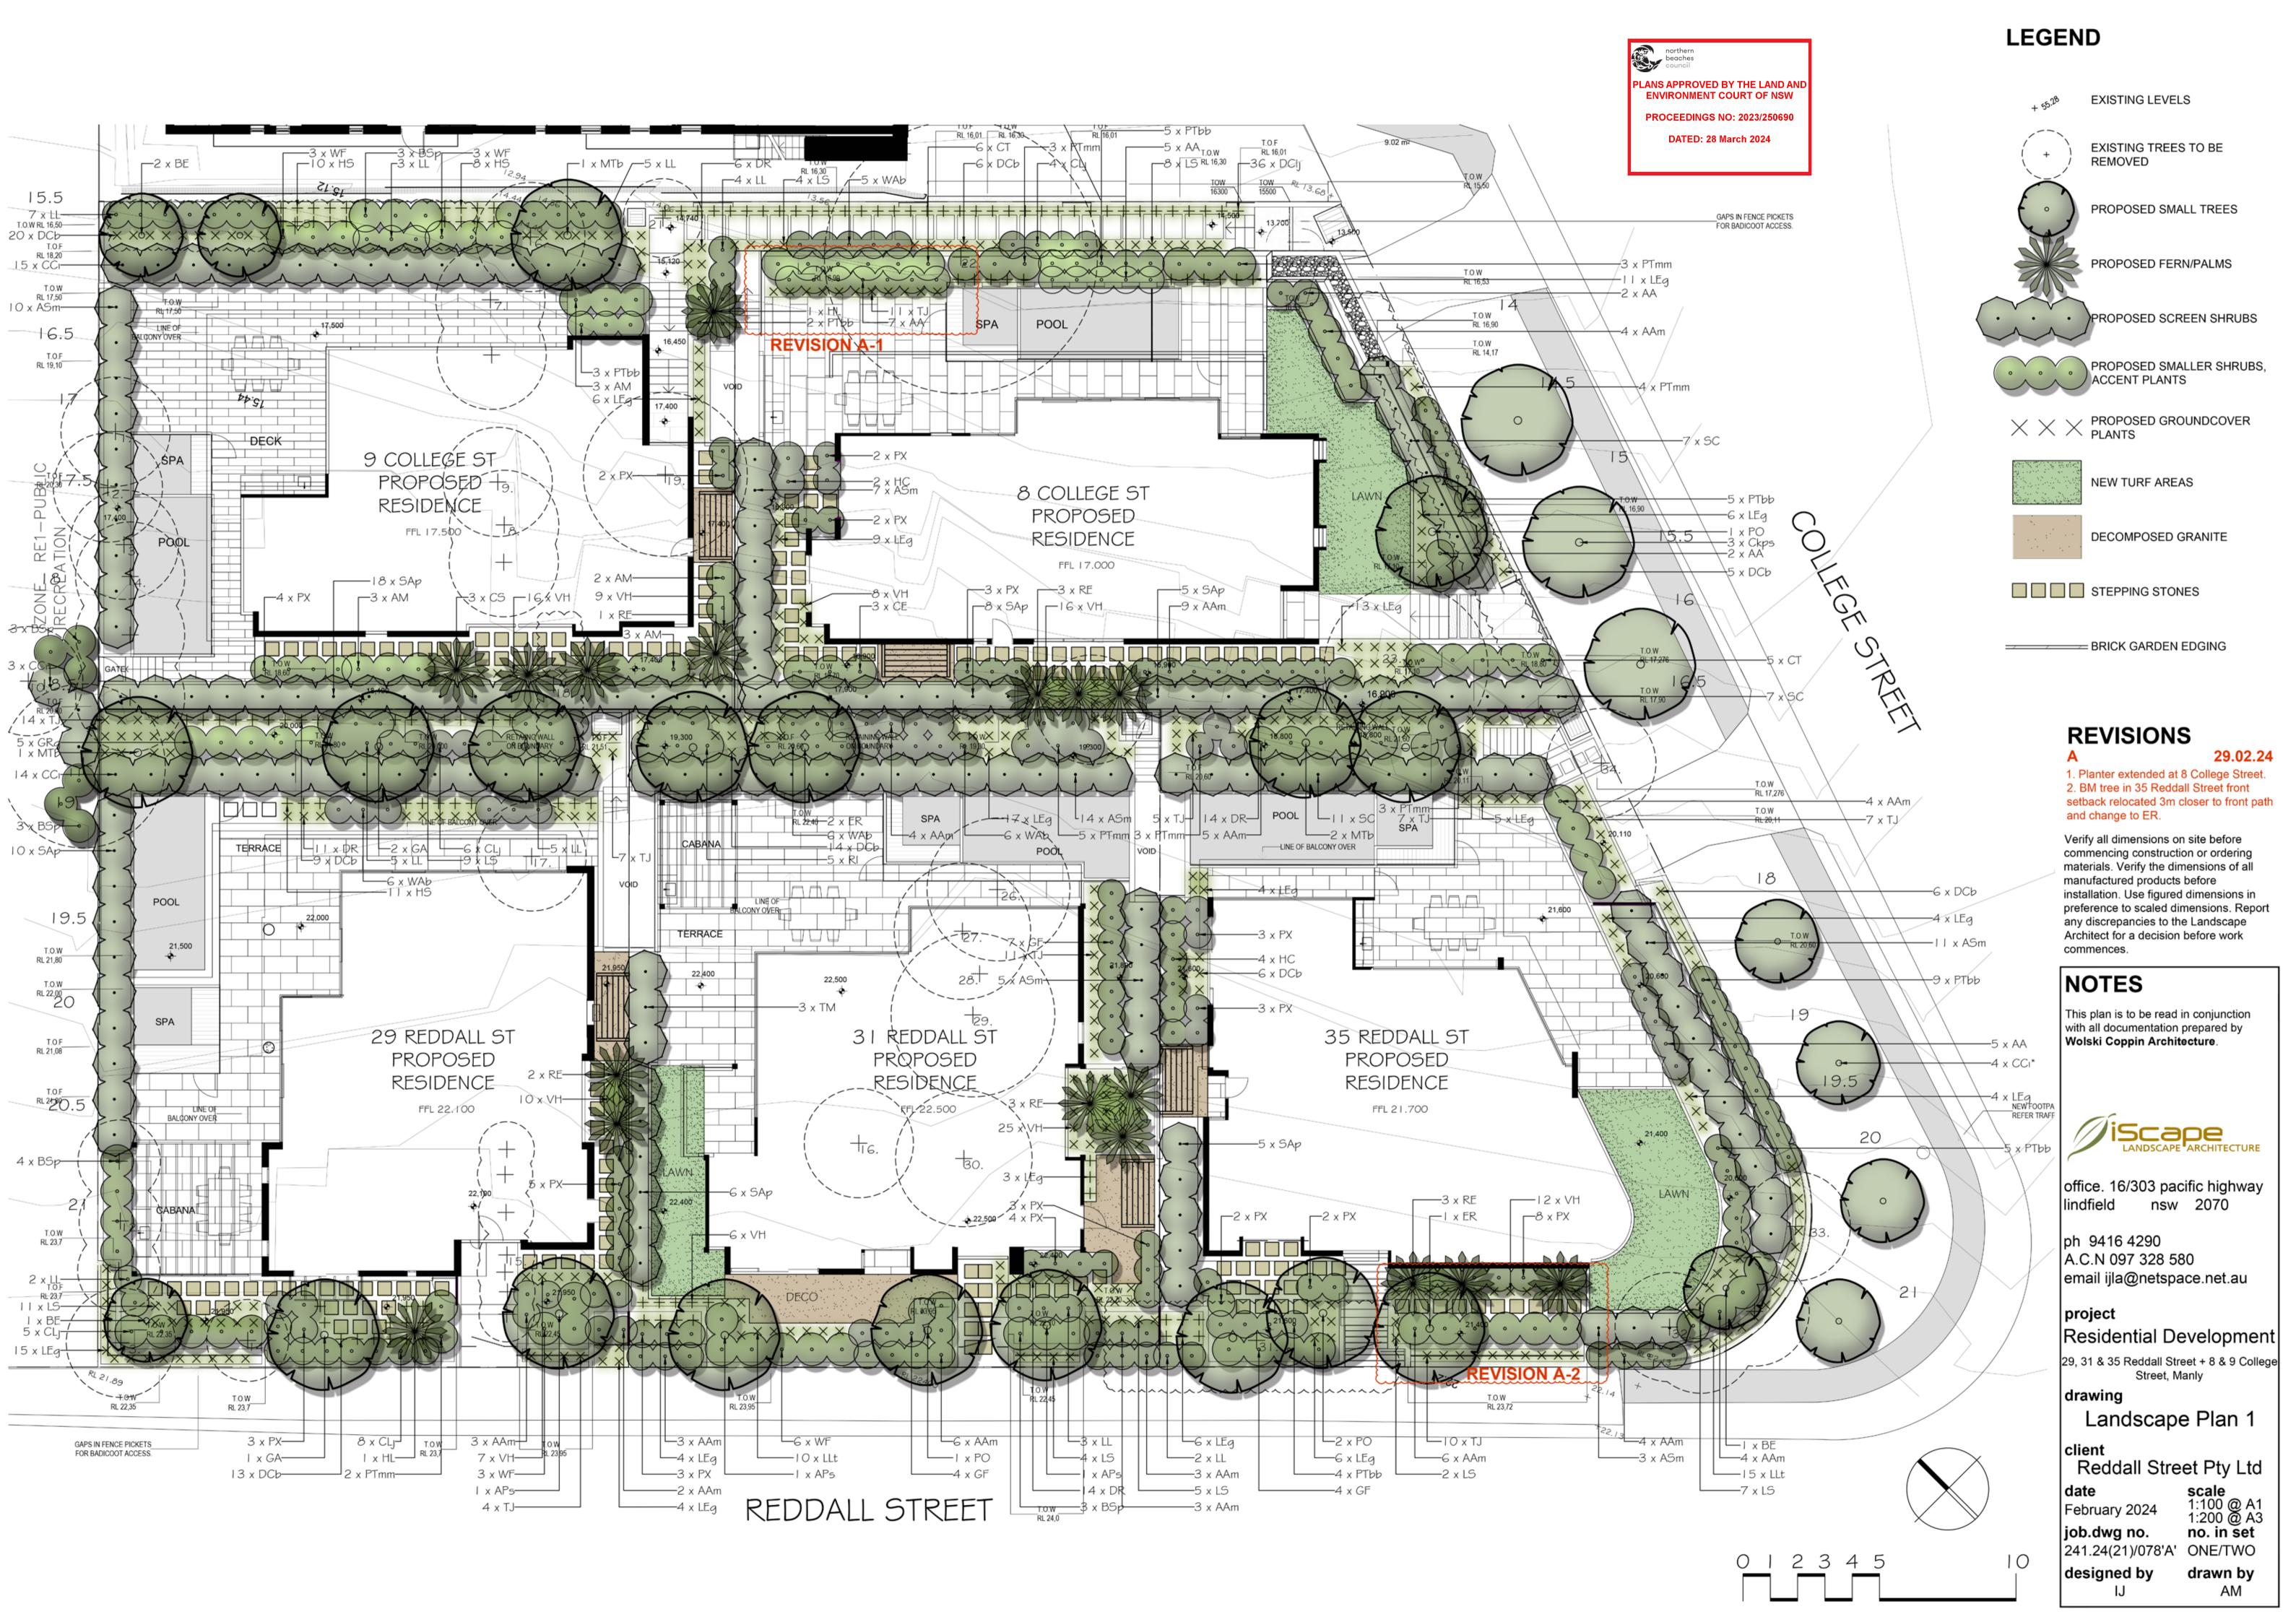

SCHEDULE OF PLANT MATERIAL

SCHEDULE OF PLANT WATERIAL								
CODE	BOTANICAL NAME	COMMON NAME	YTITNAUÇ	MATURE HEIGHT	CONTAINER SIZE	STAKE		
AA	Agave attenuata	Agave	21	1m	200mm	_		
AAm	Acmena smithii 'Allyn Magic'	Dwarf Lilli Pilli	60	1m	200mm	_		
ASm	Acmena smithii 'Minor'	Dwarf Lilli Pilli	50	3m	200mm	-		
APs	Acer palmatum 'Senkaki'	Coral Barked Maple	3	4m	75 litre	2		
AM	Alpinia mutica	Dwarf Cardemon Ginge	r 11	2m	200mm	_		
BE	Banksia ericifolia	Heath Banksia	4	3m	45 litre	-		
BSp	Banksia spinulosa	Hairpin Banksia	16	1.5m	200mm	-		
CCi	Callistemon citrinus	Bottlebrush	32	2.5m	200mm	-		
CCi*	Callistemon citrinus	Bottlebrush	4	2.5m	75 litre	-		
Ckps	Callistemon 'Kings Park Special'	Bottlebrush	3	5m	75 litre	-		
CLj	Callistemon 'Little John'	Bottlebrush	23	1m	200mm	-		
CS	Chamaedorea seifrizii	Bamboo Palm	3	2.5m	200mm	-		
CT	Choisya ternata	Mexican Orange Blossom	11	1.5m	200mm	-		
CE	Colocasia esculenta	Elephant Ear	3	2m	200mm	-		
DCb	Dianella 'Cassa Blue'	Blue Flax Lily	79	0.4m	140mm	_		
DCIj	Dianella caerulea 'Little Jess'	Little Jess Dianella	36	0.4m	140mm	-		
DR	Dianella revoluta	Flax Lily	45	0.4m	140mm	-		
ER	Elaeocarpus reticulatus	Blueberry Ash	3	5m	45 litre	2		
GF	Gardenia augusta 'Florida'	Gardenia	15	1m	200mm	_		
GRg	Grevillea 'Robyn Gordon'	Robyn Gordon	5	1.5m	200mm	_		
GA	Gordonia axillaris	Fried Egg Plant	3	5m	45 litre	2		
HC	Hedychium coronarium	Fragrent White Ginger	6	2m	200mm	-		
HS	Hibbertia scandens	Guinea Flower	29	0.4m	140mm	_		
HL	Hyophorbe lagenicaulis	Bottle Palm	2	3m	45 litre	2		
LEg	Liriope 'Evergreen Giant'	Turf Lily	127	0.6m	140mm	-		
LL	Lomandra longifolia	Mat Rush	36	1m	140mm	-		
LLt	Lomandra longifolia 'Tanika'	Tanika Lomandra	37	0.4m	140mm	-		
LS	Lomandra 'Seascape'	Seascape Lomandra	50	0.4m	140mm	-		
MTb	Magnolia grandiflora 'Teddy Bear'	Dwarf Magnolia	4	4m	45 litre	2		
РО	Plumeria obtusa	Singapore Plumeria	4	4m	45 litre	2		
PTbb	Phormium tenax 'Bronze Baby'	Dwarf NZ Flax	33	1m	140mm	-		
PTmm	Pittosporum 'Miss Muffet'	Pittosporum	23	1m	200mm	-		
PX	Philodendron 'Xanadu'	Xanadu	49	0.75m	200mm	-		
RI	Rhaphiolepis indica	Indian Hawthorn	5	1.5m	200mm	-		
RE	Rhapis excelsa	Lady Palm	12	3m	200mm	-		
SC	Syzigium 'Cascade'	Cascasde Lillypilly	25	2m	200mm	-		
SAp	Syzygium australe 'Pinnacle'	Dwarf Lilli Pilli	52	3m	200mm	-		
TJ	Trachelospermum jasminoides	Star Jasmine	76	0.4m	140mm	_		
TM	Thysanolaena maxima	Tiger Grass	3	2m	200mm	-		
VH	Viola hederacea	Native Violet	109	0.1m	140mm	-		
WAb	Westringia fruticosa 'Aussie Box'	Dwarf Coastal Roseman		1m	200mm	_		
WF	Westringia fruticosa	Coastal Rosemary	15	2m	200mm	-		
		-						

SCHEDIII E OF EXISTING TREES

SCHEDULE OF EXISTING TREES							
KEY	BOTANICAL NAME	COMMON NAME	HEIGHT X SPREAL				
1.	Murraya paniculata	Orange jessamine	7 x 6m				
2.	Melaleuca bracteata	Black Tea-tree	7.5 x 6m				
3.	Camellia sasanqua	Sasanqua camellia	6.5 x 4m				
4.	Murraya paniculata x 4	Orange jessamine	6 x 5m				
5.	Viburnum odoratissimum	Sweet viburnum	6.5 x 13m				
6.	Olea europaea L. subsp.cuspidata	African olive	-				
7.	Archontophoenix cunninghamiana	Bangalow palm	-				
8.	Murraya paniculata x 2	Orange jessamine	4.5 x 6m				
9.	Archontophoenix alexandrae,	Alexandra palm	-				
10.	Ficus benjamina	Weeping fig	5.5 x 4m				
11.	Nerium oleander	Oleander	5 x 6m				
12.	Robinia pseudoacacia 'Frisia'	Golden Robinia	-				
13.	Elaeocarpus reticulatus cv	Blueberry Ash 'Prima Donna'	5 x 5m				
14.	Magnolia grandiflora cv.	Little Gem	4.5 x 3m				
15.	Syzygium australe cv. x 9	Brush Cherry	5-6 x 10m				
16.	Cupressus sp.	Cypress	-				
17.	Pittosporum undulatum	Native Daphne	-				
18.	Camellia japonica x 3	Viburnum odoratissimum x 1	5 x 5.5m				
19.	Ficus rubiginosa	Port Jackson fig	10 x 7m				
20.	Cyathea cooperi	Australian Tree fern	4 x 5m				
21.	Archontophoenix alexandrae	Alexandra palm	-				
22.	Strelitzia nicolai	Giant White Bird of Paradise	13 x 10m				
23.	Plumeria acutifolia	Frangipani	4.5 x 6m				
24.	Phoenix canariensis	Canary Island date palm	-				
25.	Olea europaea L. subsp. cuspidata	African olive	-				
26.	Phoenix canariensis	Canary Island date palm	-				
27.	Dracaena marginata	Red-edged Dracaena	6 x 5m				
28.	Archontophoenix alexandrae	Alexandra palm	-				
29.	Ficus lyrata	Fiddle-leaved fig	8 x 6m				
30.	Plumeria acutifolia	Frangipani	4.5 x 5m				
31.	Plumeria acutifolia x 4	Frangipani	5 x 12m				
32.	Syagrus romanzoffiana x 3	Cocos palm	-				
33.	Phoenix canariensis	Canary Island date palm	-				
34.	Syagrus romanzoffiana	Cocos palm	-				
35.	Nerium oleander	Oleander	-				

NOTE: Also refer to Tree Impact Assessment prepared by Catriona Mackenzie, Urban Forestry Australia for Trees No.1-35.





Acer palmatum 'Senkaki'



Acmena smithii 'Allyn Magic'



Acmena smithii 'Minor'



Agave attenuata



Alpinia mutica

Choisya ternata



Banksia ericifolia

Colocasia esculenta



Banksia spinulosa





Dianella 'Cassa Blue'



Callistemon citrinus



Plumeria obtusa

Rhapis excelsa



Callistemon 'Kings Park Special'

Dianella revoluta



Callistemon 'Little John'

Elaeocarpus reticulatus



Gardenia augusta 'Florida'

Chamaedorea seifrizii



Lomandra longifolia 'Tanika'

Gordonia axillaris



Grevillea 'Robyn Gordon'



Hedychium coronarium









Magnolia grandiflora 'Teddy Bear'

Syzigium 'Cascade'



commences.

NOTES This plan is to be read in conjunction with all documentation prepared by Wolski Coppin Architecture.



1. Planter extended at 8 College Street. 2. BM tree in 35 Reddall Street front setback relocated 3m closer to front path

Verify all dimensions on site before

any discrepancies to the Landscape Architect for a decision before work

commencing construction or ordering materials. Verify the dimensions of all manufactured products before installation. Use figured dimensions in preference to scaled dimensions. Report

and change to ER.

29.02.24

office. 16/303 pacific highway

lindfield nsw 2070

ph 9416 4290 A.C.N 097 328 580 email ijla@netspace.net.au

project Residential Development

29, 31 & 35 Reddall Street + 8 & 9 College Street, Manly

drawing

Landscape Plan 2 Reddall Street Pty Ltd

scale 1:100 @ A1 1:200 @ A3 date February 2024 job.dwg no. no. in set 241.24(21)/079'A' TWO/TWO

designed by drawn by

0 | 2 3 4 5





Phormium tenax 'Bronze Baby'

Trachelospermum jasminoides



Thysanolaena maxima

Liriope 'Evergreen Giant'





Viola hederacea

Lomandra longifolia





Rhaphiolepis indica





Westringia fruticosa 'Aussie Box'



Syzygium australe 'Pinnacle'

Westringia fruticosa



PLANS APPROVED BY THE LAND AND ENVIRONMENT COURT OF NSW