DEVELOPMENT APPLICATION | REVISION A

201 Headland Road, North Curl Curl NSW 2099

LOCATION (NTS)



BASIX SPECIFICATION

DRAWINGS LIST

DRAWING No.	DESCRIPTION	REV	DATE ISSUED
DA 00	COVER PAGE	А	03.11.2025
DA 01	SITE ANALYSIS	А	03.11.2025
DA 10	LOWER GROUND FLOOR PLAN	А	03.11.2025
DA 11	GROUND FLOOR PLAN	А	03.11.2025
DA 12	FIRST FLOOR PLAN	А	03.11.2025
DA 13	ROOF PLAN	А	03.11.2025
DA 20	NORTH ELEVATION	А	03.11.2025
DA 21	SOUTH ELEVATION	А	03.11.2025
DA 22	EAST ELEVATION	А	03.11.2025
DA 23	WEST ELEVATION	А	03.11.2025
DA 30	SECTION AA	А	03.11.2025
DA 31	SECTION BB	А	03.11.2025
DA 40	SHADOW DIAGRAM - 9AM 21 JUNE	А	03.11.2025
DA 41	SHADOW DIAGRAM - 12PM 21 JUNE	А	03.11.2025
DA 42	SHADOW DIAGRAM - 3PM 21 JUNE	А	03.11.2025
DA 50	LANDSCAPE CALCULATIONS	А	03.11.2025
DA 51	POS CALCULATIONS	А	03.11.2025
DA 60	EXTERNAL FINISHES SCHEDULE	А	03.11.2025

CONSULTANTS

SURVEYOR

CMS Surveyors 2/99A South Creek Rd, Dee Why, NSW 2099 (02) 9971 4802 info@cmssurveyors.com.au

kburgess@martens.com.au

Kenneth Burgess Martens & Associates Pty Ltd

Drew Roberts

GEOTECHNICAL ENGINEER

Suite 201, 20 George Street, Hornsby, NSW

HYDRAULIC ENGINEER Wylie Faeste

NB Consulting 02 9984 7000 drew@astuteplanning.com.au

0472 648 087

Compliant

Astute Planning

PLANNING CONSULTANT

drew@astuteplanning.com.au

SITE CALCULATIONS

AREA CALCULATIONS

EXISTING AREA

LANDSCAPING - SITE COVERAGE Control - 40% of site area

Allowable Cover Proposed Cover

335.48 m² 415.05 m²

838.7 m²

BASIX™Certificate

Alterations and Additions



Project name	Headland
Street address	201 HEADLAND Road NORTH CURL CURL 2099
Local Government Area	Northern Beaches Council
Plan type and number	Deposited Plan DP12515
Lot number	6
Section number	-
Project type	
Dwelling type	Dwelling house (detached)
Type of alteration and addition	The estimated development cost for my renovation work is \$50,000 or more, and does not include a pool (and/or spa).
N/A	N/A
Certificate Prepared by plea	se complete before submitting to Council or PCA)
Name / Company Name: Modify Home	es Pty Ltd

Fixtures and systems		Show on CC/CDC Plans & specs	Certifier Check
Hot water			
The applicant must install the following hot water system in the development: solar (electric-boosted) system that is eligible to create Renewable Energy (Electricity) Regulations 2001 (incorporating Amendment Regulations 2005 (in. 2)).	~	~	~
Lighting			
The applicant must ensure a minimum of 40% of new or altered light fixtures are fitted with fluorescent, compact fluorescent, or light- emitting-diode (LED) lamps.		-	-
Fixtures			
The applicant must ensure new or altered showerheads have a flow rate no greater than 9 litres per minute or a 3 star water rating.		~	~
The applicant must ensure new or altered toilets have a flow rate no greater than 4 litres per average flush or a minimum 3 star water rating.		~	~
The applicant must ensure new or altered taps have a flow rate no greater than 9 litres per minute or minimum 3 star water rating.		_	

Construction			Show on DA Plans	Show on CC/CDC Plans & specs	Certifie Check
Insulation requirements					
	red construction (floor(s), walls, and ceilings tional insulation is not required where the are of altered construction where insulation alres	a of new construction is less than 2m2, b)	•	~	~
Construction	Additional insulation required (R-value)	Other specifications			
concrete slab on ground floor.	nil	N/A			
suspended floor with enclosed subfloor: framed (R0.7).	R0.60 (down) (or R1.30 including construction)	N/A			
floor above existing dwelling or building.	nil	N/A			
external wall: framed (weatherboard, fibro, metal clad)	R1.30 (or R1.70 including construction)				
external wall: concrete block/ plasterboard	R1.18 (or R1.70 including construction)				
external wall: other/undecided	R1.70 (including construction)				
flat ceiling, pitched roof	ceiling: R1.20 (up), roof: foil backed blanket (55 mm)	light (solar absorptance < 0.475)			

Glazing requirements	Show on DA Plans	Show on CC/CDC Plans & specs	Certifier Check
Windows and glazed doors			
The applicant must install the windows, glazed doors and shading devices, in accordance with the specifications listed in the table below. Relevant overshadowing specifications must be satisfied for each window and glazed door.	-	~	~
The following requirements must also be satisfied in relation to each window and glazed door:		~	~
Each window or glazed door with standard aluminium or timber frames and single clear or toned glass may either match the description, or, have a U-value and a Solar Heat Gain Coefficient (SHCC) no greater than that listed in the table below. Total system U-values and SHCSC must be calculated in accordance with National Ferestration Rating Council (NFRC) conditions.		~	~
Each window or glazed door with improved frames, or pyrubytic low-e glass, or clearitat papicious glazing, or tonediair gapticless glazing, or must have a U-value and a Solari Heat Gain Coefficient (SRIGC) or greater than tal steal of the teble below. Total system U-values and SHIGCs must be calculated in accordance with National Ferestration Rating Council (NFRC) conditions. The description is provised for information only. Alternative systems with complying U-value and SHIGC may be substitution.		~	~
For projections described in millimetres, the leading edge of each eave, pergola, verandah, balcony or awning must be no more than 500 mm above the head of the window or glazed door and no more than 2400 mm above the sill.	•	~	~
For projections described as a ratio, the ratio of the projection from the wall to the height above the window or glazed door sill must be at least that shown in the table below.	~	~	~
Pergolas with polycarbonate roof or similar translucent material must have a shading coefficient of less than 0.35.		~	~
Pergolas with fixed battens must have battens parallel to the window or glazed door above which they are situated, unless the pergola also shades a perpendicular window. The spacing between battens must not be more than 50 mm.		~	

ABREVIATIONS

BALC - BALCONY BL - BLOCKWORK **BW - BRICKWORK** CPT - CARPET CR - CEMENT RENDER

CT - CERAMIC TILE DEM - DEMOLISHED DP - DOWN PIPE

EO - ELETRICITY LINE OVERHEAD EX - EXISTING STRUCTURE

FFL - FINISHED FLOOR LEVEL G - GLASS GM - GAS METER MR - METAL ROOF OF - OVER FLOW

PAV - PAVING PF - PAINT FINISH PP - POWER POLE RF - ROOF RL - RELATIVE LEVEL

RR - ROOF RIDGE RT - ROOF TILE SD - STEEL DOOR SK - SKYLIGHT SP - STEEL PLATE

SST - SAND STONE STR - STAIR TC - TIMBER CLADDING TD - TREAD TG - TOP OF GUTTER

TPIT - TELSTRA PIT TSF - TIMBER STRIP FLOORING T - TIMBER TW - TOP OF WALL WM - WATER METER

PRELIMINARY - NOT FOR **CONSTRUCTION**

GENERAL NOTES

The Builder shall check all dimensions and levels on site prior too construction.

Notify any errors, discrepancies or omissions to the architect.

Drawings shall not be used for construction purposes until issued for construction.

Do not scale drawings. All boundaries and contours subject to survey

This drawing is to be read in conjunction with all relevant schedules, specifications and

This drawing is to be read in conjunication and an incommendation.

This drawing is copyright and is not to be replaced or used for any purpose without written consent of Modify Pty. Ltd. NOM Architect Jeremy Unger #10738

201 Headland Road, North Curl Curl NSW 2099

CLIENT Rvan & Natalie Dinsdale REASON FOR ISSUE FOR DA SUBMISSION

--- DEMOLISH STRUCTURE - BOUNDARY --- EXTENT OF APPROVED DA EXISTING SECTION


MASONRY SECTION TIMBER SECTION GLASS SECTION CONCRETE SECTION STEEL/METAL SECTION DRAWING TITLE COVER PAGE


Monday, 3 November 2025

DRAWN BY: SCALE:

CHECKED BY:



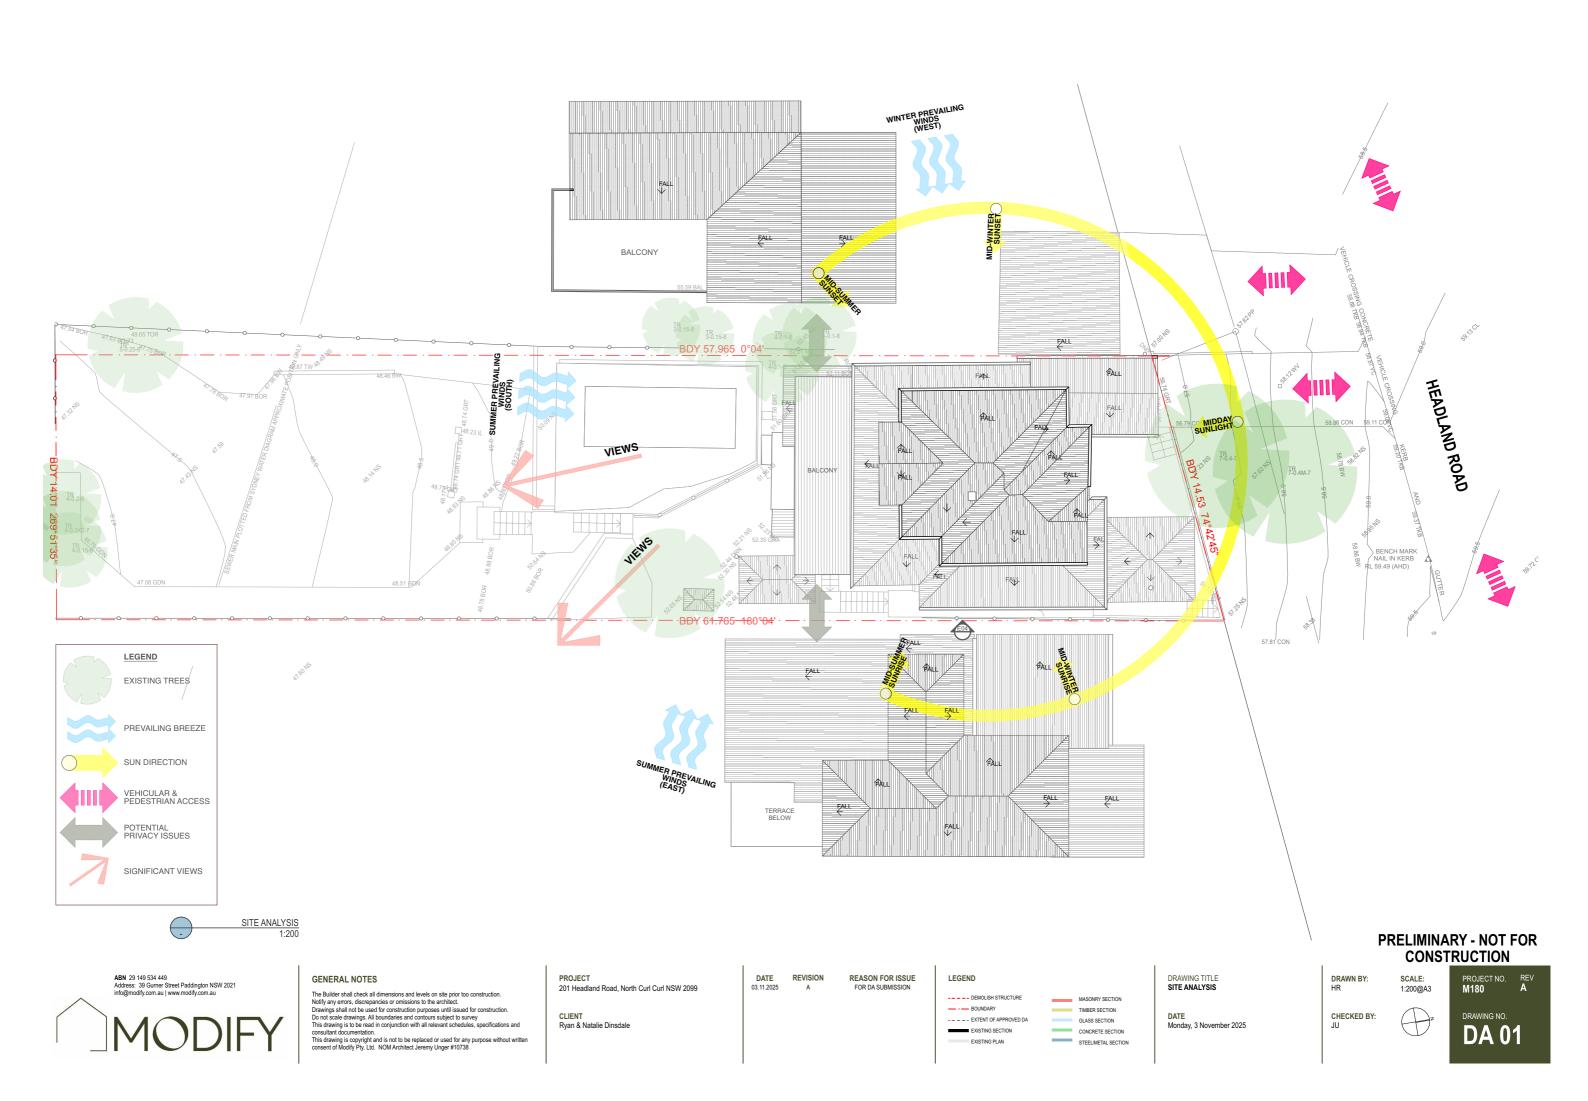

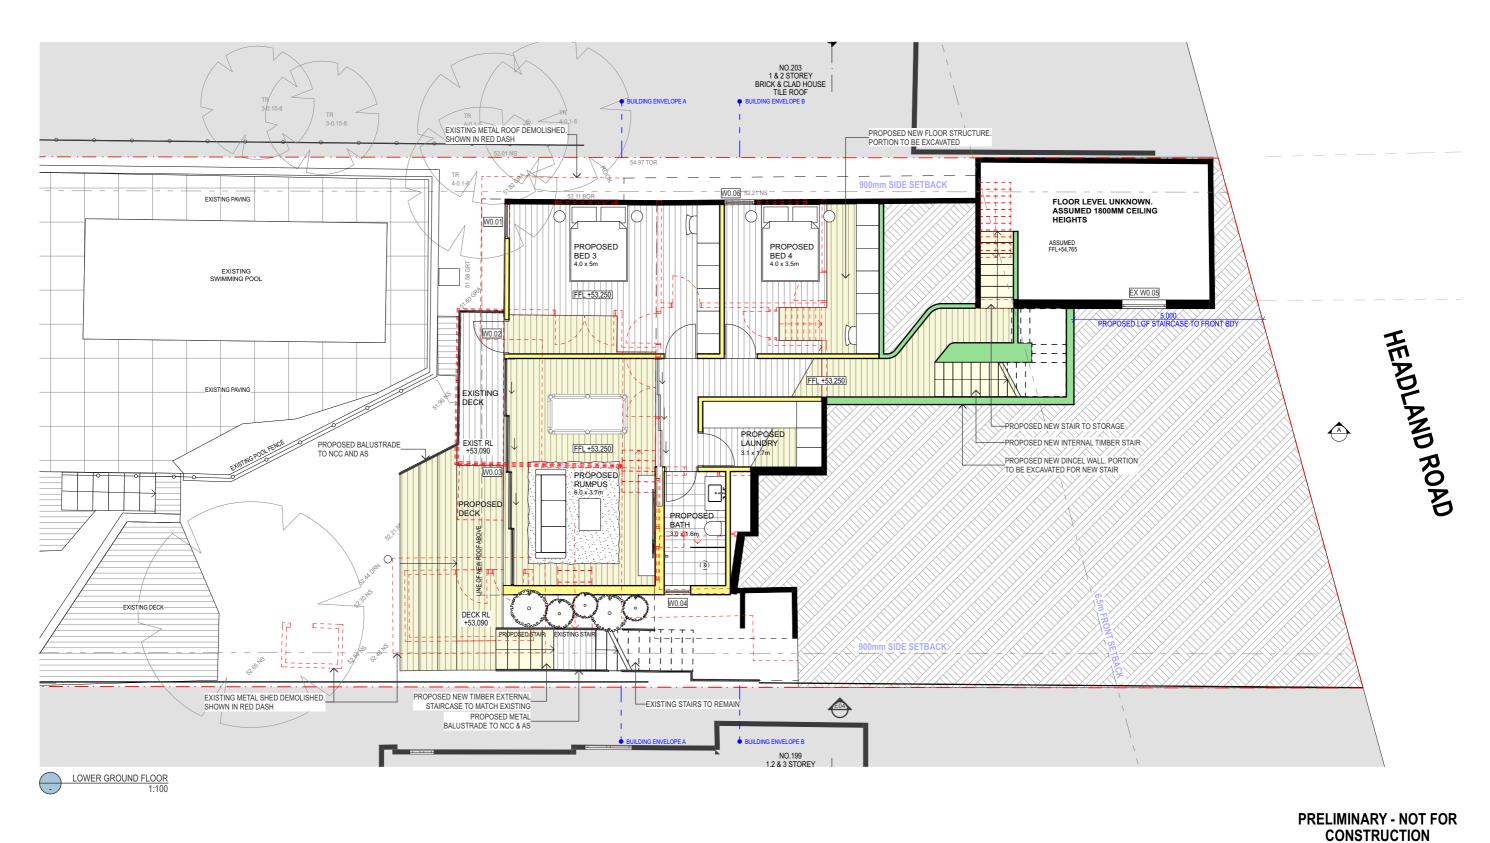



The Builder shall check all dimensions and levels on site prior too construction. Notify any errors, discrepancies or omissions to the architect. Drawings shall not be used for construction purposes until issued for construction. Do not scale drawings. All boundaries and contours subject to survey This drawing is to be read in conjunction with all relevant schedules, specifications and consultant documentation.

This drawing is copyright and is not to be replaced or used for any purpose without written consent of Modify Pty. Ltd. NOM Architect Jeremy Unger #10738

201 Headland Road, North Curl Curl NSW 2099

CLIENT

Ryan & Natalie Dinsdale

03.11.2025

REASON FOR ISSUE FOR DA SUBMISSION

LEGEND --- DEMOLISH STRUCTURE - BOUNDARY TIMBER SECTION --- EXTENT OF APPROVED DA EXISTING SECTION STEEL/METAL SECTION

GLASS SECTION

CONCRETE SECTION


DRAWING TITLE LOWER GROUND FLOOR PLAN MASONRY SECTION

Monday, 3 November 2025

DRAWN BY:

1:100@A3 CHECKED BY:



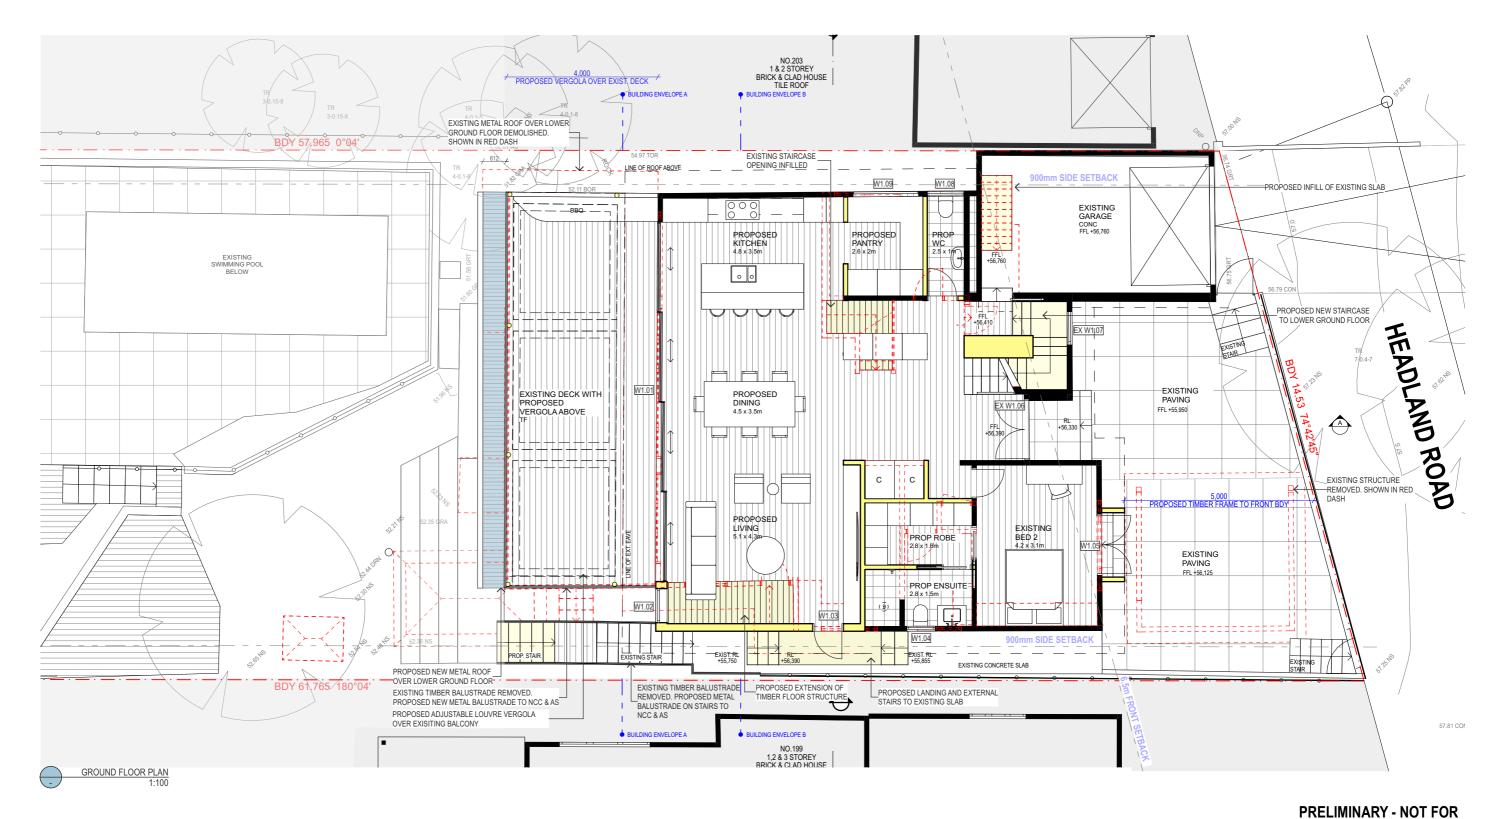

The Builder shall check all dimensions and levels on site prior too construction. Notify any errors, discrepancies or omissions to the architect. Drawings shall not be used for construction purposes until issued for construction. Do not scale drawings. All boundaries and contours subject to survey This drawing is to be read in conjunction with all relevant schedules, specifications and consultant documentation.

This drawing is copyright and is not to be replaced or used for any purpose without written consent of Modify Pty. Ltd. NOM Architect Jeremy Unger #10738

PROJECT 201 Headland Road, North Curl Curl NSW 2099 CLIENT

Ryan & Natalie Dinsdale

03.11.2025

REASON FOR ISSUE FOR DA SUBMISSION


LEGEND MASONRY SECTION --- DEMOLISH STRUCTURE - - BOUNDARY TIMBER SECTION --- EXTENT OF APPROVED DA GLASS SECTION CONCRETE SECTION EXISTING SECTION STEEL/METAL SECTION


DRAWING TITLE GROUND FLOOR PLAN

Monday, 3 November 2025

DRAWN BY: SCALE: 1:100@A3

CHECKED BY:

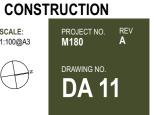

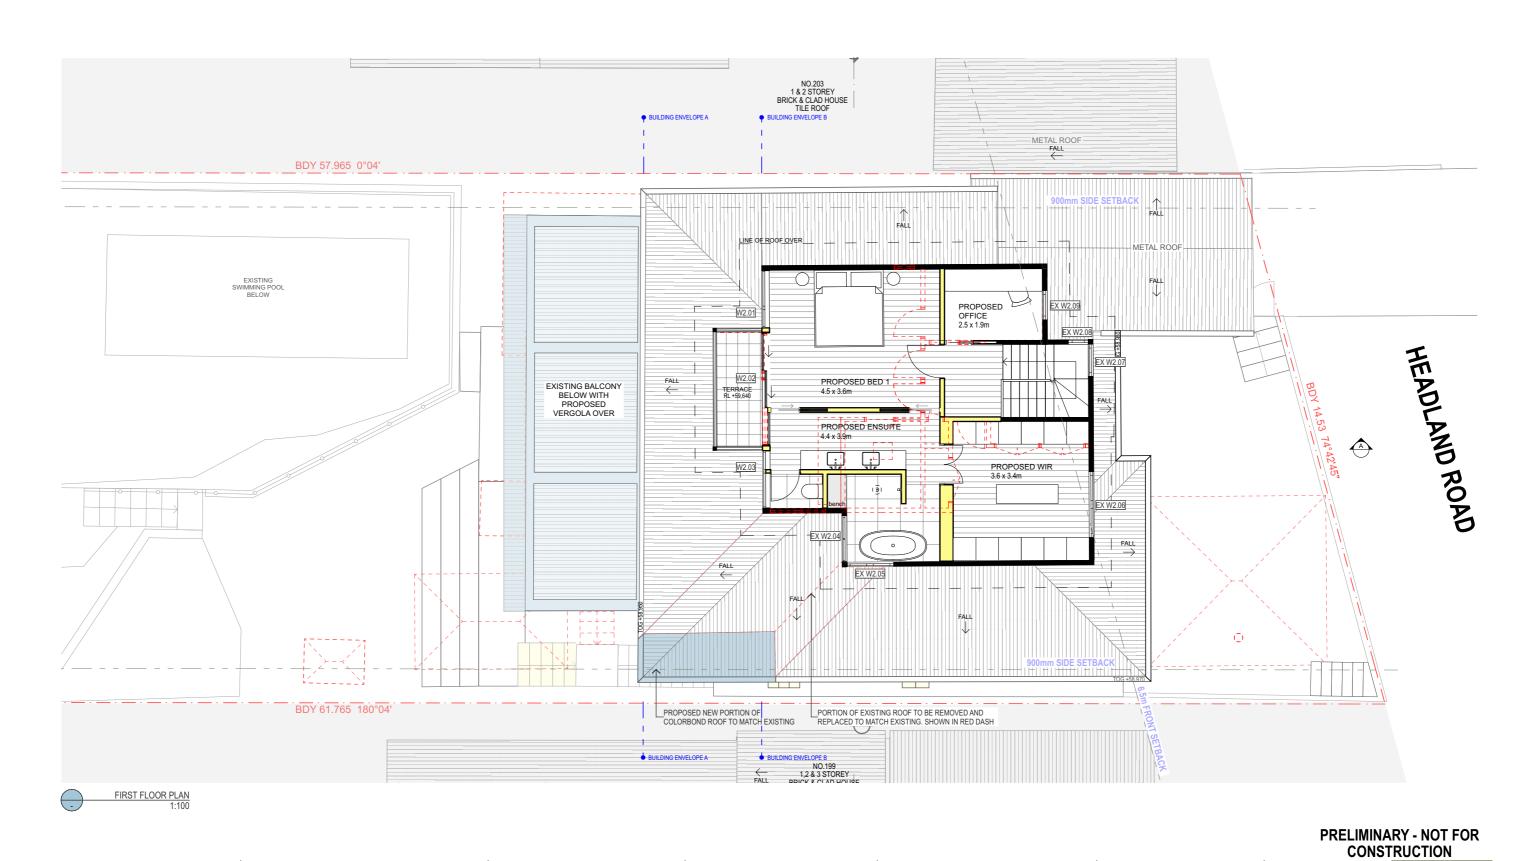



201 Headland Road, North Curl Curl NSW 2099

03.11.2025

REASON FOR ISSUE FOR DA SUBMISSION

LEGEND

MASONRY SECTION TIMBER SECTION

GLASS SECTION

STEEL/METAL SECTION

CONCRETE SECTION

DRAWING TITLE FIRST FLOOR PLAN

1:100@A3

GENERAL NOTES

The Builder shall check all dimensions and levels on site prior too construction. Notify any errors, discrepancies or ornissions to the architect. Drawings shall not be used for construction purposes until issued for construction. Do not scale drawings. All boundaries and contours subject to survey This drawing is to be read in conjunction with all relevant schedules, specifications and consultant documentation.


This drawing is copyright and is not to be replaced or used for any purpose without written consent of Modify Pty. Ltd. NOM Architect Jeremy Unger #10738

CLIENT Ryan & Natalie Dinsdale --- DEMOLISH STRUCTURE - BOUNDARY --- EXTENT OF APPROVED DA EXISTING SECTION

Monday, 3 November 2025

DRAWN BY: HR CHECKED BY: JU

DA 12

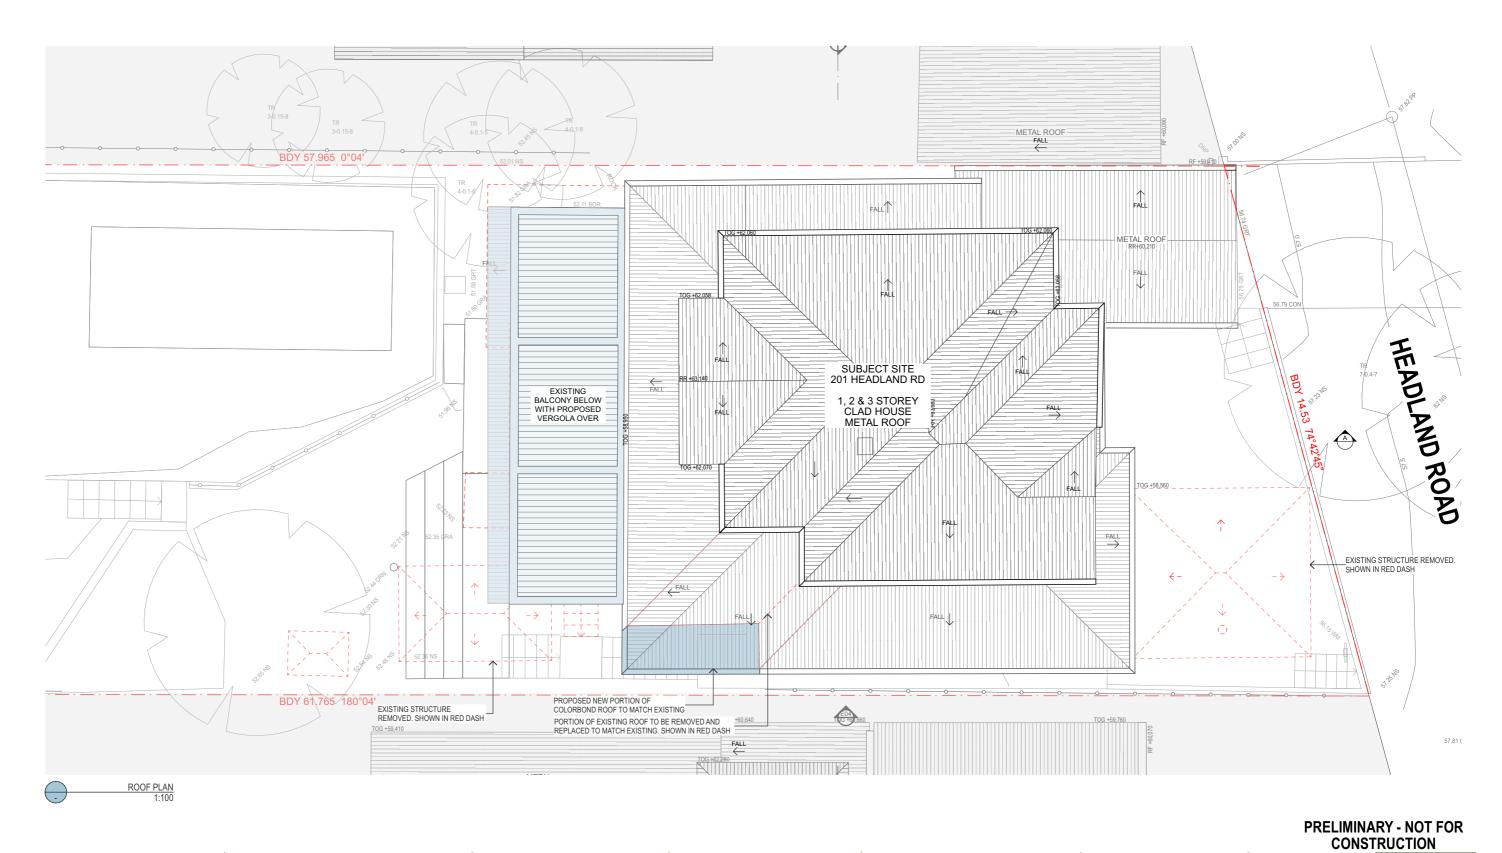



The Builder shall check all dimensions and levels on site prior too construction. Notify any errors, discrepancies or omissions to the architect. Drawings shall not be used for construction purposes until issued for construction. Do not scale drawings. All boundaries and contours subject to survey This drawing is to be read in conjunction with all relevant schedules, specifications and consultant documentation. This drawing is copyright and is not to be replaced or used for any purpose without written consent of Modify Pty. Ltd. NOM Architect Jeremy Unger #10738

PROJECT 201 Headland Road, North Curl Curl NSW 2099

CLIENT

Ryan & Natalie Dinsdale

03.11.2025

REASON FOR ISSUE FOR DA SUBMISSION

LEGEND --- DEMOLISH STRUCTURE - BOUNDARY --- EXTENT OF APPROVED DA EXISTING SECTION STEEL/METAL SECTION

MASONRY SECTION TIMBER SECTION

GLASS SECTION

CONCRETE SECTION

DRAWING TITLE ROOF PLAN

Monday, 3 November 2025

DRAWN BY: HR SCALE:

1:100@A3 CHECKED BY: JU









The Builder shall check all dimensions and levels on site prior too construction.

Notify any errors, discrepancies or omissions to the architect.

Drawings shall not be used for construction purposes until issued for construction.

Do not scale drawings. All boundaries and contours subject to survey

This drawing is to be read in conjunction with all relevant schedules, specifications and consultant documentation.

This drawing is copyright and is not to be replaced or used for any purpose without written consent of Modify Pty. Ltd. NOM Architect Jeremy Unger #10738

201 Headland Road, North Curl Curl NSW 2099 CLIENT

Ryan & Natalie Dinsdale

03.11.2025

REASON FOR ISSUE FOR DA SUBMISSION

LEGEND --- DEMOLISH STRUCTURE MASONRY SECTION - BOUNDARY TIMBER SECTION --- EXTENT OF APPROVED DA GLASS SECTION EXISTING SECTION CONCRETE SECTION STEEL/METAL SECTION


DRAWING TITLE NORTH ELEVATION

Monday, 3 November 2025

PRELIMINARY - NOT FOR CONSTRUCTION

DRAWN BY: HR SCALE: 1:100@A3 CHECKED BY: JU



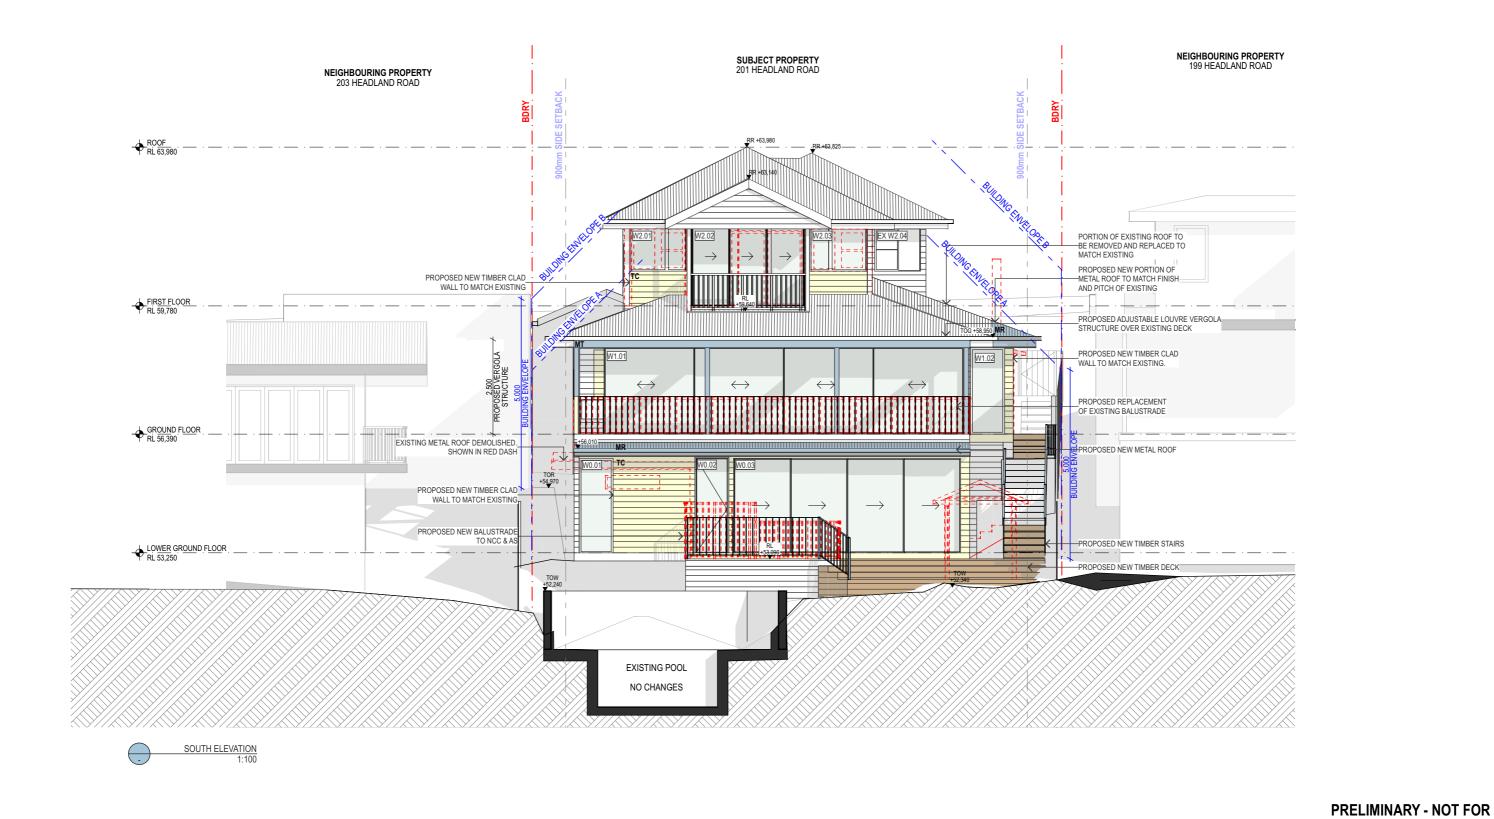



The Builder shall check all dimensions and levels on site prior too construction. Notify any errors, discrepancies or omissions to the architect. Drawings shall not be used for construction purposes until issued for construction. Do not scale drawings. All boundaries and contours subject to survey This drawing is to be read in conjunction with all relevant schedules, specifications and consultant documentation. This drawing is copyright and is not to be replaced or used for any purpose without written consent of Modify Pty. Ltd. NOM Architect Jeremy Unger #10738

201 Headland Road, North Curl Curl NSW 2099 CLIENT

REASON FOR ISSUE FOR DA SUBMISSION

LEGEND - BOUNDARY

MASONRY SECTION

DRAWING TITLE SOUTH ELEVATION

DRAWN BY: CHECKED BY: JU SCALE: 1:100@A3

CONSTRUCTION PROJECT NO. REV A DA 21

PROJECT

Ryan & Natalie Dinsdale


03.11.2025

--- DEMOLISH STRUCTURE --- EXTENT OF APPROVED DA EXISTING SECTION

TIMBER SECTION GLASS SECTION CONCRETE SECTION

Monday, 3 November 2025

STEEL/METAL SECTION

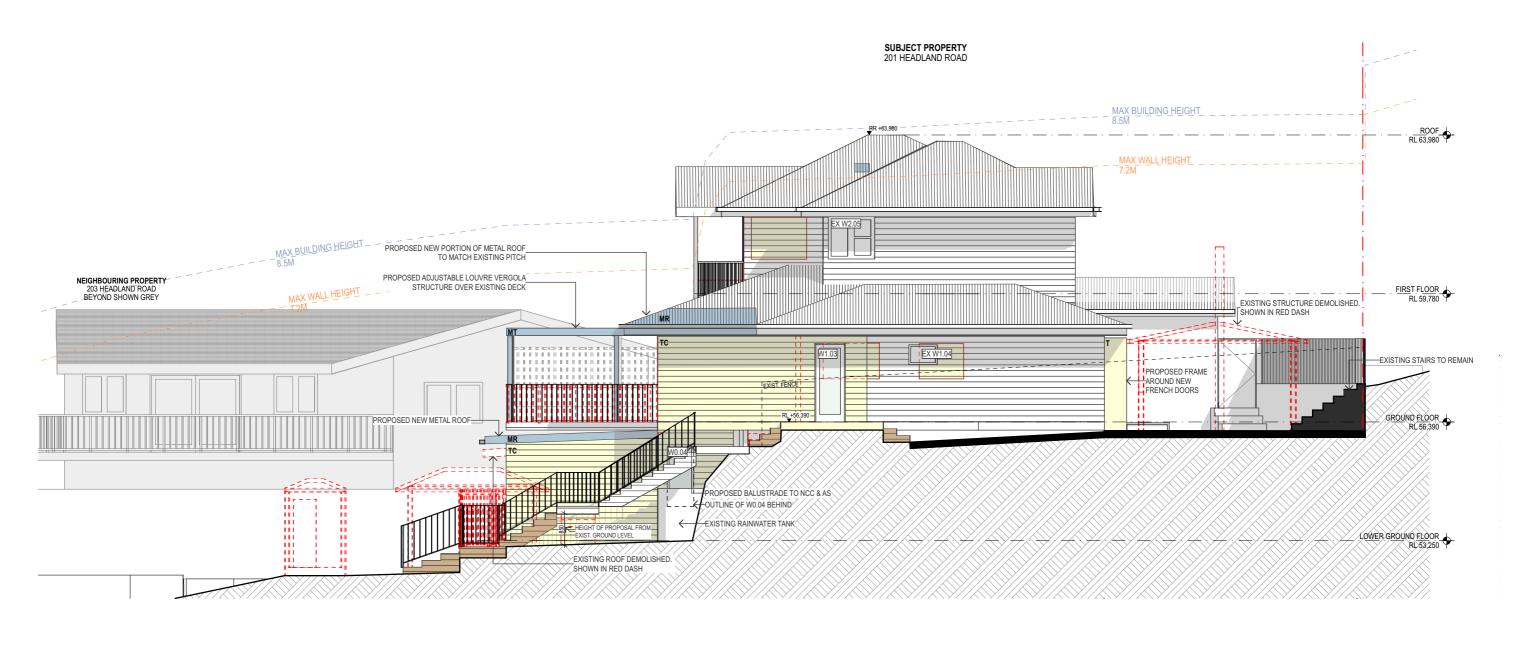



PRELIMINARY - NOT FOR CONSTRUCTION



GENERAL NOTES

The Builder shall check all dimensions and levels on site prior too construction. Notify any errors, discrepancies or omissions to the architect. Drawings shall not be used for construction purposes until issued for construction. Do not scale drawings. All boundaries and contours subject to survey This drawing is to be read in conjunction with all relevant schedules, specifications and consultant documentation. This drawing is copyright and is not to be replaced or used for any purpose without written consent of Modify Pty. Ltd. NOM Architect Jeremy Unger #10738

PROJECT 201 Headland Road, North Curl Curl NSW 2099 CLIENT

Ryan & Natalie Dinsdale

REASON FOR ISSUE FOR DA SUBMISSION

03.11.2025


LEGEND - - BOUNDARY

MASONRY SECTION --- DEMOLISH STRUCTURE TIMBER SECTION --- EXTENT OF APPROVED DA GLASS SECTION CONCRETE SECTION EXISTING SECTION STEEL/METAL SECTION DRAWING TITLE EAST ELEVATION

Monday, 3 November 2025

DRAWN BY: HR CHECKED BY: JU

SCALE: 1:100@A3 PROJECT NO. REV **M180 A** DRAWING NO. **DA 22**

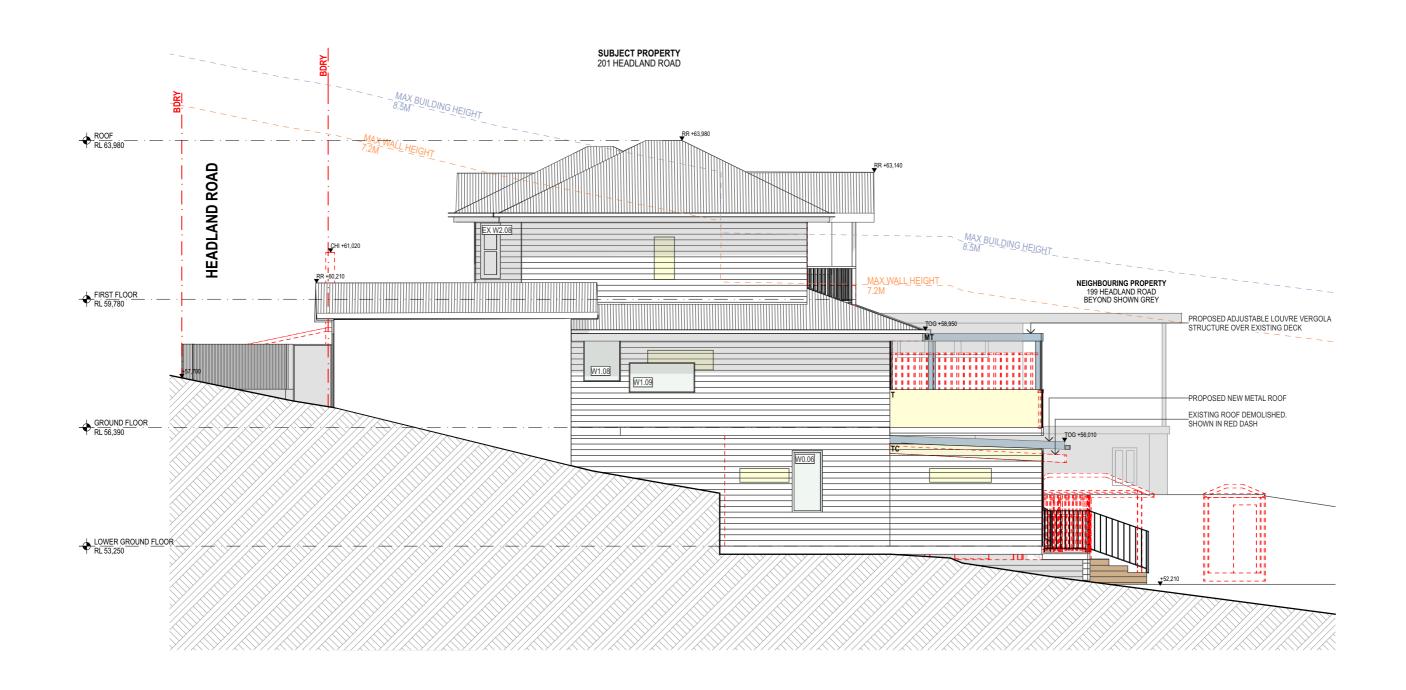



PRELIMINARY - NOT FOR CONSTRUCTION



GENERAL NOTES

The Builder shall check all dimensions and levels on site prior too construction. Notify any errors, discrepancies or omissions to the architect. Drawings shall not be used for construction purposes until issued for construction. Do not scale drawings. All boundaries and contours subject to survey This drawing is to be read in conjunction with all relevant schedules, specifications and consultant documentation. This drawing is copyright and is not to be replaced or used for any purpose without written consent of Modify Pty. Ltd. NOM Architect Jeremy Unger #10738

201 Headland Road, North Curl Curl NSW 2099

CLIENT

Ryan & Natalie Dinsdale

REASON FOR ISSUE


03.11.2025

LEGEND FOR DA SUBMISSION - BOUNDARY

MASONRY SECTION --- DEMOLISH STRUCTURE TIMBER SECTION --- EXTENT OF APPROVED DA GLASS SECTION EXISTING SECTION CONCRETE SECTION STEEL/METAL SECTION DRAWING TITLE WEST ELEVATION Monday, 3 November 2025

DRAWN BY: HR CHECKED BY: JU

PROJECT NO. REV A SCALE: 1:100@A3 DA 23

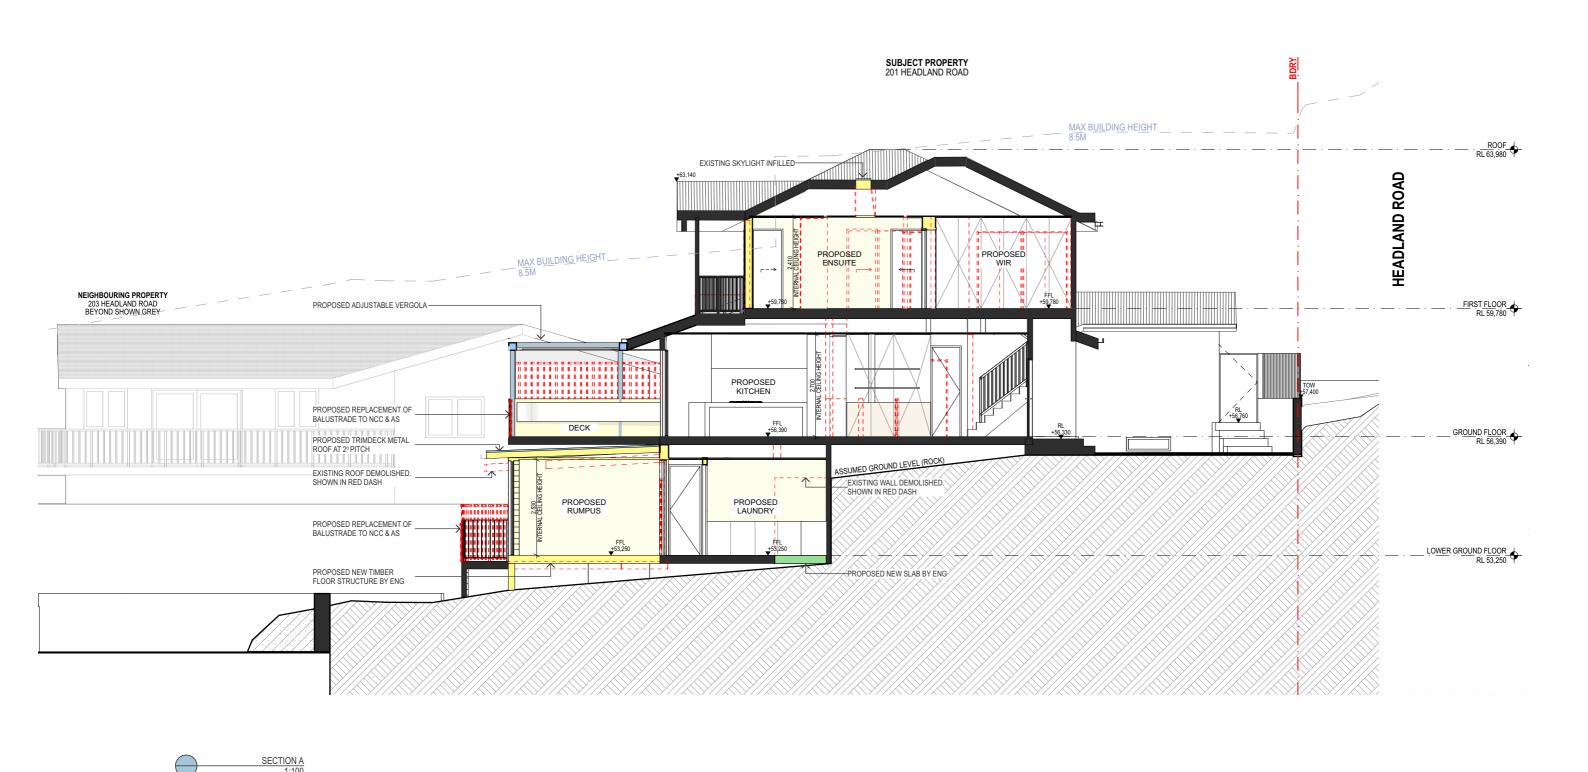



The Builder shall check all dimensions and levels on site prior too construction. Notify any errors, discrepancies or omissions to the architect. Drawings shall not be used for construction purposes until issued for construction. Do not scale drawings. All boundaries and contours subject to survey This drawing is to be read in conjunction with all relevant schedules, specifications and consultant documentation. This drawing is copyright and is not to be replaced or used for any purpose without written consent of Modify Pty. Ltd. NOM Architect Jeremy Unger #10738

PROJECT 201 Headland Road, North Curl Curl NSW 2099

CLIENT

Ryan & Natalie Dinsdale

03.11.2025

REASON FOR ISSUE FOR DA SUBMISSION

LEGEND MASONRY SECTION --- DEMOLISH STRUCTURE - BOUNDARY TIMBER SECTION --- EXTENT OF APPROVED DA GLASS SECTION CONCRETE SECTION EXISTING SECTION STEEL/METAL SECTION


DRAWING TITLE SECTION AA

Monday, 3 November 2025

DRAWN BY: CHECKED BY: JU

PROJECT NO. REV **M180 A** SCALE: 1:100@A3 DRAWING NO. **DA 30**

PRELIMINARY - NOT FOR CONSTRUCTION

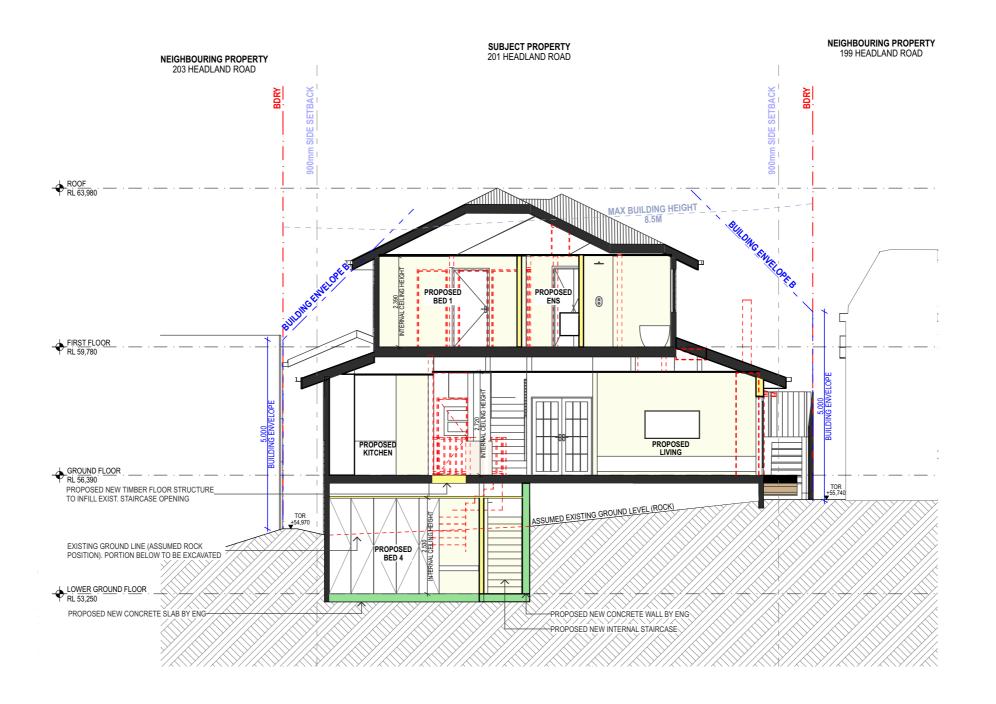





The Builder shall check all dimensions and levels on site prior too construction.

Notify any errors, discrepancies or omissions to the architect.

Drawings shall not be used for construction purposes until issued for construction.

Do not scale drawings. All boundaries and contours subject to survey

This drawing is to be read in conjunction with all relevant schedules, specifications and consultant documentation.

This drawing is copyright and is not to be replaced or used for any purpose without written consent of Modify Pty. Ltd. NOM Architect Jeremy Unger #10738

PROJECT 201 Headland Road, North Curl Curl NSW 2099 CLIENT

Ryan & Natalie Dinsdale

03.11.2025

REASON FOR ISSUE FOR DA SUBMISSION

LEGEND MASONRY SECTION --- DEMOLISH STRUCTURE - BOUNDARY TIMBER SECTION --- EXTENT OF APPROVED DA GLASS SECTION EXISTING SECTION CONCRETE SECTION STEEL/METAL SECTION


DRAWING TITLE SECTION BB


Monday, 3 November 2025

PRELIMINARY - NOT FOR CONSTRUCTION

DRAWN BY: HR SCALE: 1:100@A3 CHECKED BY: JU



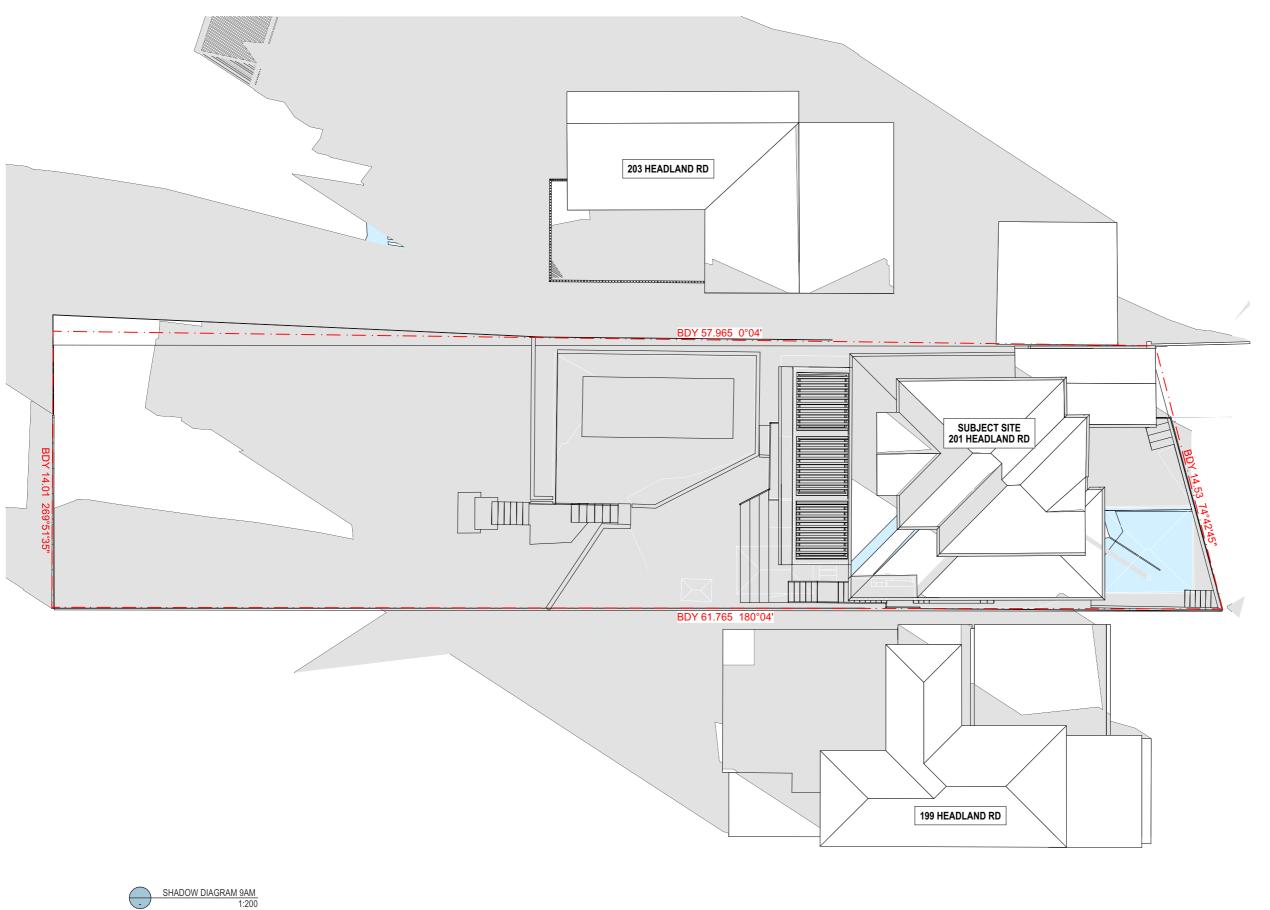

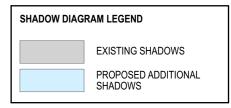

PRELIMINARY - NOT FOR **CONSTRUCTION**

DRAWN BY: HR CHECKED BY: JU

SCALE: 1:200@A3

PROJECT NO. REV **M180** A DA 40

ABN 29 149 534 449 Address: 39 Gurner Street Paddington NSW 2021 info@modify.com.au | www.modify.com.au

GENERAL NOTES

The Builder shall check all dimensions and levels on site prior too construction.
Notify any errors, discrepancies or omissions to the architect.
Drawings shall not be used for construction purposes until issued for construction.
Do not scale drawings. All boundaries and contours subject to survey.
This drawing is to be read in conjunction with all relevant schedules, specifications and consultant documentation.
This drawing is copyright and is not to be replaced or used for any purpose without written consent of Modify Pty. Ltd. NOM Architect Jeremy Unger #10738

PROJECT 201 Headland Road, North Curl Curl NSW 2099


CLIENT Ryan & Natalie Dinsdale


REASON FOR ISSUE FOR DA SUBMISSION 03.11.2025

LEGEND --- DEMOLISH STRUCTURE ---- BOUNDARY TIMBER SECTION --- EXTENT OF APPROVED DA GLASS SECTION CONCRETE SECTION EXISTING SECTION STEEL/METAL SECTION

DRAWING TITLE SHADOW DIAGRAM - 9AM 21 JUNE MASONRY SECTION

Monday, 3 November 2025

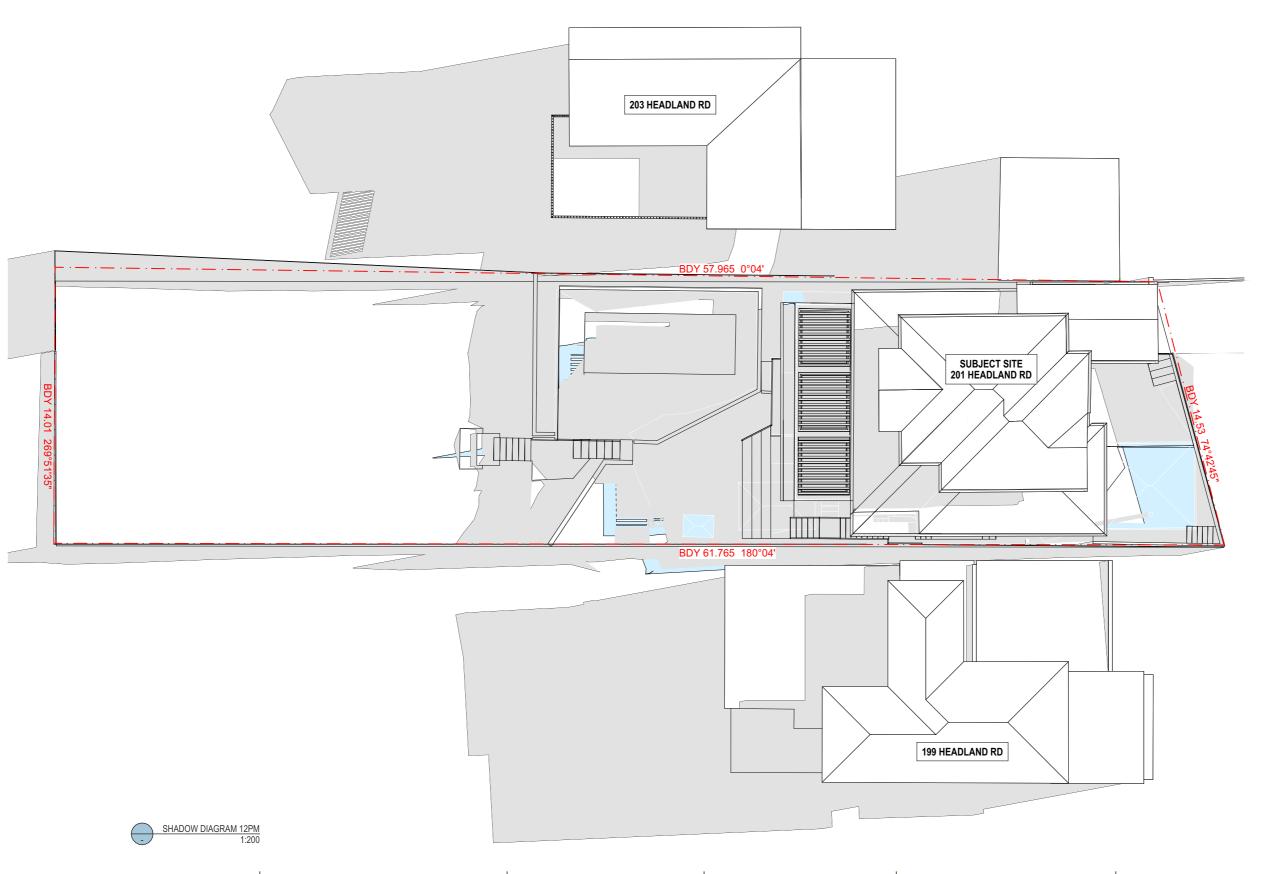

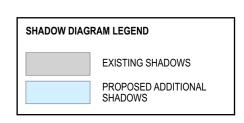

PRELIMINARY - NOT FOR CONSTRUCTION

DRAWN BY: HR CHECKED BY: JU

SCALE:

1:200@A3

PROJECT NO. REV **M180 A** DA 41

GENERAL NOTES

CLIENT Ryan & Natalie Dinsdale

201 Headland Road, North Curl Curl NSW 2099

PROJECT

03.11.2025


REASON FOR ISSUE FOR DA SUBMISSION

LEGEND --- DEMOLISH STRUCTURE ---- BOUNDARY --- EXTENT OF APPROVED DA EXISTING SECTION

MASONRY SECTION TIMBER SECTION GLASS SECTION CONCRETE SECTION STEEL/METAL SECTION DRAWING TITLE SHADOW DIAGRAM - 12PM 21 JUNE Monday, 3 November 2025

The Builder shall check all dimensions and levels on site prior too construction.
Notify any errors, discrepancies or omissions to the architect.
Drawings shall not be used for construction purposes until issued for construction.
Do not scale drawings. All boundaries and contours subject to survey.
This drawing is to be read in conjunction with all relevant schedules, specifications and consultant documentation.
This drawing is copyright and is not to be replaced or used for any purpose without written consent of Modify Pty. Ltd. NOM Architect Jeremy Unger #10738

ABN 29 149 534 449 Address: 39 Gurner Street Paddington NSW 2021 info@modify.com.au | www.modify.com.au

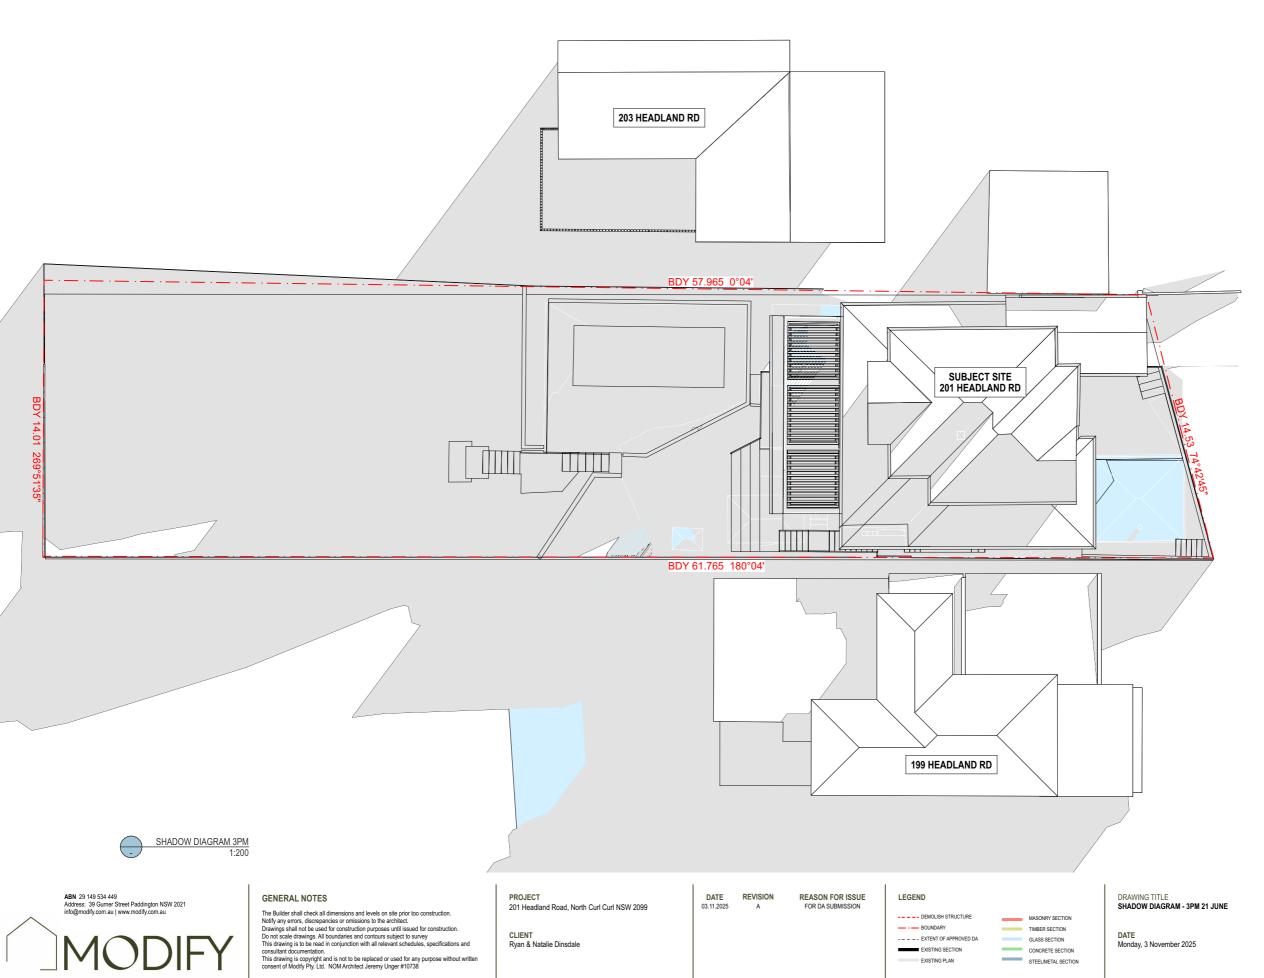

Ryan & Natalie Dinsdale

SHADOW DIAGRAM LEGEND EXISTING SHADOWS PROPOSED ADDITIONAL SHADOWS

PRELIMINARY - NOT FOR CONSTRUCTION

DRAWN BY: HR CHECKED BY: JU


Monday, 3 November 2025

CONCRETE SECTION

STEEL/METAL SECTION

EXISTING SECTION

SCALE: 1:200@A3

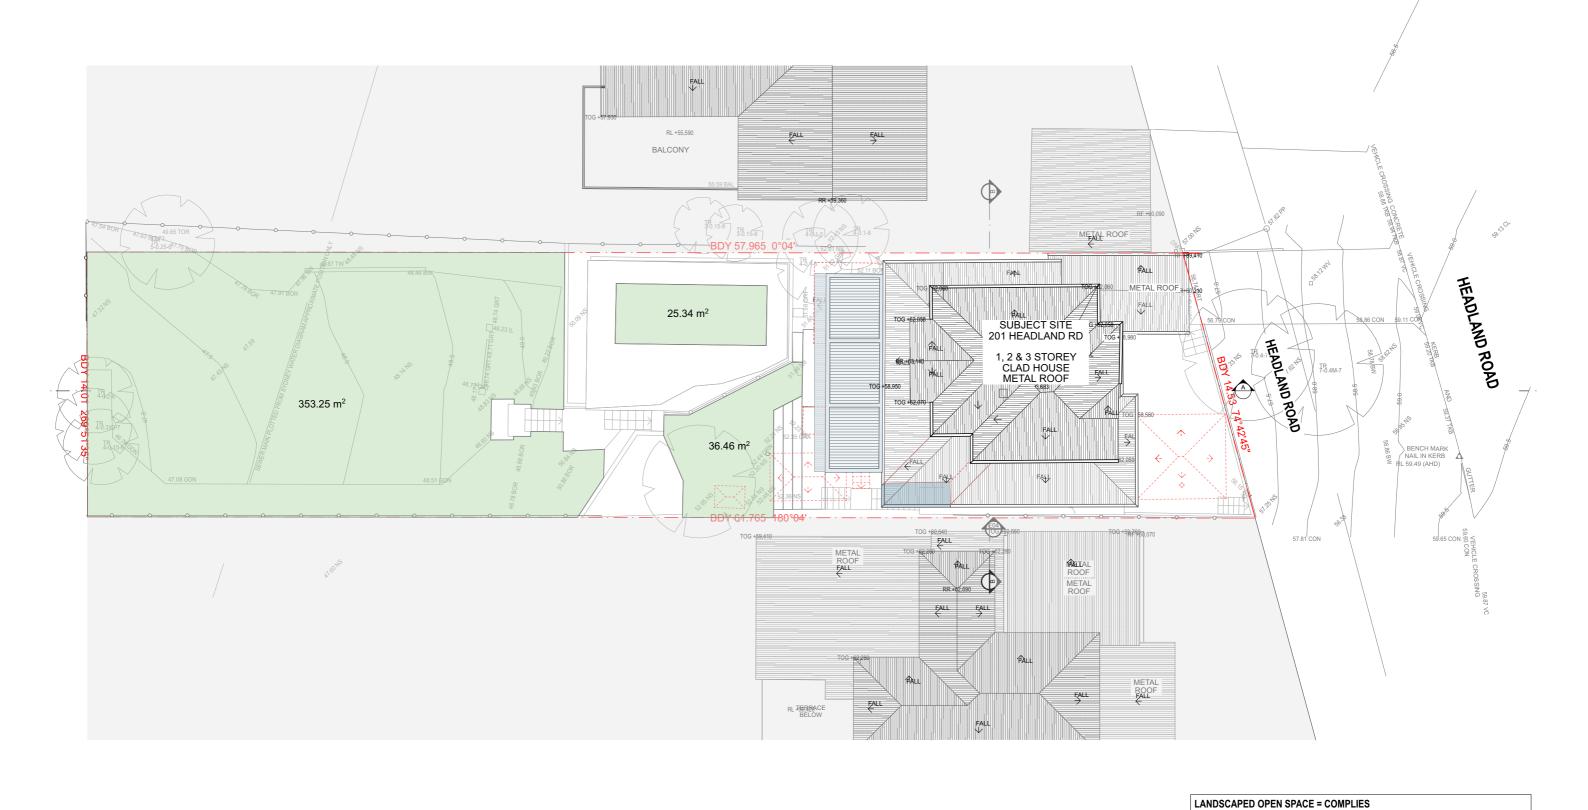





The Builder shall check all dimensions and levels on site prior too construction. Notify any errors, discrepancies or omissions to the architect. Drawings shall not be used for construction purposes until issued for construction. Do not scale drawings. All boundaries and contours subject to survey This drawing is to be read in conjunction with all relevant schedules, specifications and consultant documentation.

This drawing is copyright and is not to be replaced or used for any purpose without written consent of Modify Pty. Ltd. NOM Architect Jeremy Unger #10738

PROJECT 201 Headland Road, North Curl Curl NSW 2099

CLIENT

Ryan & Natalie Dinsdale

03.11.2025

REASON FOR ISSUE FOR DA SUBMISSION

LEGEND --- DEMOLISH STRUCTURE - - BOUNDARY --- EXTENT OF APPROVED DA EXISTING SECTION

MASONRY SECTION TIMBER SECTION GLASS SECTION CONCRETE SECTION STEEL/METAL SECTION DRAWING TITLE LANDSCAPE CALCULATIONS

Monday, 3 November 2025


PRELIMINARY - NOT FOR CONSTRUCTION DRAWN BY: SCALE:

1:200@A3 CHECKED BY: JU

MINIMUM LANDSCAPED AREA REQUIREMENT = 40% OF SITE AREA: 335.48m²

PROPOSED LANDSCAPED AREA = 49% OF SITE AREA = 415.05m²



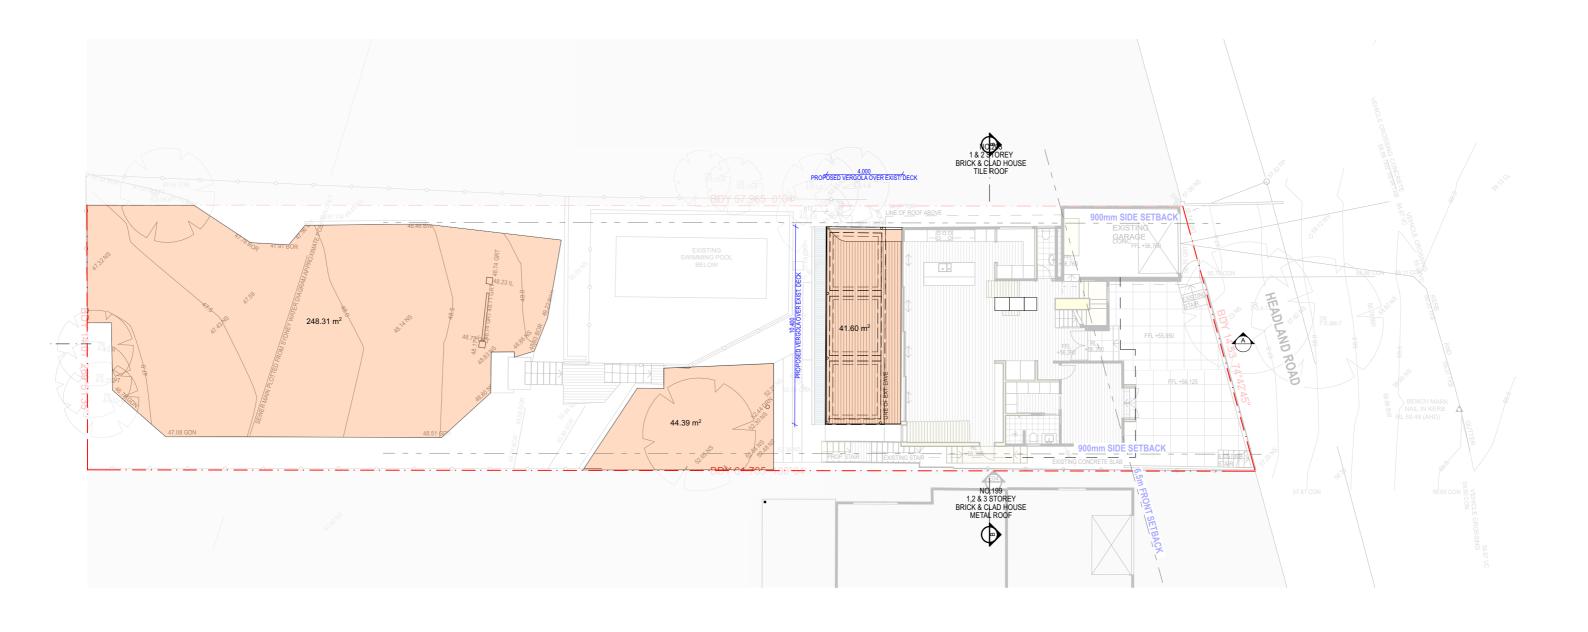





The Builder shall check all dimensions and levels on site prior too construction. Notify any errors, discrepancies or omissions to the architect. Drawings shall not be used for construction purposes until issued for construction. Do not scale drawings. All boundaries and contours subject to survey This drawing is to be read in conjunction with all relevant schedules, specifications and consultant documentation.

This drawing is copyright and is not to be replaced or used for any purpose without written consent of Modify Pty. Ltd. NOM Architect Jeremy Unger #10738

PROJECT 201 Headland Road, North Curl Curl NSW 2099

CLIENT

Ryan & Natalie Dinsdale

03.11.2025

REASON FOR ISSUE FOR DA SUBMISSION

LEGEND MASONRY SECTION --- DEMOLISH STRUCTURE - - BOUNDARY TIMBER SECTION --- EXTENT OF APPROVED DA GLASS SECTION CONCRETE SECTION EXISTING SECTION STEEL/METAL SECTION

PRIVATE OPEN SPACE = COMPLIES

MINIMUM PRIVATE OPEN SPACE REQUIREMENT = 60m² PROPOSED PRIVATE OPEN SPACE AREA = 348.75m²

PRIVATE OPEN SPACES

GROUND FLOOR DECK = 41.6m² LOWER GROUND DECK = 44.39m² REAR BACKYARD = 248.31m²

PRELIMINARY - NOT FOR CONSTRUCTION

SCALE: 1:200@A3




DRAWN BY: HR

CHECKED BY: JU



Monday, 3 November 2025

DRAWING TITLE
POS CALCULATIONS

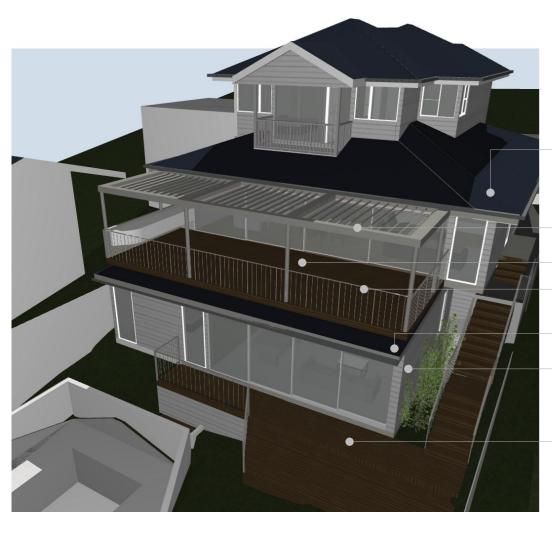

-COLORBOND ROOF IN "DEEP OCEAN" OR SIMILIAR (to match existing)

-VERGOLA. DULUX DURALLOY "SURFMIST" or "LEXICON or SIMILIAR

TIMBER DECKING

METAL BALUSTRADE. POWDER COATED FINISH DULUX DURALLOY "SURFMIST" or "LEXICON or SIMILIAR

-COLORBOND ROOF IN "DEEP OCEAN" OR SIMILIAR (to match existing)

TIMBER CLADDING ROOF. COLOUR "DEEP OCEAN" OR SIMILIAR

TIMBER DECKING

Generic Perspective

EXTERNAL FINISHES SCHEDULE




TIMBER FRAMED WINDOWS Match existing. Finished in light, warm, earthy colours such as Dulux "Portland Stone" or "Regency White" or similar.



TD - TIMBER **DECKING**



ALUMINIUM ADJUSTABLE LOUVRE PERGOLA STRUCTURE Light, warm, earthy tones, e.g. Dulux Duralloy "Lexicon" or "Surfmist" or similiar

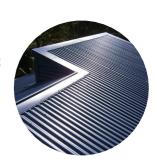

MR - METAL ROOF CUSTOM ORB

Colour to match existing. "Deep Ocean" or similiar



METAL BALUSTRADE Powder Coated finish in light, warm, earthy tones. e.g. Dulux Duralloy "Lexicon" or "Surfmist" or



CL - PAINTED TIMBER WEATHERBOARD HORIZONTAL. Light, warm, earthy, tones, e.g. Dulux "Portland Stone" or "Regency White" or

ABN 29 149 534 449 Address: 39 Gurner Street Paddington NSW 2021 info@modify.com.au | www.modify.com.au

GENERAL NOTES

The Builder shall check all dimensions and levels on site prior too construction.

Notify any errors, discrepancies or omissions to the architect.

Drawings shall not be used for construction purposes until issued for construction.

Do not scale drawings. All boundaries and contours subject to survey.

This drawing is to be read in conjunction with all relevant schedules, specifications and consultant documentation.

This drawing is copyright and is not to be replaced or used for any purpose without written consent of Modify Pty. Ltd. NOM Architect Jeremy Unger #10738

201 Headland Road, North Curl Curl NSW 2099

CLIENT Ryan & Natalie Dinsdale 03.11.2025

REASON FOR ISSUE FOR DA SUBMISSION

LEGEND

--- DEMOLISH STRUCTURE - BOUNDARY --- EXTENT OF APPROVED DA

EXISTING SECTION

MASONRY SECTION TIMBER SECTION GLASS SECTION CONCRETE SECTION STEEL/METAL SECTION

DRAWING TITLE EXTERNAL FINISHES SCHEDULE

Monday, 3 November 2025

PRELIMINARY - NOT FOR CONSTRUCTION

DRAWN BY: SCALE:

CHECKED BY:

1:100@A3

PROJECT NO. REV A DRAWING NO. **DA 60**