DRAWING No.

DA1000

DA1001

DA1002

DA1003

DA1004

DA1005 DA1006

DA1007

DA1008

DA1009

DA1010

DA1011

DA1012

DA1013

DA1014

DA1015

DA1016

DA1017

DA2000

DA2001

DA2002

DA2003

DA3000

DA3001

DA3002

DA3003

DA4000

DA4001

DA4002

DA5000

DA5001

DA5002

DA5003

DA5004

DA5005

DA5006

DESCRIPTION

Cover Sheet

SITE SURVEY

SITE PLAN

A4 NOTIFICATION PLAN

Demolition Ground Floor Plan

Landscape Open Space Plan Proposed

Excavation & Fill Plan

Sediment & Erosion Plan

Waste Management Plan

Floor Space Ratio Calculation

**Existing Ground Floor Plan** 

Demolition First Floor Plan

Existing First Floor Plan

LOWER GROUND FLOOR

GROUND FLOOR

FIRST FLOOR

SECTION 1

SECTION 2

SECTION DRIVE

SECTION POOL

**ELEVATIONS 1** 

**ELEVATIONS 2** 

**PERSPECTIVE** 

**ELEVATION FRONT FENCE** 

SHADOW PLAN 21st June 9am

SHADOW PLAN 21st June 12pm

SHADOW PLAN 21st June 3pm

WALL ELEVATION SHADOWS

MATERIAL & COLOUR SAMPLE BOARD

ROOF

Existing Lower Ground Floor Plan

Landscape Open Space Plan Existing

Demolition Lower Ground Floor Plan

Landscape Plan

Stormwater Plan

Rapid Plans www.rapidplans.com.au P.O. Box 6193 Frenchs Forest DC NSW 2086 Fax: (02) 9905-8865 Mobile: 0414-945-024 Email: gregg@rapidplans.com.au

**ISSUED DATE** 

05-02-2024

05-02-2024

05-02-2024

05-02-2024 05-02-2024

05-02-2024

05-02-2024

05-02-2024

05-02-2024 05-02-2024

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05-02-2024

05-02-2024

05-02-2024

**NCC Requirements** 



# New DwellingTo Existing Residence For David Dowell

# 40 Riverview Parade North Manly





Lot 75 D.P.12578 Project Number: RP0122DOW Urban Auto Enginee Nationwide House Energy Rating Scheme® NatHERS® Certificate No. #HR-H3IGEL-03 star rating THAT Y 7.0 75/-/DP12578 NATIONWIDE HOUSE 29.7 MJ/m<sup>2</sup>

Thermal performance (MJ/m)

Whole of Home

performance rating

No Whole of Home

performance rating

generated for this

Page 1 of 14

**BASIX** Certificate

#### Single Dwelling

Certificate number: 1737451S

This certificate confirms that the proposed development will meet the NSW government's requirements for sustainability, if it is built in accordance with the commitments set out below. Terms used in this certificate, or in the commit have the meaning given by the document entitled "BASIX Definitions" dated 10/09/2020 published by the Department. This document is available at www.basix.nsw.gov.au


Date of issue: Monday, 26 February 2024

To be valid, this certificate must be lodged within 3 months of the date of issue.



Project summary			
Project name	Dow	ell	
Street address	40 F	RIVERVIEW Parade I	NORTH MANLY 2100
Local Government Area	Nort	hern Beaches Counc	il
Plan type and plan number	Dep	osited Plan DP12578	
Lot no.	75		
Section no.	-		
Project type	dwel	ling house (detached	)
No. of bedrooms	5		
Project score			
Water	~	40	Target 40
Thermal Performance	~	Pass	Target Pass
Energy	~	93	Target 72
Materials	~	-100	Target n/a

Certificate Pre	ared by		
Name / Company Na	ne: RAPID PLANS PTY	LTD	
ABN (if applicable): 4	150064592		

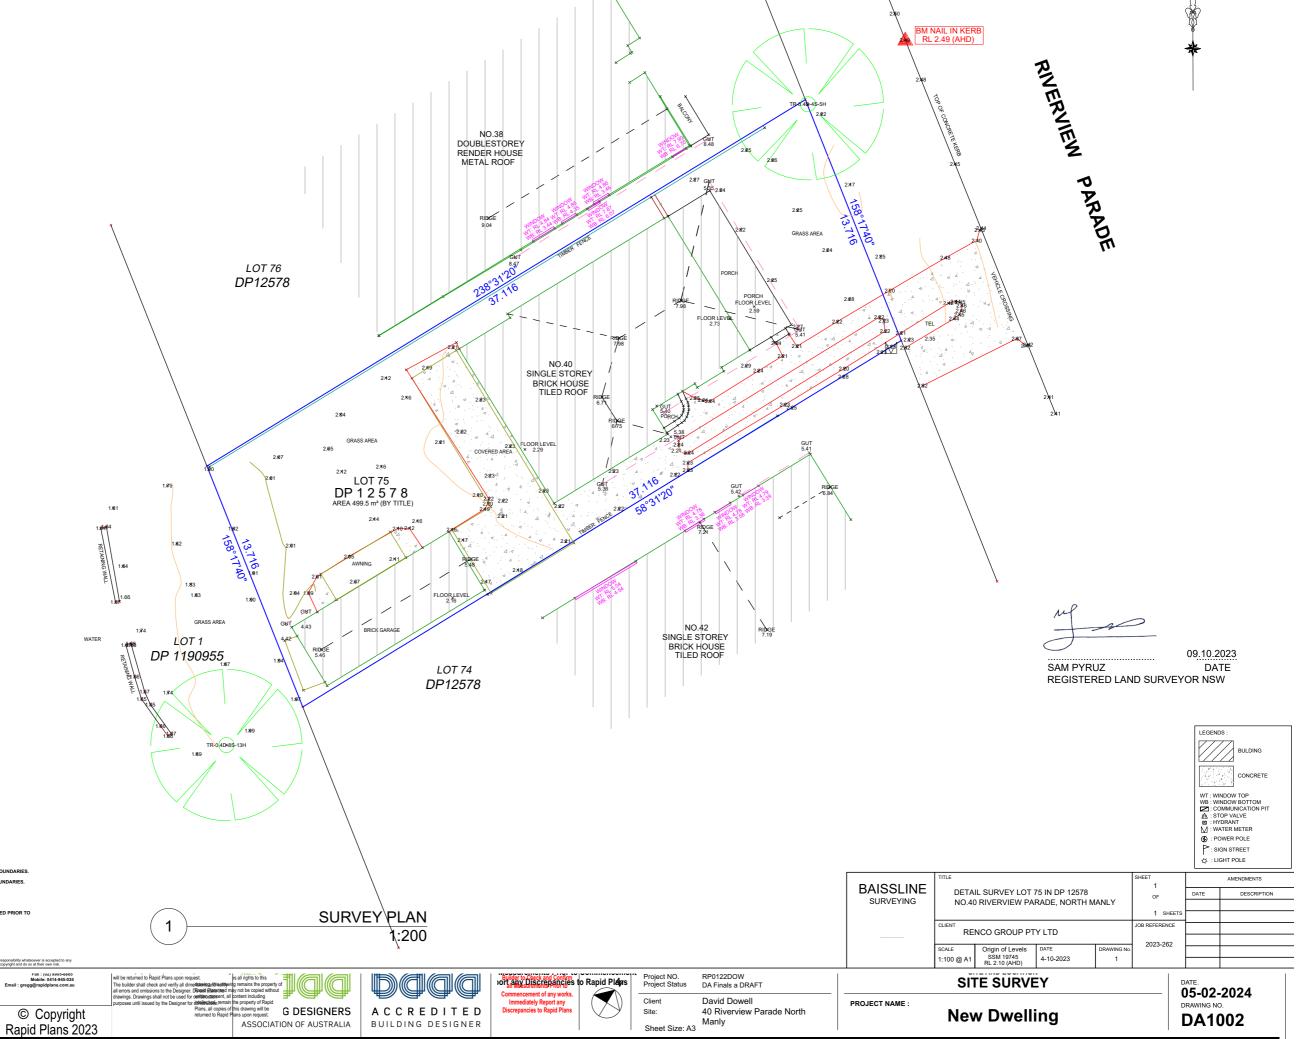



No Investigation of Underground services has been made. All relevant Authorities should be notified prior to any excavation on or near the site.

Developers & Excavators may be held financially responsible by the asset owner should they damage underground networks.



rax : (uz) 9905-0005 Mobile: 0414-945-024 egg@rapidplans.com.au







**New Dwelling** 

#### Schedule of BASIX commitments

e swimming pool must not have a volume greater than 32 kilolitres

The commitments set out below regulate how the proposed development is to be carried out. It is a condition of any development consent granted, or complying development certificate issued, for the proposed development, that BASIX commitments be complied with.

Water Commitments	Show on DA plans	Show on CC/CDC plans & specs	Certifier check
Landscape			
The applicant must plant indigenous or low water use species of vegetation throughout 100 square metres of the site.	~	~	
Fixtures			
The applicant must install showerheads with a minimum rating of 4 star (> 4.5 but <= 6 L/min plus spray force and/or coverage tests) in all showers in the development.		~	~
The applicant must install a tollet flushing system with a minimum rating of 5 star in each tollet in the development.		~	~
The applicant must install taps with a minimum rating of 5 star in the kitchen in the development.		~	
The applicant must install basin taps with a minimum rating of 5 star in each bathroom in the development.		~	
Alternative water			
Rainwater tank			
The applicant must install a rainwater tank of at least 4000 litres on the site. This rainwater tank must meet, and be installed in accordance with, the requirements of all applicable regulatory authorities.	~	~	~
The applicant must configure the rainwater tank to collect rain runoff from at least 170 square metres of the roof area of the development (excluding the area of the roof which drains to any stormwater tank or private dam).		~	~
The applicant must connect the rainwater tank to:			
<ul> <li>at least one outdoor tap in the development (Note: NSW Health does not recommend that rainwater be used for human consumption in areas with potable water supply.)</li> </ul>		-	-
a tap that is located within 10 metres of the swimming pool in the development		~	-
Water Commitments	Show on DA plans	Show on CC/CDC plans & specs	Certifie check

SITE PLAN

1:200

Thermal Performance and Materials commitments	Show on DA plans	Show on CC/CDC plans & specs	Certifier check
Simulation Method			
Assessor details and thermal loads			
The applicant must attach the certificate referred to under "Assessor Details" on the front page of this BASIX certificate (the "Assessor Certificate") to the development application and construction certificate application for the proposed development (or, if the applicant is applying for a complying development certificate for the proposed development, to that application). The applicant must also attach the Assessor Certificate to the application for an occupation certificate for the proposed development.			
The Assessor Certificate must have been issued by an Accredited Assessor in accordance with the Thermal Comfort Protocol.			
The details of the proposed development on the Assessor Certificate must be consistent with the details shown in this BASIX certificate, including the Cooling and Heating loads shown on the front page of this certificate and the "Construction" and "Glazing" tables below.			
The applicant must show on the plans accompanying the development application for the proposed development, all matters which the Assessor Certificate requires to be shown on those plans. Those plans must bear a stamp of endorsement from the Accredited Assessor to certify that this is the case. The applicant must show on the plans accompanying the application for a construction certificate (or complying development certificate, if applicable), all thermal performance specifications set out in the Assessor Certificate, and all aspects of the proposed development which were used to calculate those specifications.	~	~	~
The applicant must construct the development in accordance with all thermal performance specifications set out in the Assessor Certificate, and in accordance with those aspects of the development application or application for a complying development certificate which were used to calculate those specifications.		~	~
The applicant must show on the plans accompanying the development application for the proposed development, the locations of ceiling fans set out in the Assessor Certificate. The applicant must show on the plans accompanying the application for a construction certificate (or complying development certificate, if applicable), the locations of ceiling fans set out in the Assessor Certificate.	~	~	~


Sun Orbit

#### Wall Legend

Denotes New Timber Framed Wall Denotes New Masonry Wall

Denotes New Concrete Block Wall **Denotes New Concrete** 

Denotes Existing Wall Denotes Demolished Item

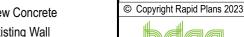



Rapid Plan
Building Design and Architectural Drafting



Site Information	Prop.	Comp
Site Area	499.5m2	Yes
Housing Density (dwelling/m2)	1	Yes
Max Ceiling Ht Above Nat. GL	7.2m	Yes
Max Bldg Ht Above Nat. GL	8.5m	Yes
Front Setback (Min.)	6.5m	Yes
Rear Setback (Min.)	6.0m	Yes
Min. side bdy setback (Min.)	0.9m	Yes
Building envelope	4m@45 Deg	Yes
% of landscape open space (40% min)	40%	Yes
Impervious area (m2)	%	Yes
Maximum cut into gnd (m)	2.1m	Yes
Maximum denth of fill (m)	NΔ	Vac

**Builder to Check and Confirm all** Measurements Prior to Commencement of any works. nmediately Report any Discrepancion



Drawn | Checked GBJ Plot Date: 27/2/24 Project NO. RP0122DOW Project Status DA Finals a D

lo. of car spaces provided 2

nt David Dowell


SITE AND LOCATION


**New Dwelling** 


05-02-2024 DA1003

29.7 MJ/m DA APPLICATION **ONLY** NOT FOR CONSTRUCTION

7.0 HOUSE

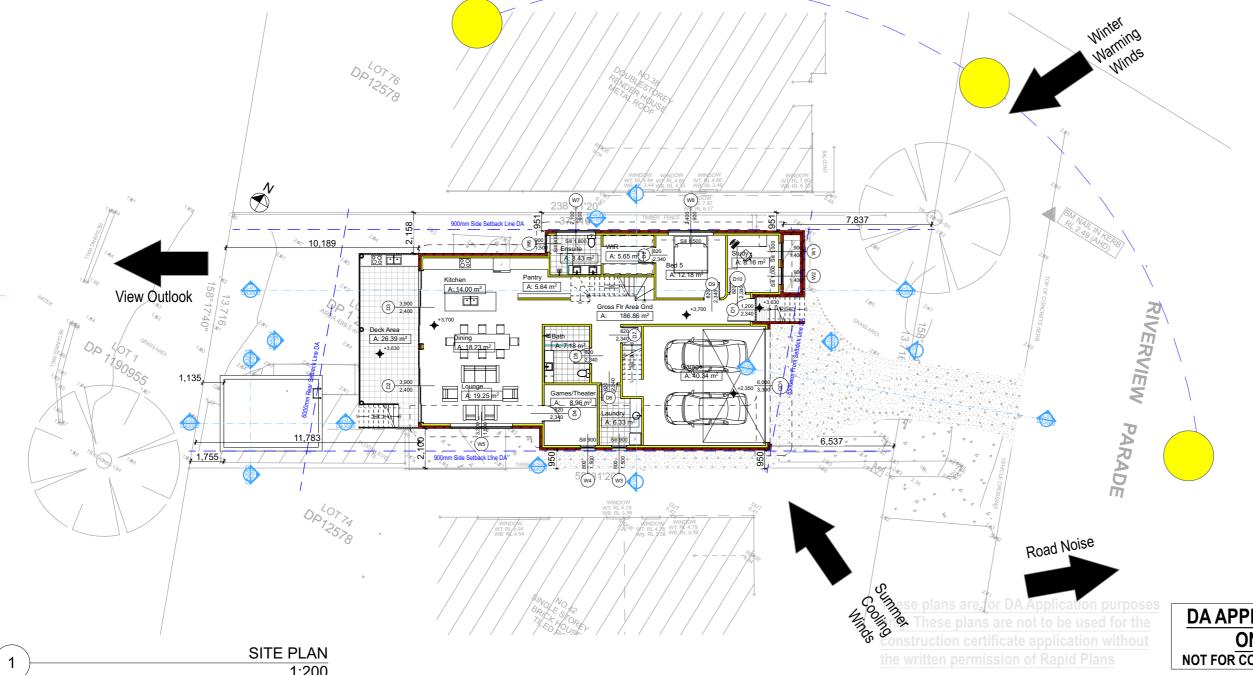

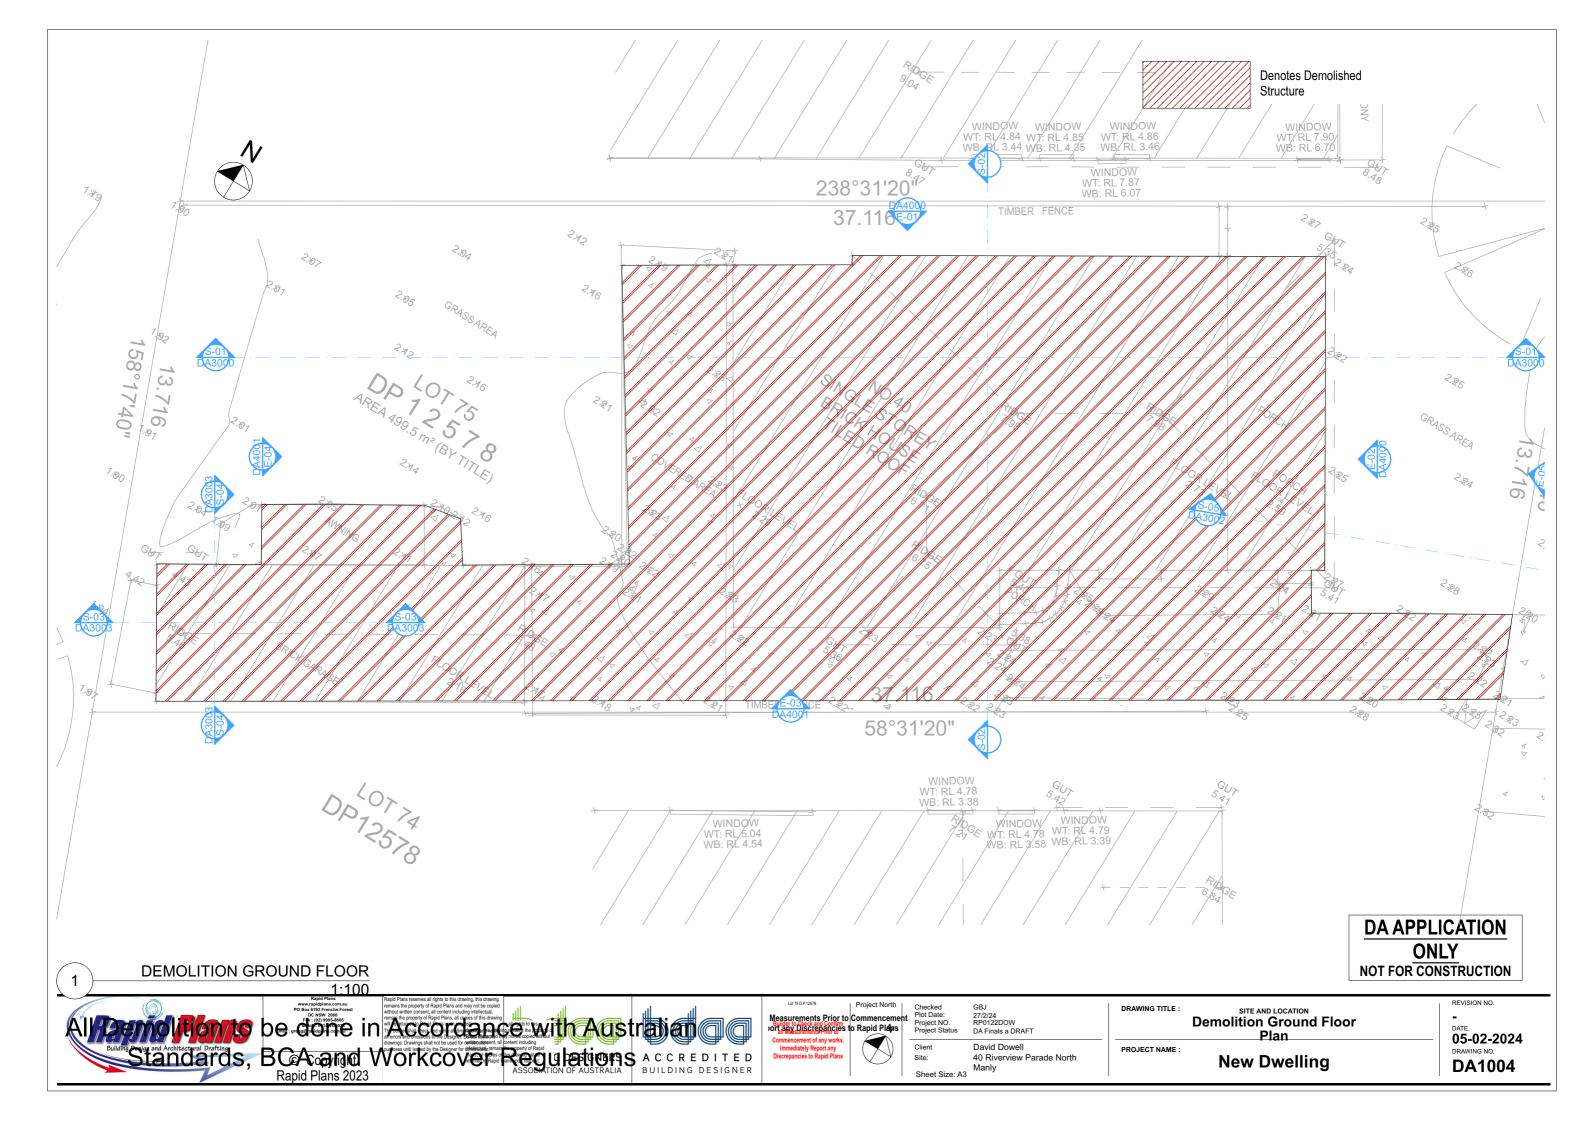

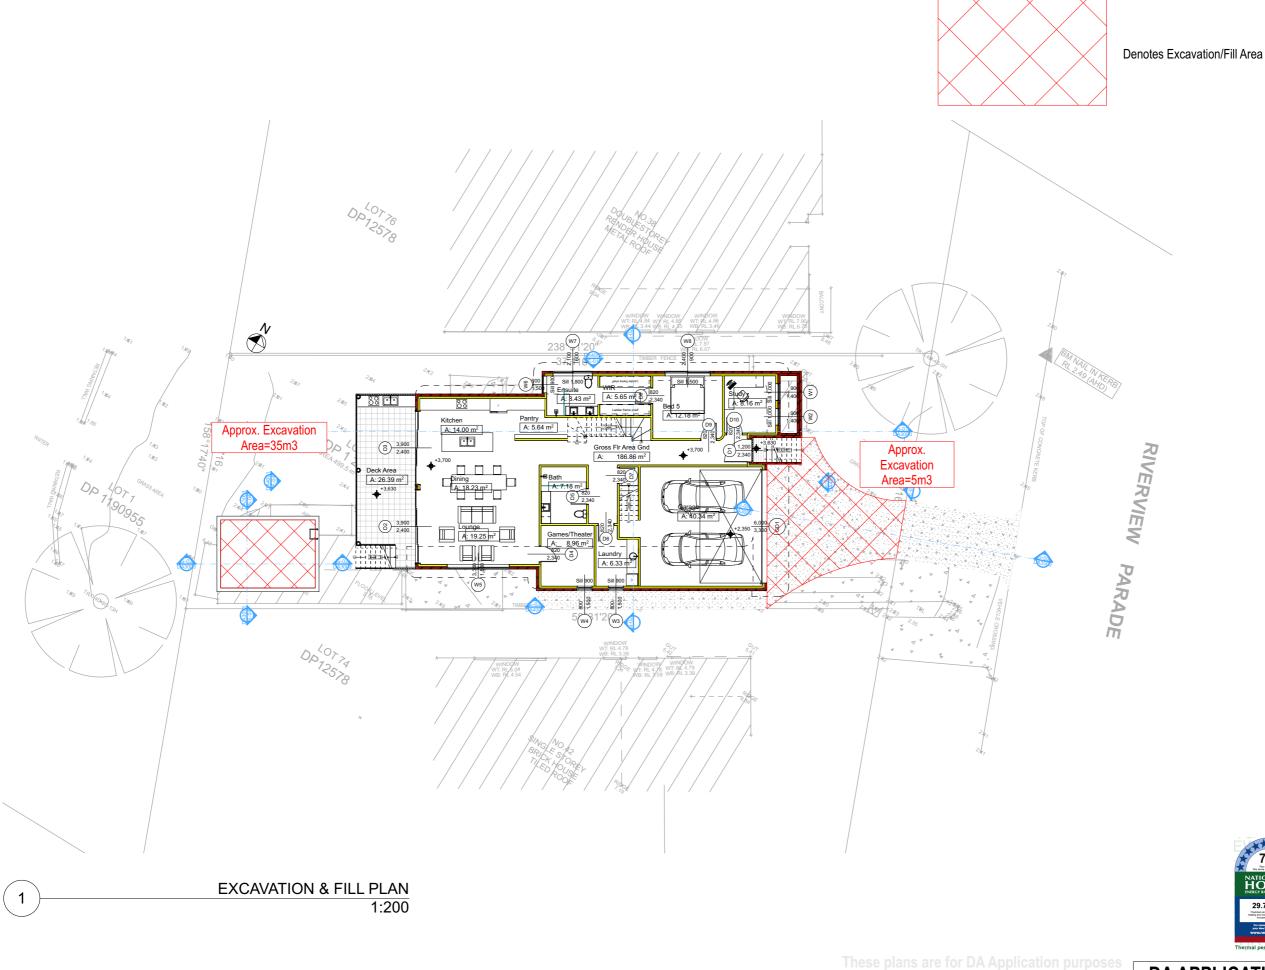

**DA APPLICATION ONLY** NOT FOR CONSTRUCTION

HOUSE









Site Area	499.5m2	Yes
Housing Density (dwelling/m2)	1	Yes
Max Ceiling Ht Above Nat. GL	7.2m	Yes
Max Bldg Ht Above Nat. GL	8.5m	Yes
Front Setback (Min.)	6.5m	Yes
Rear Setback (Min.)	6.0m	Yes
Min. side bdy setback (Min.)	0.9m	Yes
Building envelope	4m@45	Yes
	Deg	
% of landscape open space (40% min)	40%	Yes
Impervious area (m2)	%	Yes
Maximum cut into gnd (m)	2.1m	Yes
Maximum depth of fill (m)	NA	Yes
No of car spaces provided	2	Vac


**Builder to Check and Confirm all** Measurements Prior to Commencement of any works. mediately Report any Discrepancie to Rapid Plans




RAWING TITLE:
SITE AND LOCATION
Excavation & Fill Plan

New Dwelling

05-02-2024

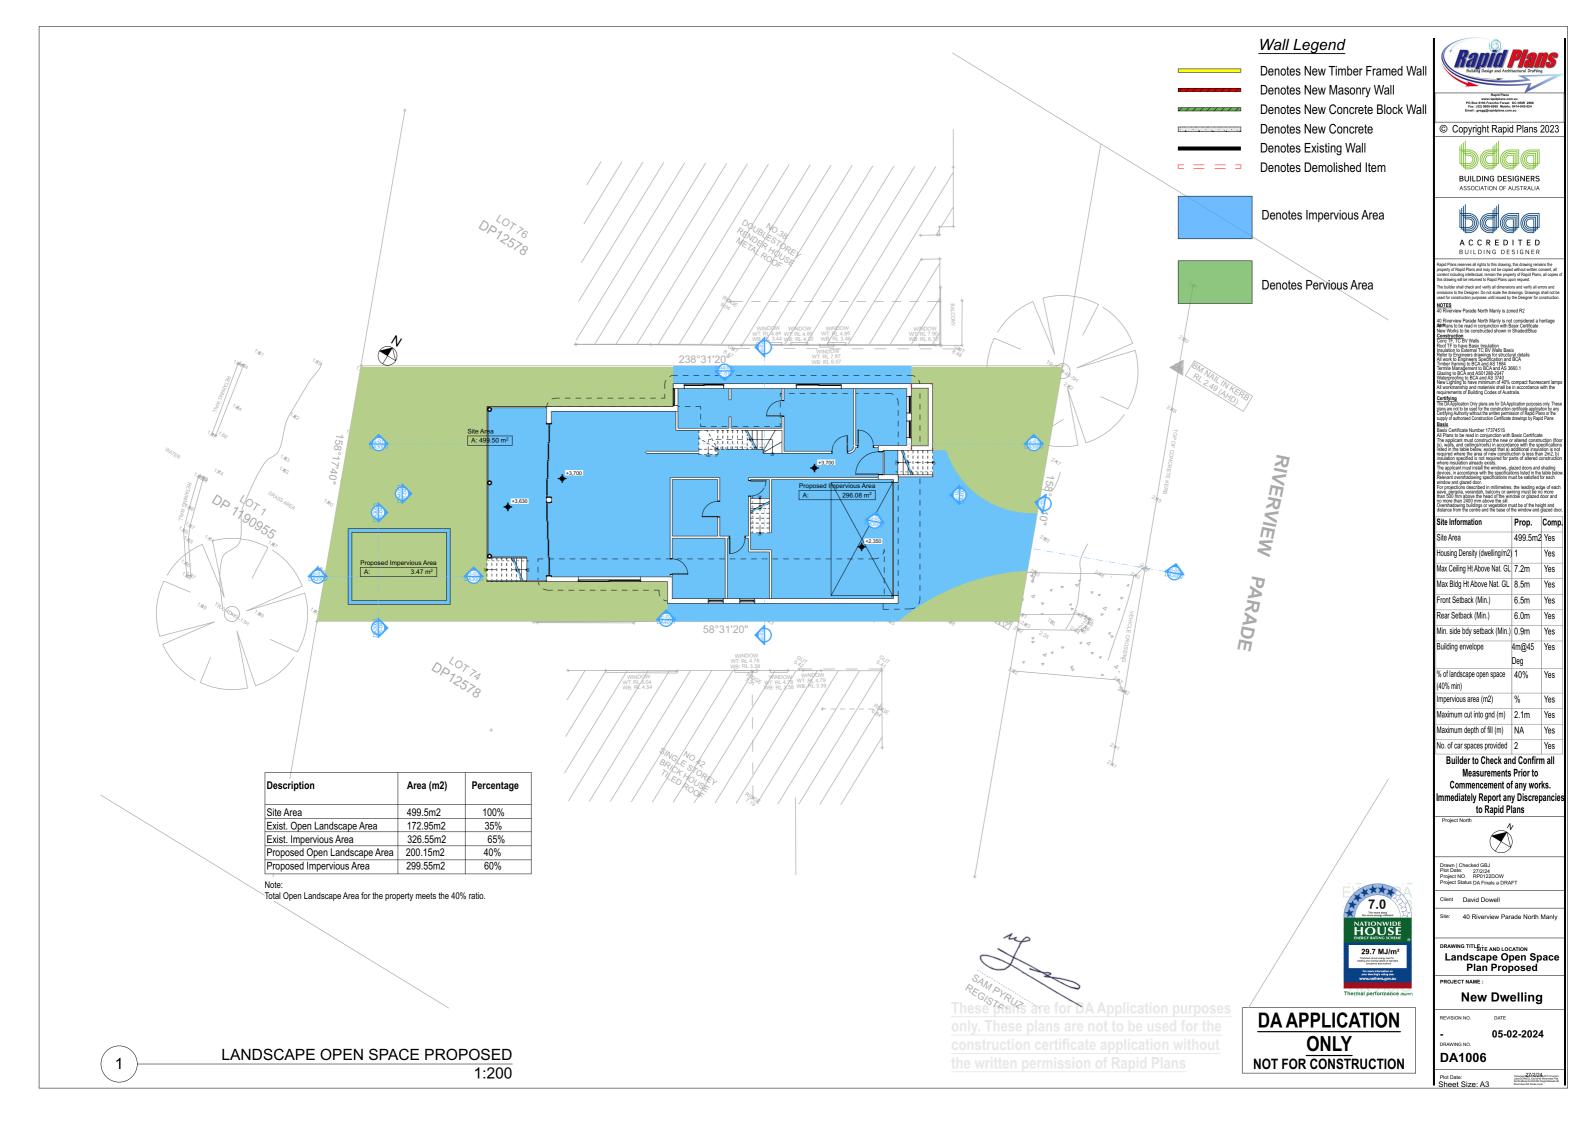

Water Commitments	Show on DA plans	Show on CC/CDC plans & specs	Certifier check
The swimming pool must not have a volume greater than 32 kilolitres.	~	~	
The swimming pool must have a pool cover.		<b>~</b>	
The swimming pool must be outdoors.	~	~	

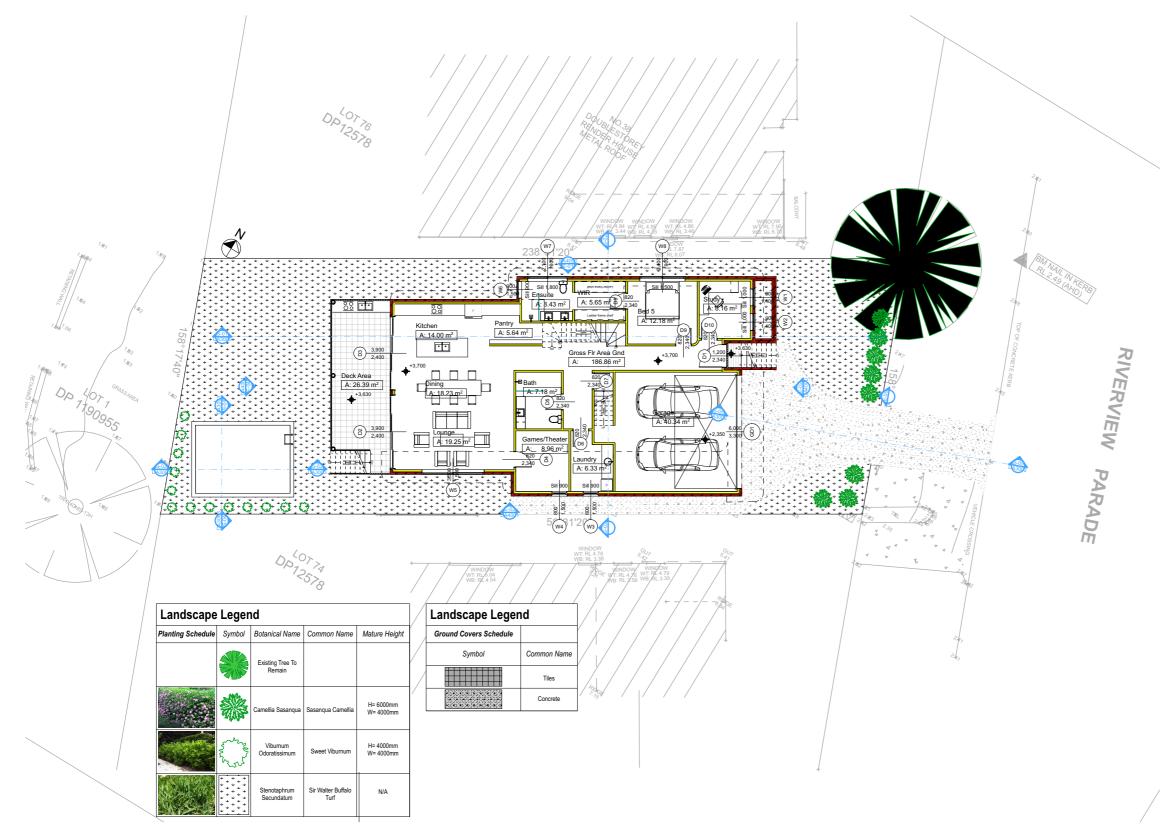

LANDSCAPE PLAN

1:200



**DA APPLICATION ONLY** NOT FOR CONSTRUCTION



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Site Information	Prop.	Comp.
Site Area	499.5m2	Yes
Housing Density (dwelling/m2)	1	Yes
Max Ceiling Ht Above Nat. GL	7.2m	Yes
Max Bldg Ht Above Nat. GL	8.5m	Yes
Front Setback (Min.)	6.5m	Yes
Rear Setback (Min.)	6.0m	Yes
Min. side bdy setback (Min.)	0.9m	Yes
Building envelope	4m@45	Yes
	Deg	
% of landscape open space (40% min)	40%	Yes
Impervious area (m2)	%	Yes
Maximum cut into gnd (m)	2.1m	Yes
Maximum depth of fill (m)	NA	Yes
No. of car spaces provided	2	Yes

**Builder to Check and Confirm all** Measurements Prior to Commencement of any works. mediately Report any Discrepancie to Rapid Plans




site and Location

Landscape Plan

**New Dwelling** 

05-02-2024

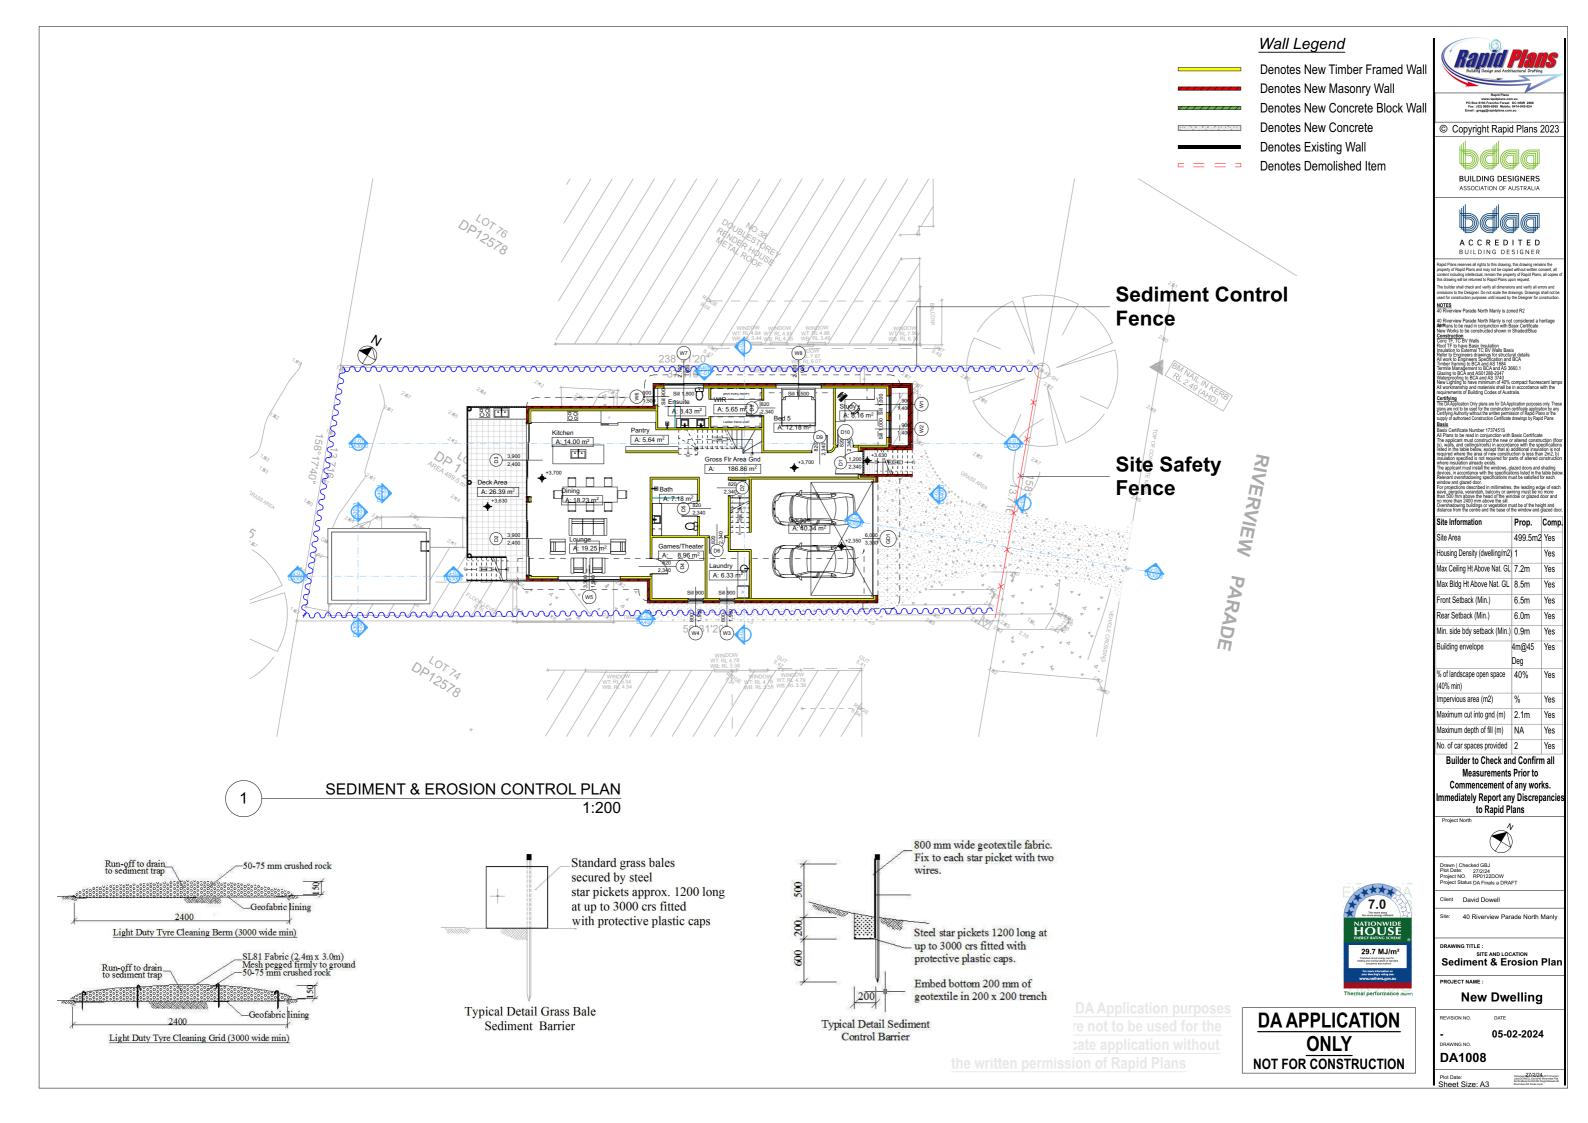

# Wall Legend Denotes New Timb Denotes New Mas

Denotes New Timber Framed Wall
Denotes New Masonry Wall
Denotes New Concrete Block Wall
Denotes New Concrete
Denotes Existing Wall

Denotes Demolished Item



Rapid Plans www.rapidplans.com.au PO Box 6193 Frenchs Forest DC NSW Fax: (02) 9905-8965 Mobile: 0414-945

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NOTES

40 Riverview Parade North Manly is zoned R2

40 Riverview Parade North Manly is not considered a beri

40 Riverview Parade North Manly is not considered a h
AllerBlans to be read in conjunction with Basix Certificate
New Works to be constructed shown in Shaded/Blue
Construction
Conc TF, TC BV Walls
Cond TF to have Basix Insulation

Refer to Engineers drawings for structural details All work to Engineers Specification and BCA Timber framing to BCA and AS 1884 Termile Management to BCA and AS 3680.1 Glazing to BCA and AS01268.2047 Wasterprofiles of BCA and AS01268.2047 ASD 450126.2047 ASD 450126.2047 ASD 450126.2047 Wasterprofiles of BCA 450126.2047 ASD 450126.2047 Wasterprofiles of BCA 450126.2047 Wa

**Intifying**In DA Application Only plans are for DA Application purposes only. Thesis are not to be used for the construction certificate application by any orthlying Authority without the written permission of Read Plans or the poly of authorised Construction Certificate drawings by Rapid Plans sists

is ix

ix Certificate Number 1727/351S

The applicant must construct the new or altered construction (iii), valids, and conjustroids) in accordance with the specifical listed in the lable below accord that a) address in suitable is less than the substance of the subs

Relevant overshadowing specifications must be satisfied for each window and glazed door. For projections described in millimetres, the leading edge of ea eave, pergola, verandah, balcony or awning must be no more than 500 mm above the head of the window or glazed door and no more than 2400 mm above the sill. Overshadowing buildings or vegetation must be of the height and

Ho. of car spaces provided 2 Yes

Builder to Check and Confirm all

Measurements Prior to

Commencement of any works.

mmediately Report any Discrepanci



Drawn | Checked GBJ Plot Date: 27/2/24 Project NO. RP0122DOV

Client David De

Site: 40 Riverview Parade North

SITE AND LOCATION

Waste Management Plan


ROJECT NAME :

New Dwelling

05-02-2024

DA1009

nt Date: Associate Associa

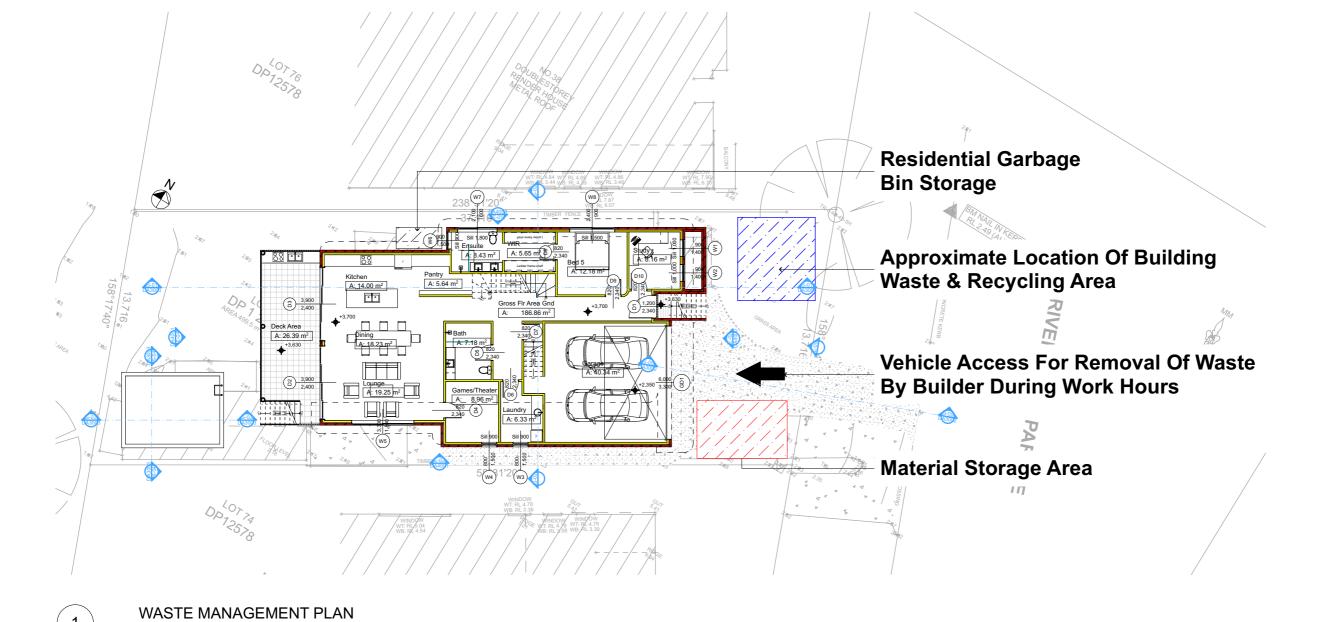


1:200

These plans are for DA Application purposes only. These plans are not to be used for the construction certificate application without the written permission of Rapid Plans

DA APPLICATION
ONLY
NOT FOR CONSTRUCTION

HOUSE

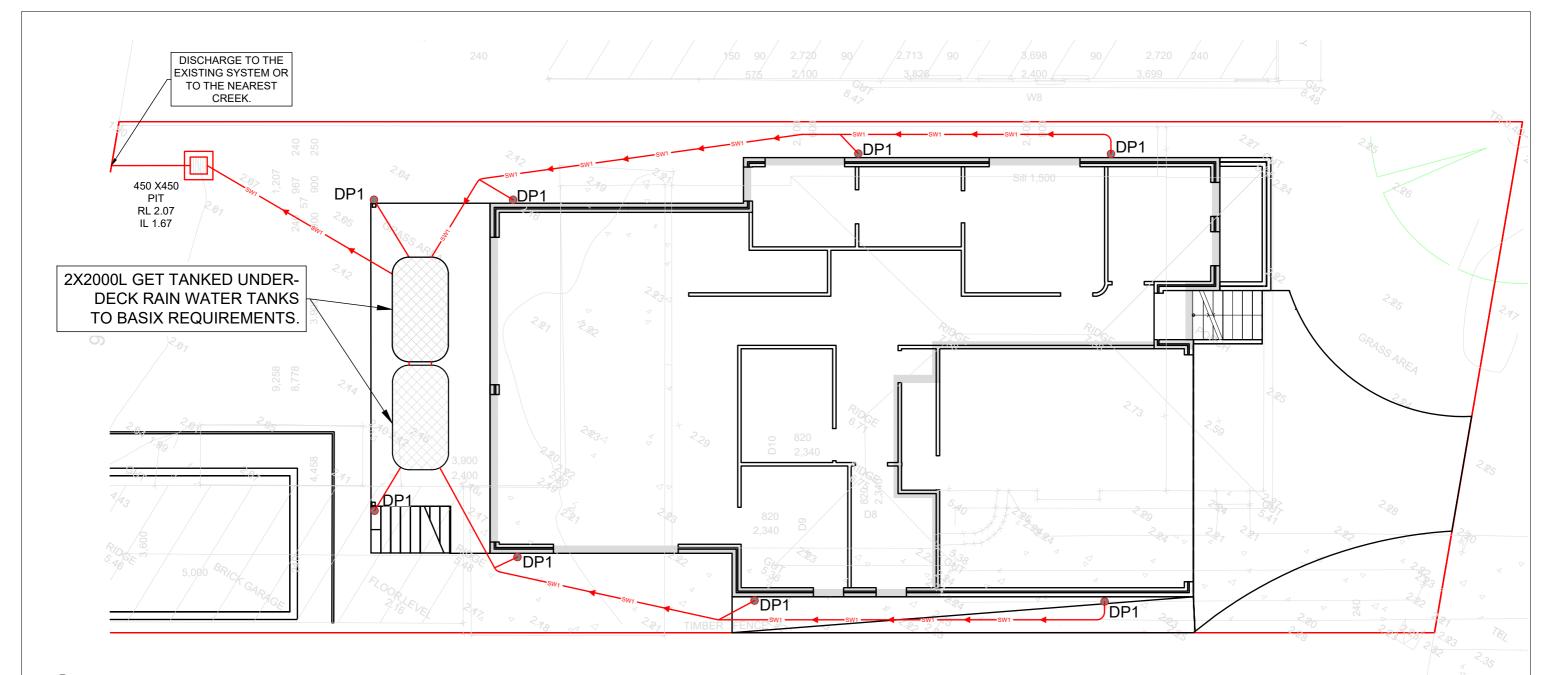

Plans - Stormwater 1:1

#### SITE PARAMETERS & TANK DETAILS SITE AREA 499.5 m2 **EXISTING IMPERVIOUS AREA** 326.55 m2 PROPOSED IMPERVIOUS AREA 299.55 m2 EXISTING LANDSCAPED AREA 172.95 m2 200.15 m2 PROPOSED LANDSCAPED AREA 3500 L RWT TANK REQUIREMENT

### **GROUND FLOOR DRAINAGE PLAN**

SCALE 1:100

### LEGEND:

NEW DOWNPIPE (Ø100 mm uPVC) DPS. DOWNPIPE SPREADER Ø100 uPVC STORMWATER PIPE MIN. 1% FALL (U.N.O) SEDIMENT CONTROL FENCE



450x450 GRATED PIT



RAINWATER TANK TO BASIX REQ.










27/2/24 RP0122DOW DA Finals a DRAFT David Dowell


DRAWING TITLE :


SITE AND LOCATION
Stormwater Plan

REVISION NO. 05-02-2024 **DA1010** 

PROJECT NAME : will be guest. G DESIGNERS © Copyright Rapid Plans 2023 40 Riverview Parade North **New Dwelling** ASSOCIATION OF AUSTRALIA BUILDING DESIGNER

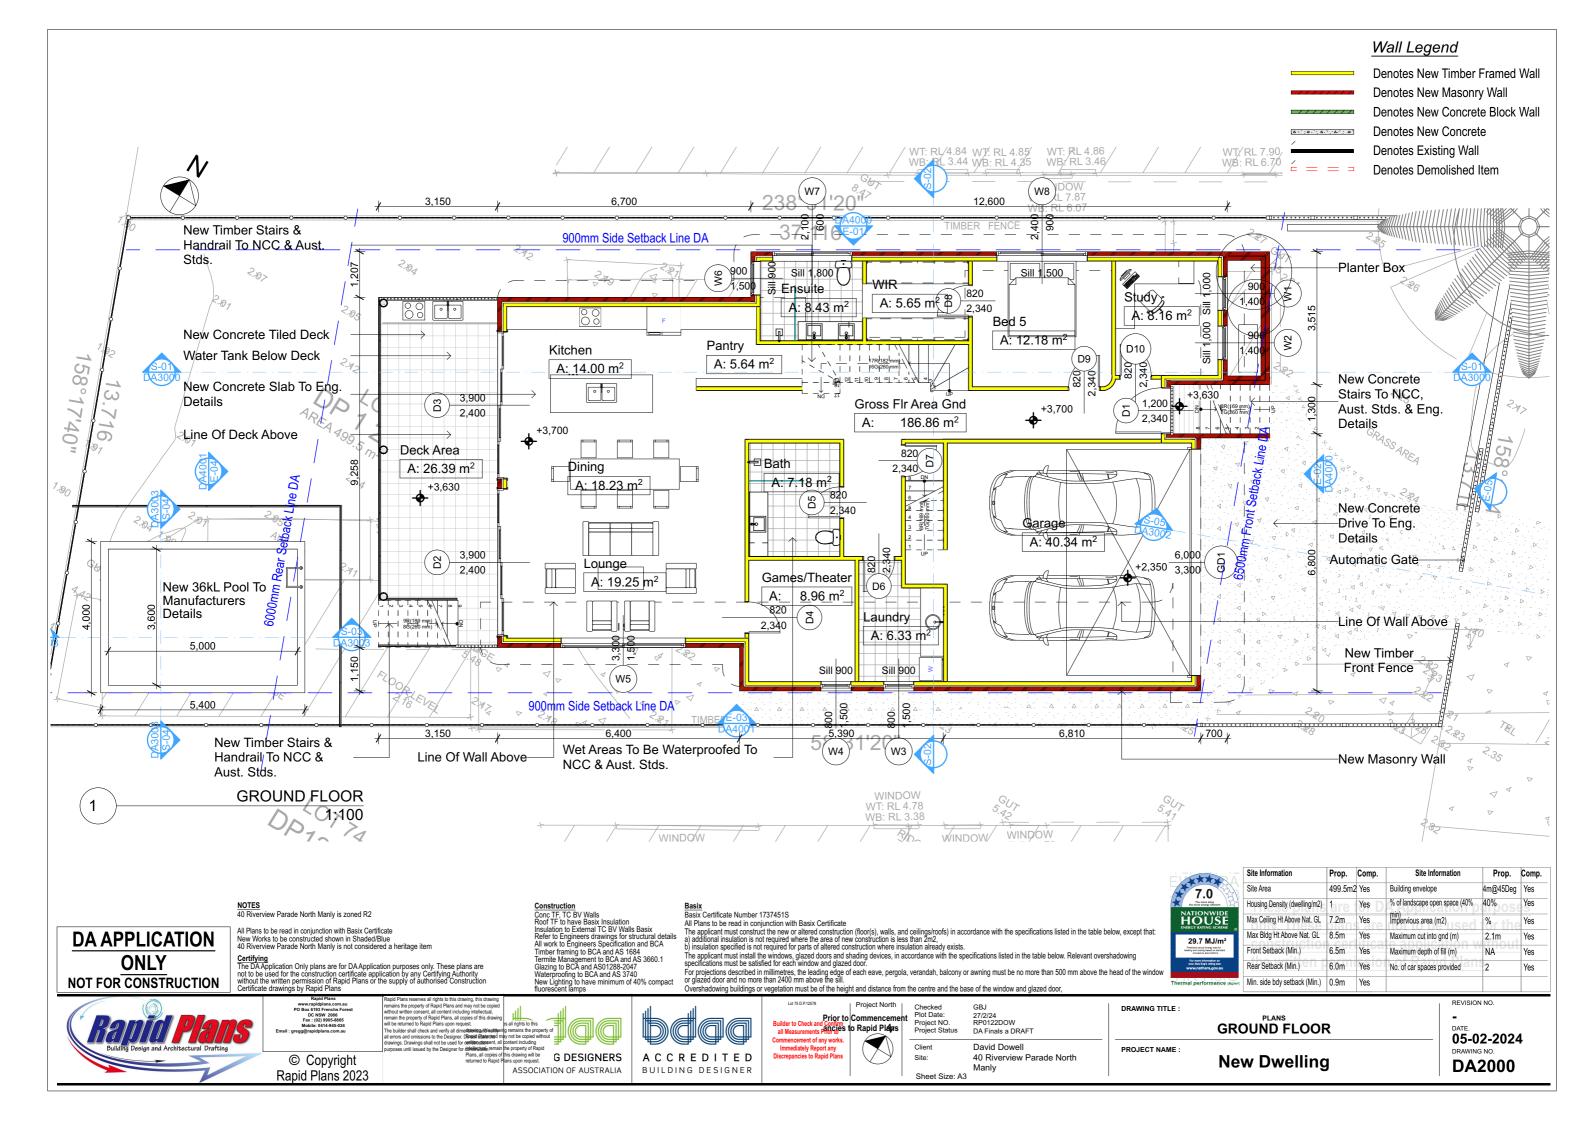

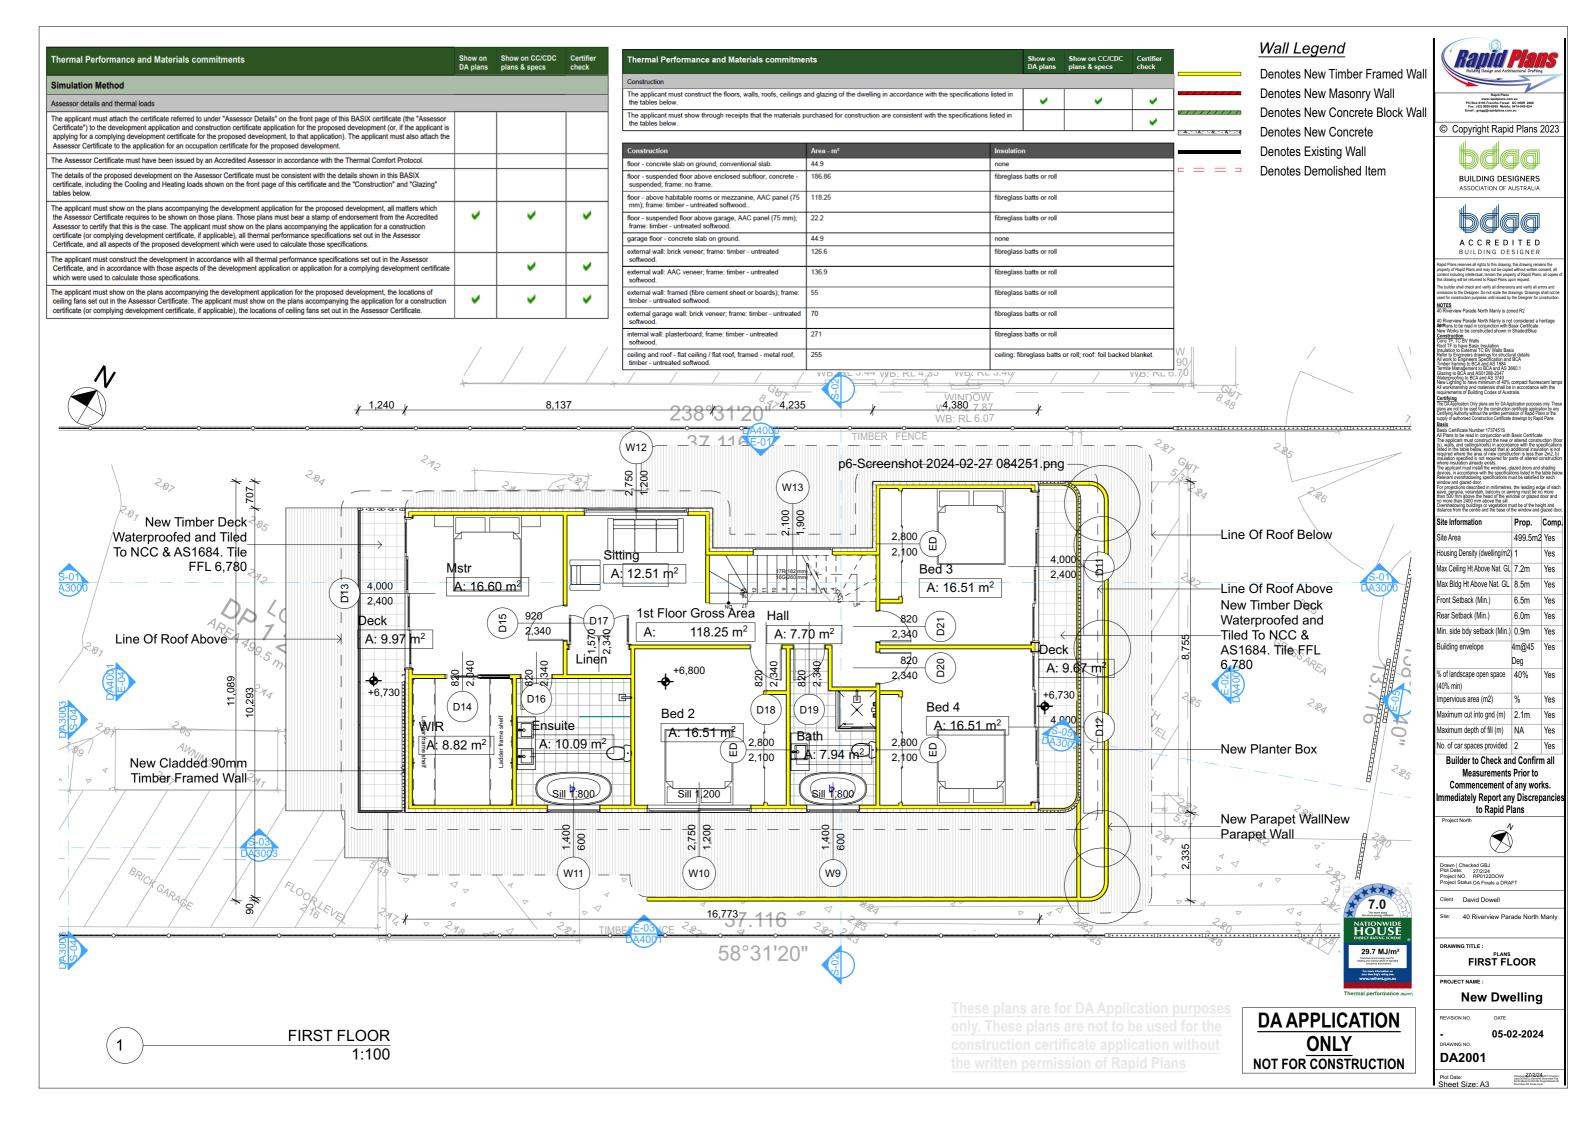

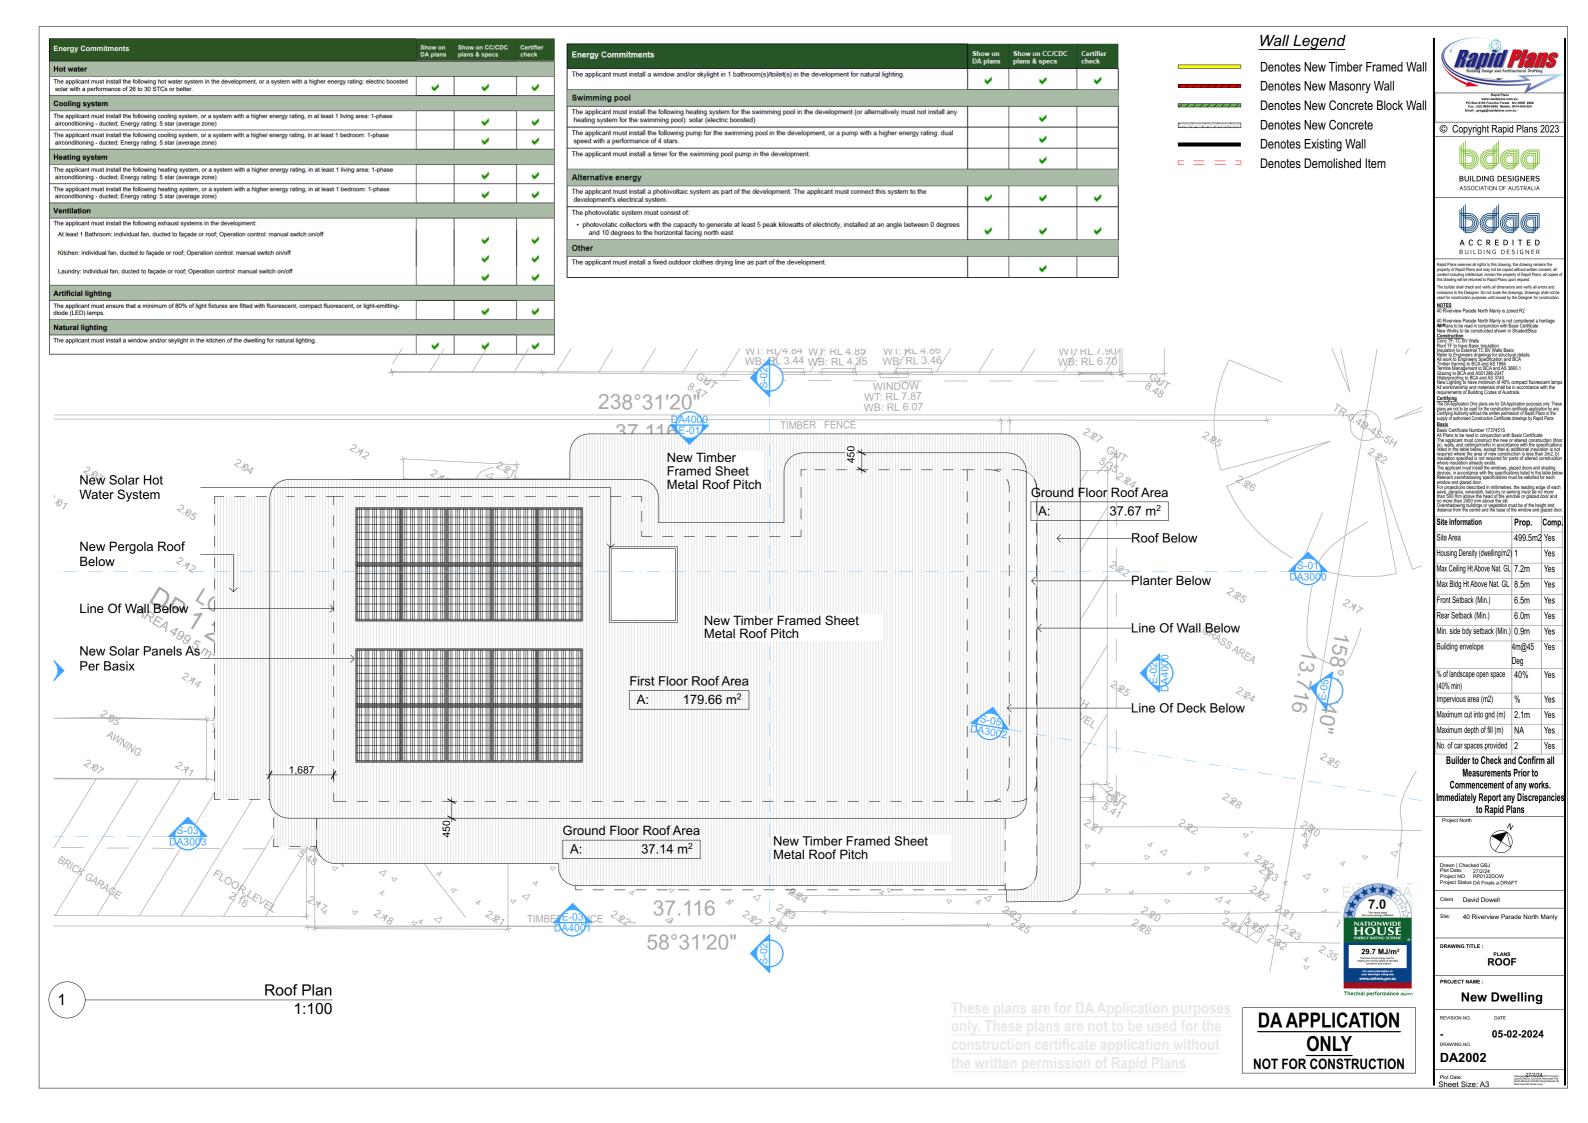


Thermal Performance and Materials commitments	Show on DA plans	Show on CC/CDC plans & specs	Certifier check
Simulation Method			
Assessor details and thermal loads			
The applicant must attach the certificate referred to under "Assessor Details" on the front page of this BASIX certificate (the "Assessor Certificate") to the development application and construction certificate application for the proposed development (or, if the applicant is applying for a complying development certificate for the proposed development, to that application). The applicant must also attach the Assessor Certificate to the application for an occupation certificate for the proposed development.			
The Assessor Certificate must have been issued by an Accredited Assessor in accordance with the Thermal Comfort Protocol.			
The details of the proposed development on the Assessor Certificate must be consistent with the details shown in this BASIX certificate, including the Cooling and Heating loads shown on the front page of this certificate and the "Construction" and "Glazing" tables below.			
The applicant must show on the plans accompanying the development application for the proposed development, all matters which the Assessor Certificate requires to be shown on those plans. Those plans must bear a stamp of endorsement from the Accredited Assessor to certify that this is the case. The applicant must show on the plans accompanying the application for a construction certificate (or complying development certificate, if applicable), all thermal performance specifications set out in the Assessor Certificate, and all aspects of the proposed development which were used to calculate those specifications.	~	~	~
The applicant must construct the development in accordance with all thermal performance specifications set out in the Assessor Certificate, and in accordance with those aspects of the development application or application for a complying development certificate which were used to calculate those specifications.		~	~
The applicant must show on the plans accompanying the development application for the proposed development, the locations of ceiling fans set out in the Assessor Certificate. The applicant must show on the plans accompanying the application for a construction certificate (or complying development certificate, if applicable), the locations of ceiling fans set out in the Assessor Certificate.	~	~	~

Thermal Performance and Materials commitments	Show on DA plans	Show on CC/CDC plans & specs	Certifier check
Construction			
The applicant must construct the floors, walls, roofs, ceilings and glazing of the dwelling in accordance with the specifications listed in the tables below.	~	~	~
The applicant must show through receipts that the materials purchased for construction are consistent with the specifications listed in the tables below.			~

Construction	Area - m²	Insulation
floor - concrete slab on ground, conventional slab.	44.9	none
floor - suspended floor above enclosed subfloor, concrete - suspended; frame: no frame.	186.86	fibreglass batts or roll
floor - above habitable rooms or mezzanine, AAC panel (75 mm); frame: timber - untreated softwood	118.25	fibreglass batts or roll
floor - suspended floor above garage, AAC panel (75 mm); frame: timber - untreated softwood.	22.2	fibreglass batts or roll
garage floor - concrete slab on ground.	44.9	none
external wall: brick veneer; frame: timber - untreated softwood.	126.6	fibreglass batts or roll
external wall: AAC veneer; frame: timber - untreated softwood.	136.9	fibreglass batts or roll
external wall: framed (fibre cement sheet or boards); frame: timber - untreated softwood.	55	fibreglass batts or roll
external garage wall: brick veneer; frame: timber - untreated softwood.	70	fibreglass batts or roll
internal wall: plasterboard; frame: timber - untreated softwood.	271	fibreglass batts or roll
ceiling and roof - flat ceiling / flat roof, framed - metal roof, timber - untreated softwood.	255	ceiling: fibreglass batts or roll; roof: foil backed blanket.



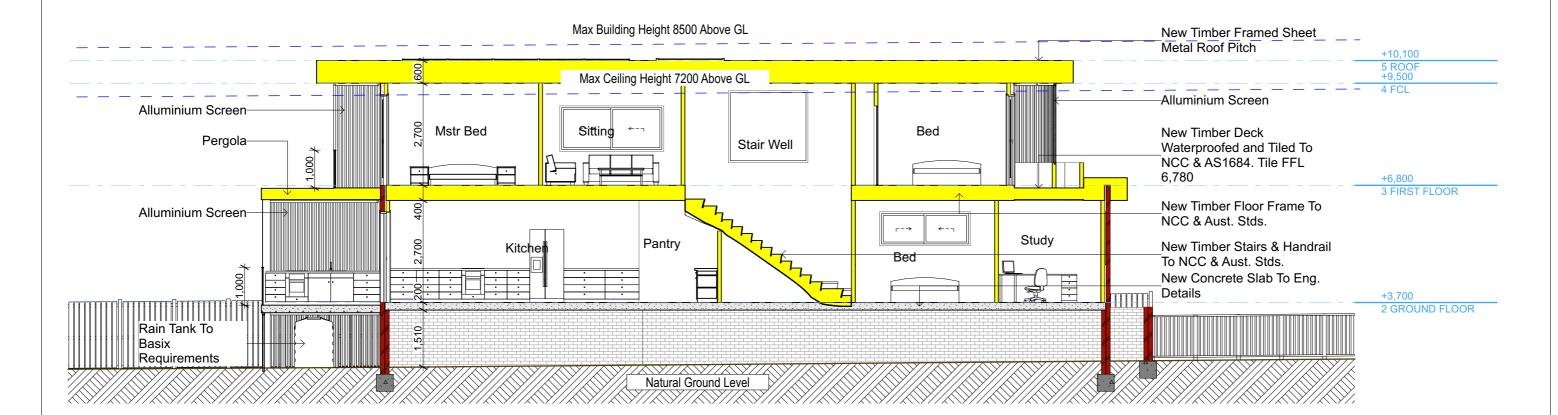

**DA APPLICATION** 

ONLY

NOT FOR CONSTRUCTION

(S-01)

NOTES 40 Riverview Parade North Manly is zoned R2

**SECTION 1** 

All Plans to be read in conjunction with Basix Certificate
New Works to be constructed shown in Shaded/Blue
40 Riverview Parade North Manly is not considered a heritage item

1:100

Certifying
The DA Application Only plans are for DA Application purposes only. These plans are not to be used for the construction certificate application by any Certifying Authority without the written permission of Rapid Plans or the supply of authorised Construction Certificate drawings by Rapid Plans

G DESIGNERS ASSOCIATION OF AUSTRALIA



ancies to Rapid Plays

Basix Certificate Number 1/3/451S
All Plans to be read in conjunction with Basix Certificate
The applicant must construct the new or altered construction (floor(s), walls, and ceilings/roofs) in accordance with the specifications listed in the table below, except that:
a) additional insulation is not required where the area of new construction is less than 2m2,
b) insulation specified is not required for parts of altered construction where insulation already exists.
The applicant must install the windows, glazed doors and shading devices, in accordance with the specifications listed in the table below. Relevant overshadowing specifications must be satisfied for each window and glazed door.

For projections described in millimetres, the leading edge of each eave, pergola, verandah, balcony or awning must be no more than 500 mm above the head of the window or glazed door and no more than 2400 mm above the sill.

Overshadowing buildings or vegetation must be of the height and distance from the centre and the base of the window and glazed door, David Dowell

Sheet Size: A3

40 Riverview Parade North

7.0 HOUSI 29.7 MJ/m

Site Information	Prop.	Comp.	Site Information	Prop.	Comp.
Site Area	499.5m2	Yes	Building envelope	4m@45Deg	Yes
Housing Density (dwelling/m2)	are t	Yes	% of landscape open space (40%	40%	Yes
Max Ceiling Ht Above Nat. GL	7.2m	Yes	min) Impervious area (m2)	%	Yes
Max Bldg Ht Above Nat. GL	8.5m	Yes	Maximum cut into gnd (m)	2.1m	Yes
Front Setback (Min.)	6.5m	Yes	Maximum depth of fill (m)	NA	Yes
Rear Setback (Min.)	6.0m	Yes	No. of car spaces provided	2	Yes
Min. side bdy setback (Min.)	0.9m	Yes			

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Rapid Plans 2023

BUILDING DESIGNER

Basix Certificate Number 1737451S

27/2/24 RP0122DOW DA Finals a DRAFT

PROJECT NAME :

DRAWING TITLE :

SECTION 1

**New Dwelling** 

REVISION NO. 05-02-2024

Thermal Performance and Materials commitments	Show on DA plans	Show on CC/CDC plans & specs	Certifier check
Construction			
The applicant must construct the floors, walls, roofs, ceilings and glazing of the dwelling in accordance with the specifications listed in the tables below.	~	~	~
The applicant must show through receipts that the materials purchased for construction are consistent with the specifications listed in the tables below.			~

Construction	Area - m²	Insulation
floor - concrete slab on ground, conventional slab.	44.9	none
floor - suspended floor above enclosed subfloor, concrete - suspended; frame: no frame.	186.86	fibreglass batts or roll
floor - above habitable rooms or mezzanine, AAC panel (75 mm); frame: timber - untreated softwood	118.25	fibreglass batts or roll
floor - suspended floor above garage, AAC panel (75 mm); frame: timber - untreated softwood.	22.2	fibreglass batts or roll
garage floor - concrete slab on ground.	44.9	none
external wall: brick veneer; frame: timber - untreated softwood.	126.6	fibreglass batts or roll
external wall: AAC veneer; frame: timber - untreated softwood.	136.9	fibreglass batts or roll
external wall: framed (fibre cement sheet or boards); frame: timber - untreated softwood.	55	fibreglass batts or roll
external garage wall: brick veneer; frame: timber - untreated softwood.	70	fibreglass batts or roll
internal wall: plasterboard; frame: timber - untreated softwood.	271	fibreglass batts or roll
ceiling and roof - flat ceiling / flat roof, framed - metal roof, timber - untreated softwood.	255	ceiling: fibreglass batts or roll; roof: foil backed blanket.

Frames	Maximum area - m2
aluminium	75.2
timber	0
uPVC	0
steel	0
composite	0

The applicant must install windows, glazed doors and skylights as described in the table below, in accordance with the specifications listed in the table.

Thermal Performance and Materials commitments

**S-02** 

Glazing	Maximum area - m2
single	0
double	75.2
triple	0

Section 2

1:100

#### Schedule of BASIX commitments

The commitments set out below regulate how the proposed development is to be carried out. It is a condition of any development consent granted, or complying development certificate issued, for the proposed development, that BASIX commitments be complied with.

Water Commitments	Show on DA plans	Show on CC/CDC plans & specs	Certi
Landscape			
The applicant must plant indigenous or low water use species of vegetation throughout 100 square metres of the site.	~	~	
Fixtures			
The applicant must install showerheads with a minimum rating of 4 star (> 4.5 but <= 6 L/min plus spray force and/or coverage tests) in all showers in the development.		~	
The applicant must install a toilet flushing system with a minimum rating of 5 star in each toilet in the development.		~	
The applicant must install taps with a minimum rating of 5 star in the kitchen in the development.		~	
The applicant must install basin taps with a minimum rating of 5 star in each bathroom in the development.		~	
Alternative water			
Rainwater tank			
The applicant must install a rainwater tank of at least 4000 litres on the site. This rainwater tank must meet, and be installed in accordance with, the requirements of all applicable regulatory authorities.	~	~	
The applicant must configure the rainwater tank to collect rain runoff from at least 170 square metres of the roof area of the development (excluding the area of the roof which drains to any stormwater tank or private dam).		~	
The applicant must connect the rainwater tank to:			
<ul> <li>at least one outdoor tap in the development (Note: NSW Health does not recommend that rainwater be used for human consumption in areas with potable water supply.)</li> </ul>		-	
a tap that is located within 10 metres of the swimming pool in the development		_	

Energy Commitments	Show on DA plans	Show on CC/CDC plans & specs	Certifier check
The applicant must install a window and/or skylight in 1 bathroom(s)/toilet(s) in the development for natural lighting.	~	~	~
Swimming pool			
The applicant must install the following heating system for the swimming pool in the development (or alternatively must not install any heating system for the swimming pool): solar (electric boosted)		~	
The applicant must install the following pump for the swimming pool in the development, or a pump with a higher energy rating: dual speed with a performance of 4 stars.		~	
The applicant must install a timer for the swimming pool pump in the development.		~	
Alternative energy			
The applicant must install a photovoltaic system as part of the development. The applicant must connect this system to the development's electrical system.	~	~	~
The photovolatic system must consist of:			
<ul> <li>photovolatic collectors with the capacity to generate at least 5 peak kilowatts of electricity, installed at an angle between 0 degrees and 10 degrees to the horizontal facing north east</li> </ul>	-	-	~
Other	•		
The applicant must install a fixed outdoor clothes drying line as part of the development.			

#### **New Timber Framed Sheet** Max Building Height 8500 Above GL Metal Roof Pitch +10,100 +10,100 5 ROOF +9,500 5 ROOF +9,500 Max Ceiling Height 7200 Above GL 4 FCL 4 FCL New Cladded 90mm Timber Framed Wall New Timber Floor Frame To Bed NCC & Aust. Stds. +6,800 +6,800 45° 3 FIRST FLOOR 3 FIRST FLOOR New Timber Stairs & Handrail New Brick Vaneer To NCC & Aust. Stds. Rendered Wall **Building Envelope Building Envelope** Garage Stair Bdy 4,000 Bdy +3,700 2 GROUND FLOOR New Concrete Slab To Eng. Details Natural Ground Level Natural Ground Level

#### Wall Legend

**Denotes New Timber Framed Wall** Denotes New Masonry Wall Denotes New Concrete Block Wall

**Denotes New Concrete** 

Denotes Existing Wall Denotes Demolished Item

< < <



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A C C R E D I T E D BUILDING DESIGNER

		, ,
Site Information	Prop.	Comp.
Site Area	499.5m2	Yes
Housing Density (dwelling/m2)	1	Yes
Max Ceiling Ht Above Nat. GL	7.2m	Yes
Max Bldg Ht Above Nat. GL	8.5m	Yes
Front Setback (Min.)	6.5m	Yes
Rear Setback (Min.)	6.0m	Yes
Min. side bdy setback (Min.)	0.9m	Yes
Building envelope	4m@45	Yes
	Deg	
% of landscape open space	40%	Yes
(40% min)		
Impervious area (m2)	%	Yes
Maximum cut into gnd (m)	2.1m	Yes
Maximum depth of fill (m)	NA	Yes

**Builder to Check and Confirm all** Measurements Prior to Commencement of any works. nmediately Report any Discrepancie to Rapid Plans

lo. of car spaces provided 2

Drawn | Checked GBJ Plot Date: 27/2/24 Project NO. RP0122DOW Project Status DA Finals a D

nt David Dowell


RAWING TITLE :

SECTIONS 2

**New Dwelling** 


05-02-2024



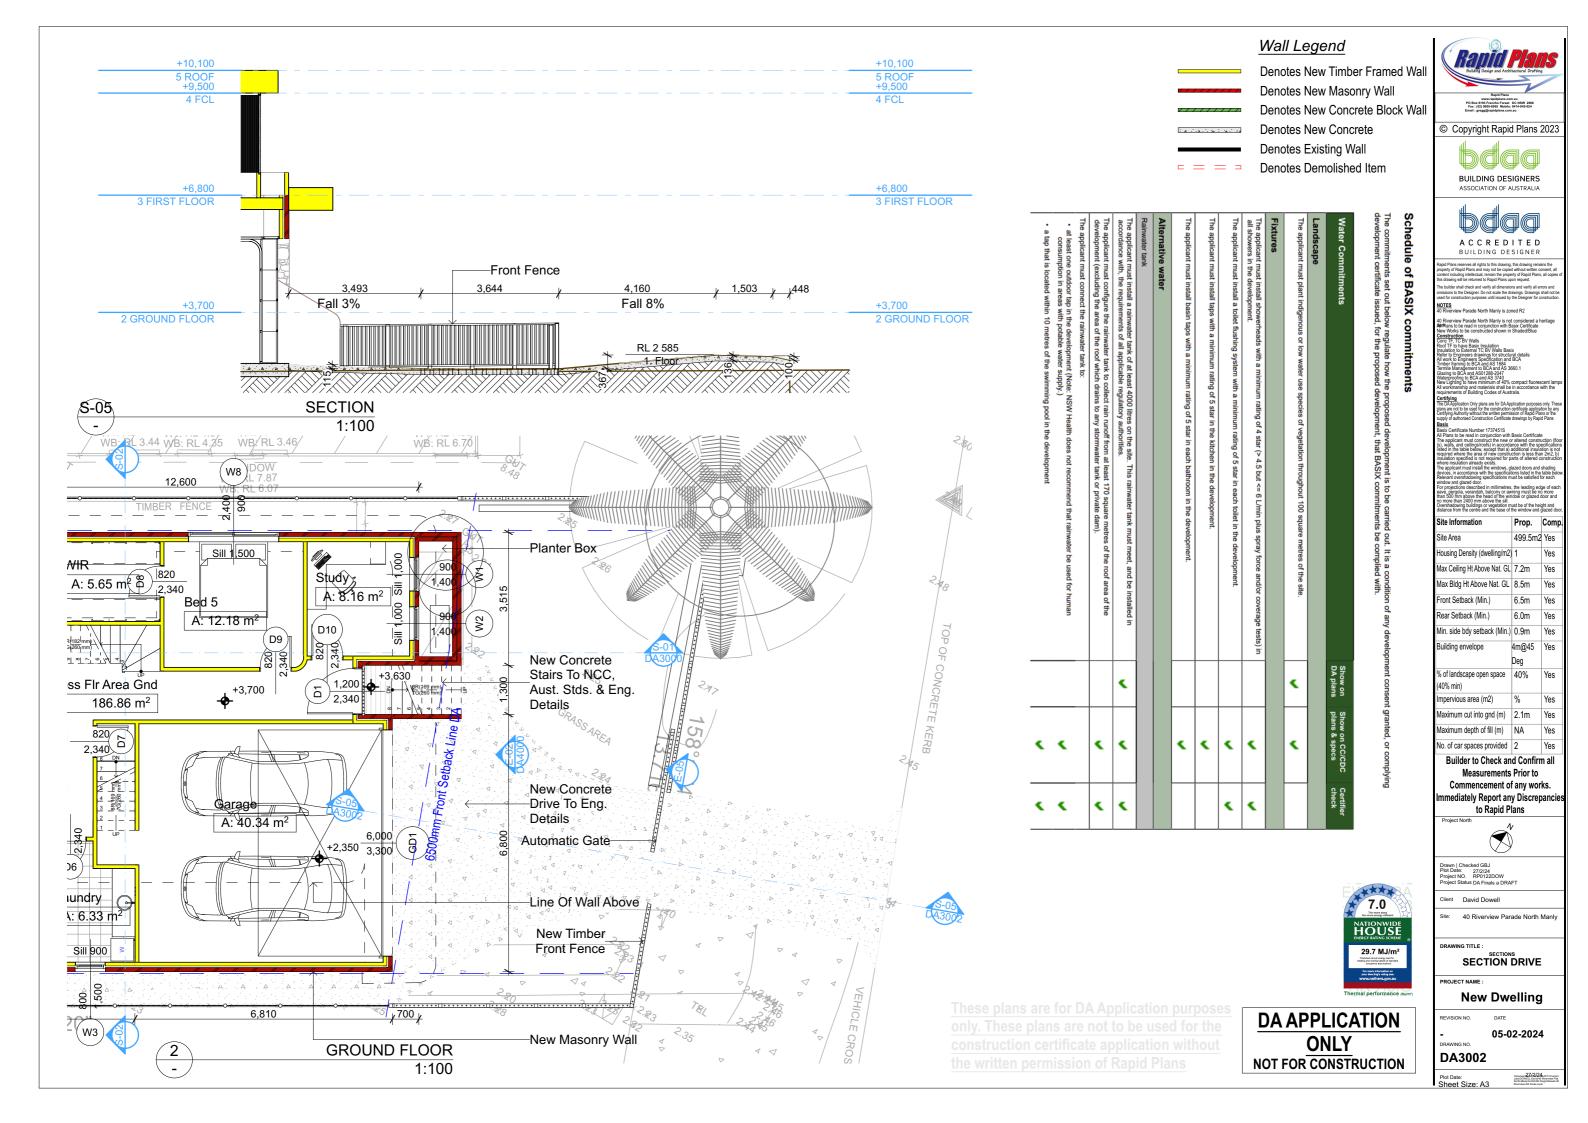

Energy Commitments	Show on DA plans	Show on CC/CDC plans & specs	Certifier check
The applicant must install a window and/or skylight in 1 bathroom(s)/toilet(s) in the development for natural lighting.	~	~	~
Swimming pool			
The applicant must install the following heating system for the swimming pool in the development (or alternatively must not install any heating system for the swimming pool): solar (electric boosted)		~	
The applicant must install the following pump for the swimming pool in the development, or a pump with a higher energy rating: dual speed with a performance of 4 stars.		~	
The applicant must install a timer for the swimming pool pump in the development.		~	
Alternative energy			
The applicant must install a photovoltaic system as part of the development. The applicant must connect this system to the development's electrical system.	~	~	~
The photovolatic system must consist of:			
<ul> <li>photovolatic collectors with the capacity to generate at least 5 peak kilowatts of electricity, installed at an angle between 0 degrees and 10 degrees to the horizontal facing north east</li> </ul>	-	-	-
Other			
The applicant must install a fixed outdoor clothes drying line as part of the development.			

Water Commitments	Show on DA plans	Show on CC/CDC plans & specs	Certifier check
Swimming Pool			
The swimming pool must not have a volume greater than 36 kilolitres.	·	~	
The swimming pool must be outdoors.	<b>✓</b>	~	

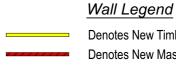

**Denotes New Timber Framed Wall** Denotes New Masonry Wall Denotes New Concrete Block Wall Denotes New Concrete **Denotes Existing Wall** 





499.5m2 Yes Max Ceiling Ht Above Nat. GL 7.2m ax Bldg Ht Above Nat. GL 8.5m 6.5m 6.0m Rear Setback (Min.) Min. side bdy setback (Min.) 0.9m 4m@45 % of landscape open space 40% pervious area (m2)

**Builder to Check and Confirm all** Measurements Prior to Commencement of any works. nmediately Report any Discrepancion to Rapid Plans

o. of car spaces provided 2



Drawn | Checked GBJ Plot Date: 27/2/24 Project NO. RP0122DOW Project Status DA Finals a D

David Dowell


AWING TITLE :

SECTION POOL

**New Dwelling** 

05-02-2024

**DA3003** 

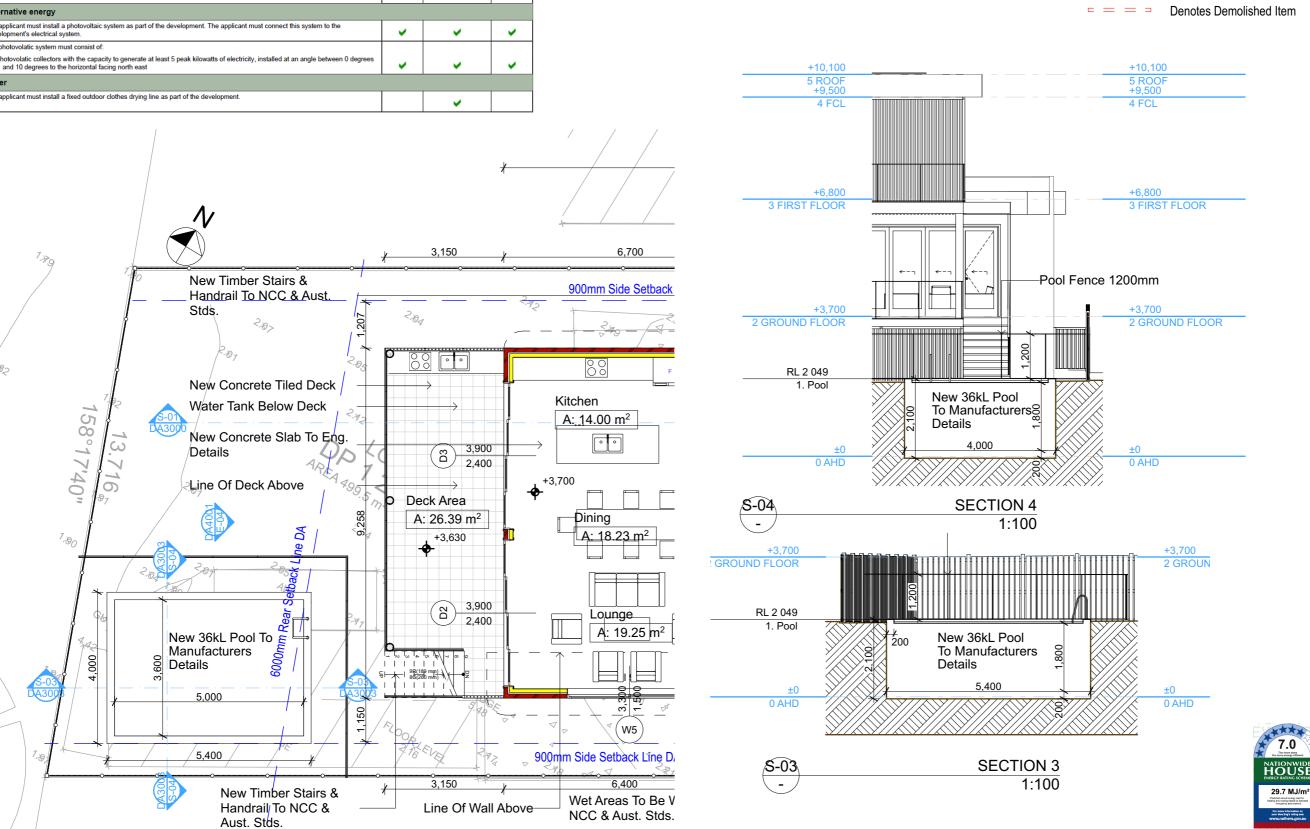


**GROUND FLOOR** 1:100

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7.0

29.7 MJ/m

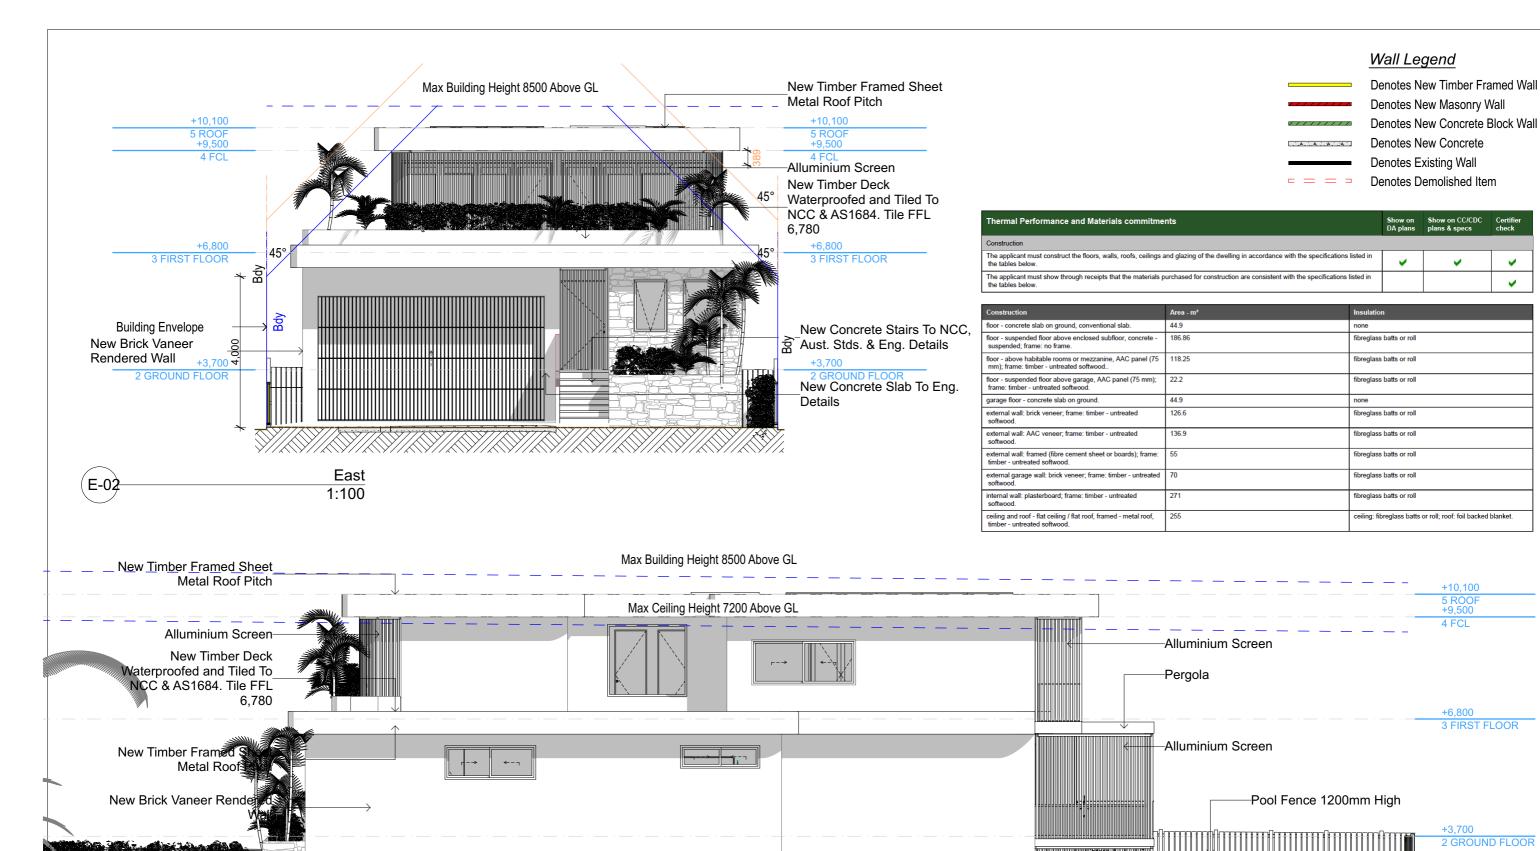

Natural Ground Level **DA APPLICATION ONLY** North E-0 NOT FOR CONSTRUCTION 1:100 REVISION NO.





ort any Discrepancies to Rapid Plans

27/2/24 RP0122DOW DA Finals a DRAFT David Dowell

40 Riverview Parade North

DRAWING TITLE :

ELEVATIONS 1 PROJECT NAME :


**New Dwelling** 

05-02-2024

**DA4000** 

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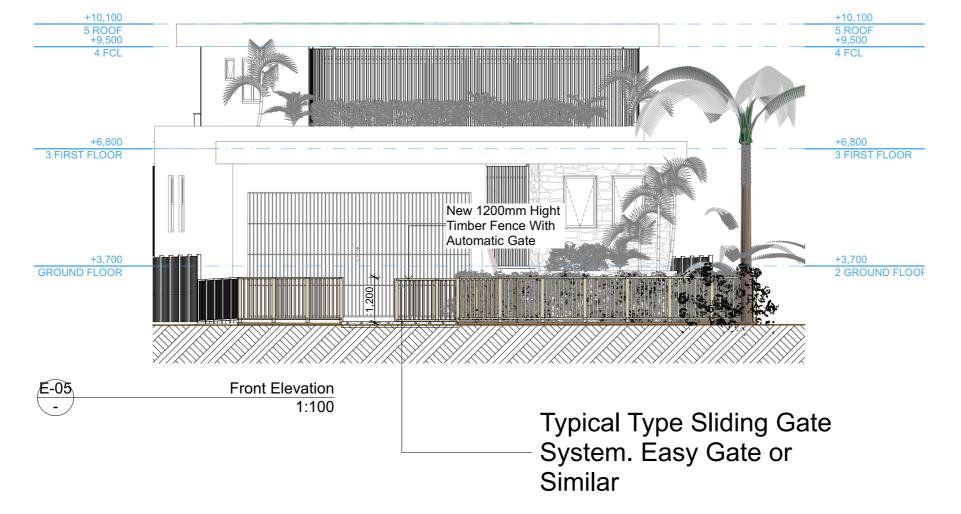


## Wall Legend

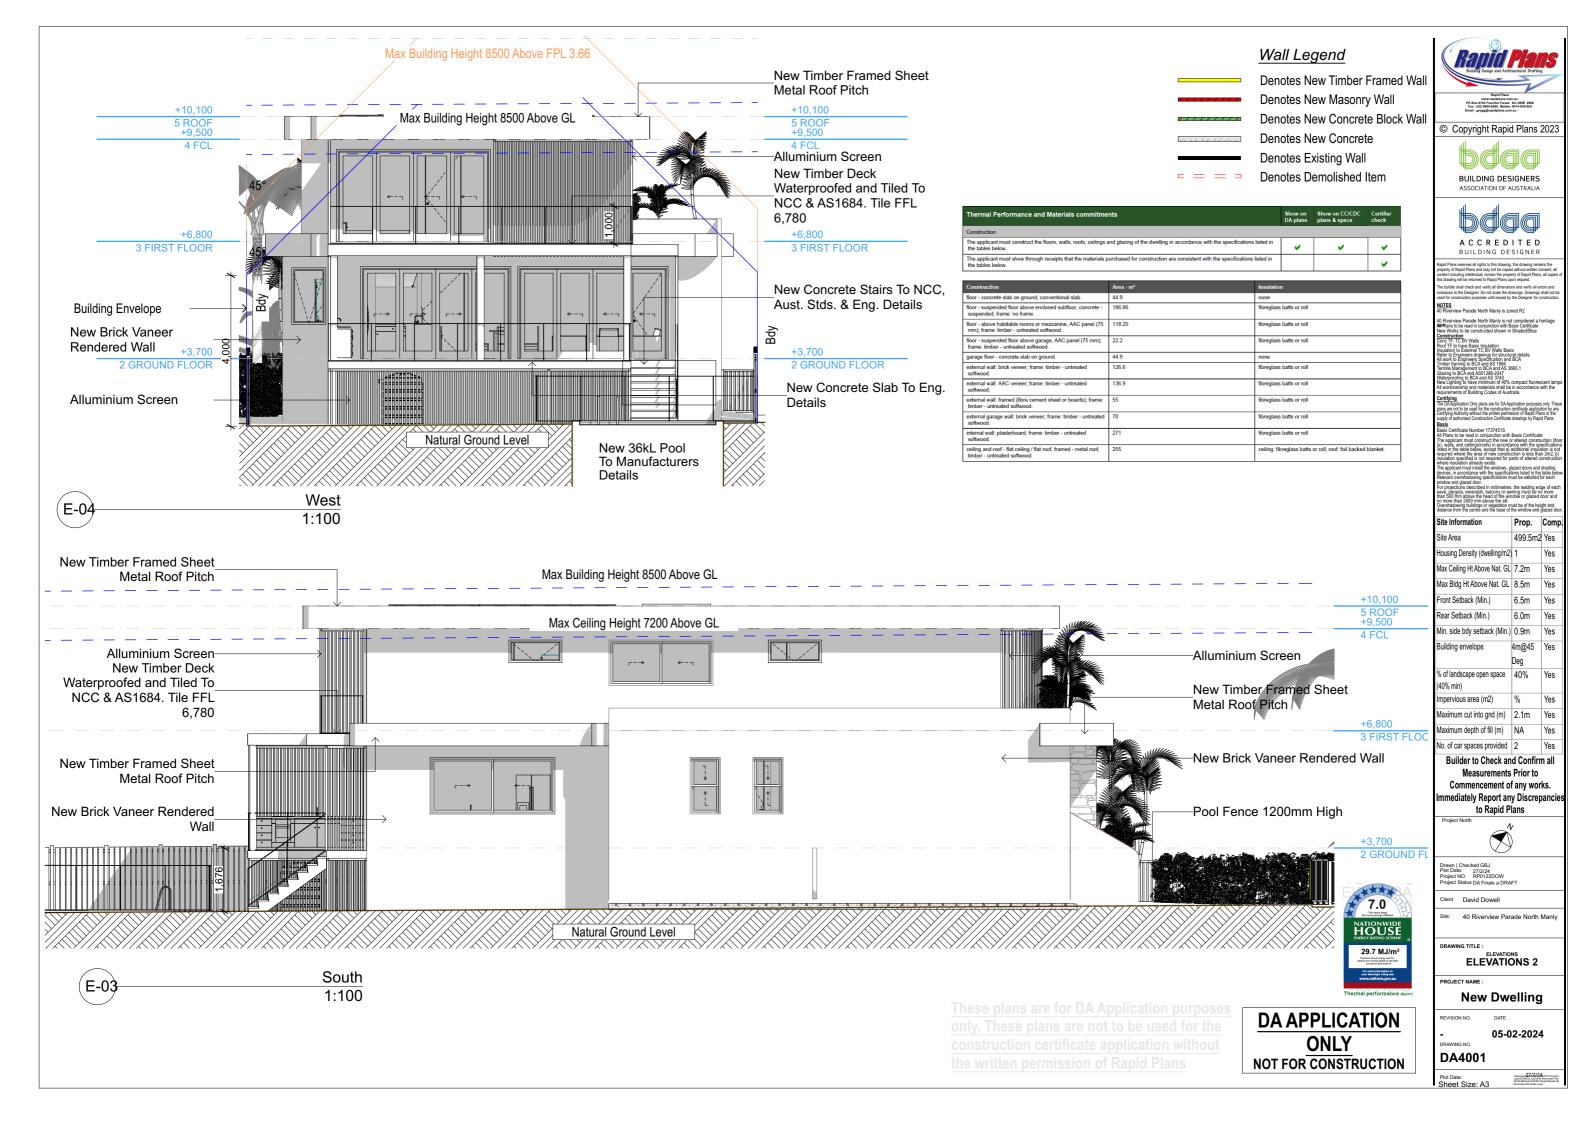**Denotes New Timber Framed Wall** Denotes New Masonry Wall Denotes New Concrete Block Wall

Denotes Demolished Item







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HOUSE

29.7 MJ/m



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499.5m2 Yes Max Ceiling Ht Above Nat. GL 7.2m ront Setback (Min.) 6.5m 6.0m Yes Rear Setback (Min.) Min. side bdy setback (Min.) 0.9m 4m@45 % of landscape open space 40% (40% min) mpervious area (m2) No. of car spaces provided 2

**Builder to Check and Confirm all** Measurements Prior to Commencement of any works. nmediately Report any Discrepancie



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nt David Dowell

ELEVATION FRONT FENCE

**New Dwelling** 

05-02-2024





Denotes Vertical Alloy Handrail Typical. Owner To Confirm Colour & Type







Denotes Alloy Doors Typical. Owner To Confirm Colour & Type



Denotes Alloy Roof Typical. Owner To Confirm Colour & Type



Denotes Garage Door Typical. Owner To Confirm Colour & Type



**Denotes Screens and House** Battens, Typical. Owner To

Confirm Colour & Type

Concrete and Tiled Deck. Owner

To Confirm Colour & Type




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nediately Report any Discrepanci to Rapid Plans MATERIAL & COLOUR SAMPLE BOARD

**New Dwelling** 

05-02-2024



Shadow 21-June 9am 1:200
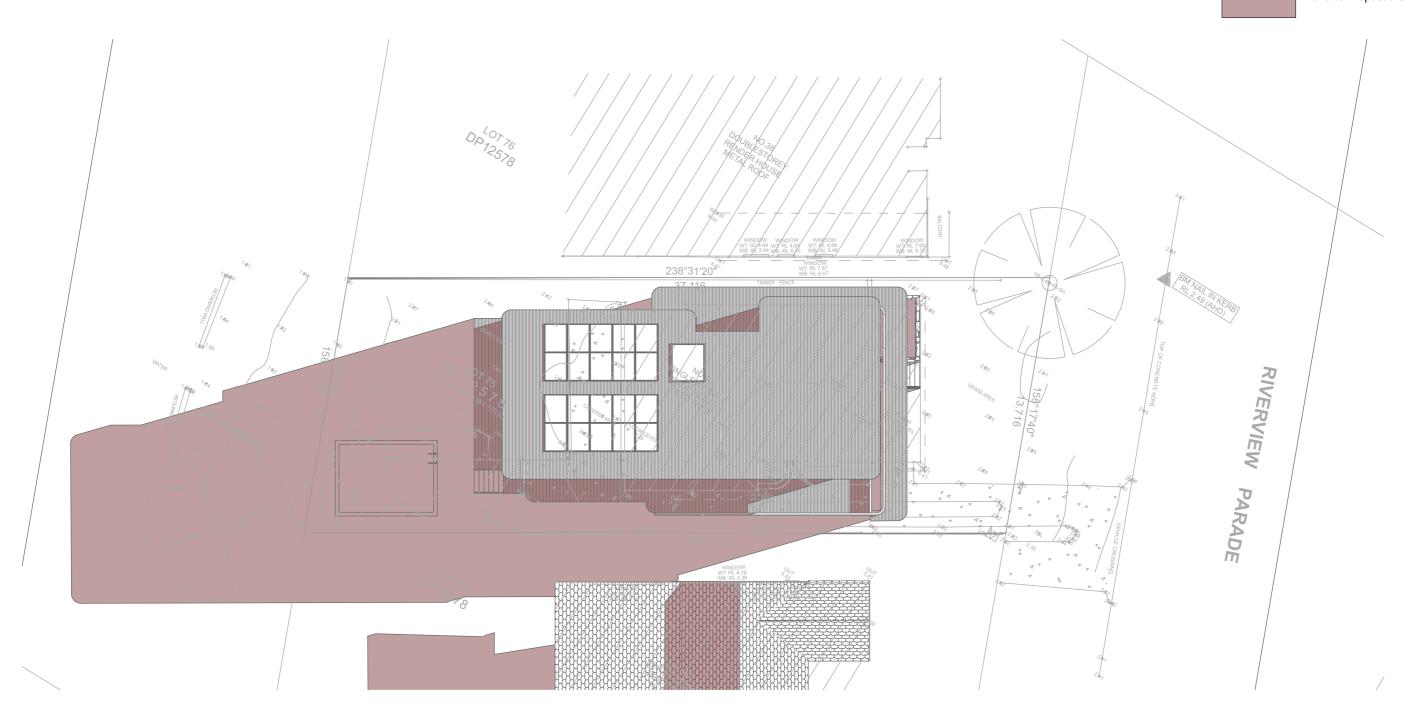
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ontent including
per property of Rapid
its drawing will be
ans upon request.

ASSOCIATION OF AUSTRALIA








GBJ 27/2/24 RP0122DOW DA Finals a DRAFT

David Dowell 40 Riverview Parade North

DRAWING TITLE : SHADOW PLAN 21st June 9am

PROJECT NAME : **New Dwelling** 

DATE. **05-02-2024** DRAWING NO. DA5001

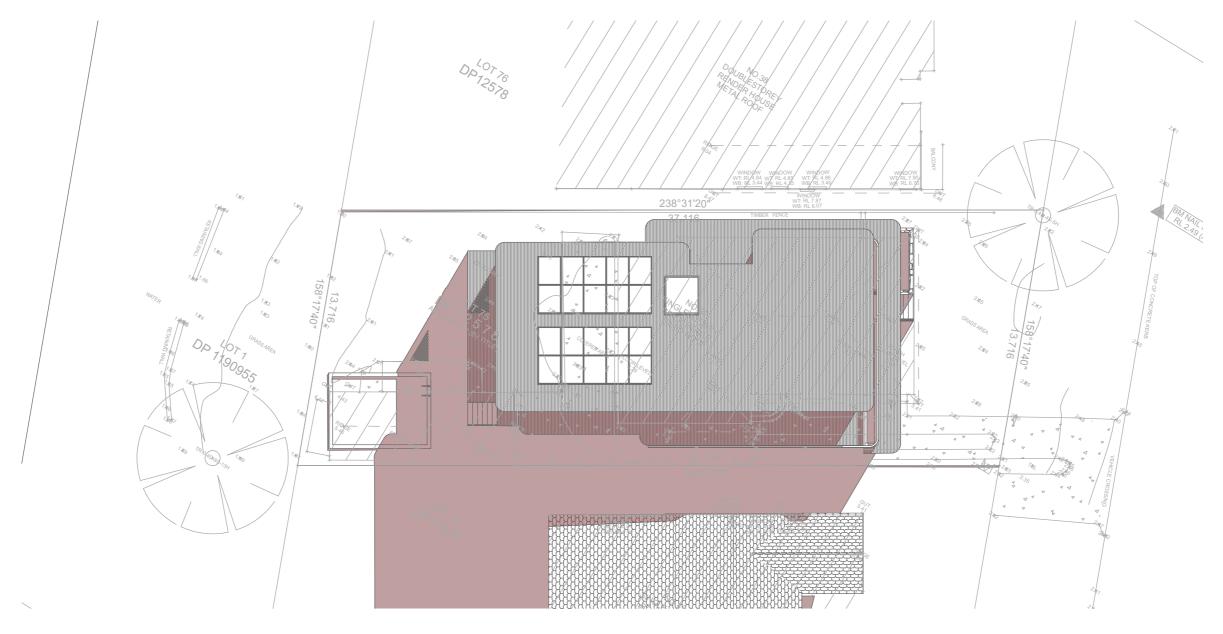

Shadow 21-June 12pm 1:200

### DA APPLICATION ONLY NOT FOR CONSTRUCTION











GBJ 27/2/24 RP0122DOW DA Finals a DRAFT


David Dowell 40 Riverview Parade North

DRAWING TITLE :

PROJECT NAME :

SHADOW PLAN 21st June 12pm **New Dwelling** 

DATE. **05-02-2024** DRAWING NO.

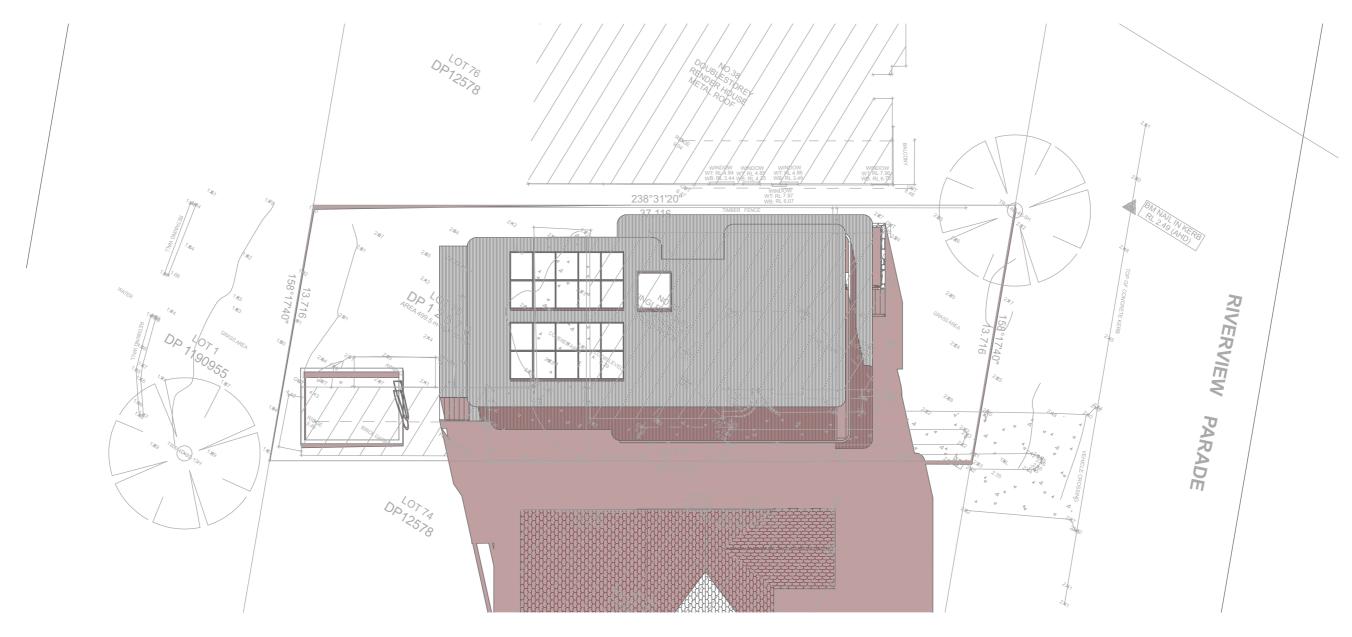

Shadow 21- June 3pm 1:200

> DA APPLICATION ONLY NOT FOR CONSTRUCTION



property of Rapid is drawing will be ns upon request.

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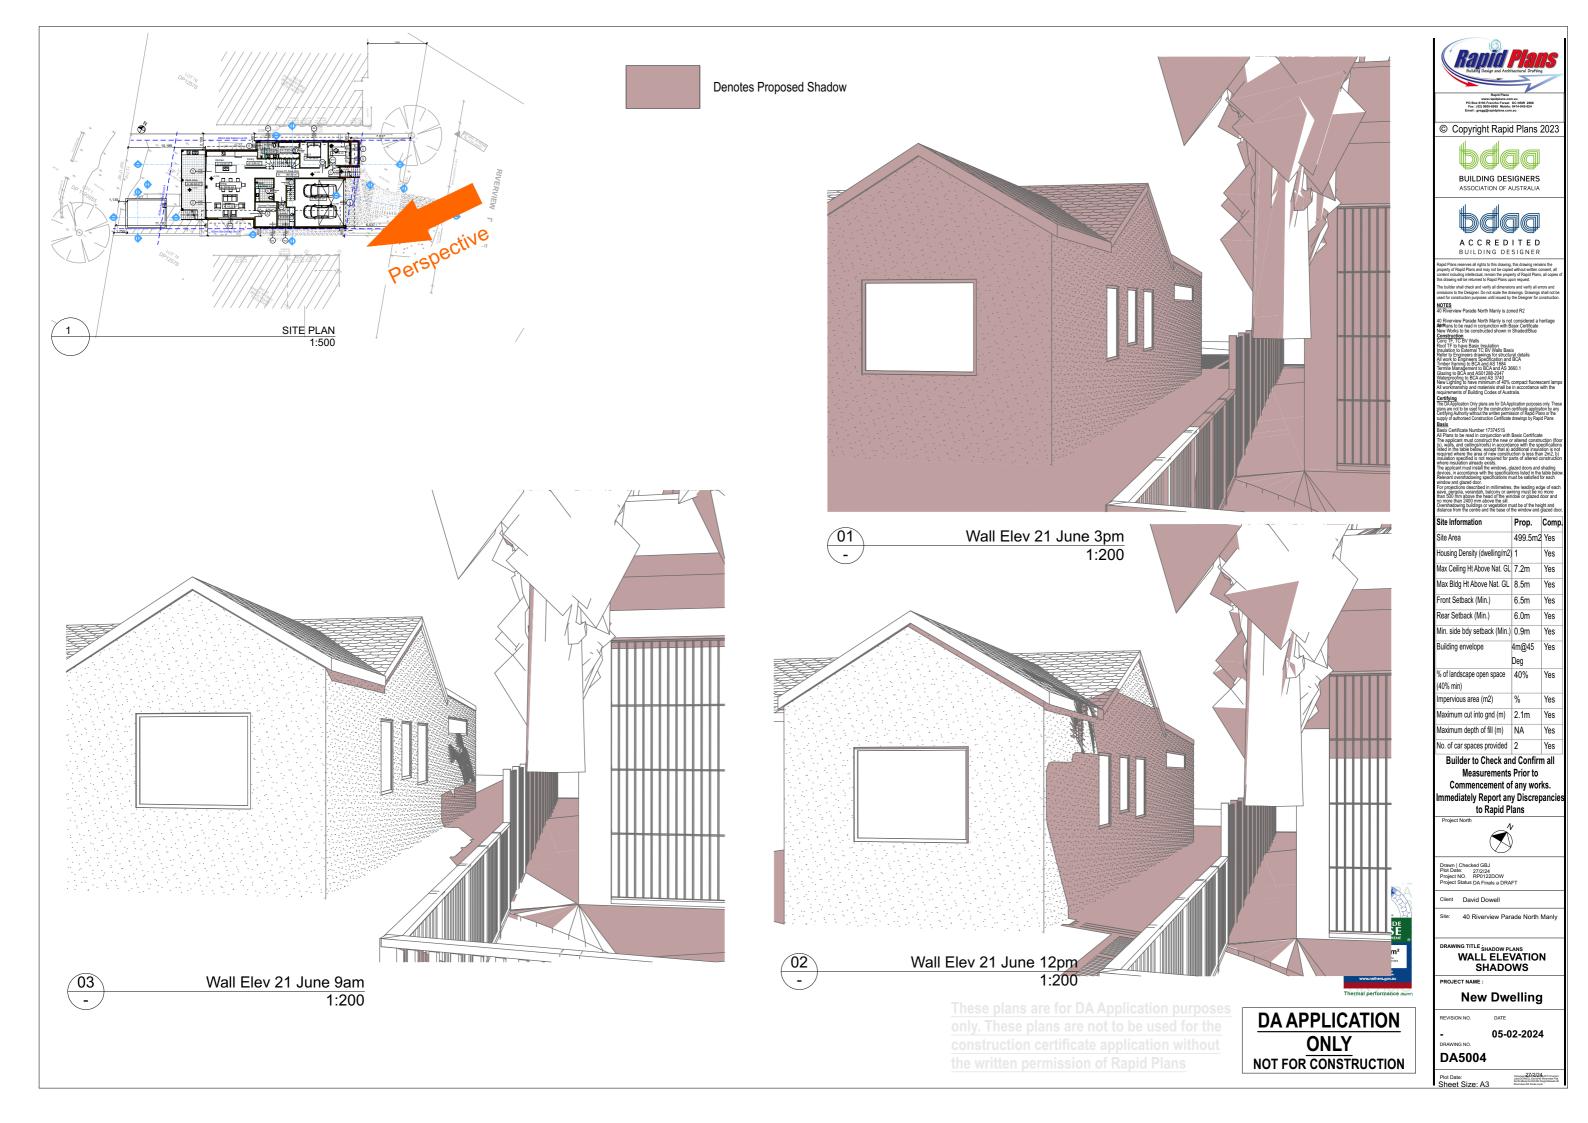
GBJ 27/2/24 RP0122DOW DA Finals a DRAFT

David Dowell 40 Riverview Parade North


DRAWING TITLE :

SHADOW PLAN 21st June 3pm

PROJECT NAME : **New Dwelling**  DATE. **05-02-2024** DRAWING NO.





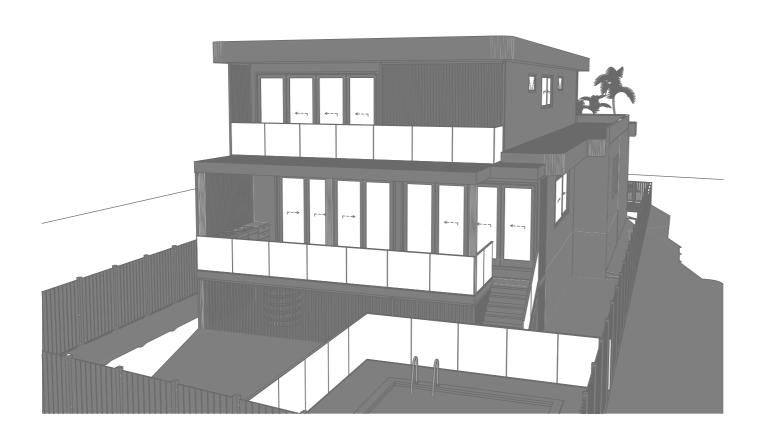



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BUILDING DESIGNERS
ASSOCIATION OF AUSTRALIA



distance from the centre and the base of	the window and	lazed door,
Site Information	Prop.	Comp.
Site Area	499.5m2	Yes
Housing Density (dwelling/m2)	1	Yes
Max Ceiling Ht Above Nat. GL	7.2m	Yes
Max Bldg Ht Above Nat. GL	8.5m	Yes
Front Setback (Min.)	6.5m	Yes
Rear Setback (Min.)	6.0m	Yes
Min. side bdy setback (Min.)	0.9m	Yes
Building envelope	4m@45	Yes
	Deg	
% of landscape open space	40%	Yes
(40% min)		
Impervious area (m2)	%	Yes
Maximum cut into gnd (m)	2.1m	Yes
Maximum depth of fill (m)	NA	Yes
No. of car spaces provided	2	Yes

Builder to Check and Confirm all Measurements Prior to Commencement of any works. mmediately Report any Discrepancie to Rapid Plans

Drawn | Checked GBJ Plot Date: 27/2/24 Project NO. RP0122DOW Project Status DA Finals a Di

ent David Dowell

DRAWING TITLE :

SHADOW PLANS PERSPECTIVE

New Dwelling

05-02-2024

DA5005

Archiment 27/2/24 UW11/Current Jobs DOWELL David-10 Riverview Pde North Marty/ArchicAD Dwyts/Dowell-10 Riverview-DA Finals a.pln



#### Single Dwelling

Certificate number: 1737451S

This certificate confirms that the proposed development will meet the NSW government's requirements for sustainability, if it is built in accordance with the commitments set out below. Terms used in this certificate, or in the commitments, have the meaning given by the document entitled "BASIX Definitions" dated 10/09/2020 published by the Department. This document is available at

Secretary
Date of issue: Monday, 26 February 2024
To be valid, this certificate must be lodged within 3 months of the date of issue.



Project name	Dowell	
Street address	40 RIVERVIEW Parade NOR	TH MANLY 2100
Local Government Area	Northern Beaches Council	
Plan type and plan number	Deposited Plan DP12578	
Lot no.	75	
Section no.	-	
Project type	dwelling house (detached)	
No. of bedrooms	5	
Project score		
Water	<b>✓</b> 40	Target 40
Thermal Performance	✓ Pass	Target Pass
Energy	<b>✓</b> 93	Target 72
Materials	<b>✓</b> -100	Target n/a

Certificate Prepared by
Name / Company Name: RAPID PLANS PTY LTD
ABN (if applicable): 43150064592

#### **Description of project**

Project address	
Project name	Dowell
Street address	40 RIVERVIEW Parade NORTH MANLY 2100
Local Government Area	Northern Beaches Council
Plan type and plan number	Deposited Plan DP12578
Lot no.	75
Section no.	-
Project type	
Project type	dwelling house (detached)
No. of bedrooms	5
Site details	
Site area (m²)	500
Roof area (m²)	254
Conditioned floor area (m²)	236.0
Unconditioned floor area (m²)	14.4
Total area of garden and lawn (m²)	180
Roof area of the existing dwelling (m²)	0

Assessor details and ther	mal loads	
Assessor number	100970	
Certificate number	#HR-H3IGEL-03	
Climate zone	56	
Area adjusted cooling load (MJ/ m².year)	10	
Area adjusted heating load (MJ/ m².year)	20	
Project score		
Water	<b>✓</b> 40	Target 40
Thermal Performance	✓ Pass	Target Pass
Energy	<b>✓</b> 93	Target 72
Materials	<b>✓</b> -100	Target n/a

#### Schedule of BASIX commitments

The commitments set out below regulate how the proposed development is to be carried out. It is a condition of any development consent granted, or complying development certificate issued, for the proposed development, that BASIX commitments be complied with.

Water Commitments	Show on DA plans	Show on CC/CDC plans & specs	Certifier check
Landscape			
The applicant must plant indigenous or low water use species of vegetation throughout 100 square metres of the site.	~	~	
Fixtures			
The applicant must install showerheads with a minimum rating of 4 star (> 4.5 but <= 6 U/min plus spray force and/or coverage tests) is all showers in the development.	n	~	~
The applicant must install a toilet flushing system with a minimum rating of 5 star in each toilet in the development.		~	~
The applicant must install taps with a minimum rating of 5 star in the kitchen in the development.		~	
The applicant must install basin taps with a minimum rating of 5 star in each bathroom in the development.		~	
Alternative water			
Rainwater tank			
The applicant must install a rainwater tank of at least 4000 litres on the site. This rainwater tank must meet, and be installed in accordance with, the requirements of all applicable regulatory authorities.	~	~	~
The applicant must configure the rainwater tank to collect rain runoff from at least 170 square metres of the roof area of the development (excluding the area of the roof which drains to any stormwater tank or private dam).		~	~
The applicant must connect the rainwater tank to:			
<ul> <li>at least one outdoor tap in the development (Note: NSW Health does not recommend that rainwater be used for human consumption in areas with potable water supply.)</li> </ul>		<b>~</b>	-
a tap that is located within 10 metres of the swimming pool in the development		-	-
Water Commitments	Show on DA plans	Show on CC/CDC plans & specs	Certifier check
Swimming Pool			
The swimming pool must not have a volume greater than 36 kilolitres.	~	~	
The swimming pool must be outdoors.			

Thermal Performance and Materials commitments	Show on DA plans	Show on CC/CDC plans & specs	Certifier check
Simulation Method			
Assessor details and thermal loads			
The applicant must attach the certificate referred to under "Assessor Details" on the front page of this BASIX certificate (the "Assessor Certificate") to the development application and construction certificate application for the proposed development (or, if the applicant is applying for a complying development certificate for the proposed development, to that applicant). The applicant must also attach the Assessor Certificate to the application for an occupation certificate for the proposed development.			
The Assessor Certificate must have been issued by an Accredited Assessor in accordance with the Thermal Comfort Protocol.			
The details of the proposed development on the Assessor Certificate must be consistent with the details shown in this BASIX certificate, including the Cooling and Heating loads shown on the front page of this certificate and the "Construction" and "Glazing" tables below.			
The applicant must show on the plans accompanying the development application for the proposed development, all matters which the Assessor Certificate requires to be shown on those plans. Those plans must bear a stamp of endorsement from the Accredited Assessor to certify that this is the case. The applicant must show on the plans accompanying the application for a construction certificate (or complying development certificate, if applicable), all thermal performance specifications set out in the Assessor Certificate, and all aspects of the proposed development which were used to calculate those specifications.	~	~	~
The applicant must construct the development in accordance with all thermal performance specifications set out in the Assessor Certificate, and in accordance with those aspects of the development application or application for a complying development certificate which were used to calculate those specifications.		~	~
The applicant must show on the plans accompanying the development application for the proposed development, the locations of ceiling fans set out in the Assessor Certificate. The applicant must show on the plans accompanying the application for a construction certificate (or combying development certificate, if applicable), the locations of ceiling fans set out in the Assessor Certificate.	~	~	~

Thermal Performance and Materials commitments	Show on DA plans	Show on CC/CDC plans & specs	Certifier check
Construction			
The applicant must construct the floors, walls, roofs, ceilings and glazing of the dwelling in accordance with the specifications listed in the tables below.	~	~	~
The applicant must show through receipts that the materials purchased for construction are consistent with the specifications listed in the tables below.			~


Construction	Area - m²	Insulation
floor - concrete slab on ground, conventional slab.	44.9	none
floor - suspended floor above enclosed subfloor, concrete - suspended; frame: no frame.	186.86	fibreglass batts or roll
floor - above habitable rooms or mezzanine, AAC panel (75 mm); frame: timber - untreated softwood	118.25	fibreglass batts or roll
floor - suspended floor above garage, AAC panel (75 mm); frame: timber - untreated softwood.	22.2	fibreglass batts or roll
garage floor - concrete slab on ground.	44.9	none
external wall: brick veneer; frame: timber - untreated softwood.	126.6	fibreglass batts or roll
external wall: AAC veneer; frame: timber - untreated softwood.	136.9	fibreglass batts or roll
external wall: framed (fibre cement sheet or boards); frame: timber - untreated softwood.	55	fibreglass batts or roll
external garage wall: brick veneer; frame: timber - untreated softwood.	70	fibreglass batts or roll
internal wall: plasterboard; frame: timber - untreated softwood.	271	fibreglass batts or roll
ceiling and roof - flat ceiling / flat roof, framed - metal roof, timber - untreated softwood.	255	ceiling: fibreglass batts or roll; roof: foil backed blanket.

Thermal Performance and Materials commitments	Show on DA plans	Show on CC/CDC plans & specs	Certifier check
Glazing			
The applicant must install windows, glazed doors and skylights as described in the table below, in accordance with the specifications listed in the table.	~	<	~

Frames	Maximum area - m2
aluminium	75.2
timber	0
uPVC	0
steel	0
composite	0

Glazing	Maximum area - m2
single	0
double	75.2
triple	0

Energy Commitments	Show on DA plans	Show on CC/CDC plans & specs	Certifier check
Hot water			
The applicant must install the following hot water system in the development, or a system with a higher energy rating: electric boosted solar with a performance of 26 to 30 STCs or better.	~	~	~
Cooling system			
The applicant must install the following cooling system, or a system with a higher energy rating, in at least 1 living area: 1-phase airconditioning - ducted; Energy rating: 5 star (average zone)		~	~
The applicant must install the following cooling system, or a system with a higher energy rating, in at least 1 bedroom: 1-phase airconditioning - ducted; Energy rating: 5 star (average zone)		~	~
Heating system			
The applicant must install the following heating system, or a system with a higher energy rating, in at least 1 living area: 1-phase airconditioning - ducted; Energy rating: 5 star (average zone)		~	~
The applicant must install the following heating system, or a system with a higher energy rating, in at least 1 bedroom: 1-phase airconditioning - ducted; Energy rating: 5 star (average zone)		~	~
Ventilation			
The applicant must install the following exhaust systems in the development:	T		T
At least 1 Bathroom: individual fan, ducted to façade or roof; Operation control: manual switch on/off		_	-
Kitchen: individual fan, ducted to façade or roof; Operation control: manual switch on/off		_	-
Laundry: individual fan, ducted to façade or roof; Operation control: manual switch on/off		-	-
Artificial lighting			
The applicant must ensure that a minimum of 80% of light fixtures are fitted with fluorescent, compact fluorescent, or light-emitting-diode (LED) lamps.		~	~
Natural lighting			
The applicant must install a window and/or skylight in the kitchen of the dwelling for natural lighting.	~	~	~

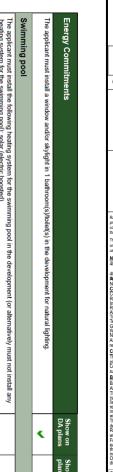



A C C R E D I T E D BUILDING DESIGNER

NOTES 40 Riverview Parade North Manly is zoned R2

40 Riversive Parade North Mary is zoned R2

OR Diversives Parade North Mary is not conditioned a he
ARPhane to be read in conjunction with Basis Certificate
Market Services of the Constitution of the Consti

Prop. Comp 499.5m2 Yes Site Area lousing Density (dwelling/m2) 1 Yes Max Ceiling Ht Above Nat. GL 7.2m Max Bldg Ht Above Nat. GL 8.5m Front Setback (Min.) 6.5m Yes Rear Setback (Min.) 6.0m Yes Min. side bdy setback (Min.) 0.9m Yes Building envelope 4m@45 Yes % of landscape open space 40% Yes (40% min) mpervious area (m2) Maximum cut into gnd (m) 2.1m Yes

**Builder to Check and Confirm all** Measurements Prior to Commencement of any works. Immediately Report any Discrepancies

No. of car spaces provided 2

to Rapid Plans

Drawn | Checked GBJ Plot Date: 27/2/24 Project NO. RP0122DOW Project Status DA Finals a DRAF1

ient David Dowell

7.0

HOUSE

29.7 MJ/m<sup>2</sup>

DA APPLICATION

**ONLY** 

NOT FOR CONSTRUCTION

Site: 40 Riverview Parade North Manly

DRAWING TITLE :

SHADOW PLANS BASIX ROJECT NAME :

**New Dwelling** 

05-02-2024

DA5006

Sheet Size: A3

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