Cover Page 1142 Pittwater Road Collaroy NSW 2097 - Proposed Alterations & Additions



DATA 551.1 m² Site Area **Landscaped Area** Area 198.09 m² **Existing Landscape** 35.94% Minimum Required 220.44 m² 40% 218.02 m² Proposed Landscape 39.56%



LEGEND carpet timber fl tile floor

lobile Recycling Bin	sk	skylight
	rwt	rain water tank
lobile Waste Bin	sa	Smoke alarms and evacuation lighting are to comply with BCA 2022 H3D6.
lobile Green Waste Bin	em	elec. meter
	hw	hot water system
cluded in Floor Space	dp	downpipe
andscape Area	sp	structural post
andocapo / nod	rwo	rainwater outlet
cape Area excluded from area	TOW	top of wall
	TOP	top of parapet
	15.45	existing RL's
flooring		existing structure to be demolished
	WA.01	glazed window and door number for BASIX
ring		existing tree to be retained
		existing tree to be removed

NOTES

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 All discrepancies to be brought to the attention of the author.

Issue	Description	ISSUE BY	Issue Date	
Α	Complyng Development Certificacte	AT/YT/TY	31/7/2024	_
				_
				_
				_

ADDRESS 1142 Pittwater Road Collaroy NSW 2097

PROJECT

Proposed Alterations & Additions

ANAG NSW

JOB No 24007


YAN HONDA ARCHITECTS

REGISTERED ARCHITECT GUS HONDA 9435 DRAWING TITLE **Cover Page**

gravel

DRAWING NUMBER SCALE 1:6.67 DA00 @ A2

ISSUE Α

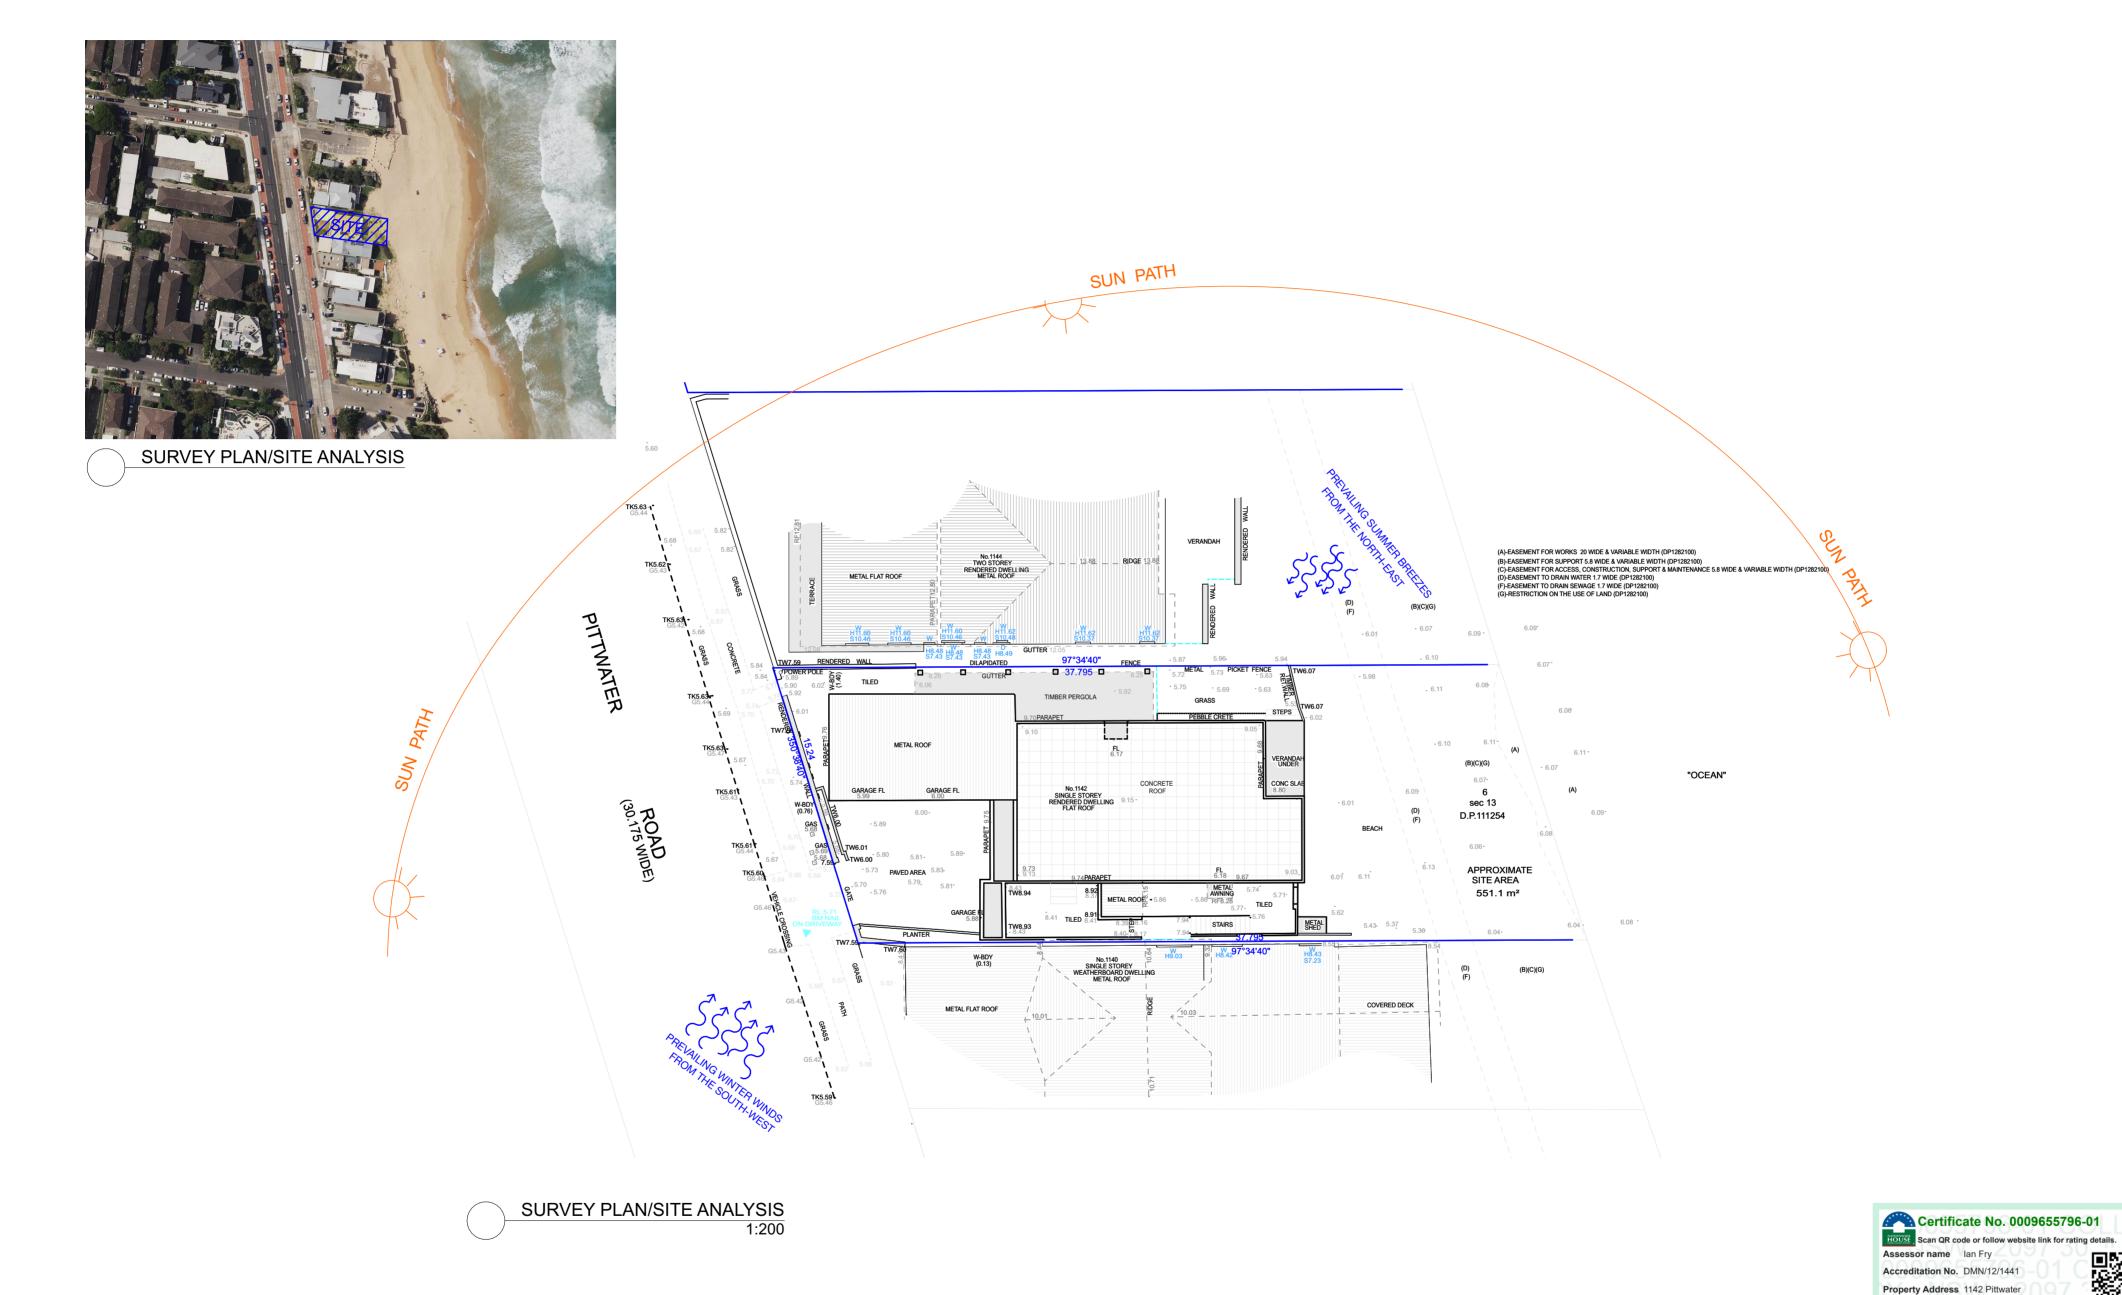



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A	Complyng Development Certificacte	AT/YT/TY	31/7/2024	1 1 1
				1142 Pittwater Road Collaroy NSW 2097
				PROJECT
				Proposed Alterations & Additions
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l				FOR
				ANAG NSW

YAN HONDA ARCHITECTS

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REGISTERED ARCHITECT GUS HONDA 9435 DRAWING TITLE Site Analysis


JOB No

24007

DRAWING NUMBER SCALE 1:200 DA01 @ A2 ISSUE

Α

Road, COLLAROY NSW,2097

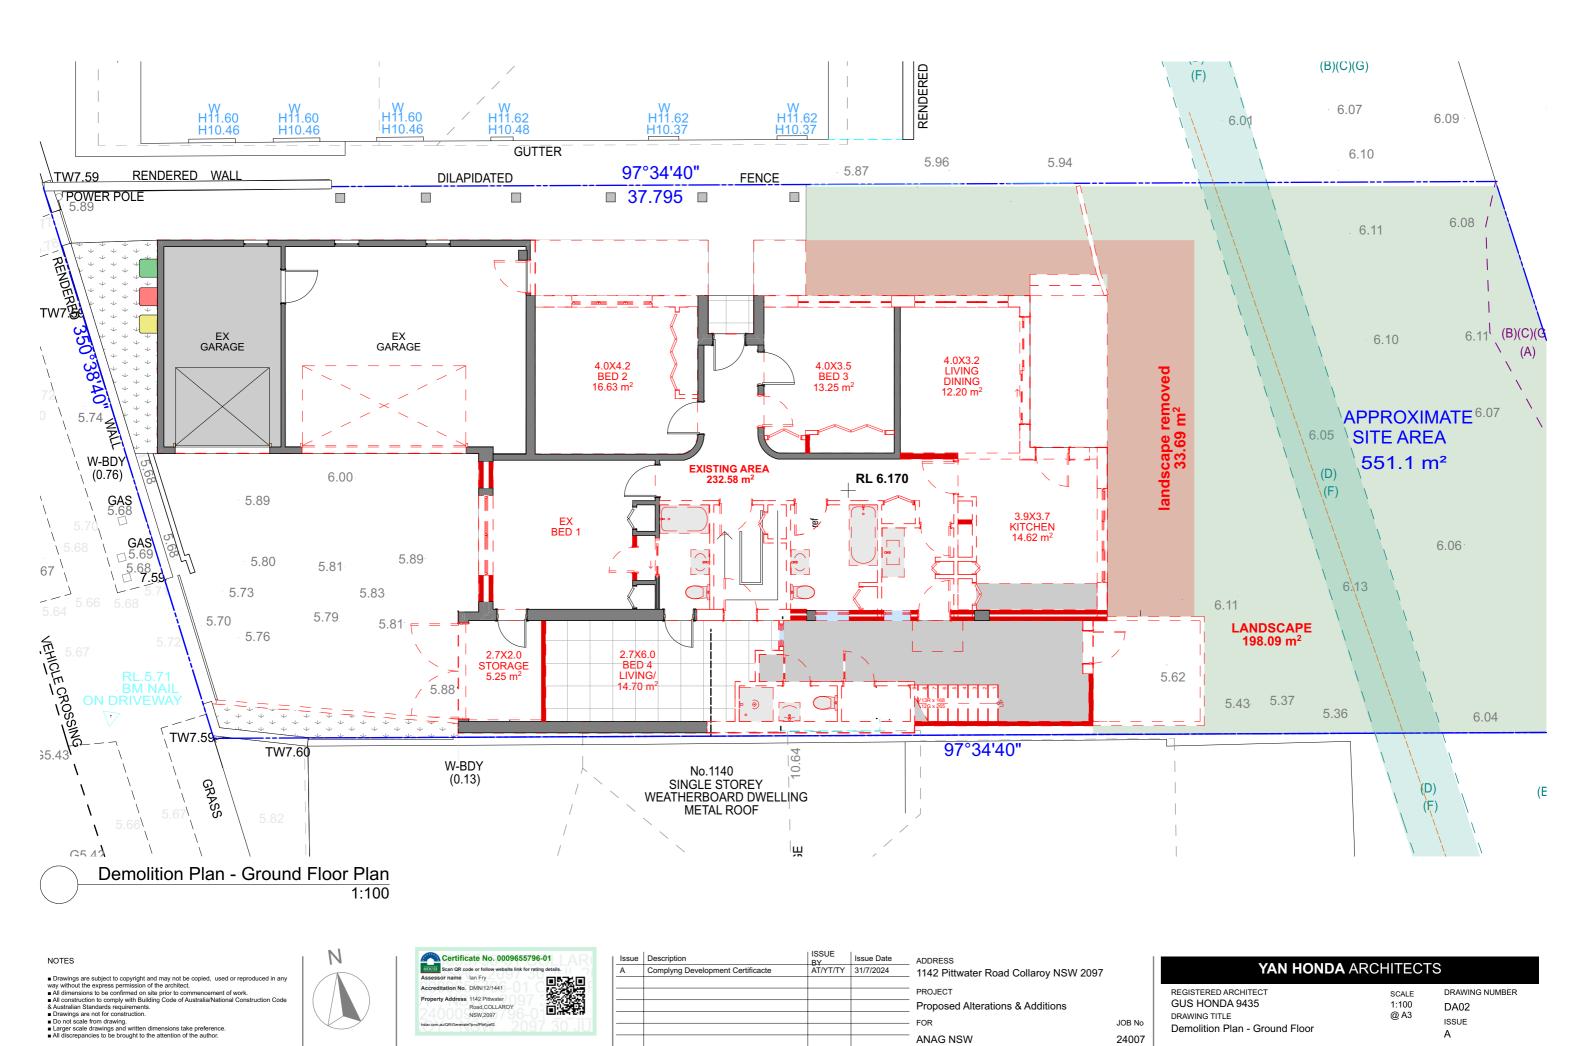

Proposed Alterations & Additions

FOR

ANAG NSW

DRAWING TITLE

Demolition Plan - Ground Floor

JOB No


24007

DA02

ISSUE

Α

@ A3

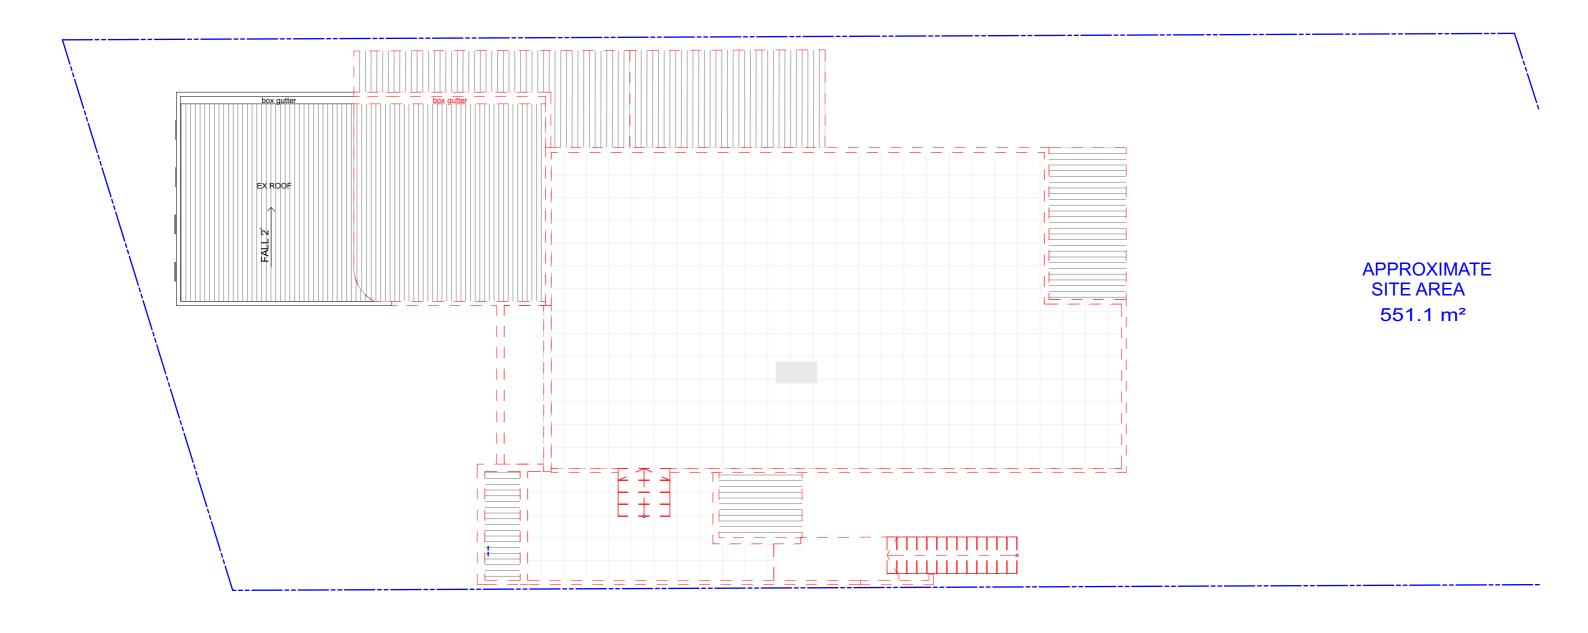



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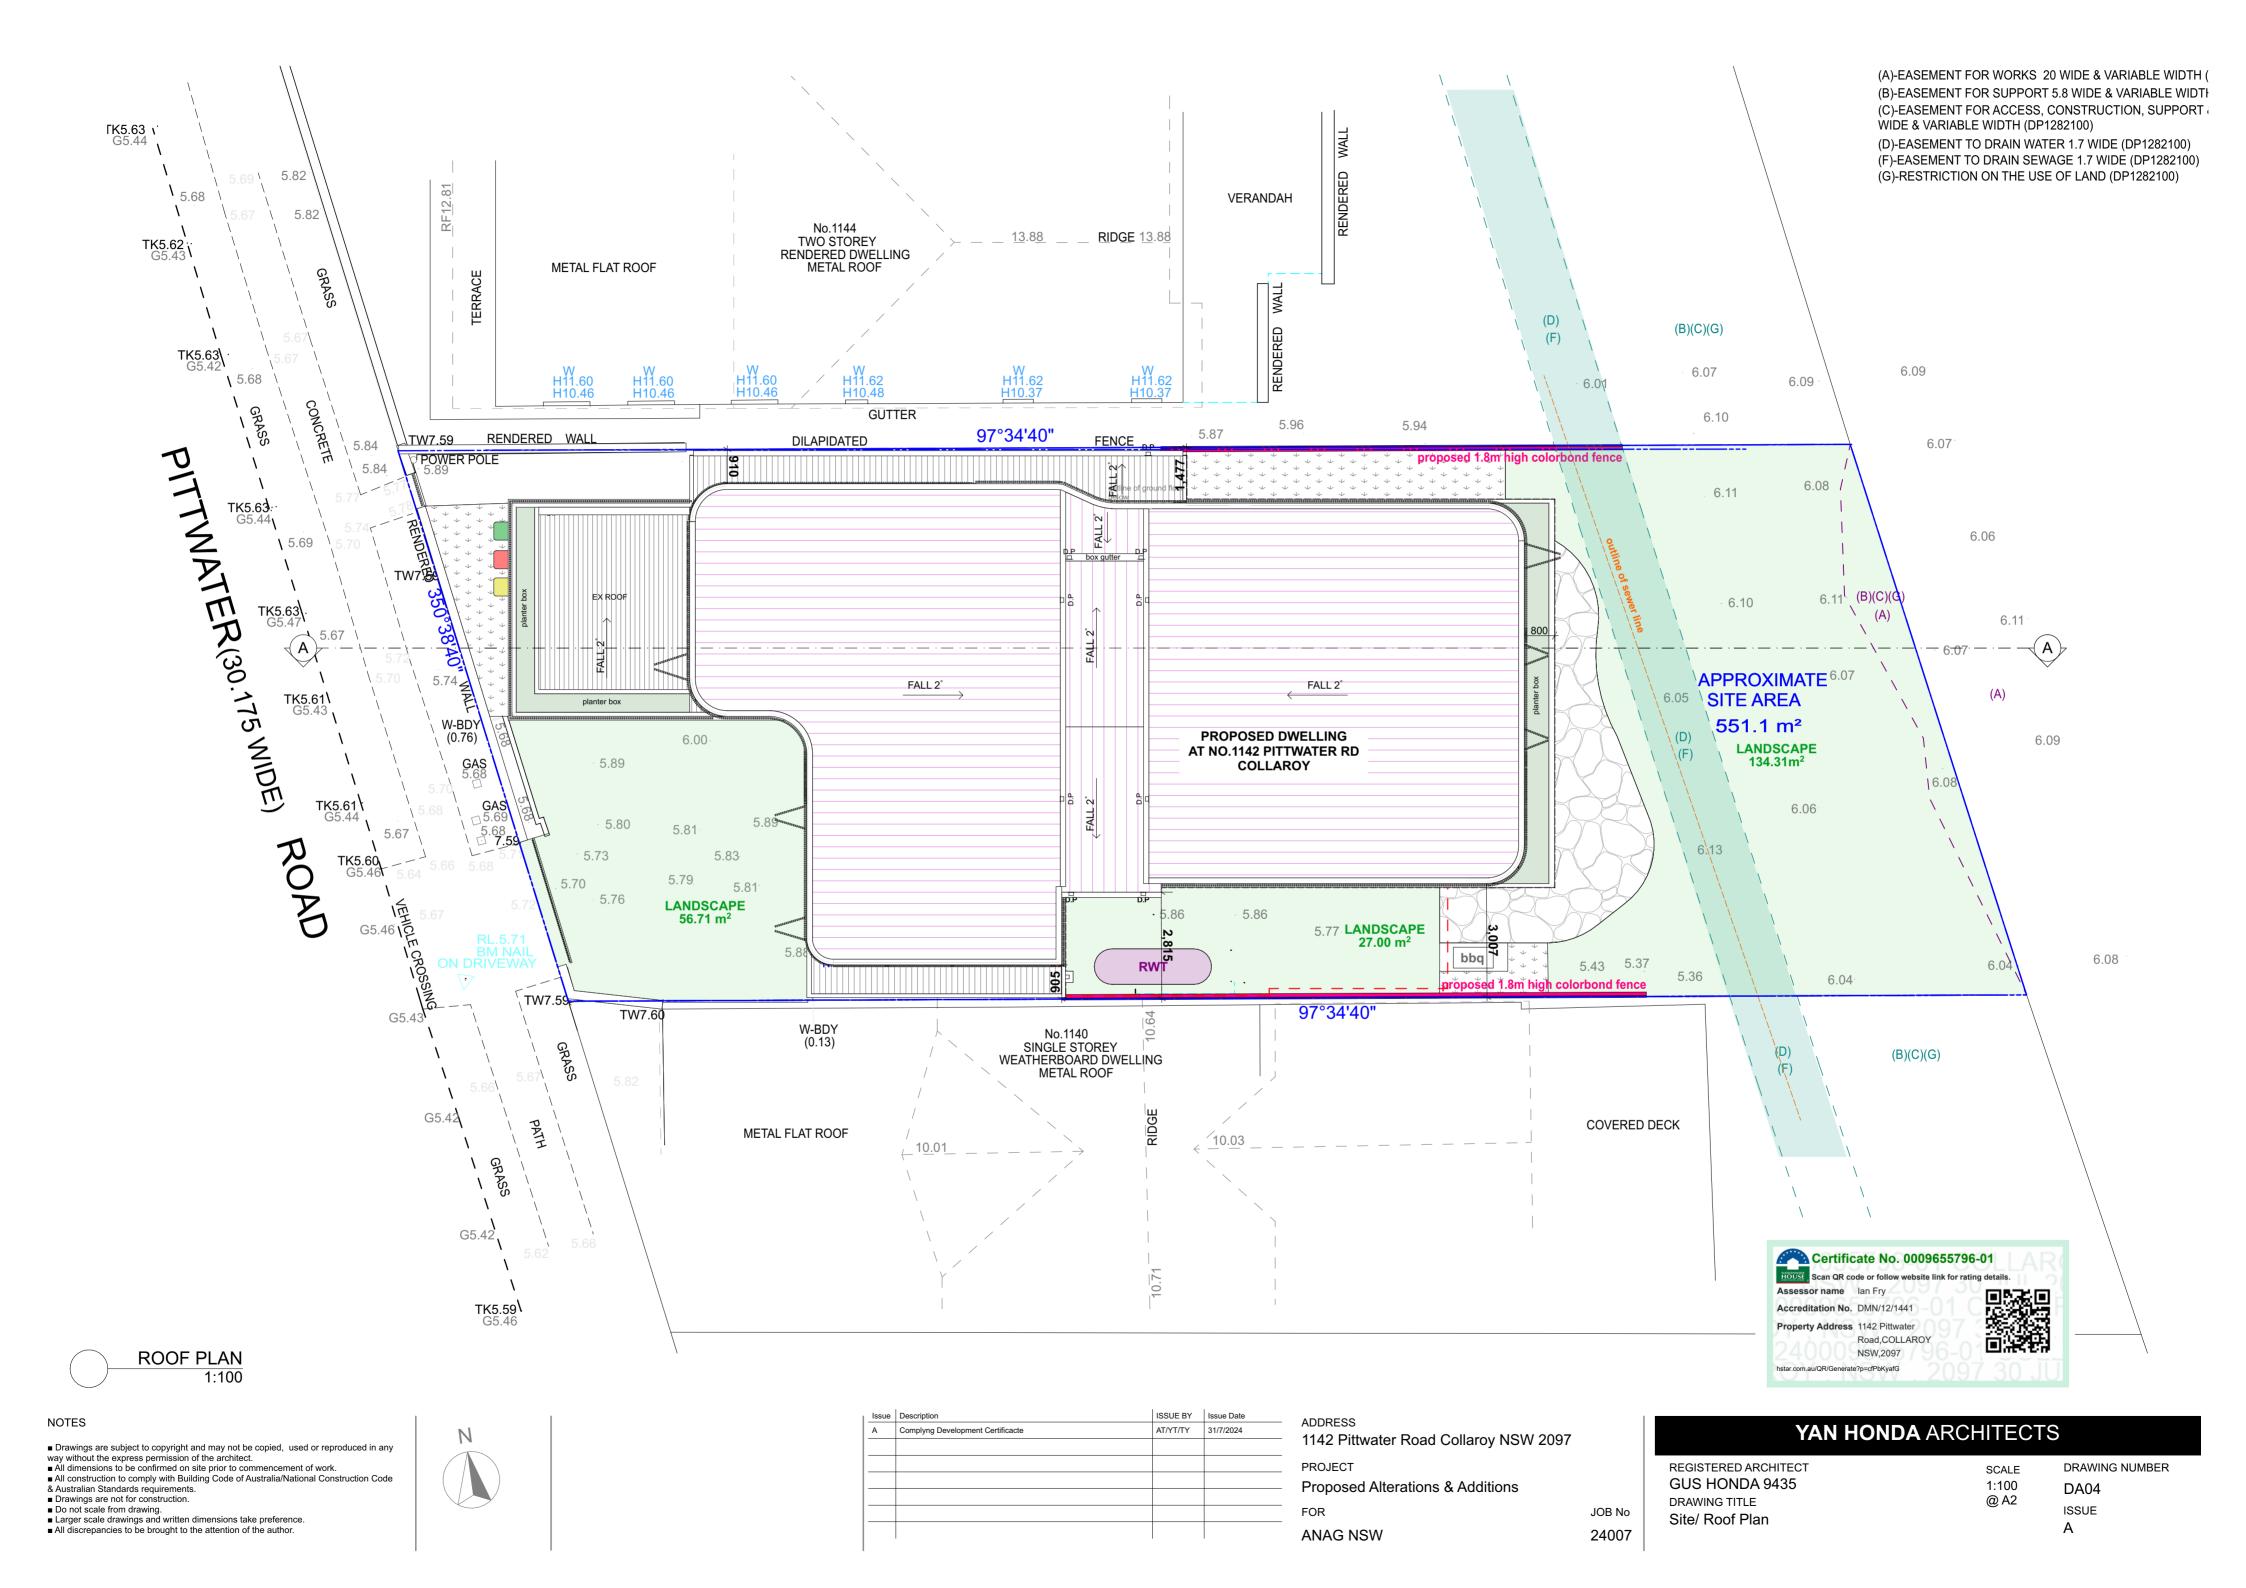
All discrepancies to be brought to the attention of the author.





HOUSE Scan QR co	de or follow website link for	r rating details.
Assessor name	lan Fry	
Accreditation No.	DMN/12/1441	
Property Address	1142 Pittwater Road,COLLAROY NSW,2097	

Issue	Description	ISSUE	Issue Date	ADDRESS	
A	Complyng Development Certificacte	AT/YT/TY	31/7/2024	1142 Pittwater Road Collaroy NSW 2097	
				PROJECT	
				Proposed Alterations & Additions	
				- FOR	JOB No
				ANAG NSW	24007

YAN HONDA	ARCHITECTS	6
REGISTERED ARCHITECT GUS HONDA 9435	SCALE 1:100	DRAWING NUMBER
DRAWING TITLE Demolition Plan - Frist Floor Plan	@ A3	ISSUE
Demolition Flatt - Flist Floor Flatt		Λ.



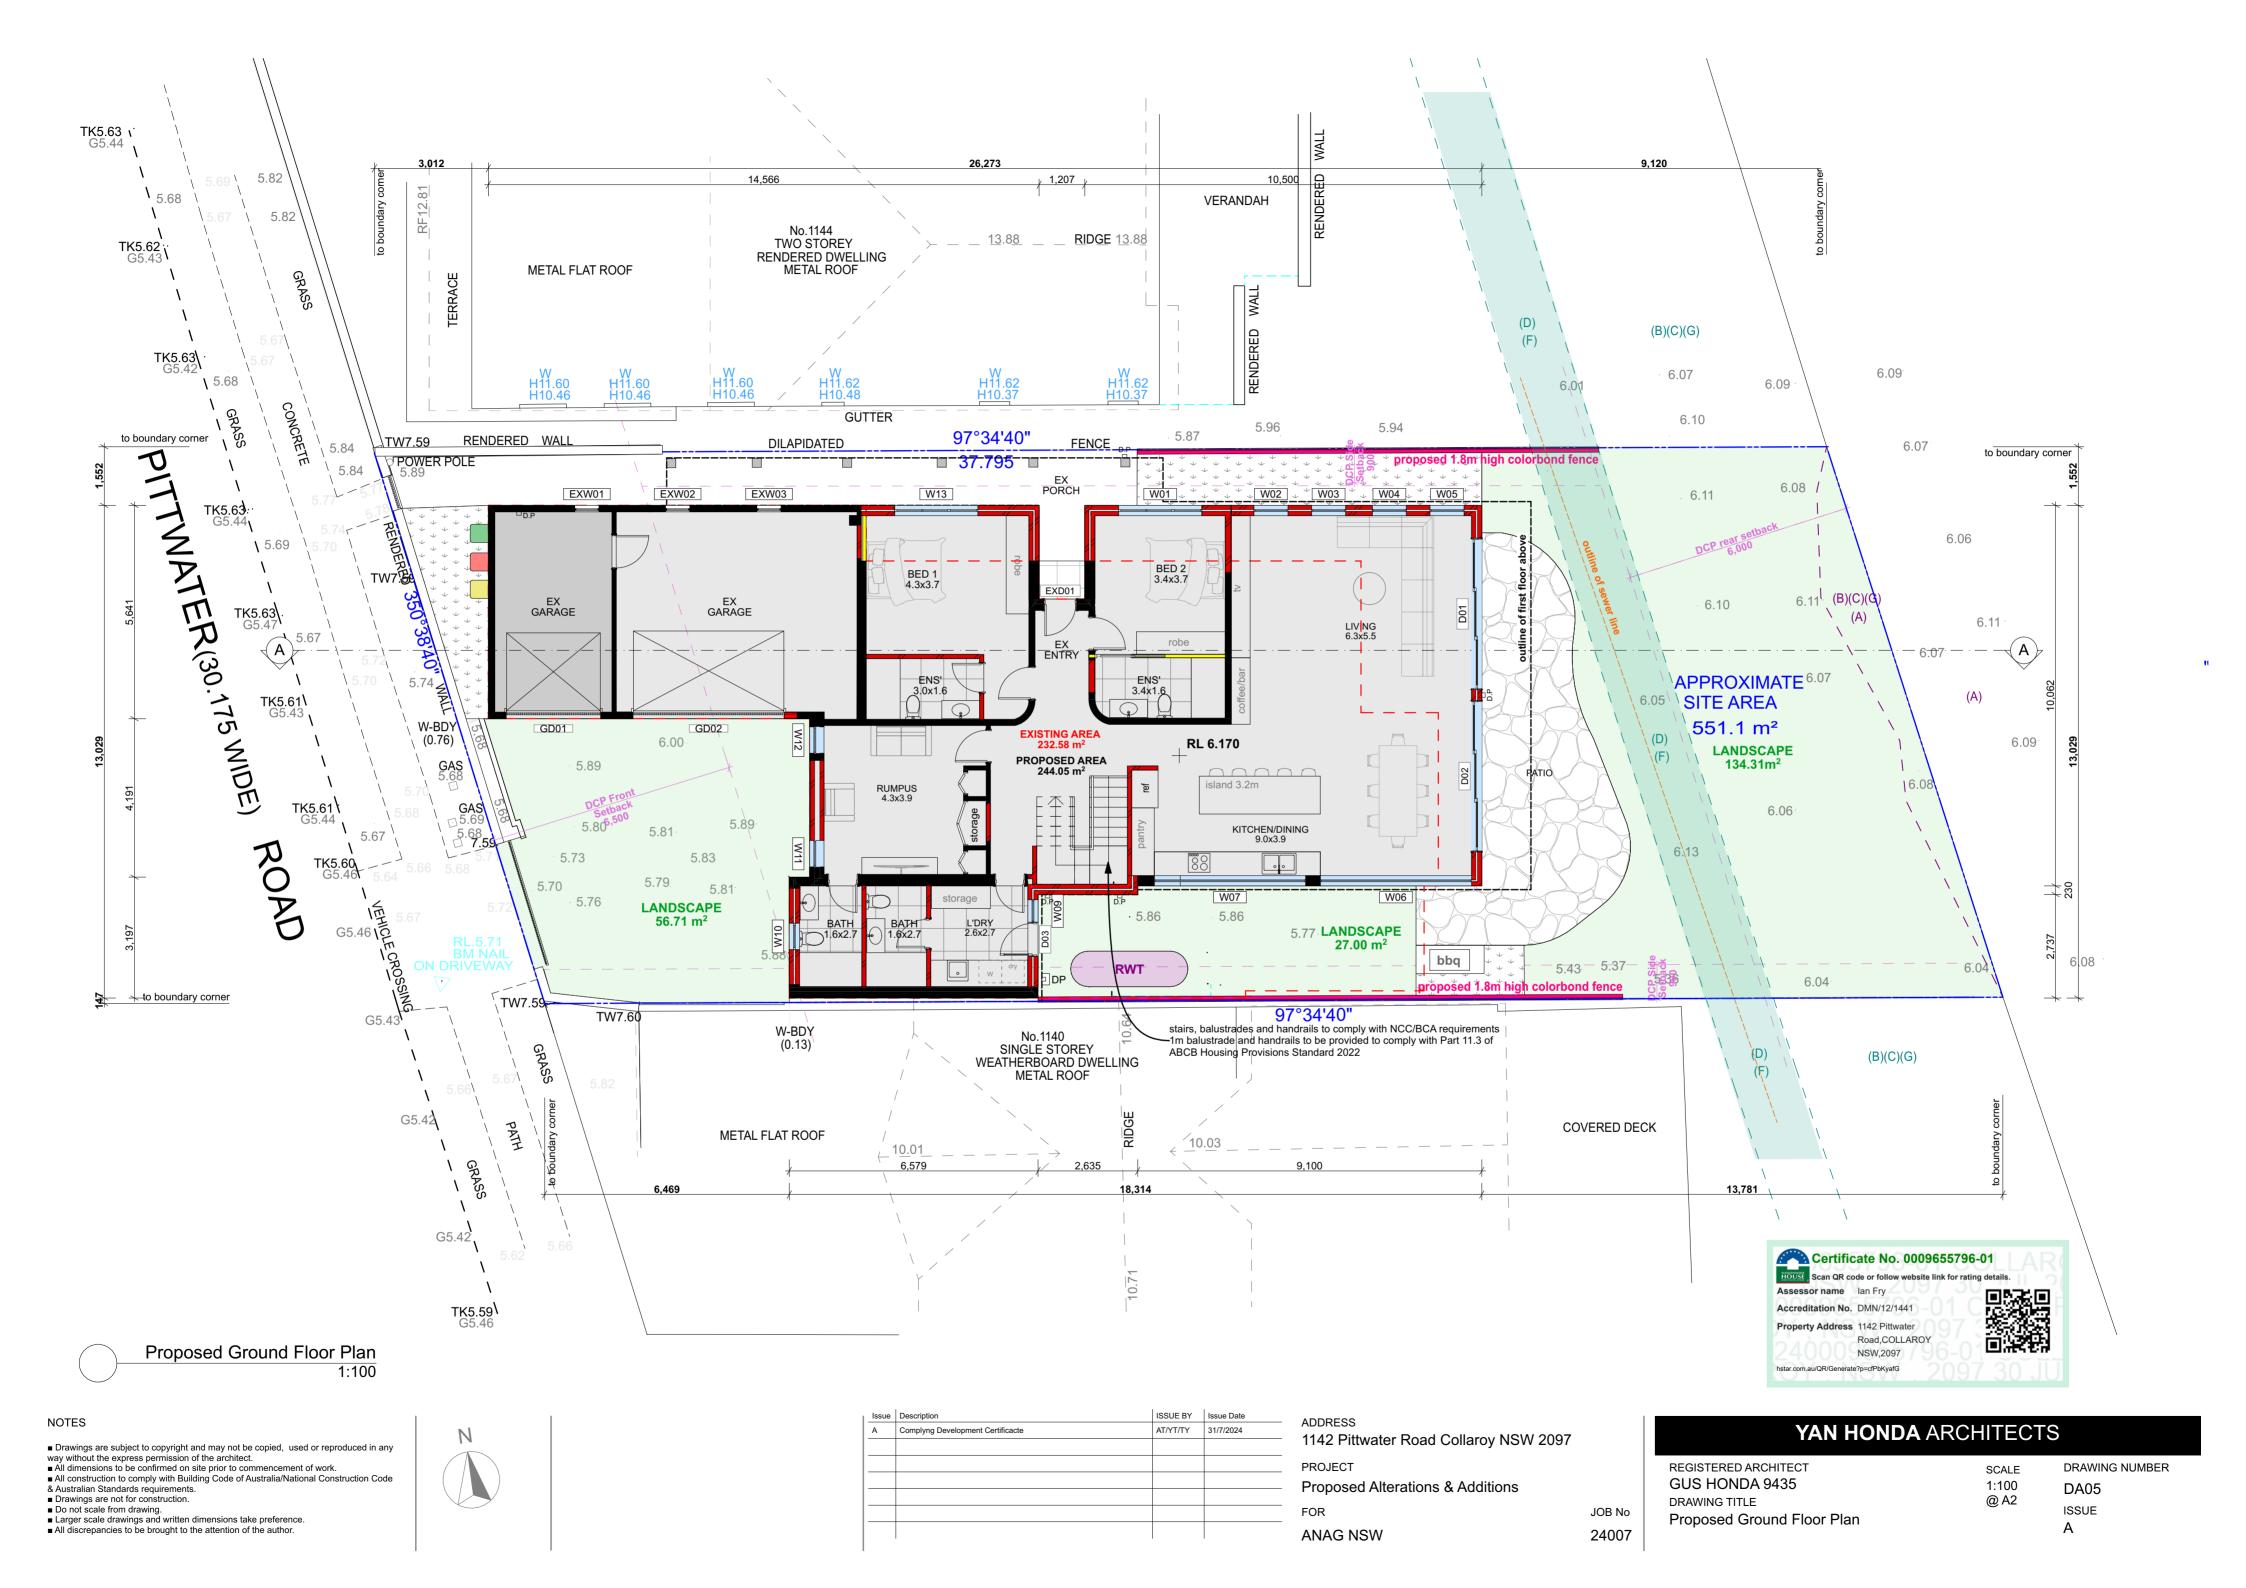

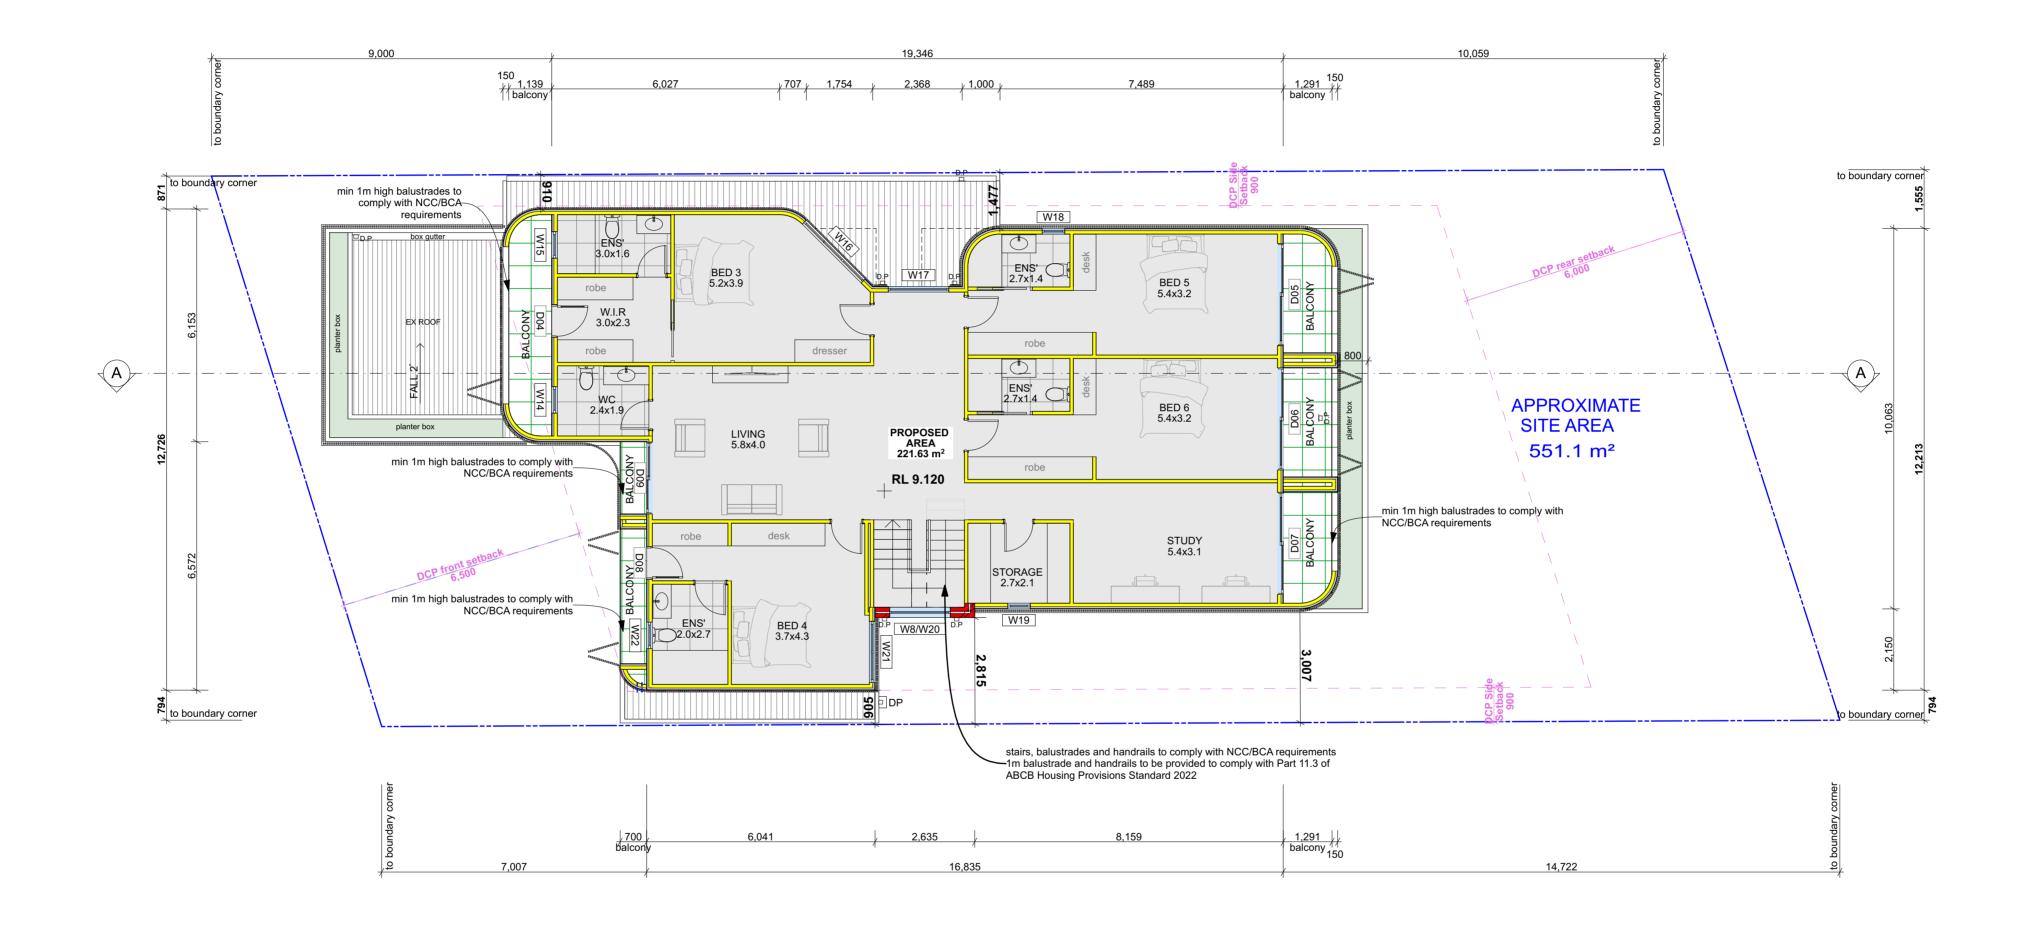





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				1142 Pittwater Road Collaroy NSW 2097
				PROJECT
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				FOR
				ANAG NSW

YAN HONDA ARCHITECTS

REGISTERED ARCHITECT GUS HONDA 9435 DRAWING TITLE Proposed First Floor Plan

JOB No

24007

DRAWING NUMBER SCALE 1:100 DA06 @ A2 ISSUE

Α



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LEGEND

FΒ face brick wall TC Timber cladding **RPW** rendered painted wall AL LV aluminium framed windows and doors

Louvre glass

Α	Complyng Development Certificacte	AT/YT/TY	31/7/2024

-	ADDRESS 1142 Pittwater Road Collaroy NSW 2097	
- - -	PROJECT Proposed Alterations & Additions	
-	FOR	JOB No
_	ANAG NSW	24007

YAN HONDA ARCHITECTS

REGISTERED ARCHITECT GUS HONDA 9435 DRAWING TITLE Elevations

DRAWING NUMBER SCALE 1:100 DA07 @ A2 ISSUE

Α



BASIX

Water Commitments Fixtures The applicant must install showerheads with a minimum rating of 4 star (> 6 but <= 7.5 L/min plus spray force and/or coverage tests) in all showers in the development.

1:100

The applicant must install a toilet flushing system with a minimum rating of 4 star in each toilet in the development

The applicant must install taps with a minimum rating of 4 star in the kitchen in the development.

The applicant must install basin taps with a minimum rating of 4 star in each bathroom in the development.

Alternative water

Rainwater tank

The applicant must install a rainwater tank of at least 2000 litres on the site. This rainwater tank must meet, and be installed in accordance with, the requirements of all applicable regulatory authorities.

The applicant must configure the rainwater tank to collect rain runoff from at least 213.26 square metres of the roof area of the development (excluding the area of the roof which drains to any stormwater tank or private dam)

The applicant must connect the rainwater tank to: the cold water tap that supplies each clothes washer in the development

at least one outdoor tap in the development (Note: NSW Health does not recommend that rainwater be used for human
consumption in areas with potable water supply.)

hermal Performance and Materials commitments

Simulation Method

The applicant must attach the certificate referred to under "Assessor Details" on the front page of this BASIX certificate (the "Assessor Certificate") to the development application and construction certificate application for the proposed development (or, if the applicant is applying for a complying development certificate for the proposed development, to that application). The applicant must also attach the Assessor Certificate to the application for an occupation certificate for the proposed development.

The Assessor Certificate must have been issued by an Accredited Assessor in accordance with the Thermal Comfort Protocol.

The details of the proposed development on the Assessor Certificate must be consistent with the details shown in this BASIX certificate, including the Cooling and Heating loads shown on the front page of this certificate and the "Construction" and "Glazing" tables below.

The applicant must show on the plans accompanying the development application for the proposed development, all matters which the Assessor Certificate requires to be shown on those plans. Those plans must bear a stamp of endorsement from the Accredited Assessor to certify that this is the case. The applicant must show on the plans accompanying the application for a construction certificate (or complying development certificate, if applicable), all thermal performance specifications set out in the Assessor Certificate, and all aspects of the proposed development which were used to calculate those specifications.

The applicant must construct the development in accordance with all thermal performance specifications set out in the Assessor Certificate, and in accordance with those aspects of the development application or application for a complying development certificate which were used to calculate those specifications.

The applicant must show on the plans accompanying the development application for the proposed development, the locations of ceiling fans set out in the Assessor Certificate. The applicant must show on the plans accompanying the application for a construct ceiling fans set out in the Assessor Certificate. The applicant must show on the plans accompanying the application for a cons certificate (or complying development certificate, if applicable), the locations of ceiling fans set out in the Assessor Certificate.

hermal Performance and Materials commitments

enstruct the floors, walls, roofs, ceilings and glazing of the dwelling in accordance with the specifications listed in

The applicant must show through receipts that the materials purchased for construction are consistent with the specifications listed in

Construction	Area - m²	Insulation
floor - concrete slab on ground, conventional slab.	171.3	none
floor - suspended floor above open subfloor, concrete - suspended; frame: no frame.	8.3	fibreglass batts or roll
floor - above habitable rooms or mezzanine, concrete - suspended; frame: no frame	155.9	fibreglass batts or roll
floor - suspended floor above garage, concrete - suspended; frame: no frame.	21.3	fibreglass batts or roll
garage floor - concrete slab on ground.	53.14	none
external wall: cavity brick; frame: no frame.	105.9	foil-foam composite board+ foil/sarking
external wall: brick veneer; frame: timber - untreated softwood.	124.1	fibreglass batts or roll
external garage wall: cavity brick; frame: no frame.	0.5	none
internal wall: single skin masonry; frame: no frame.	89.5	none
internal wall: plasterboard; frame: timber - untreated softwood.	194.3	none
ceiling and roof - flat ceiling / flat roof, framed - metal roof, timber - untreated softwood.	266.58	ceiling: fibreglass batts or roll; roof: foil backed blanket.

hermal Performance and Materials commitments

The applicant must install windows, glazed doors and skylights as described in the table below, in accordance with the specifications

Frames	Maximum area - m2
aluminium	98.9
timber	0
uPVC	0
steel	0
composite	0

Glazing	Maximum area - m2
single	21.8
double	77.1
triple	0

The applicant must install the following hot water system in the development, or a system with a higher energy rating: gas instantaneous with a performance of 6 stars. Cooling system The applicant must install the following cooling system, or a system with a higher energy rating, in at least 1 living area: 3-phase airconditioning; Energy rating: EER 3.0 - 3.5 The applicant must install the following cooling system, or a system with a higher energy rating, in at least 1 bedroom: 3-phase airconditioning; Energy rating: EER 3.0 - 3.5 Heating system The applicant must install the following heating system, or a system with a higher energy rating, in at least 1 living area: 3-phase airconditioning; Energy rating: EER 3.0 - 3.5 The applicant must install the following heating system, or a system with a higher energy rating, in at least 1 bedroom: 3-phase airconditioning; Energy rating: EER 3.0 - 3.5 Ventilation The applicant must install the following exhaust systems in the development: At least 1 Bathroom: individual fan, ducted to façade or roof; Operation control: manual switch on/off Kitchen: individual fan, ducted to façade or roof; Operation control: manual switch on/off

Energy Commitments

Laundry: natural ventilation only, or no laundry; Operation control: n/a **Artificial lighting** The applicant must ensure that a minimum of 80% of light fixtures are fitted with fluorescent, compact fluorescent, or light-emitting-diode (LED) lamps. Natural lighting

The applicant must install a window and/or skylight in the kitchen of the dwelling for natural lighting.

ne applicant must install a window and/or skylight in 5 bathroom(s)/toilet(s) in the development for natural lighting The applicant must install a gas cooktop & electric oven in the kitchen of the dwelling. The applicant must install a fixed outdoor clothes drying line as part of the development.



BASIX & THERMAL COMMITMENTS Post Code 111254 Pittwater Road Collarov To Cantilever/Suspended Floor Coverings R2.0 Insulation Slab on Ground Not Yet Selected R2.0 Insulation 1st Floor Suspended concrete External Material Internal Material Internal Insulated Default Cavity Brick R0.9 Foil Board Single Brick Default Brick Veneer Timber frame R2.5, Non Reflective Wrap Plaster Timber 90mm R2.5 R2.5 Plaster Timber Frame R6.0 Anticon 50mm (R1.3) Metal Default No Plaster Timber Frame R6.0 1st Floor Anticon 50mm (R1.3) Metal Default Please Refer to the NatHERS (or BASIX) Certificate for all external glazing. To comply you must use glazing with the same opening and frame type, the U value must be the same or lower and have an SHGC value within the range given. THE BELOW GLAZING NOMINATIONS ARE AN INDICATION ONLY PLEASE REFERENCE THE CERTIFICATE(S). **Glazing Type Required** Location(s) of Glazing Required Standard Single Clear All Wet Areas & Louvre windows Low-e Double Glaze Throughout excluding wet areas & Louvre windows Ceiling Fans Location Fan Size 1200mm 2,000L Garden, Laundry Toilets Kitchen Taps 4 Star > 6 but less < or = 7.5 litres per minute 4 Star 4 Star 4 Star Hot Water Cooling 3.0 - 3.5 EER - Heating 3.0 - 3.5 EER 3 Phase Gas Instantaneous 6 Star Air Conditioning Zoned Solar Photovoltaic System Orientation 1 Orientation 2 Cooking Outdoor Cloths Line Gas Cooktop/ Electric Oven Natural Ventilation- external window Ducted The project has been assessed under the simulation method of the BASIX Protocol. Downlights fitted after the assessment must be IC Rated and non-ventilated. All new residential buildings must be constructed in accordance with Building BCA Part 3. 12. 1, Build Sealing BCA Part 3. 12. 3. Insulation must be installed in accordance with AS3995. Frys Building Consultancy Pty Ltd Trading as Frys Energywise are Accredited Thermal Energy Assessors ABSA 20856, BDAV 12/1441, COLA 2011291

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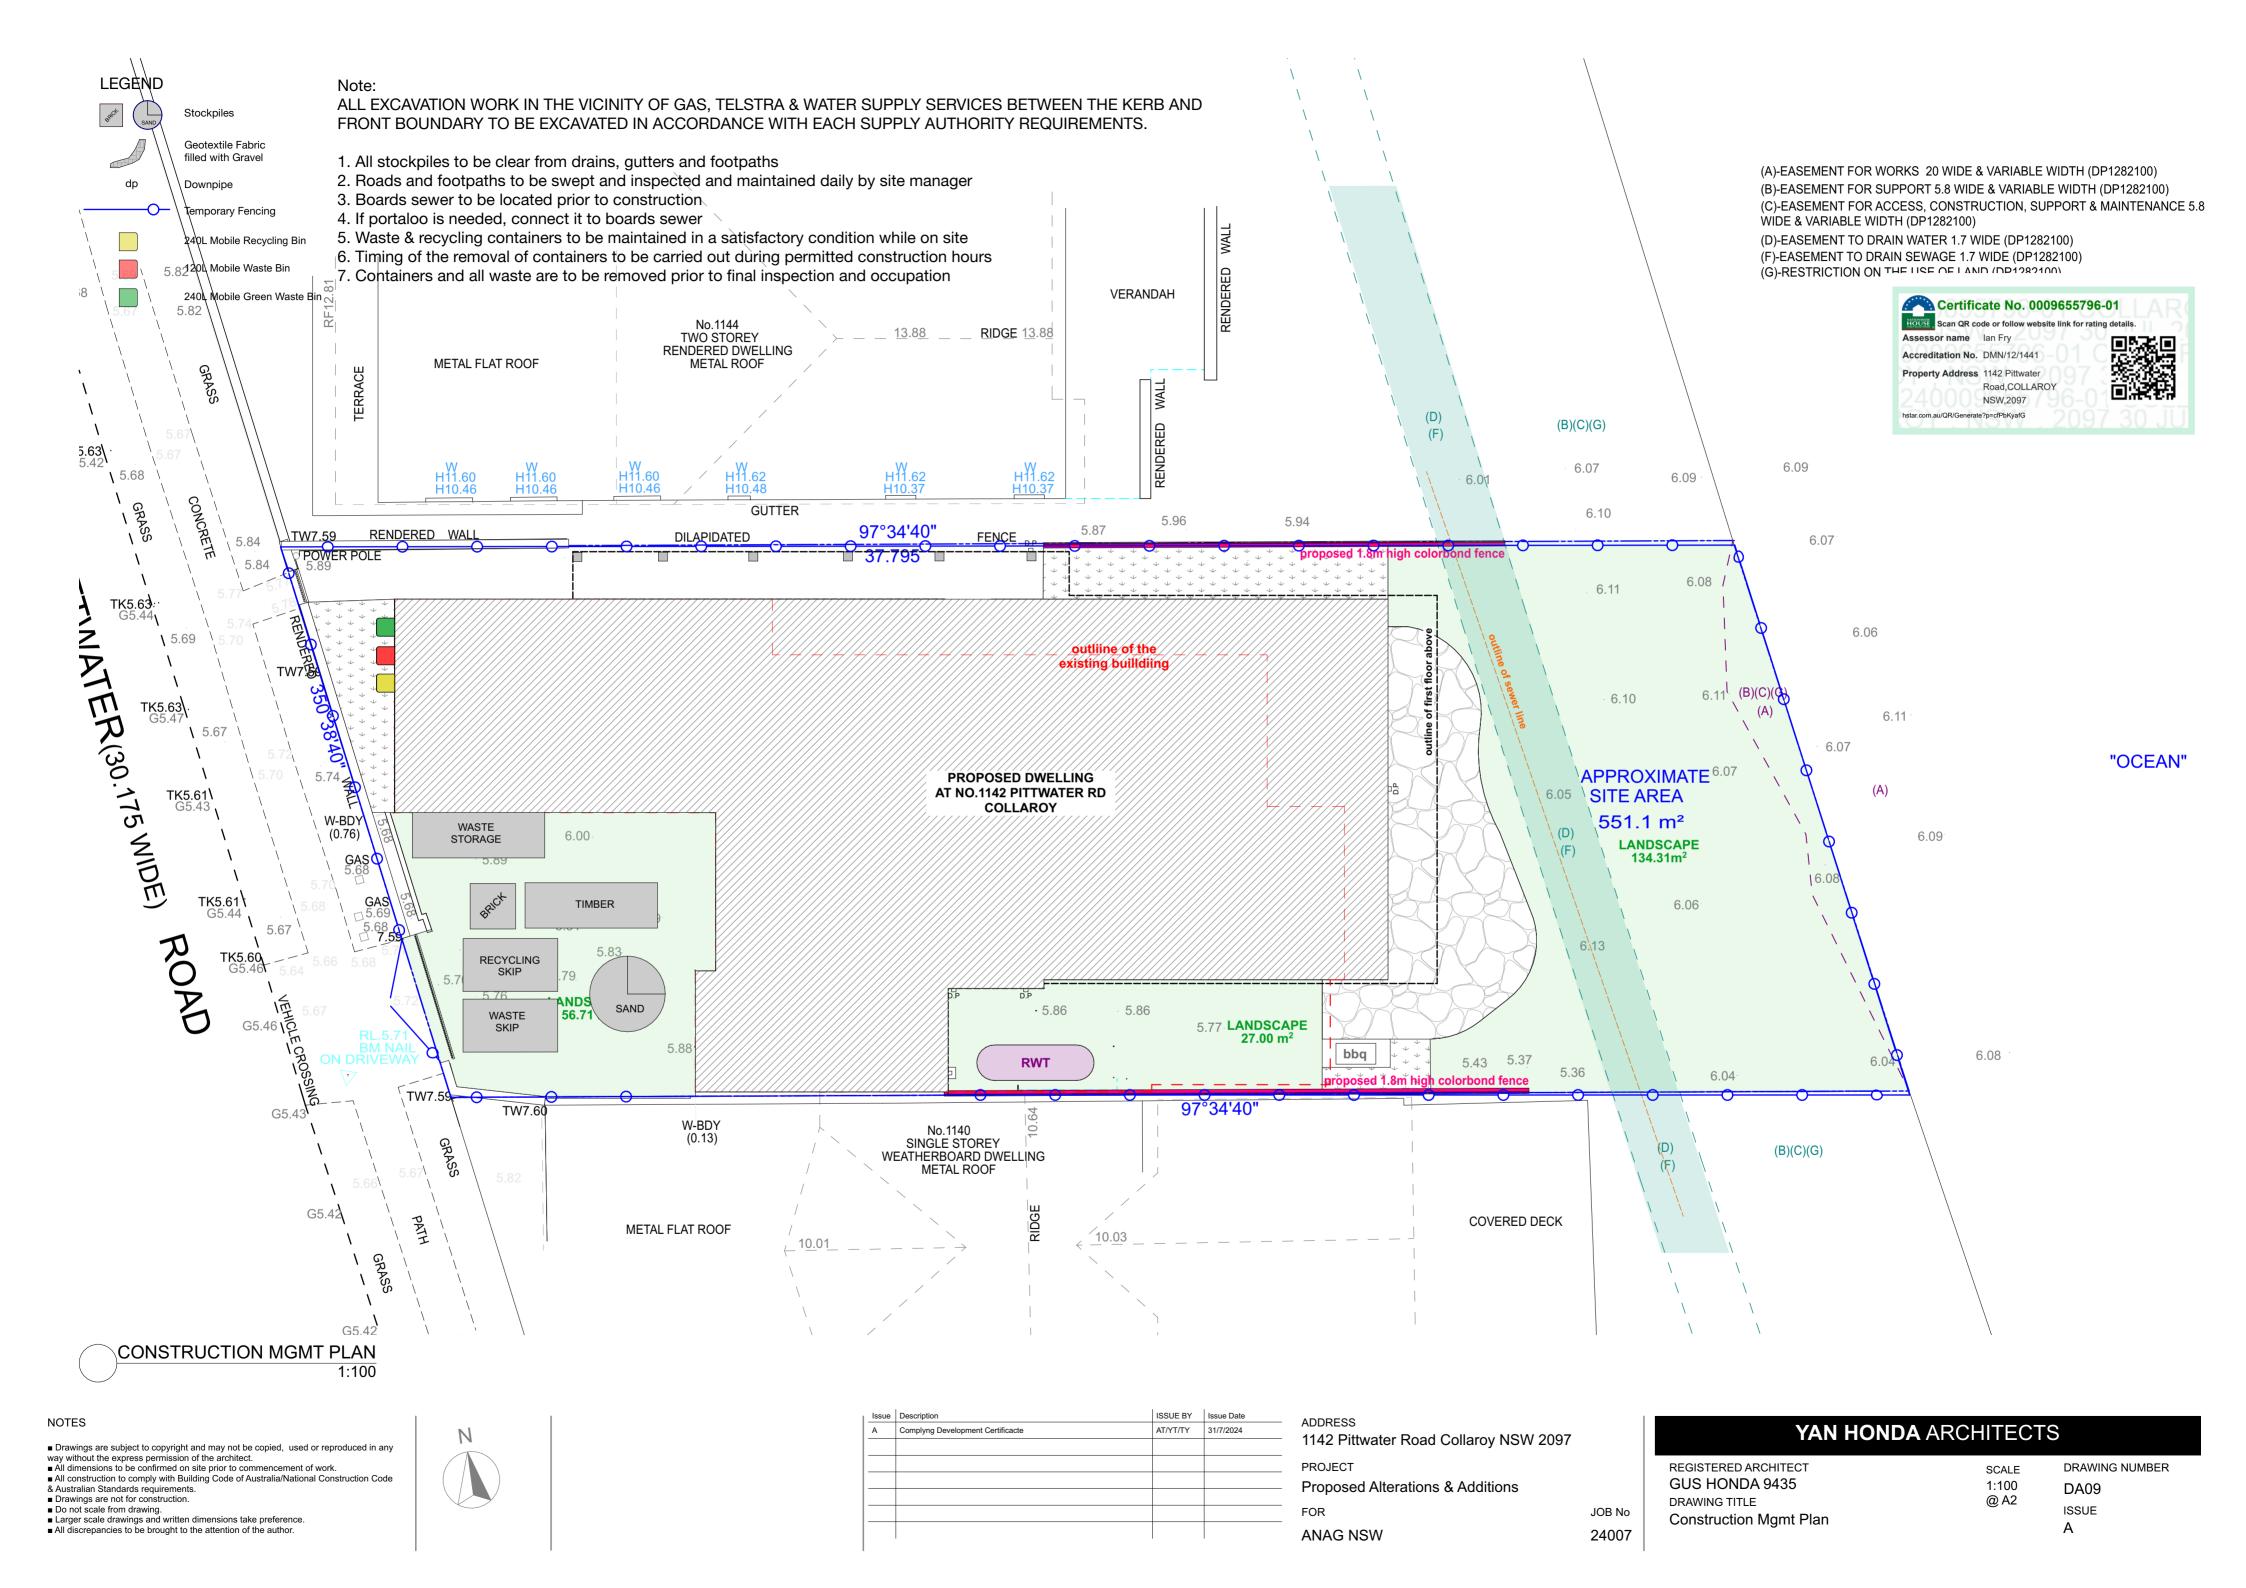
ssue	Description	ISSUE BY	Issue Date
Α	Complyng Development Certificacte	AT/YT/TY	31/7/2024

ADDRESS 1142 Pittwater Road Collaroy NSW 2097 PROJECT Proposed Alterations & Additions JOB No ANAG NSW 24007


YAN HONDA ARCHITECTS

REGISTERED ARCHITECT **GUS HONDA 9435** DRAWING TITLE Sections

DRAWING NUMBER SCALE 1:100 DA08 @ A2 ISSUE Α



 — extent of existing overshadowing additional overshadowing

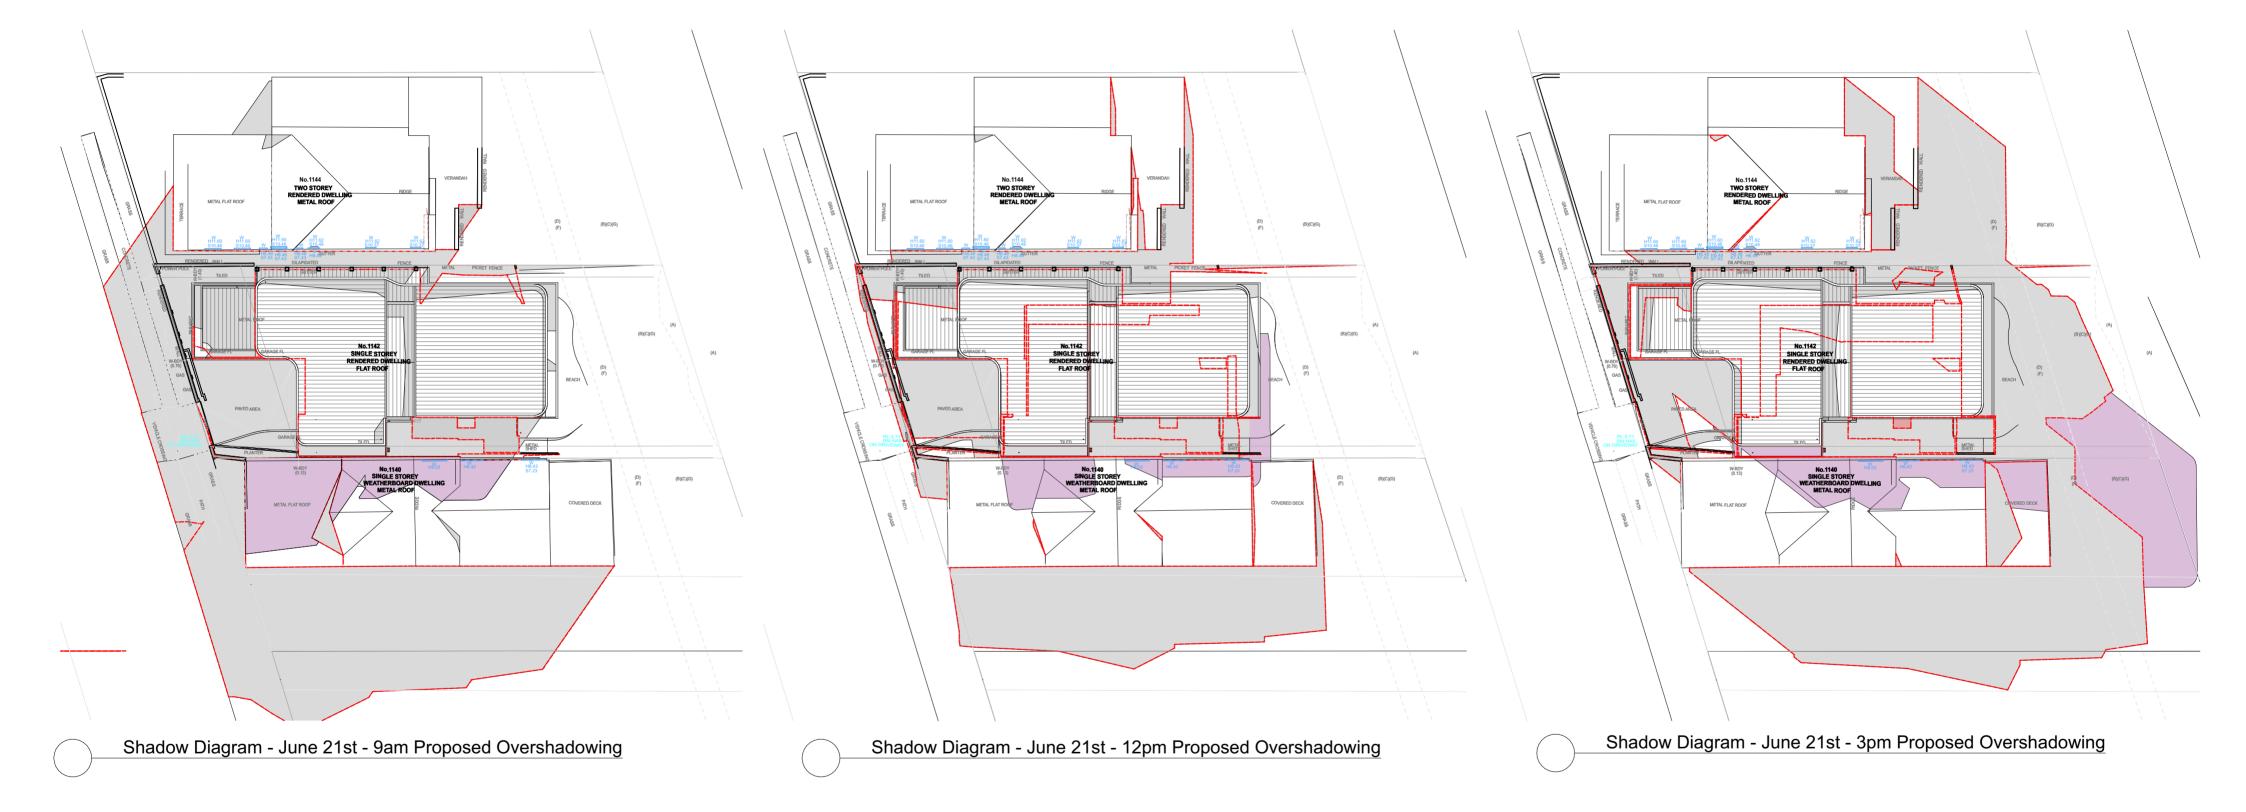

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	Complyng Development Certificacte		31/7/2024	ADDRESS
				1142 Pittwater Road Collaroy NSW 2097
				PROJECT
				Proposed Alterations & Additions
				FOR
				ANAG NSW

YAN HONDA ARCHITECTS

Certificate No. 0009655796-01

Scan QR code or follow website link for rating details.

Road, COLLAROY NSW,2097


REGISTERED ARCHITECT GUS HONDA 9435 DRAWING TITLE **Shadow Diagrams**


24007


Assessor name lan Fry Accreditation No. DMN/12/1441 Property Address 1142 Pittwater

hstar.com.au/QR/Generate?p=cfPbKyafG

3 NUMBER SCALE DA10 @ A2 ISSUE Α

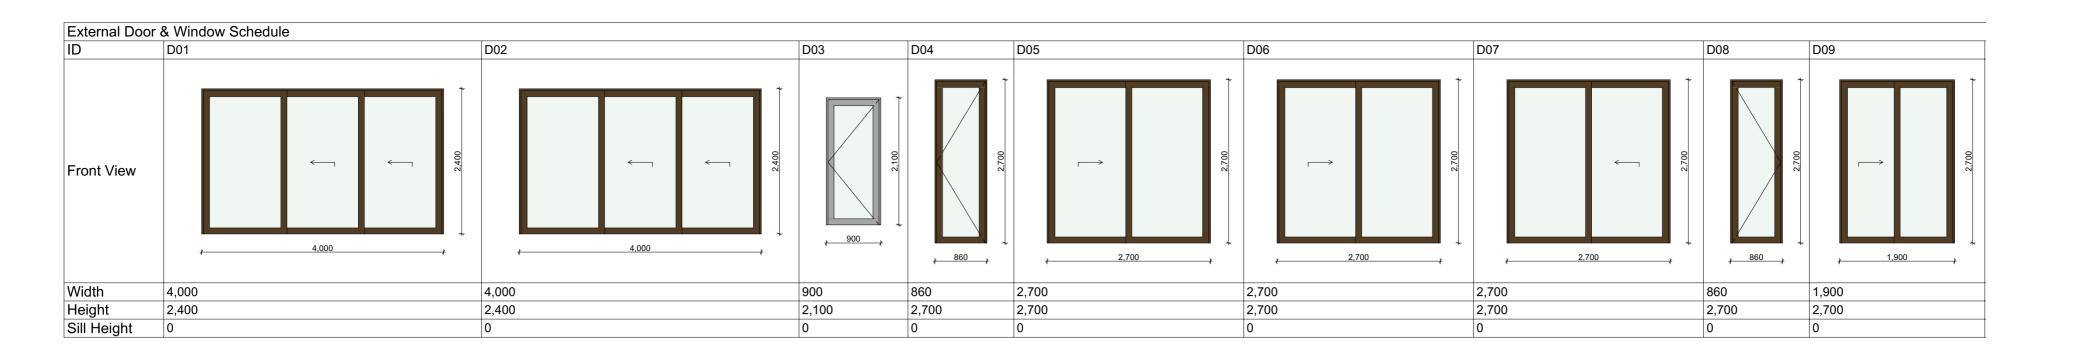

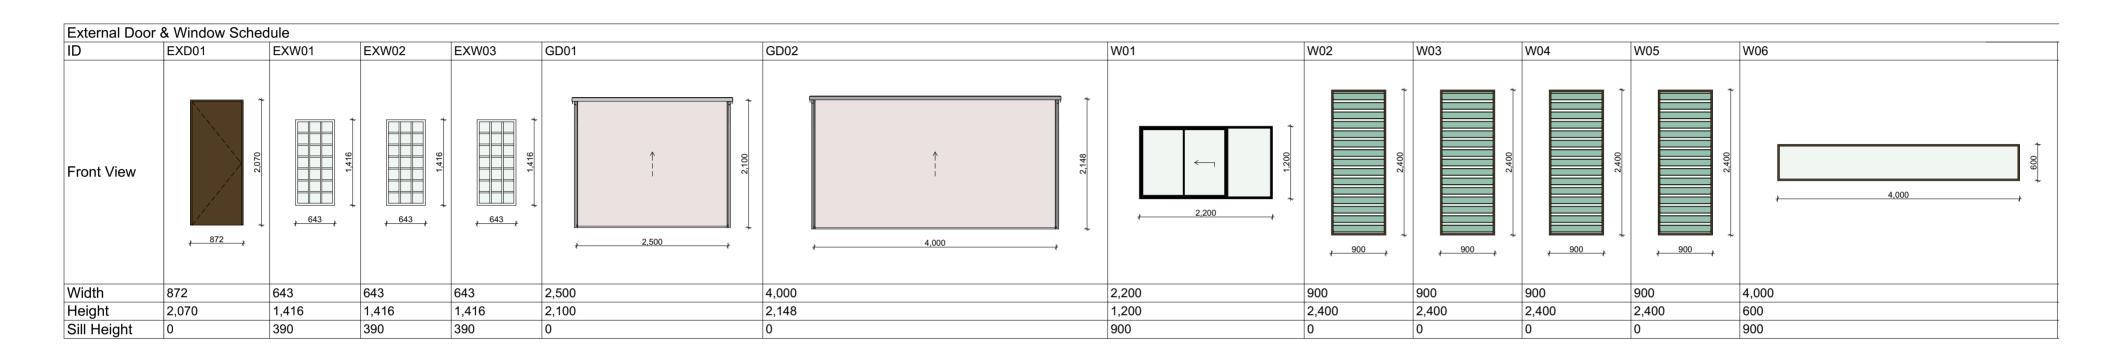

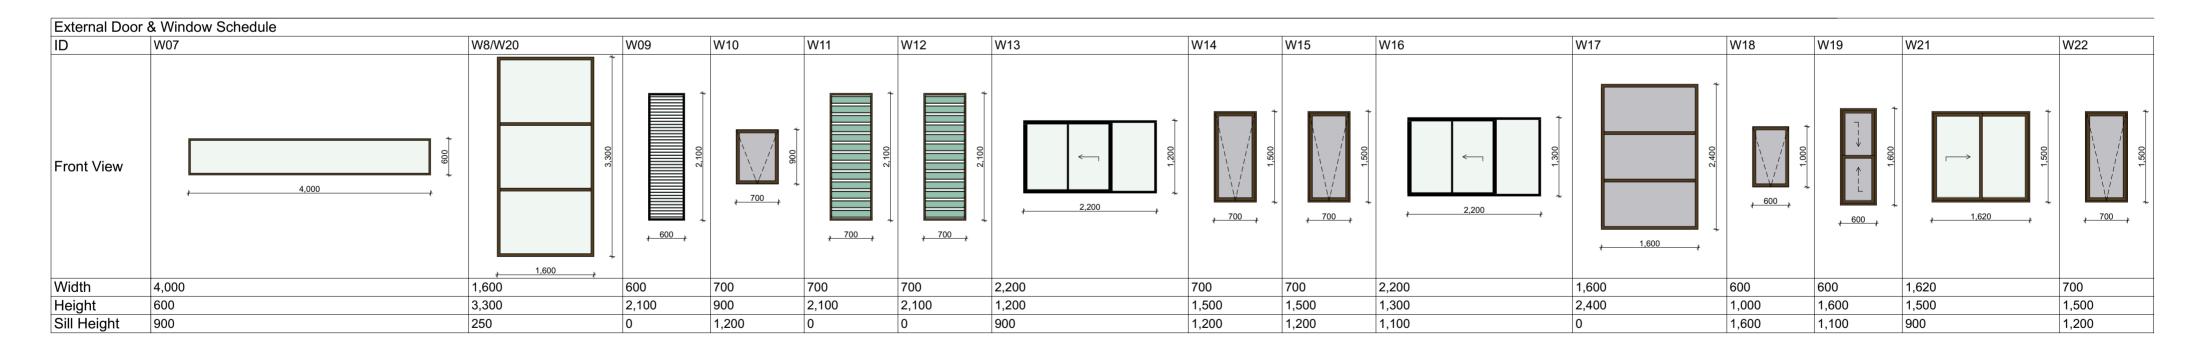

NOTES:

- Windows and doors are indicativeonly. Details to be provided by builders/manufacturers. Dimensions are wall opening indicationonly.
 Lift-off hinges to all bathrooms and WC where the clearance between the WC and door opening is less than 1200mm in distance in accordance with BCA/NCC Clause H4P3 and ABCB Housing Provisions Standards Part 10.4.2 Protectionof openable windows to comply with NCC Clause H5P2 and ABCB Part 11.3,11.3.7 and 11.3.8

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Certificate No. 0009655796-01

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Courtificate No. 0009655796-01 Assessor name lan Fry Accreditation No. DMN/12/1441 Property Address 1142 Pittwater Road, COLLAROY hstar.com.au/QR/Generate?p=cfPbKyafG

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				FOR	JOB No
				ANAG NSW	24007

LEGEND

FG

fixed glass translucent glass TG

louvre glass

YAN HONDA ARCHITECTS

REGISTERED ARCHITECT GUS HONDA 9435 DRAWING TITLE External Window & Door Schedule 01

DRAWING NUMBER SCALE DA11 @ A2 ISSUE

Α

1142 Pittwater Road Collaroy NSW 2097 - Proposed Alterations & Additions





Colour: Rockcote "TBC"



Render and Painted wall



Powdercoated aluminium framed windows and doors Colour: Colorbond Powdercoat/ Dulux 'Monument'



Colorbond kliplok roof sheeting Colour: Colorbond 'surfmist'



Facebrick wall Colour: TBC



Knotwood wall cladding Knotwood front gates Knotwood garage door Colour: Knotwood "Grey Ash" or Merbau Wathered



Render and Painted wall Colour: Dulux "TBC" to match colour of claddiing

NOTE - Colorbond gutters and downpipes and flashings colour to match timber cladding colour

NOTE: All colours and finishes can be replaced by similar colours.

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				— FOR	JOB No
				ANAG NSW	24007

YAN HONDA ARCHITECTS REGISTERED ARCHITECT DRAWING NUMBER GUS HONDA 9435 DA12 DRAWING TITLE ISSUE Finishes Schedule Α