





NOTE: ALL DEMOLISHED ELEMENTS TO ENG. SPECIFICATIONS AND AS. 2601 - 2001



SITE ANALYSIS PLAN - DEMOLITION

REV. DATE COMMENTS DRWN NOTES DRWN
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The Builder/Contractor shall check and verify ALL dimensions on site prior to commencement of any work, creation of shop drawings, or fabrication of components.
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1:200



DRAWING NO. ALEXIS AND DEAN **DA02**

CLIENT

HOUDEN

16 WORCESTER ST,


COLLAROY NSW, 2097

PROJECT ADDRESS

DRAWING NAME SITE ANALYSIS

DATE SCALE Friday, 1 September 2023 1:200 @A2



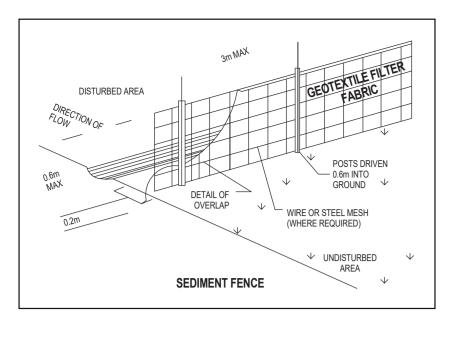

No. 9


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SITE / ROOF / SEDIMENT EROSION / WASTE MANAGEMENT / STORMWATER CONCEPT PLAN

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DRAWING NO.

THIS PLAN IS TO BE READ IN

CONJUNCTION WITH

THE CONDITIONS OF DEVELOPMENT

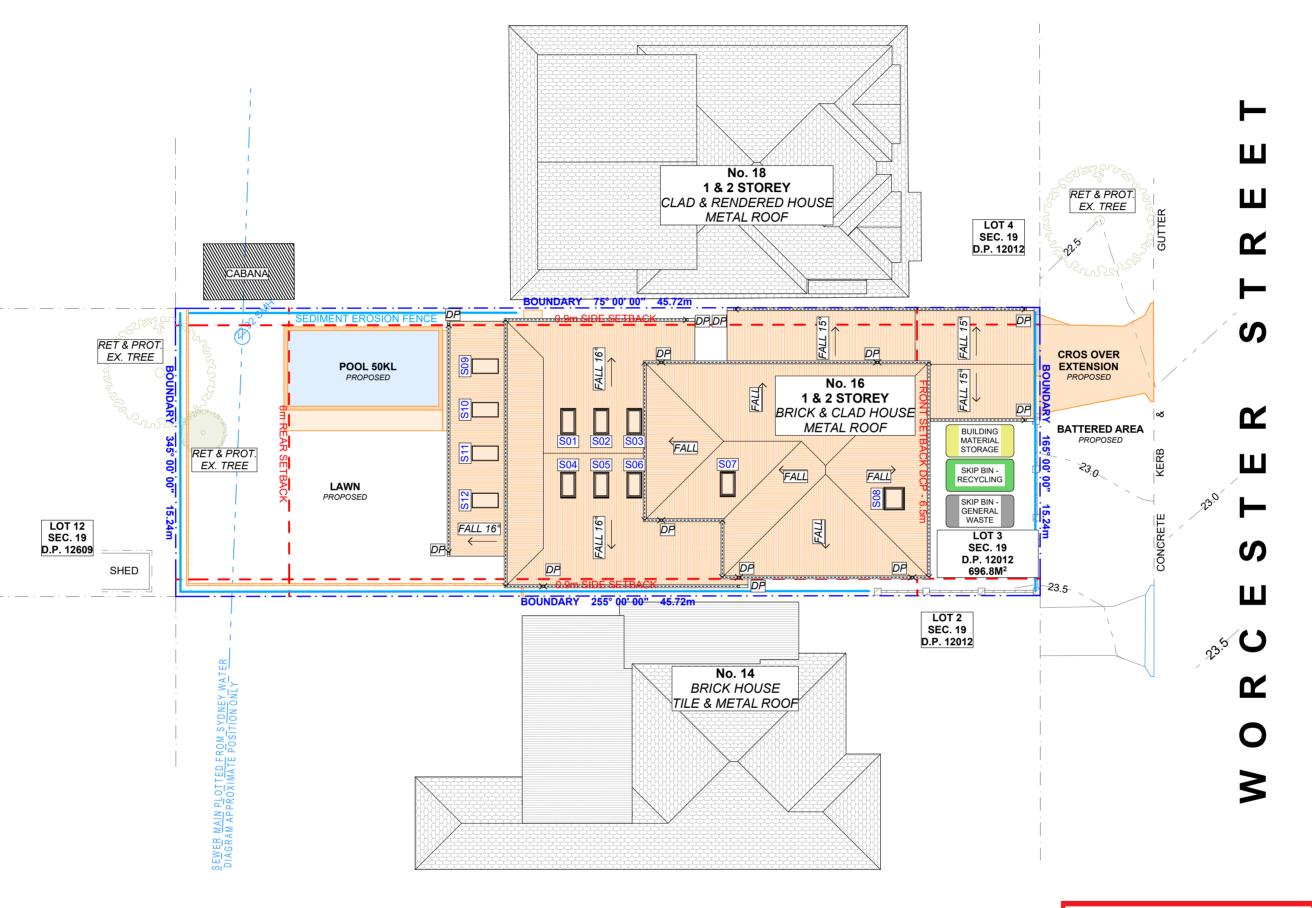CONSENT

DA2023/0921

CLIENT

HOUDEN

PROJECT ADDRESS

16 WORCESTER ST,

COLLAROY NSW, 2097

ALEXIS AND DEAN **DA03**

DATE

Friday, 1 September 2023

WASTE MANAGEMENT / STORMWATER CONCEPT PLAN

TREE PROTECTION ZONE (TPZ):

1. CHAIN WIRE MESH PANELS WITH SHADE CLOTH (IF REQUIRED) ATTACHED, HELD IN PLACE WITH CONCRETE FEET. 2. ALTERNATIVE PLYWOOD OR WOODEN PALING FENCE PANELS. THE FENCING MATERIAL ALSO PREVENTS BUILDING

MATERIALS OR SOIL ENTERING THE TPZ. 3. MULCH INSTALLATION ACROSS SURFACE OF TPZ (AT THE DISCRETION OF THE PROJECT ARBORIST). NO EXCAVATION, CONSTRUCTION ACTIVITY. GRADE CHANGES, SURFACE TREATMENT OR STORAGE OF MATERIALS OF ANY KIND

4. BRACING IS PERMISSIBLE WITHIN THE TPZ. INSTALLATION OF SUPPORTS TO

IS PERMITTED WITHIN THE TPZ.

AVOID DAMAGING ROOTS.

TREE PROTECTION

THE INFORMATION SHOWN ON THIS PLAN IS FOR

DESIGN PURPOSES ONLY. THE POSITION OF BOUNDARY LINES HAVE BEEN ESTABLISHED BY A

REGISTRATION WITH THE LAND REGISTRATION

SERVICES NSW NOR MAY THIS PLAN BE USED FOR

ANY OTHER PURPOSE. SUBSEQUENT REGISTERED

OR OTHER SURVEYS MAYAFFECT THE DEFINED

DIFFERENCES OF THIS NATURE ARE BEYOND THE PURPOSES OF THIS PLAN. THIS PLAN IS FOR THE

THE TITLE HAVE NOT BEEN INVESTIGATED. IF

THAT A SURVEY SET OUT IS CARRIED OUT.

DUST CONTROL:

SEDIMENT NOTE:

SEDIMENT FENCE AREA.

SYSTEM OR WATERWAYS.

MANAGER.

STOCKPILES:

OVER STOCKPILES.

AROUND STOCKPILES.

GUTTER PROTECTION:

SITE FOR DISPOSAL.

CONSTRUCTION WORKS.

FURTHER DEVELOPMENT IS CONTEMPLATED OR

CONSTRUCTION INTENDED THEN IT IS IMPORTANT

TO REDUCE DUST GENERATED BY WIND ACTION, THE REMOVAL OF THE TOP SOIL IS TO BE MINIMISED. TO

PREVENT DUST GENERATION, WATERING DOWN OF

THE SITE, ESPECIALLY DURING THE MOVEMENT OF

WITHIN THE SITE TO A MINIMUM. ENSURE WIND BREAKS, SUCH AS EXISTING FENCES ARE MAINTAINED

DURING THE CONSTRUCTION PHASE UNTIL NEW

LANDSCAPING IS PROVIDED OR REINSTATED.

PREVENT DUST BY COVERING STOCKPILES

MACHINERY IS REQUIRED. WHERE EXCAVATING INTO

ROCK, KEEP THE SURFACE MOIST TO MINIMISE DUST.

CONSTRUCT A GRAVEL ENTRY/EXIT POINT USING BLUE METALAND RESTRICT ALL VEHICLE MOVEMENTS

1. ALL EROSION AND SEDIMENT CONTROL MEASURES TO BE INSPECTED AND MAINTAINED DAILY BY THE SITE

2. MINIMISE DISTURBED AREAS, REMOVE EXCESS SOIL FROM EXCAVATEDAREA AS SOON AS POSSIBLE. 3. ALL MATERIAL STOCKPILE TO BE CLEAR FROM DRAINS, GUTTERS AND FOOTPATHS, OR WITHIN

4. DRAINAGE TO BE CONNECTED TO STORMWATER AS SOON AS POSSIBLE. IF STORED ON SITE, IT MUST BE FILTERED BEFORE RELEASING INTO STORMWATER

5. ROADS AND FOOTPATHS TO BE SWEPT DAILY.

ALL STOCKPILES ARE TO BE KEPT ON-SITE WHERE POSSIBLE. ANY MATERIALS PLACED ON THE FOOTPATHS OR NATURE STRIPS REQUIRE COUNCIL'S ALL STOCKPILES ARE TO BE PLACED AWAY FROM THE DRAINAGE LINES AND STREET GUTTERS. IT IS BEST TO LOCATE THESE ON THE HIGHEST PART OF THE SITE IF POSSIBLE. PLACE WATERPROOF COVERING

IF REQUIRED PROVIDE DIVERSION DRAIN & BANK

PROVIDE PROTECTION TO DOWNHILL GRATE IN

GUTTER BY MEANS OF SAND BAGS OR BLUE METAL WRAPPED IN GEOTEXTILE FABRIC. WHEN SOIL OR SAND BUILDS UP AROUND THIS SEDIMENT BARRIER,

THE MATERIAL SHOULD BE RELOCATED BACK TO THE

NOTE: ALL PROPOSED STORMWATER

TO CONNECT WITH EXISTING

NOTE: SITE BOUNDARY IS TO BE IDENTIFIED BY A REGISTERED SURVEYOR AND CLEARLY MARKED ON

SITE PRIOR TO COMMENCEMENT OF ANY

ABOVE STATED PURPOSES ONLY. RESTRICTIONS ON

BOUNDARY POSITIONS IN THIS AREA. ANY

SURVEY TO MEET THE IDENTIFICATION REQUIREMENTS FOR COUNCIL AND NOT FOR


NOTES REGARDING BOUNDARY


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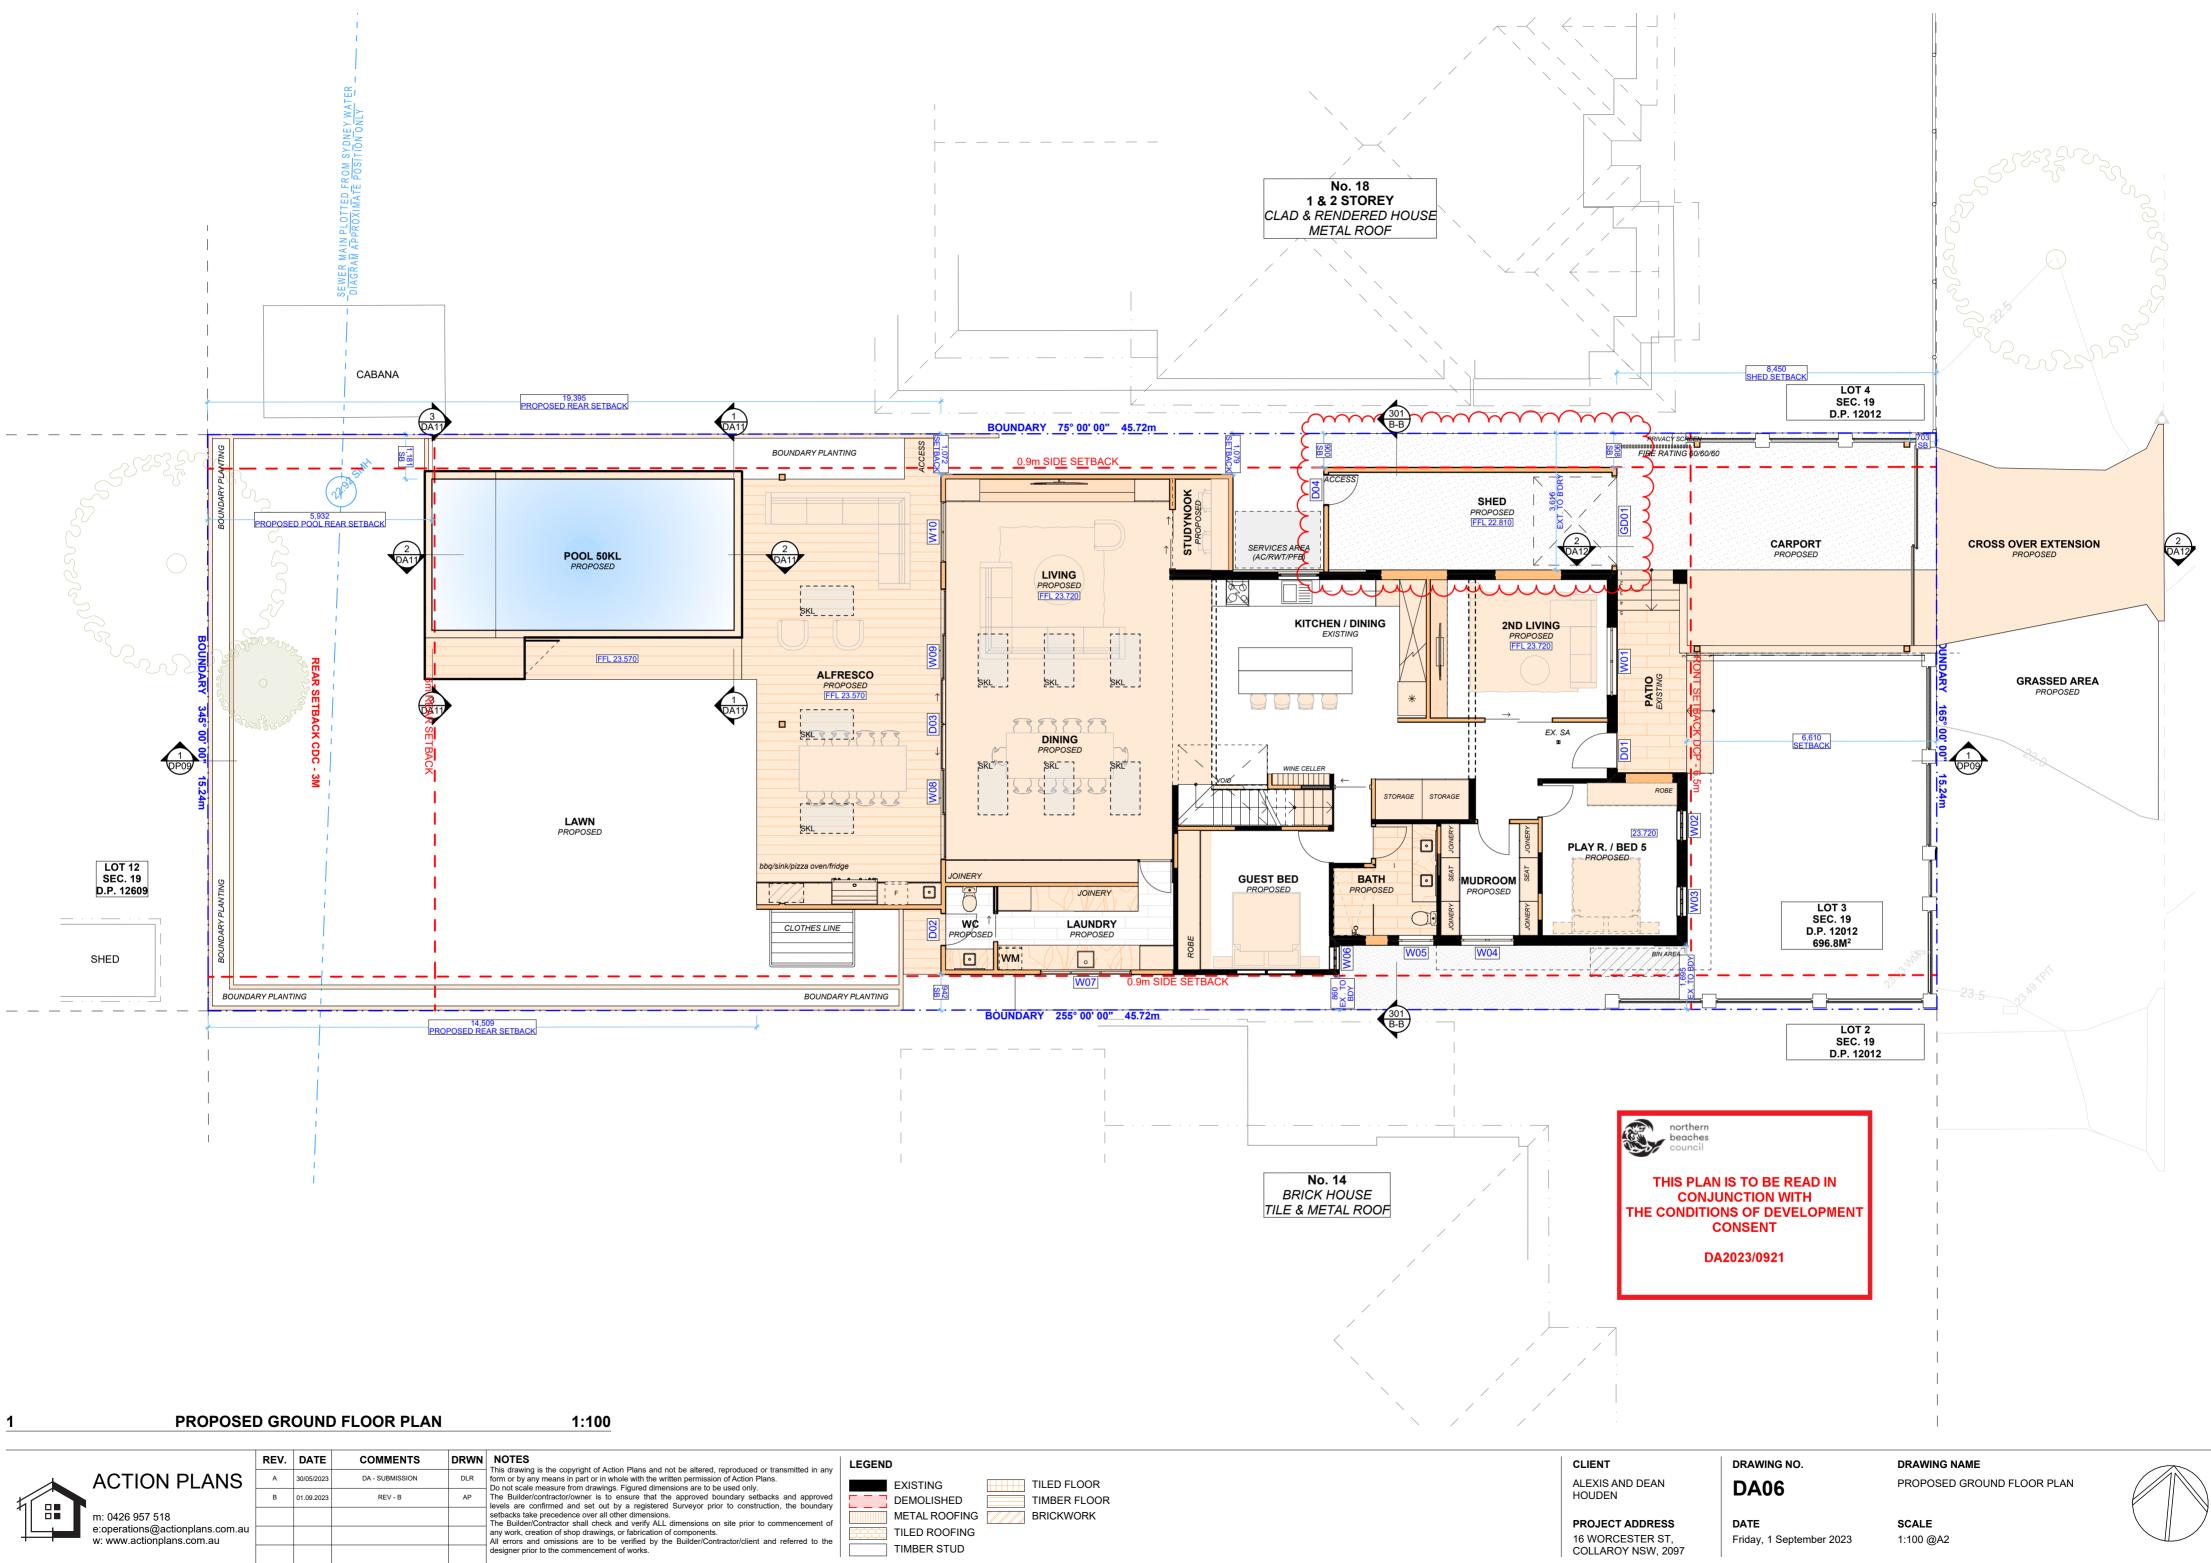
DRAWING NAME

SITE / ROOF / SEDIMENT EROSION /

SCALE 1:1.30, 1:3.75, 1:200 @A2



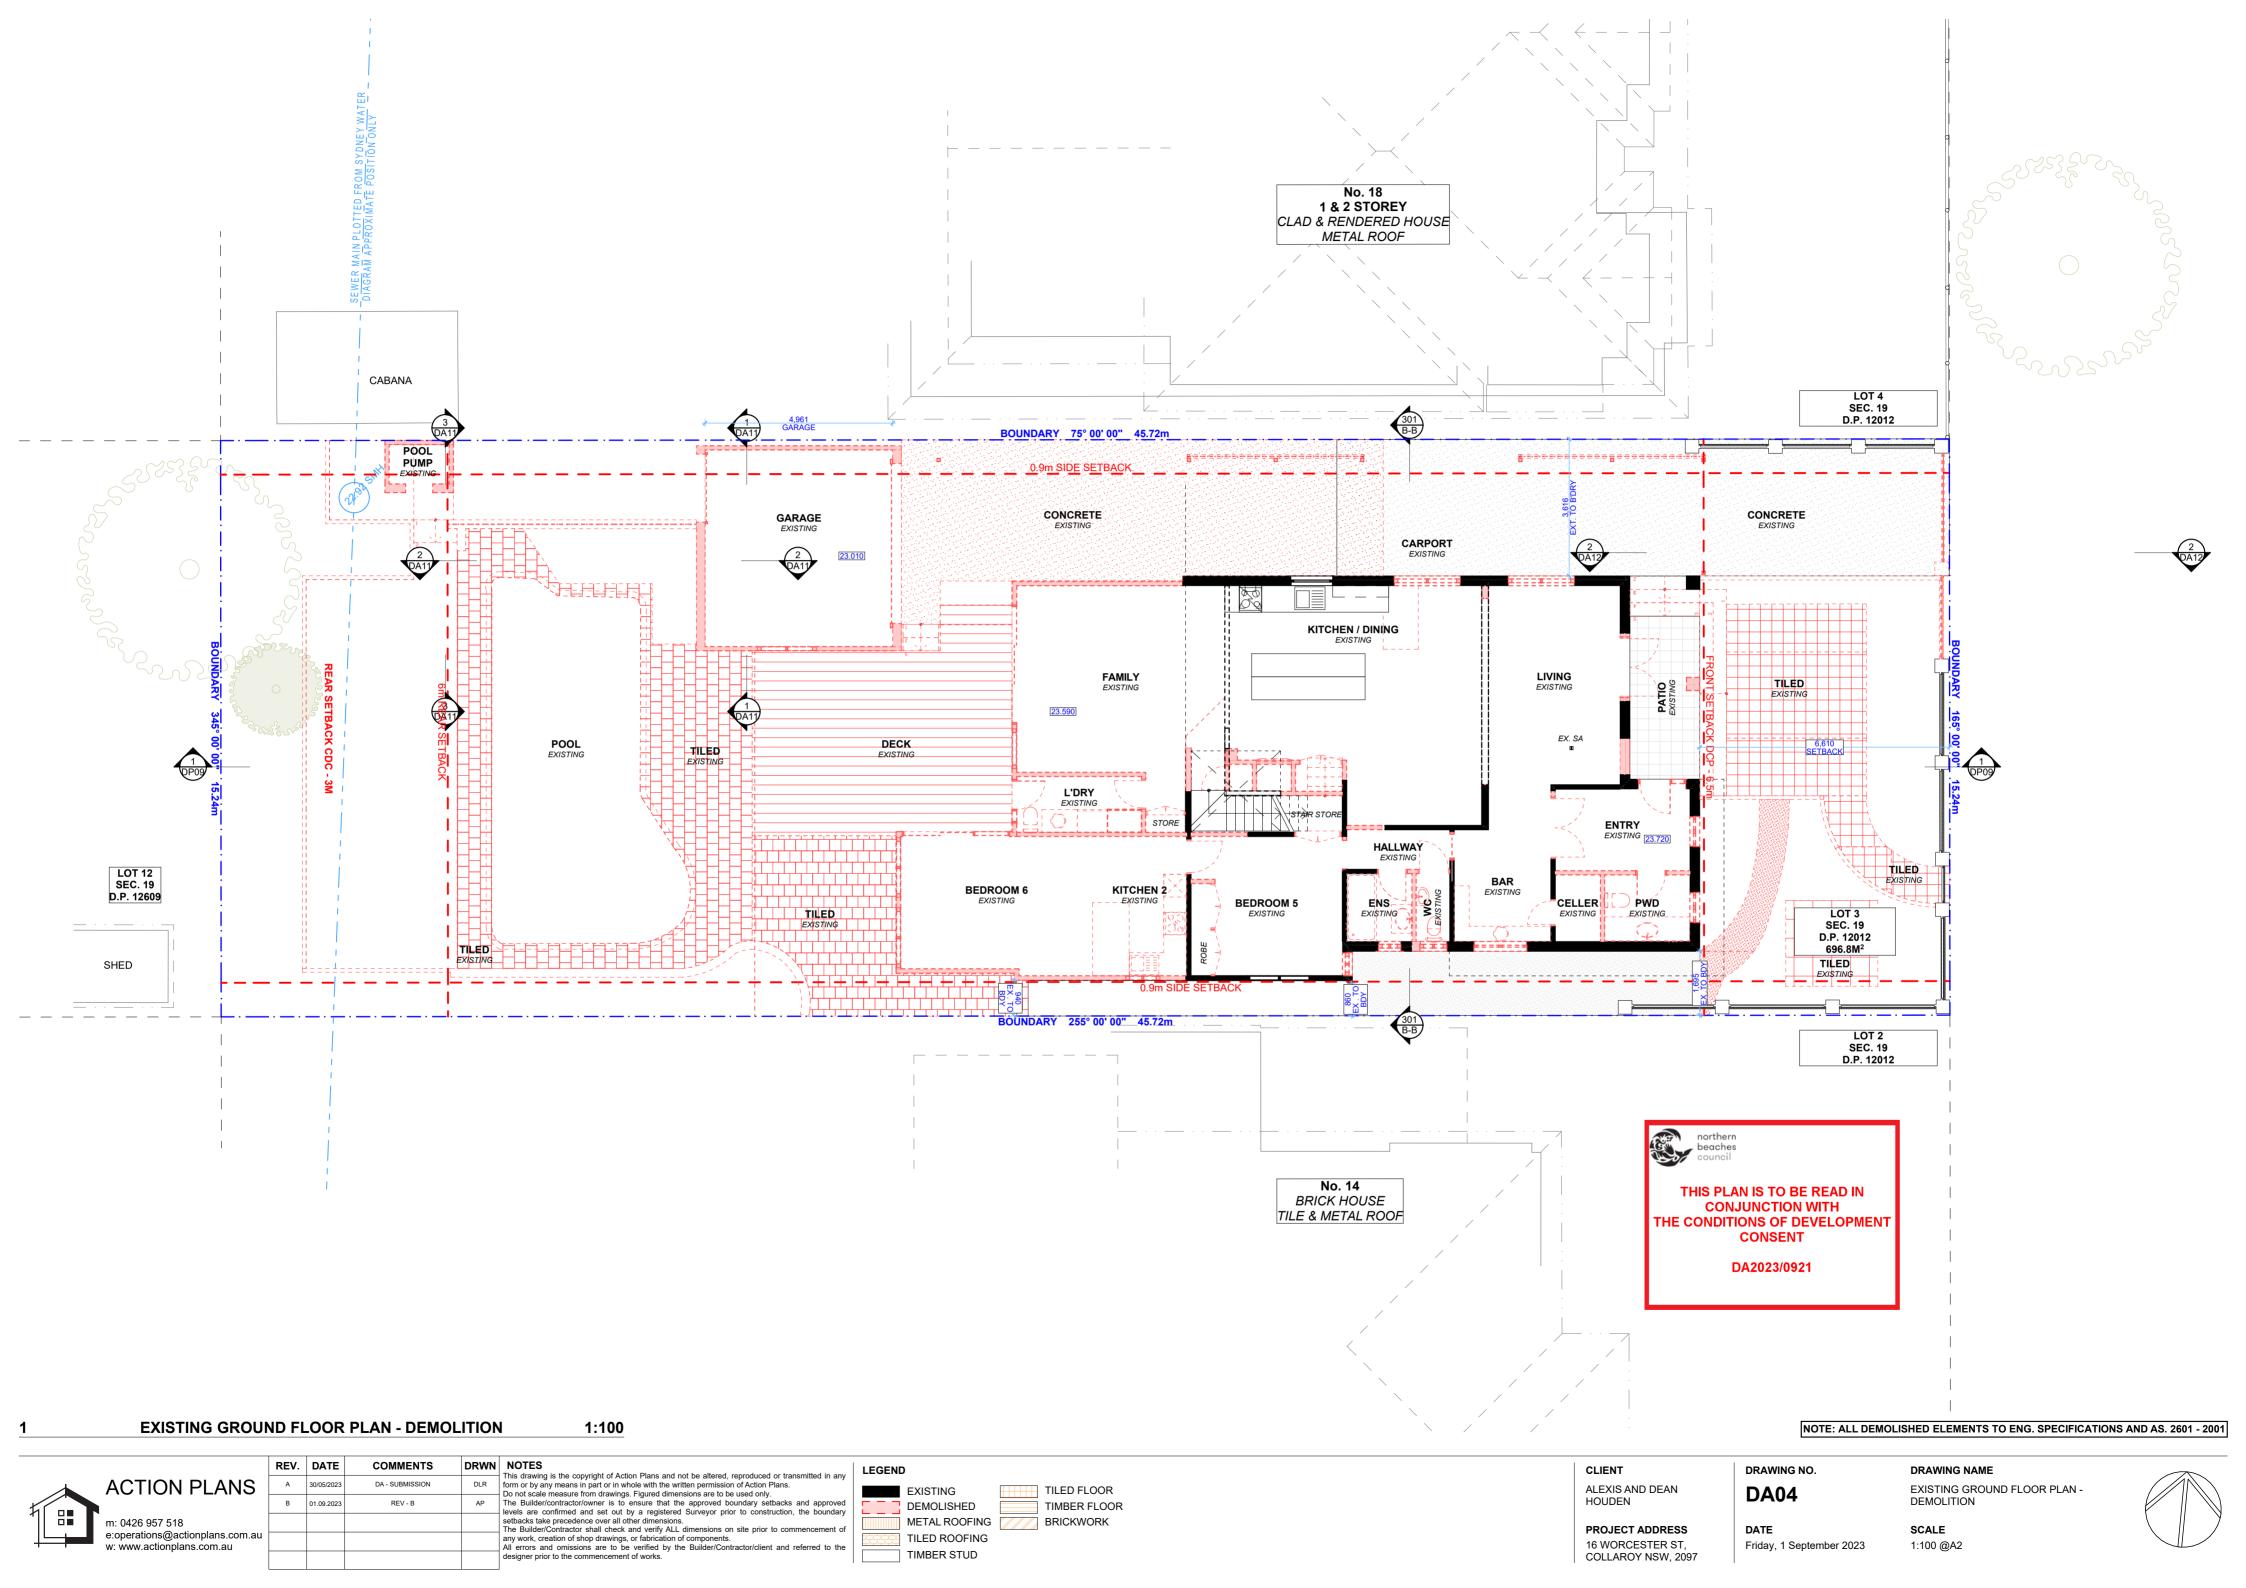

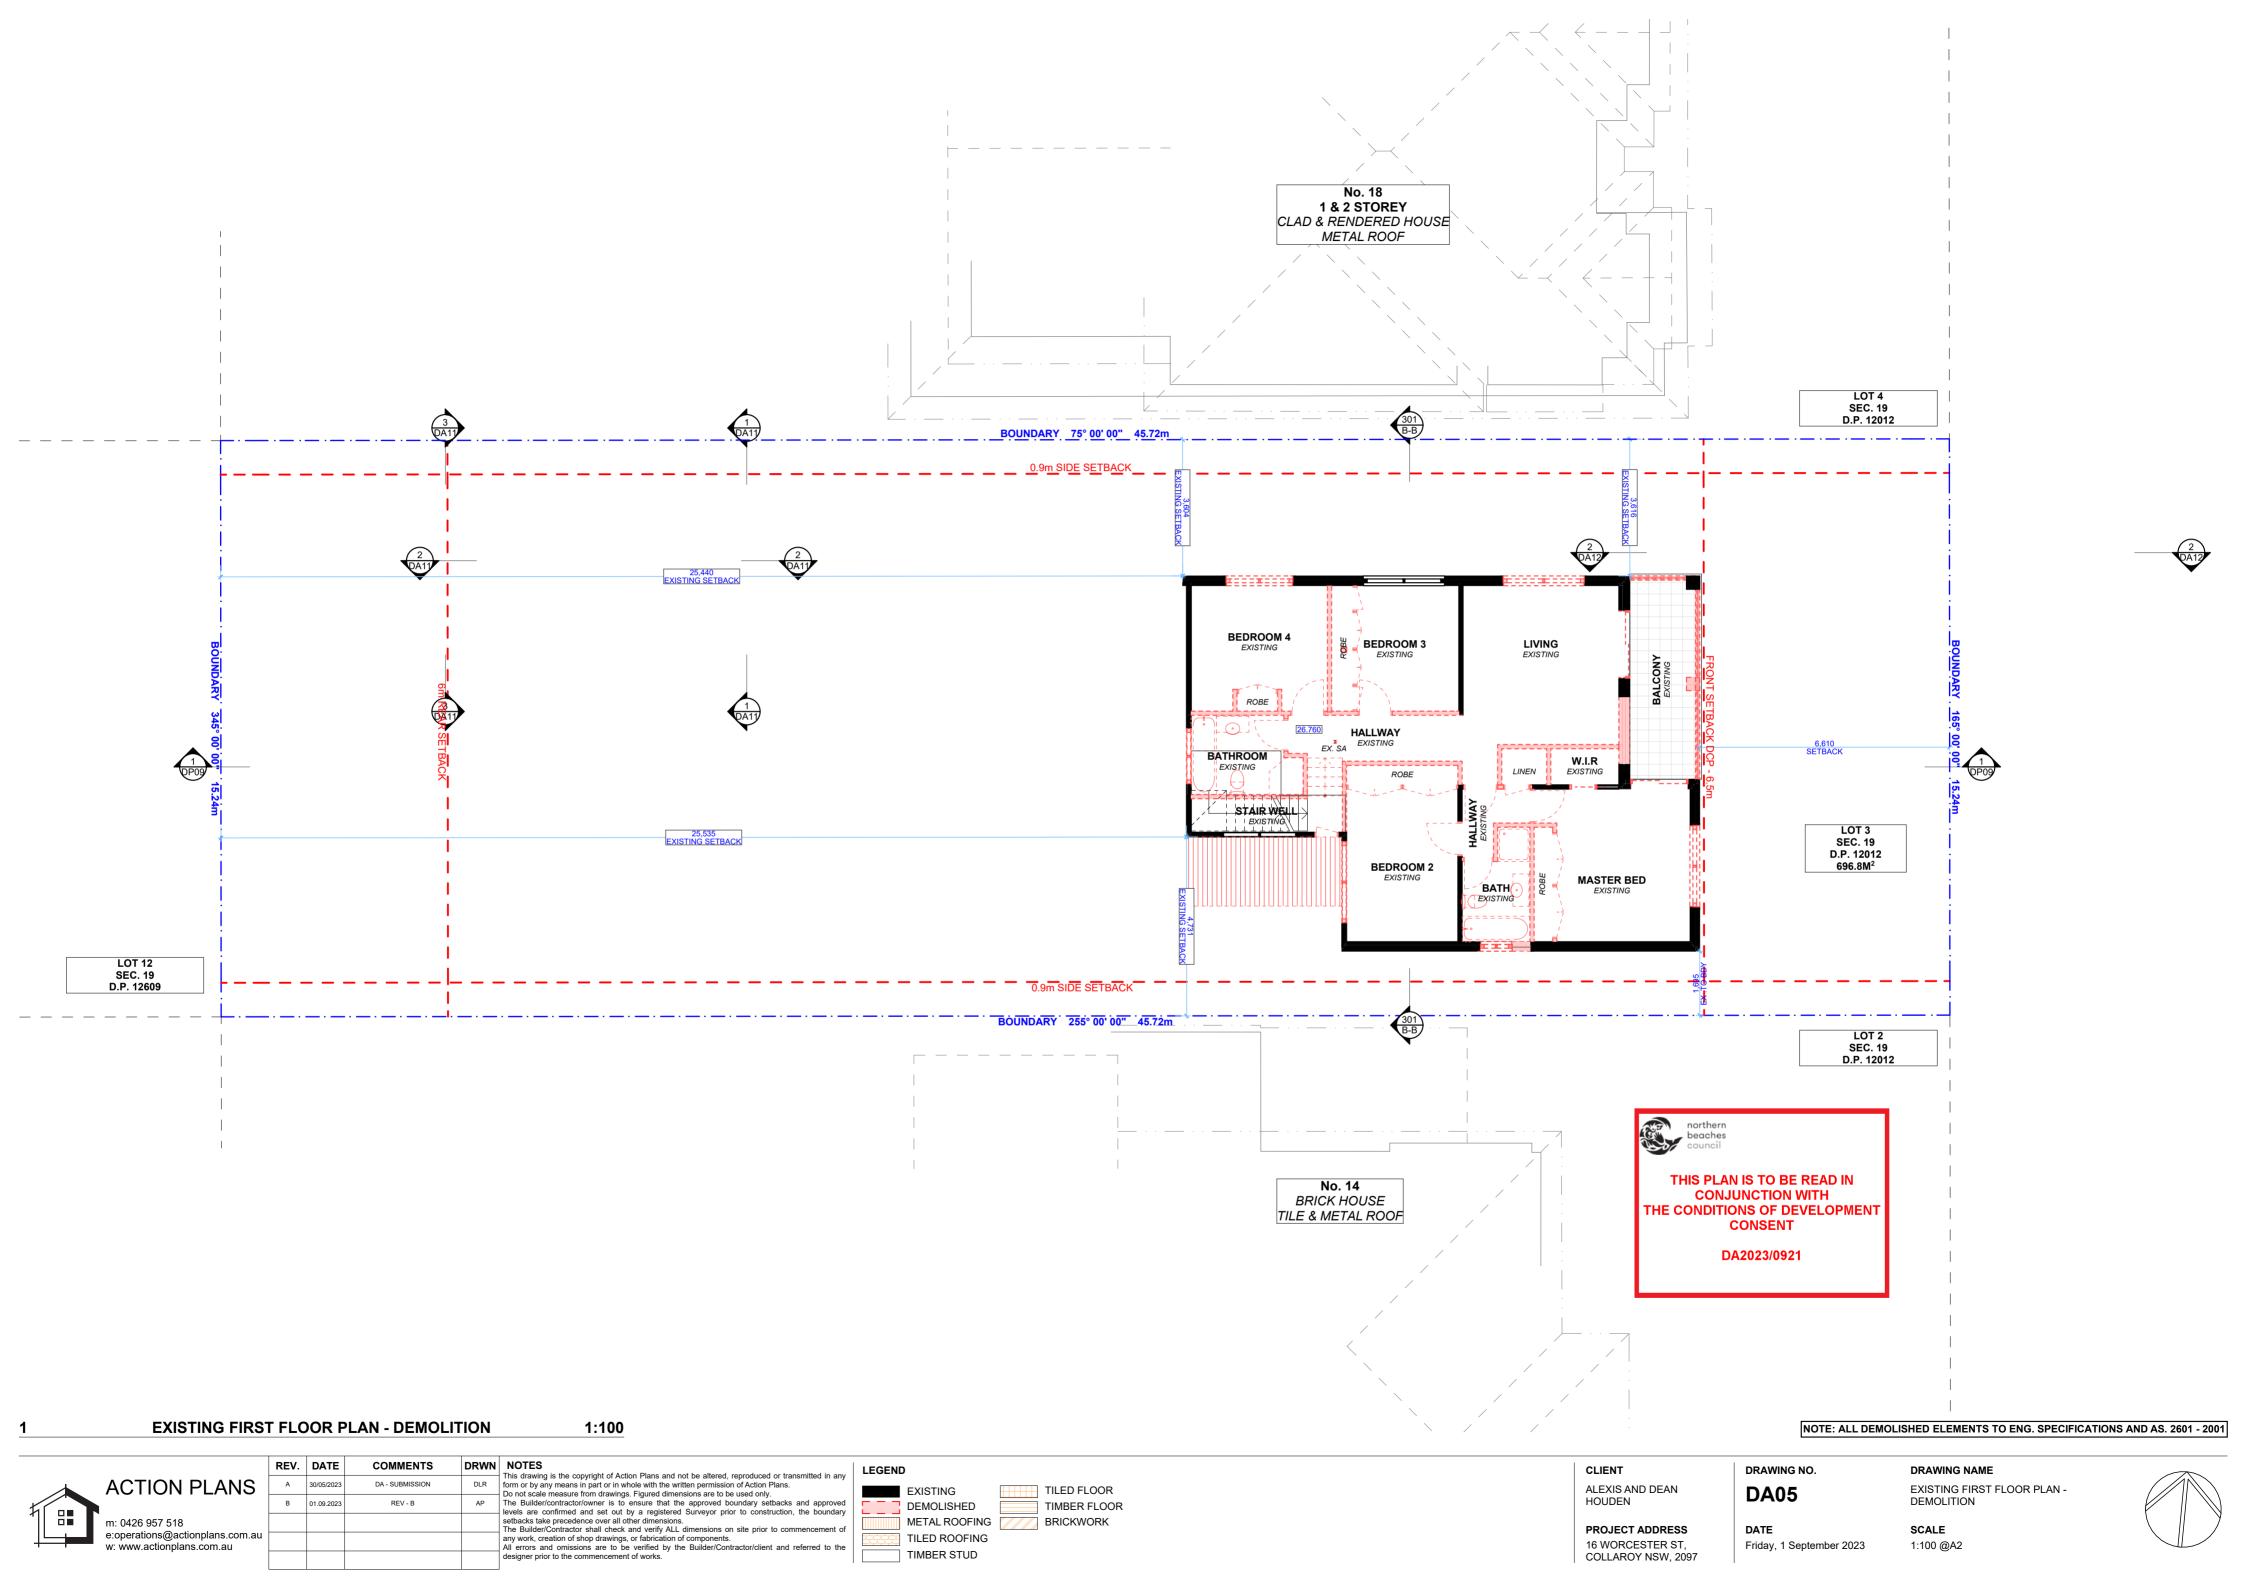






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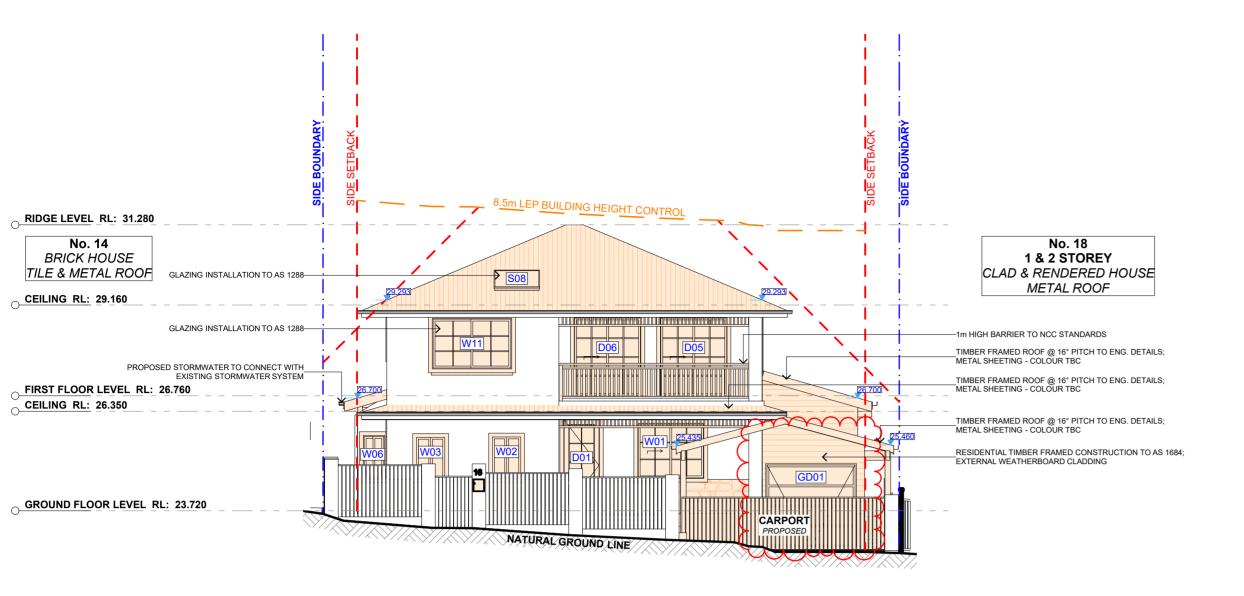
Friday, 1 September 2023

16 WORCESTER ST,


COLLAROY NSW, 2097

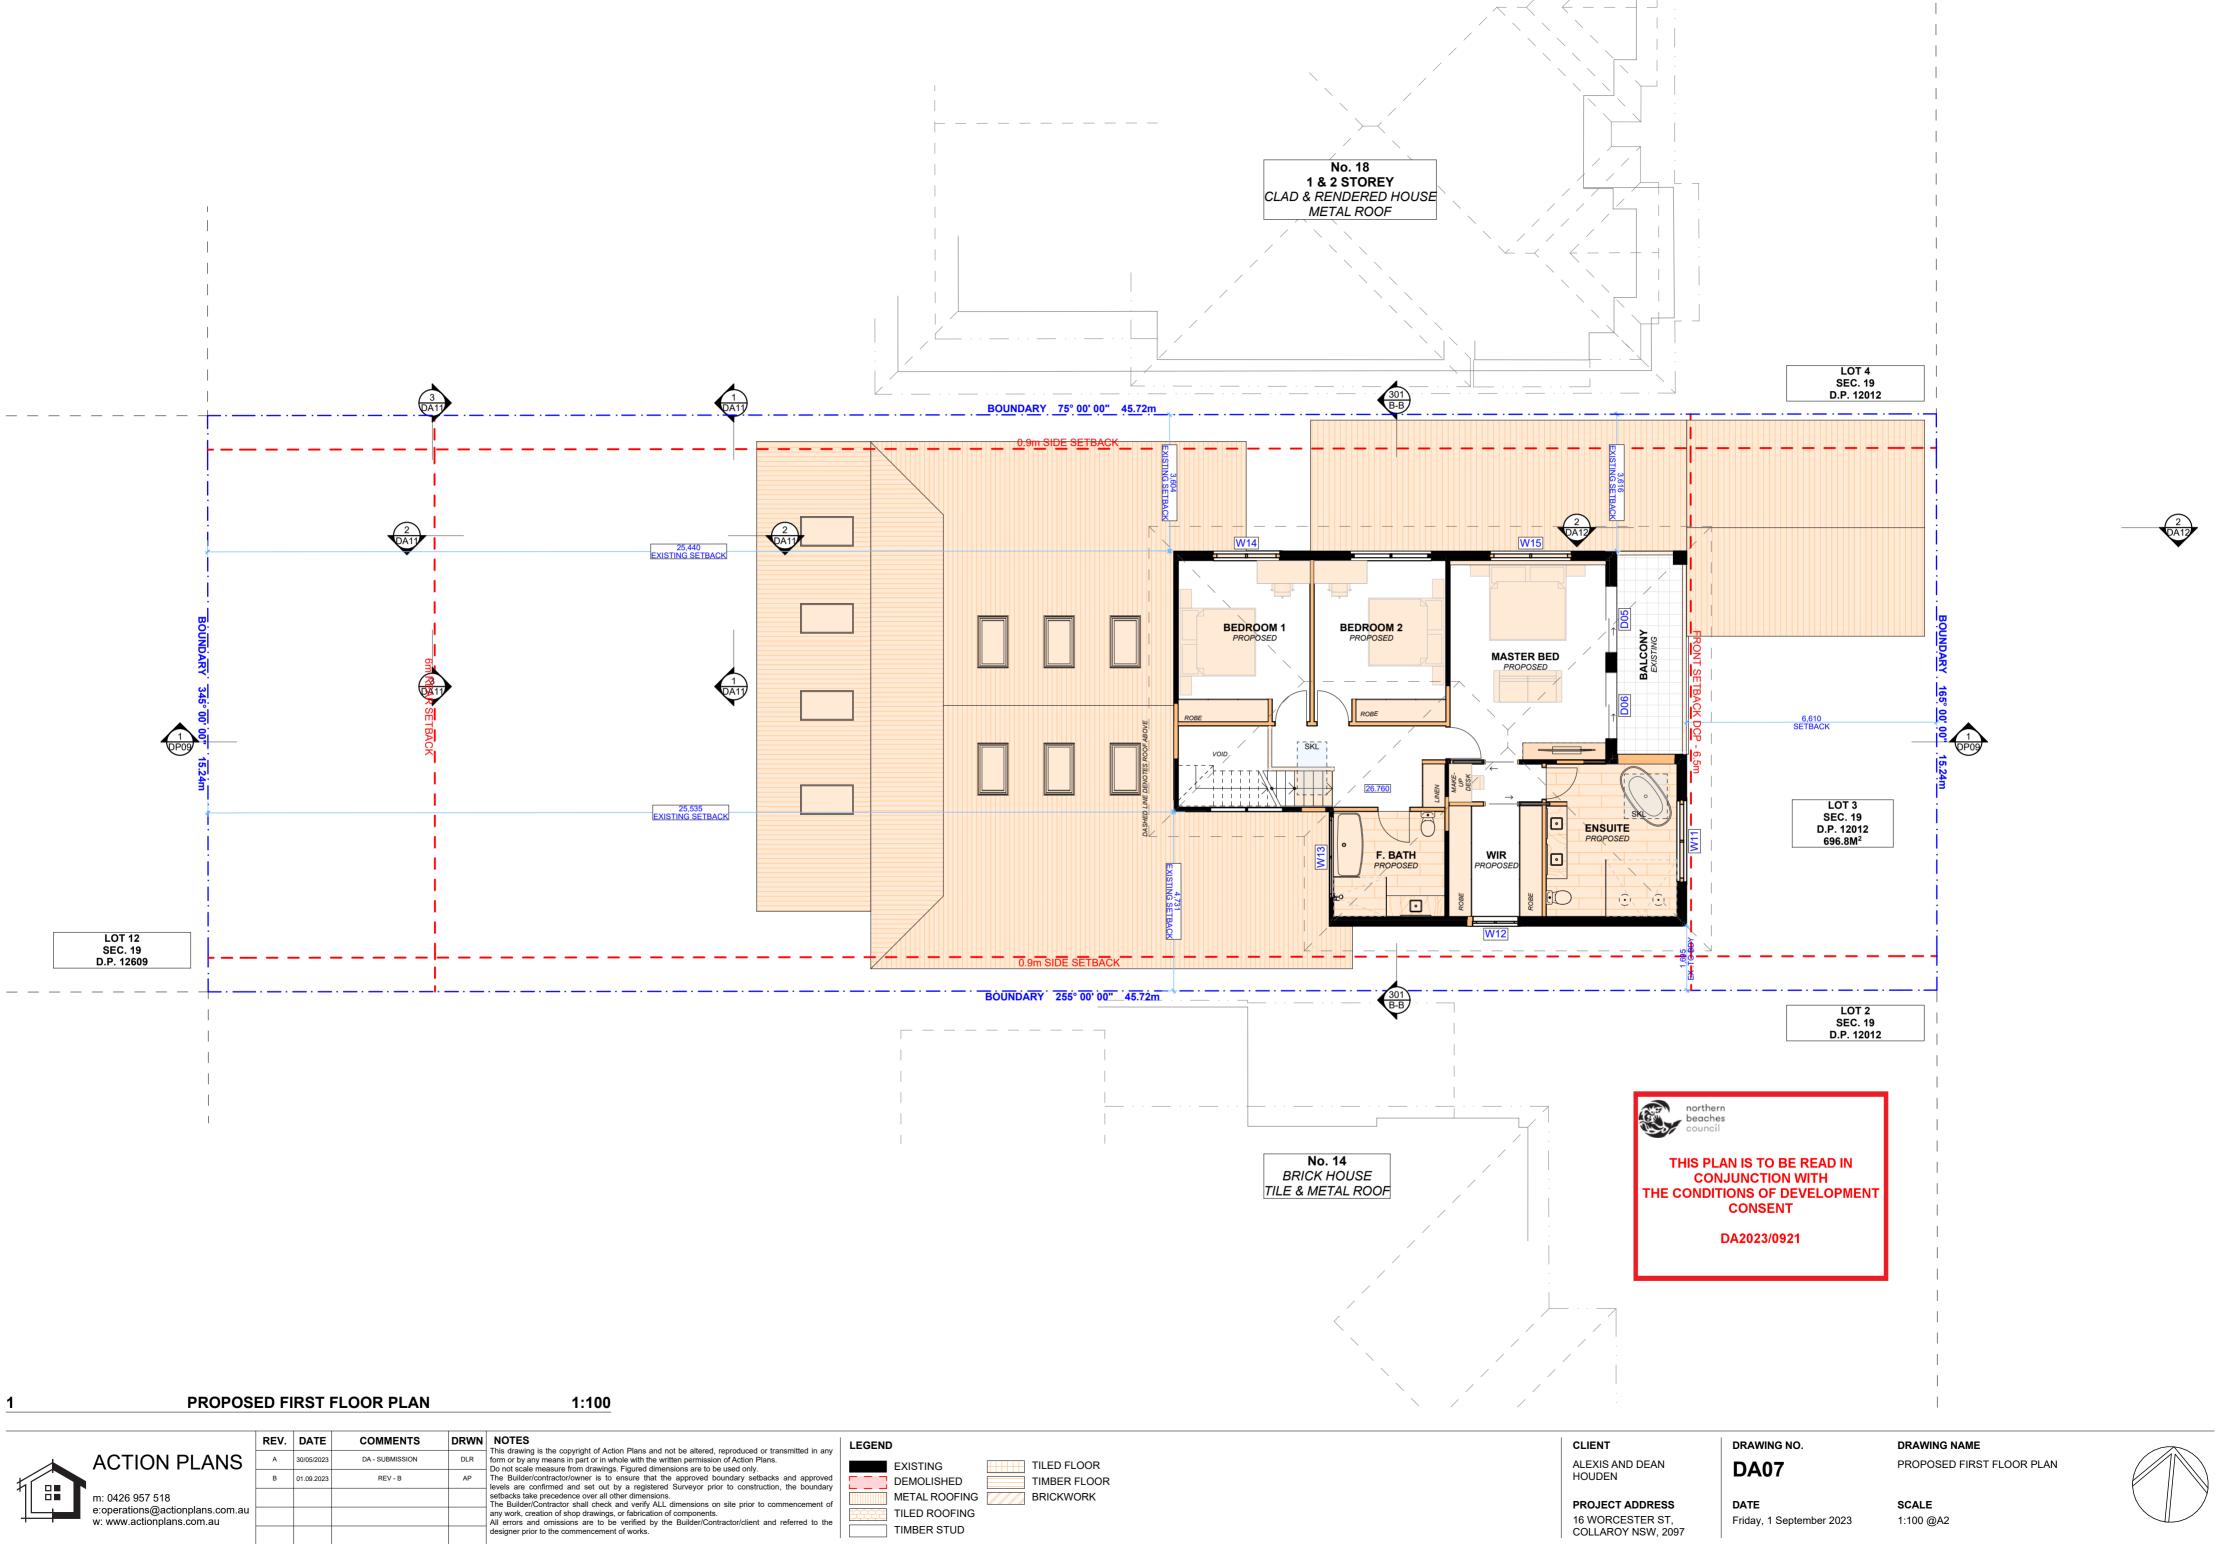SCALE

1:100 @A2





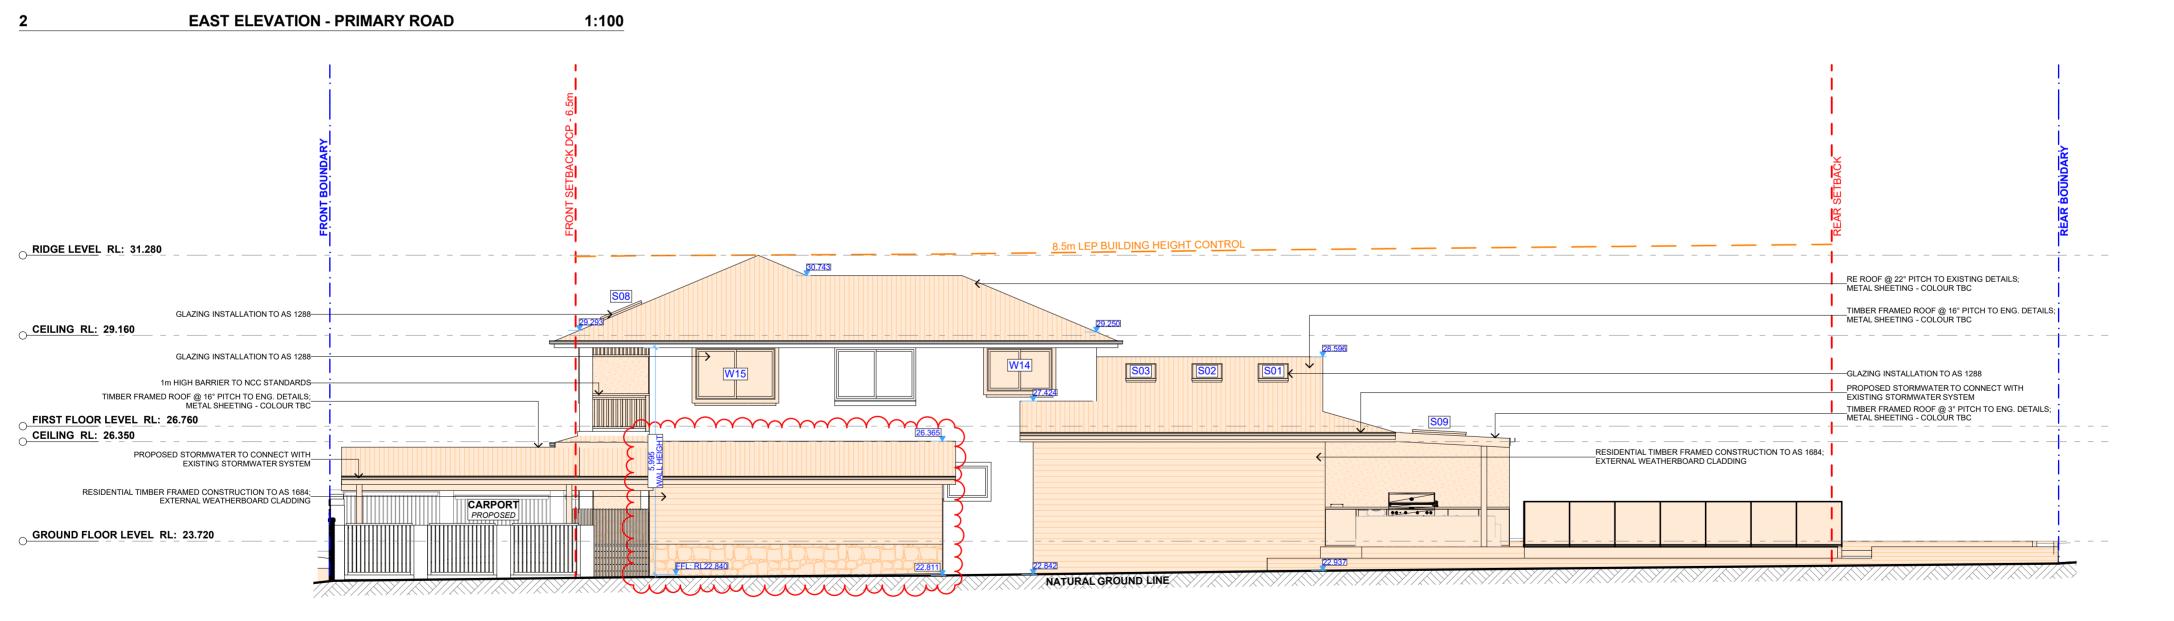

1 NORTH ELEVATION - SIDE 1:100

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ALEXIS AND DEAN
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PROJECT ADDRESS
16 WORCESTER ST,

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DATE
Friday,

COLLAROY NSW, 2097

DA08


DRAWING NAME

NORTH / EAST ELEVATION


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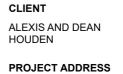
THIS PLAN IS TO BE READ IN **CONJUNCTION WITH** THE CONDITIONS OF DEVELOPMENT CONSENT DA2023/0921



SOUTH ELEVATION - SIDE 1:100

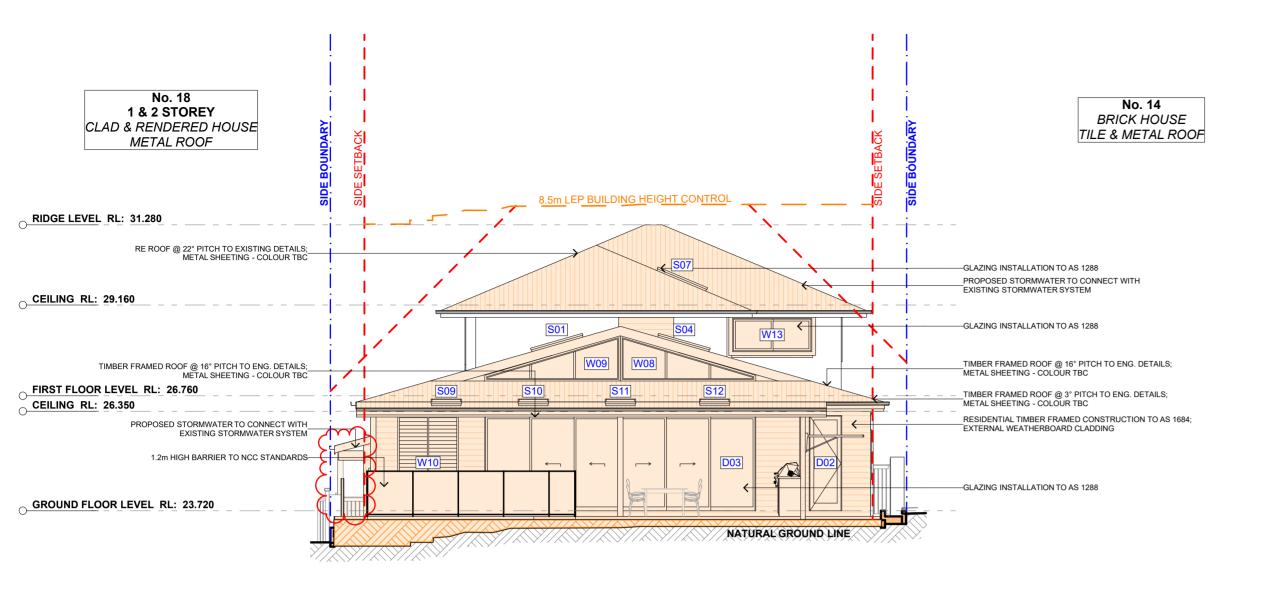		REV.	DATE	COMMENTS	DRWN	
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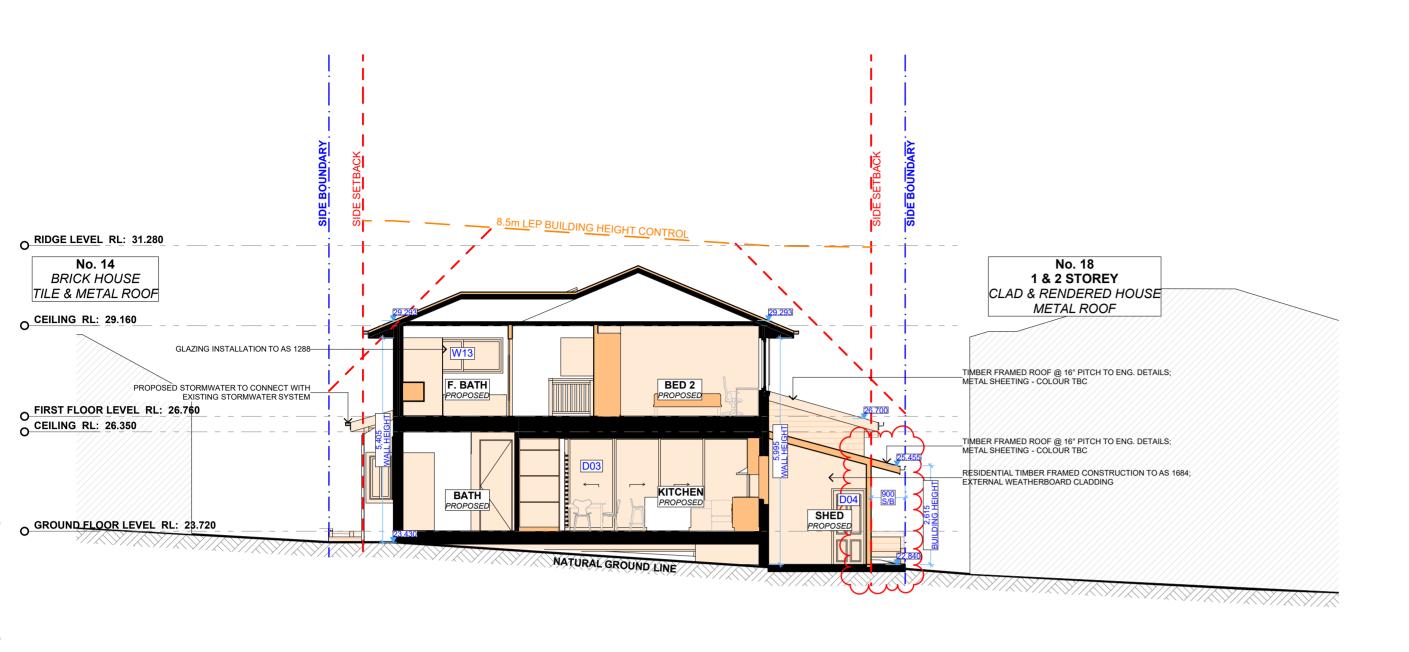
COLLAROY NSW, 2097

DRAWING NO. **DA09**

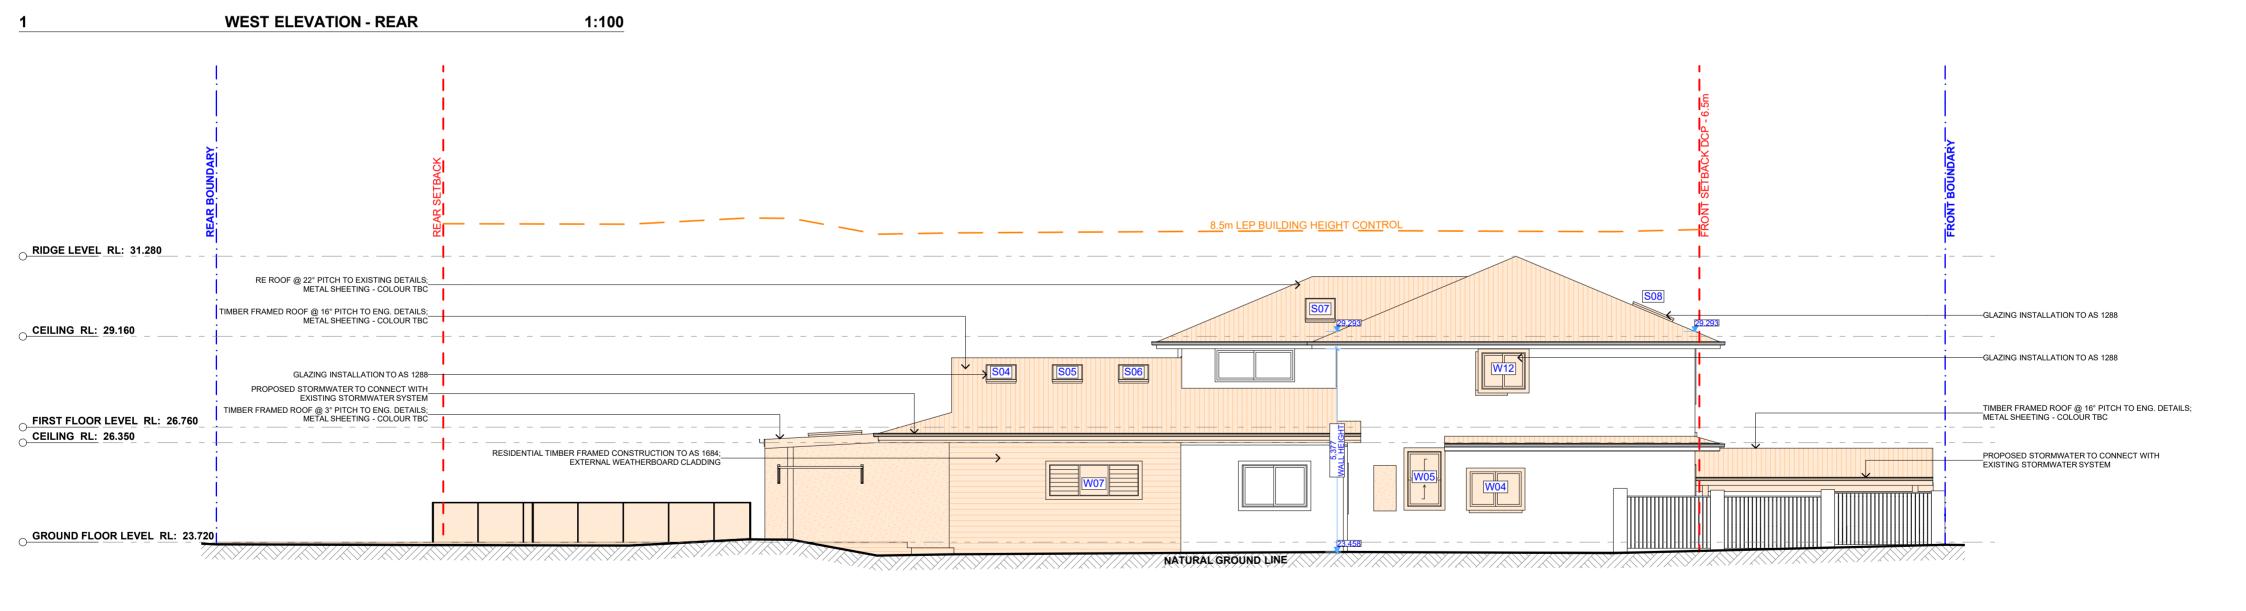
DATE

DRAWING NAME SOUTH / WEST ELEVATION

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PROPOSED LONG SECTION 1:100

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CLIENT ALEXIS AND DEAN HOUDEN

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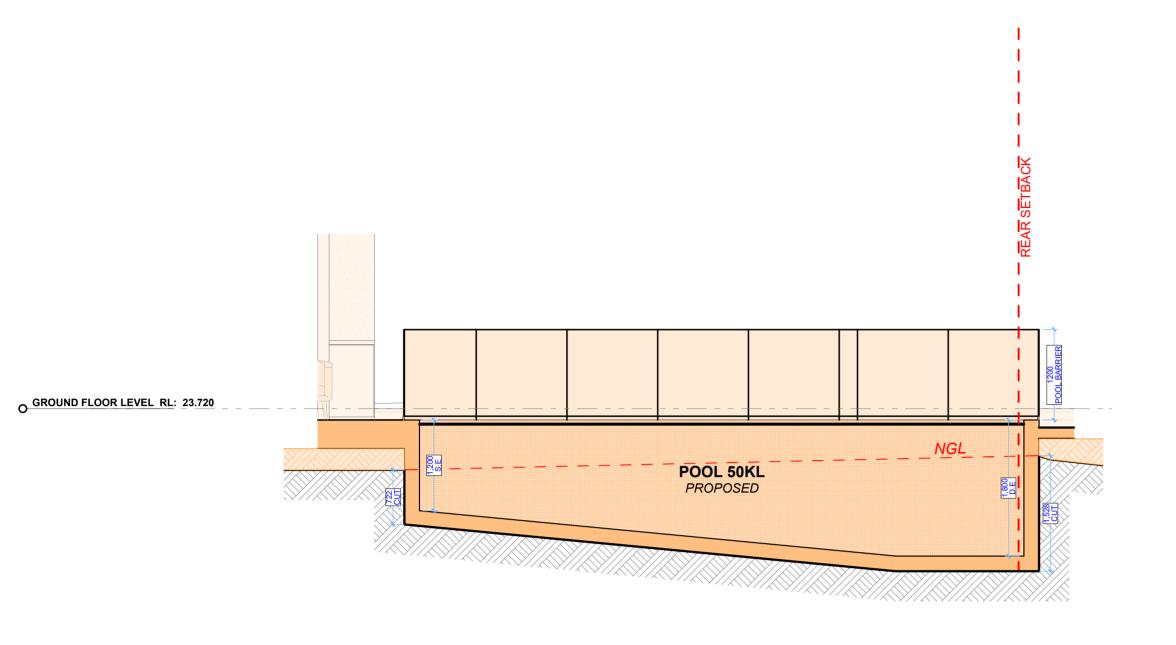
COLLAROY NSW, 2097

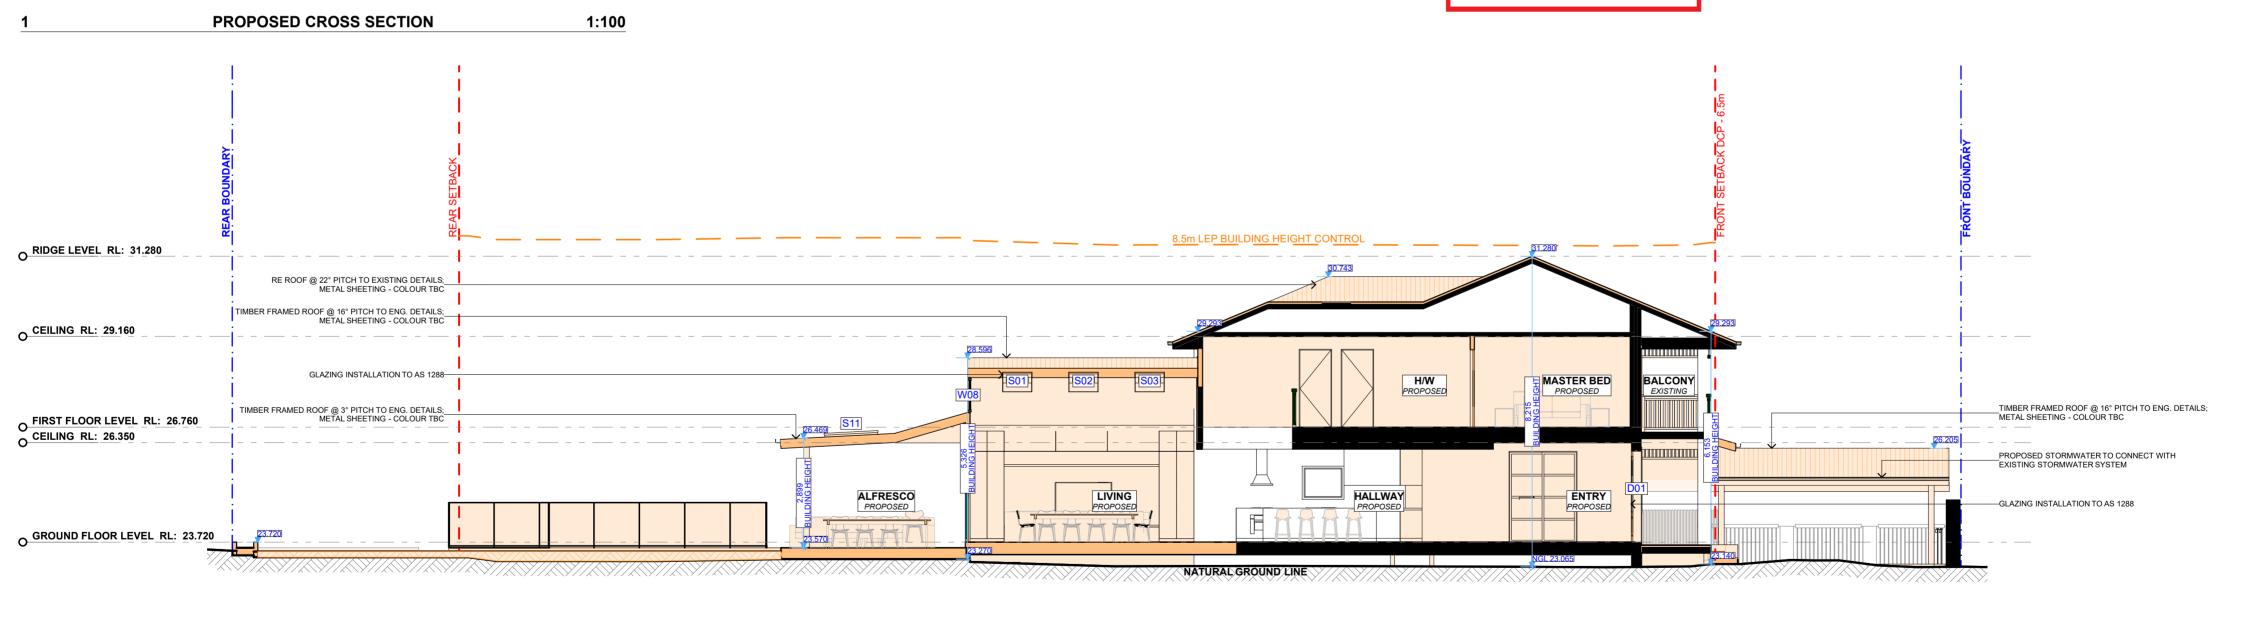DRAWING NO. **DA10**

DATE


DRAWING NAME LONG / CROSS SECTION

SCALE Friday, 1 September 2023 1:100 @A2



DESIGN SPECIFICATION Building Code of Australia (BCA) requirement (for version of BCA applicable as on the date of submission of CDC) Part 3.6 Glazing, requires all glazing to comply with AS 1288-2006 and AS 2047-1999. All glazing including The BCA requires glazing members to comply with Structural Loading Code AS decals shall comply 2280.1-2002. Glass with a high potential for human impact shall strictly comply wit with AS 1288.1-2006, the human impact safety requirements of the BCA. AS 2047-1999 and AS 1170.1-2002 Swimming Pool Safety Part 3.9.3, of the BCA specifies all requirements of swimming pool safety fencing. Compliance with As1926-2012, including 1800mm high boundary fencing acting as Fencing pool fence/barriers, 1200mm high pool fence/barriers shall surround the pool with no doors of the building permitted to open onto pool areas. Any windows shall be sufficiently protected in accordance with AS 1926.1-2012. NCZ shall be provided to all swimming pool safety fence/barriers in accordance with AS1926.1-2012. AS 1288 2006 specifies glazing requirements when glass is incorporated into a pool fence/barrier. Certification post construction will be required. Swimming Pool Part 3.9.4. of the BCA specifies all requirements of swimming pool and spa recirculation systems. AS1926.3-2010 shall be complied with and certified post recirculation Systems

PROPOSED POOL LONG SECTION 1:50 O GROUND FLOOR LEVEL RL: 23.720 POOL 50KL _ _ NGL

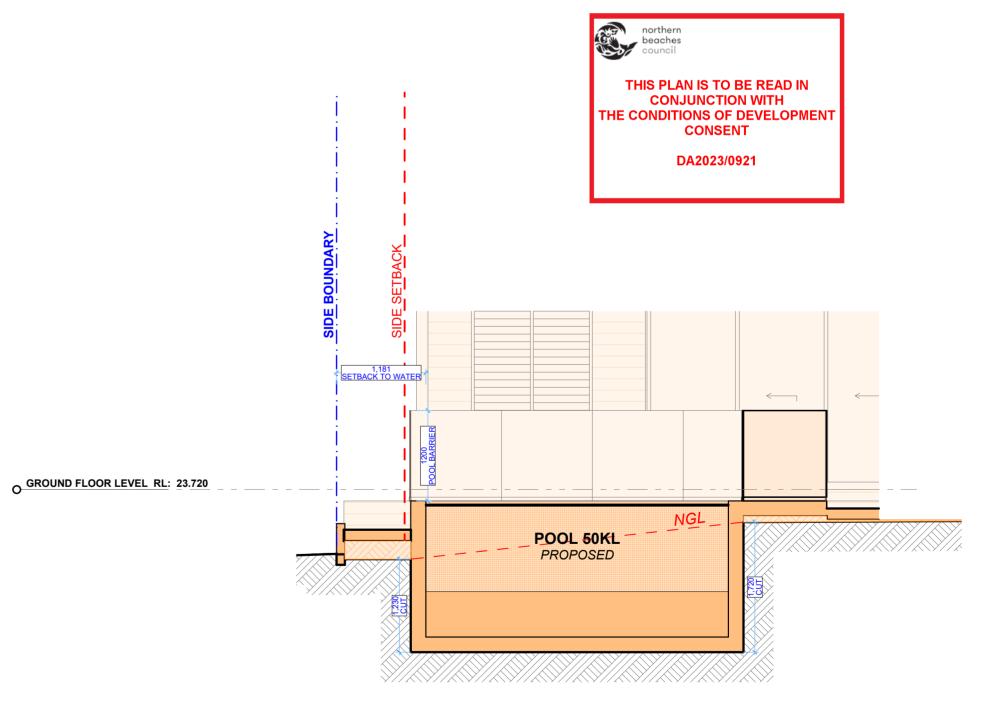

PROPOSED POOL CROSS SECTION 1:50 PROPOSED POOL CROSS SECTION 1:50

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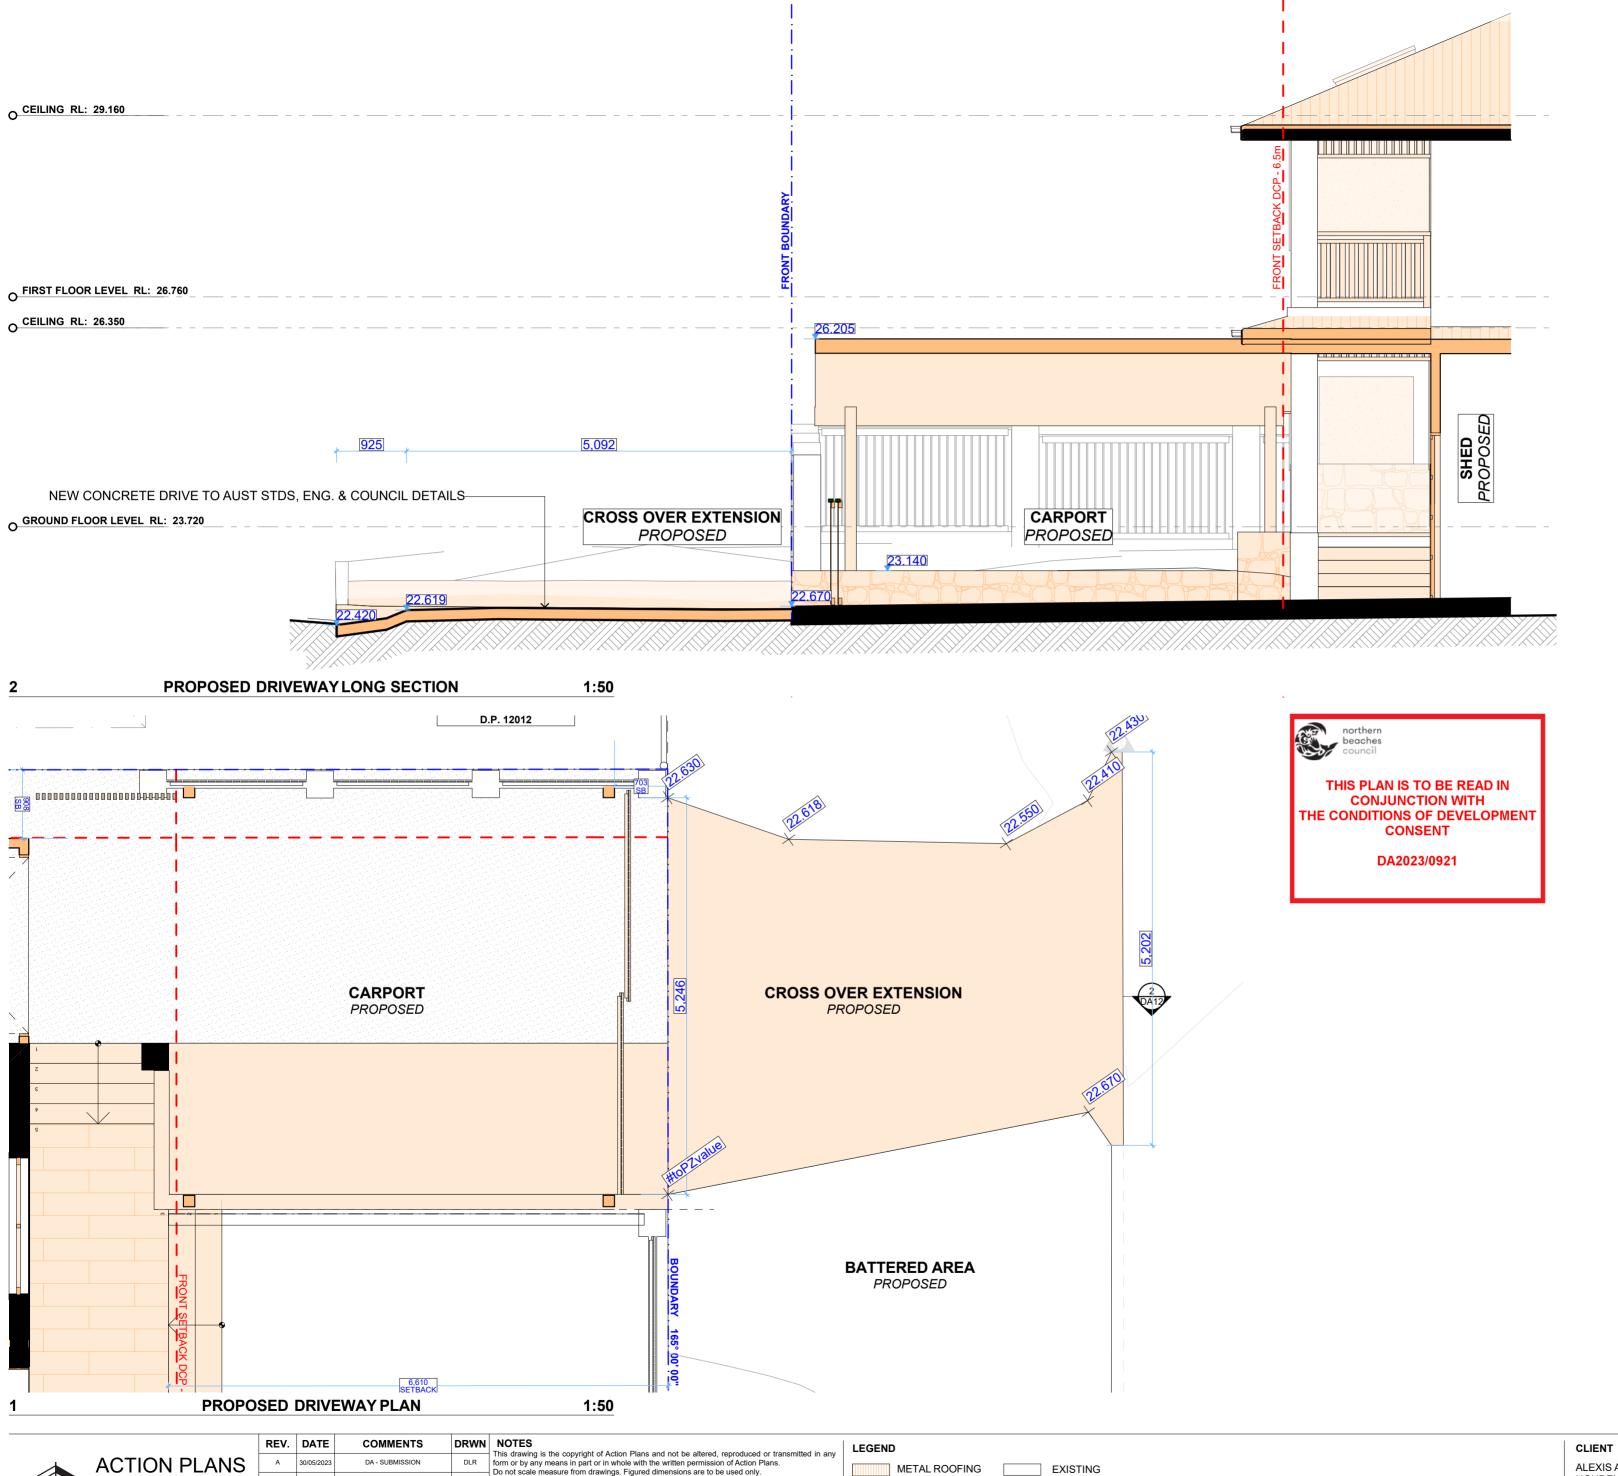
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DRAWING NO. DRAWING NAME POOL SECTIONS **DA11**

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METAL ROOFING TILED ROOFING TIMBER CLAD BRICKWORK

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ALEXIS AND DEAN HOUDEN

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16 WORCESTER ST,

COLLAROY NSW, 2097

DA12

Friday, 1 September 2023

DRAWING NO.

DATE

DRAWING NAME DRIVEWAY PLAN / LONG SECTION

SCALE 1:50 @A2