104.85m²

8.5m

8.25m

DEVELOPMENT DATA

WARRINGAH LEP & DCP 2011

Accessed 30 Nov 2023 at 13:41

PROPOSED GARAGE AREA:

LOT 15 SITE AREA: 593.(m² PROPOSED BASEMENT FLOOR: 75.07m² PROPOSED GROUND FLOOR 172.10m² PROPOSED FIRST FLOOR: 142.24m² PROPOSED PORCH AREA 5.06m² PROPOSED ALFRESCO AREA 41.68m² PROPOSED BALCONY AREA: 13.91m²

PROPOSED FLOOR AREA: REQUIRED MAX. FLOOR AREA: N/A PROPOSED TOTAL FLOOR AREA 389.41m²

LANDSCAPE REQUIRED MIN.40% LANDSCAPE AREA 237.2m² PROPOSED TOTAL LANDSCAPE AREA 237 99m²

PRIVATE OPEN SPACE REQUIRED (MIN. DIMENSIONS 5m): 60 PROPOSED PRIVATE OPEN SPACE 86.4m

SETBACKS FRONT SETBACK 6.5m REAR SETBACK SIDE SETBACK 2.0m - 2.95m

BUILDING HEIGHT PERMITTED MAX. BUILDING HEIGHT PROPOSED MAX. BUILDING HEIGHT:

BASIX COMMITMENTS

FOR DETAILS: SEE THE BASIX CERTIFICATE NO. 1733445S

The applicant must install a rainwater tank of at least 4000 litres. The rainwater tank to collect rain runoff from at least 170 m2 of the roof. The applicant must connect the rainwater tank to:

all toilets in the development
the cold water tap that supplies each clothes washer at least one outdoor tap in the development

Fixtures

Shower heads 3 star (>7.5 but <= 9.0 L/min) ·Toilets...... ·Kitchen tap. ...4 star ...5 star

·Basin Tans 5 star Hot Water System: gas instantaneous with a performance of 5.0 stars /or a

system with a higher energy rating/
Heating/Cooling: In at least 1 living area and 1 bedroom: 3-phase Airconditioning; Energy rating: EER 2.5 - 3.0 (Zoned)

Ventilation ·At least 1 Bathroom: individual fan, ducted to façade or roof; Operation control:

interlocked to light with timer off
-Kitchen: individual fan, ducted to façade or roof; Operation control: manual switch on/off

·Laundry: natural ventilation only, or no laundry; Operation control: n/a Natural lighting

·The applicant must install a window and/or skylight in the kitchen of the dwelling for natural lighting.

·The applicant must install a window and/or skylight in 4 bathroom(s)/toilet(s) in the development for natural lighting. Artificial lighting:

• The applicant must ensure that a minimum of 80% of light fixtures are fitted with fluorescent, compact fluorescent, or light-emitting-diode (LED) lamps. OTHER

The applicant must install a gas cooktop & electric oven in the kitchen of the The applicant must install a fixed outdoor clothes drying line as part of the

development.

The swimming pool must not have a volume greater than 56 kilolitres.

·The swimming pool must be outdoors.

The development must not incorporate any heating system for the swimming

The applicant must install the following pump for the swimming pool in the development, or a pump with higher energy rating: single speed with a performance of 3 stars.

The applicant must install a timer for the swimming pool pump in the

The applicant must install a photovoltaic system as part of the development. The applicant must connect this system to the development's electrical system.

The photovoltaic system must consist of photovoltaic collectors with the capacity to generate at least 2 peak kilowatts of electricity, installed at an angle of 0 degrees to the horizontal facing north.

The Basix certificate should be read in conjunction with the Nathers certificate (including the additional notes pages 4 & 5).

BUILDING ELEMENTS

FOR DETAILS: SEE THE NatHERS CERTIFICATE NO.

Thermal Comfort-Simulation method

A detailed method of assessment with greater flexibility of solution choice and capacity to assess complex dwelling designs.
The dwelling design has been assessed with NatHERS software

External Walls

·Tilt up Concrete, No Insulation
·Tilt Up Concrete, Lined Timber Stud Frame, R2.5 Bulk Insulation ·Cavity Brick, Foil Sided Bubble Wrap, Anti-glare One Side

·Single Skin Brick, R2.5 Bulk Insulation, No Air Gap (Against

Garage)
Single Skin Brick, No Insulation (All Others)

External Floor
Concrete Slab on Ground

·Suspended Floor (Open to Air)- R2.5

Internal Floor/Ceiling
Concrete Timber Framed Above Plasterboard, R2.0 Bulk

Insulation (Above Garage)
Concrete Timber Framed Above Plasterboard, No Insulation (All

External Ceiling

·Concrete, Plasterboard with Timber Frame R5.0 Bulk Insulation Unventilated roofspace Roof

Waterproofing Membrane, No Insulation, Only an Air Gap

Note: All coffer ceiling verticals and walls against the roof-space, t be insulated, with the same insulation as the ceiling insulation

Note: All downlights: IC-F /IC-4/ (insulation covered/ including the control gears/) rated as per AS/NZS standard 60598 and IP (sealed) rated as per BS EN 60529:1992, European IEC

Note: (where the roof is extended over an open area such as a deck or carport): A barrier to be installed within the roof space to separate the space above the zoned part of the house and the space above the open veranda. Note-Ceiling fans: For the number and the location, see the

For additional information please refer to the additional notes on the Nathers certificate.

NO. 8 SUMMIT AVENUE SEWER MANHOLE: 1.75m OFF REAR WALL SETBACK LINE 0.9m OFF SIDE WALL LINE CLOTHES LINE BOUNDARY LINE 0.9m TO INVERT IN 0.98m TO INVERT OUT SEWER MANHOLE UNDER PAVERS NEW DRIVEWAY IN ACCORDANCE WITH COUNCIL REQUIREMENTS EXCAVATED TO ACCESS (SL) AVENUE DRIVEWAY EXISTING TREE TO UMMIT EXISTING TREE TO LANDSCAPE PROPOSED THREE STORE LANDSCAPE POOL PUMF POOL & FILTER 12240 12240 1750 **BOUNDARY LINE** 1.75m OFF REAR WALL NO. 4 SUMMIT AVENUE SITE PLAN

REVISIONS

DESIGNED BY:

RESOLUTE P: (02) 8003 5885 E: Info@resolute.com.au



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CLIENT: MICHAEL HRONOPOULOS & VANESSA ROWED



SITE PLAN


PROPOSED NEW DWELLING


12 HOLLYWOOD STREET, MONTEREY, 2217


SCALE:1:100 @ A3 PLOT DATE: 29.07.2025


DRAWN BY: MAGGIE HASSOUN Dee Why- MD01


MD-100 A

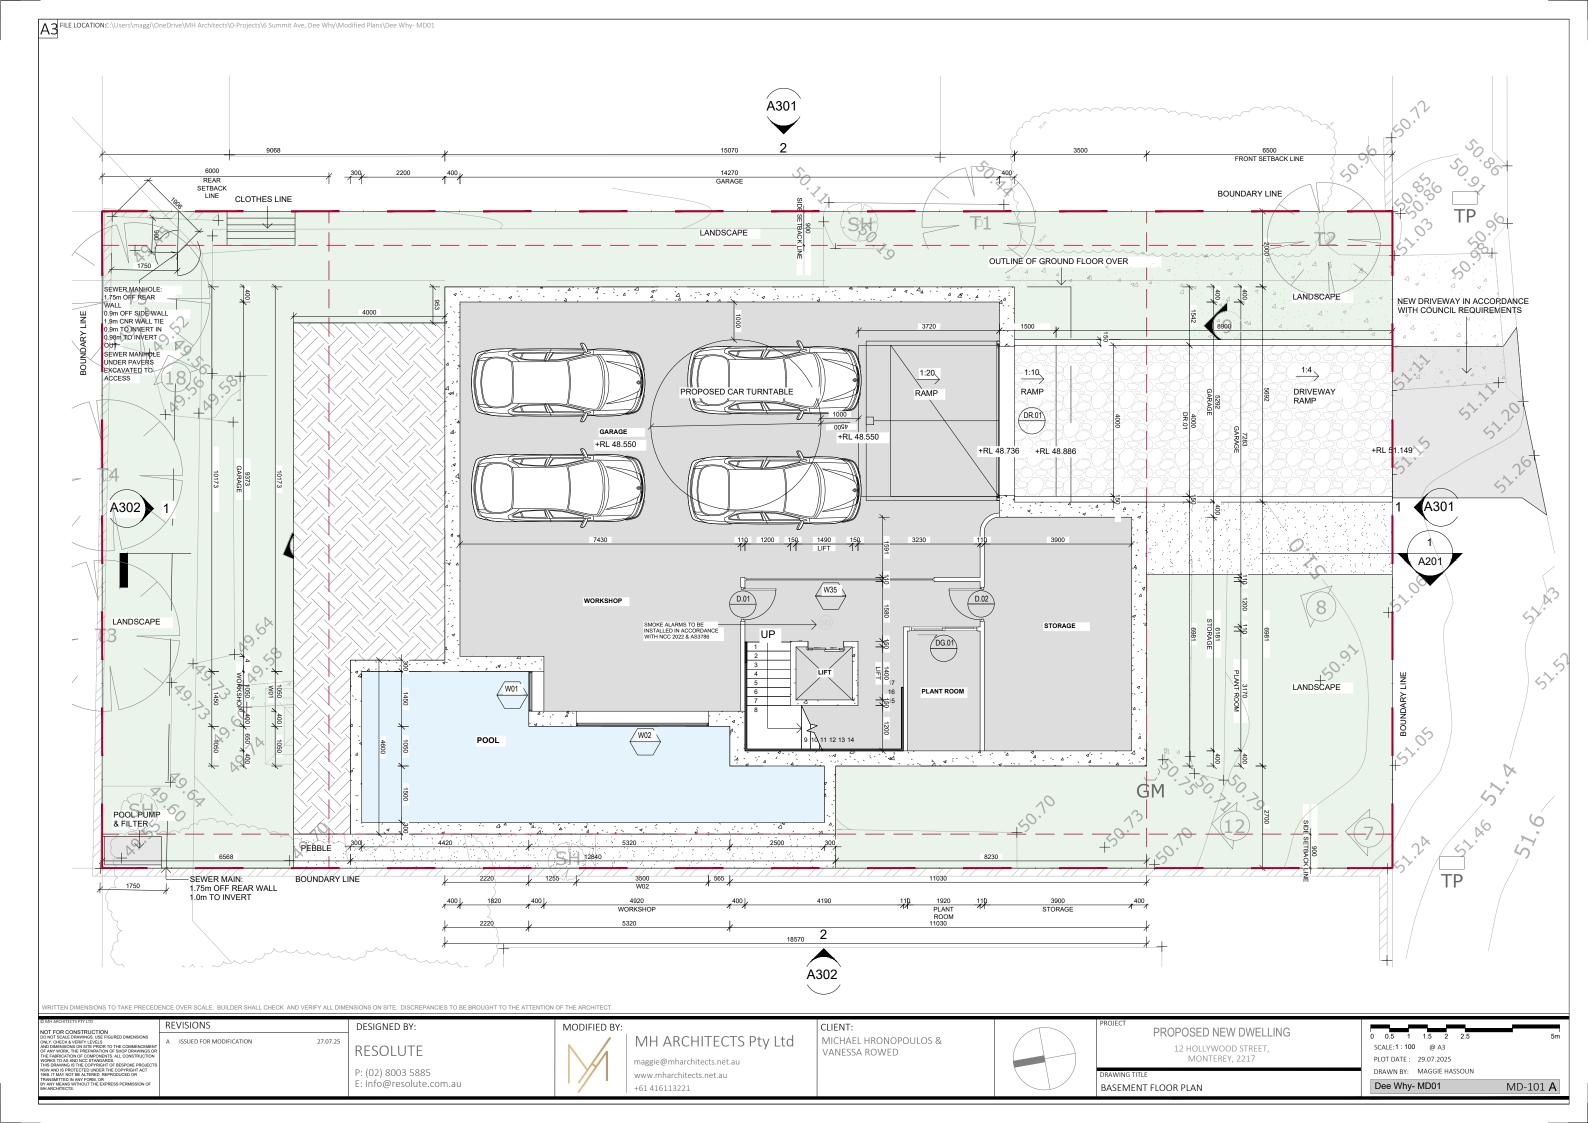

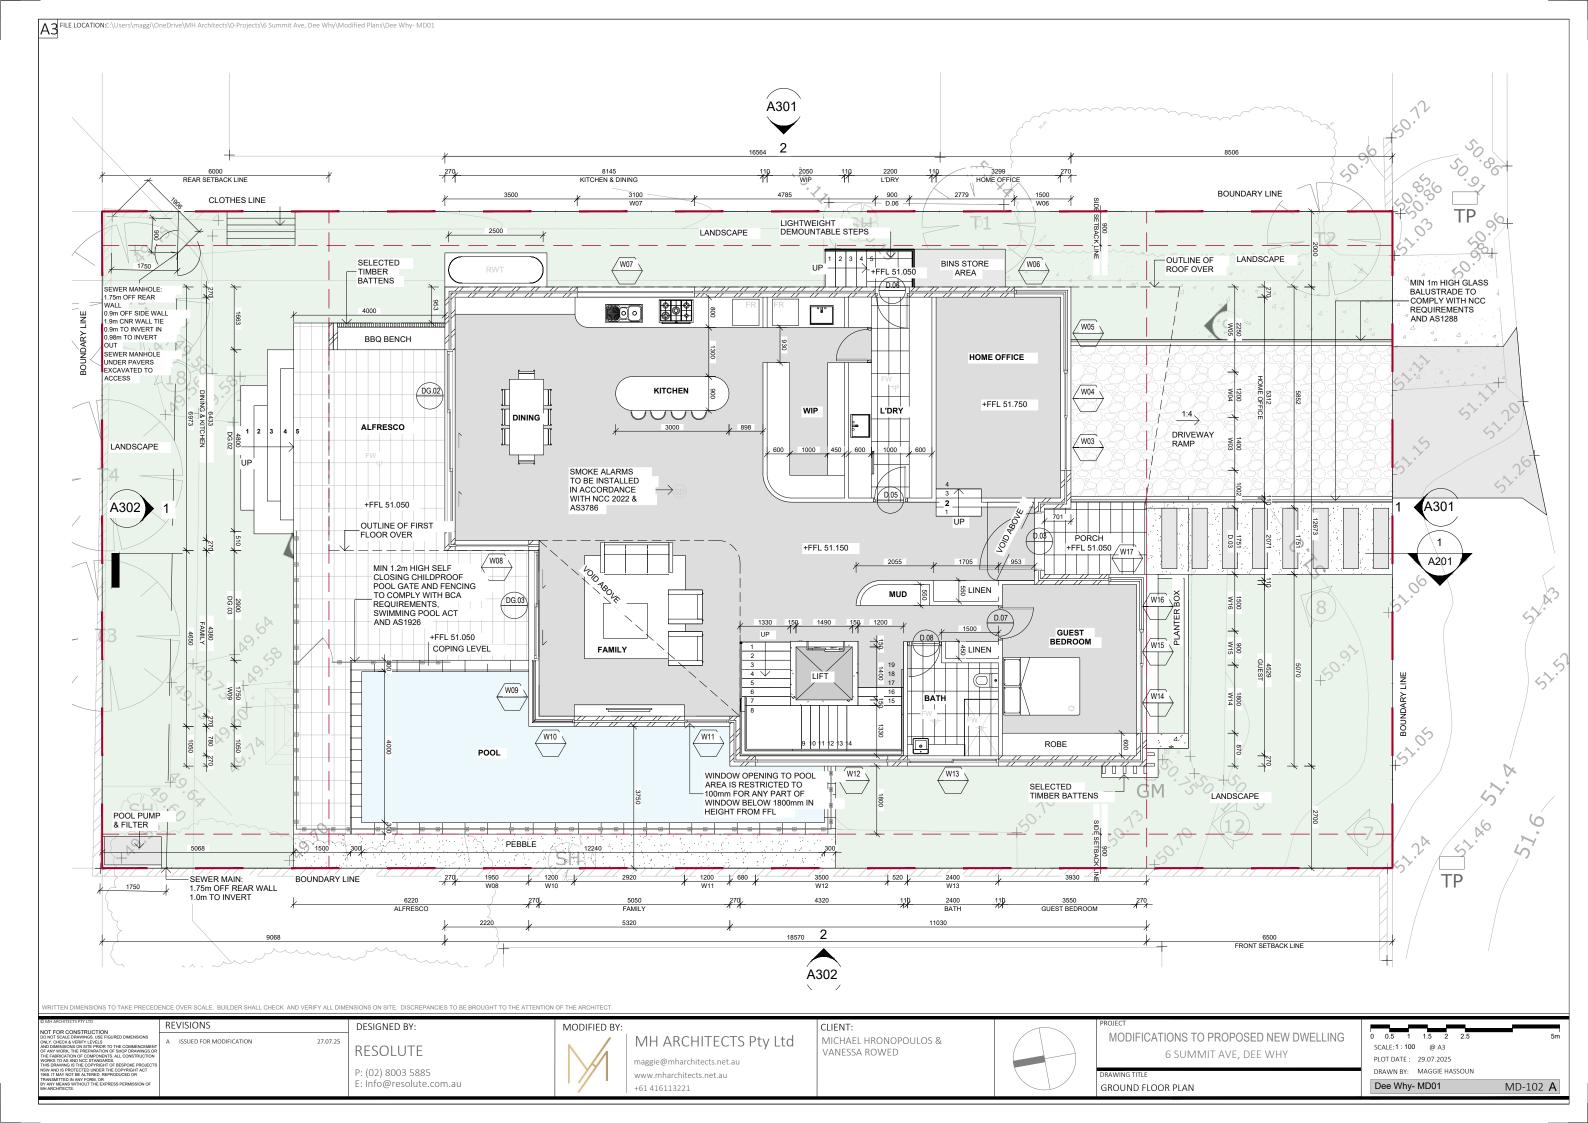

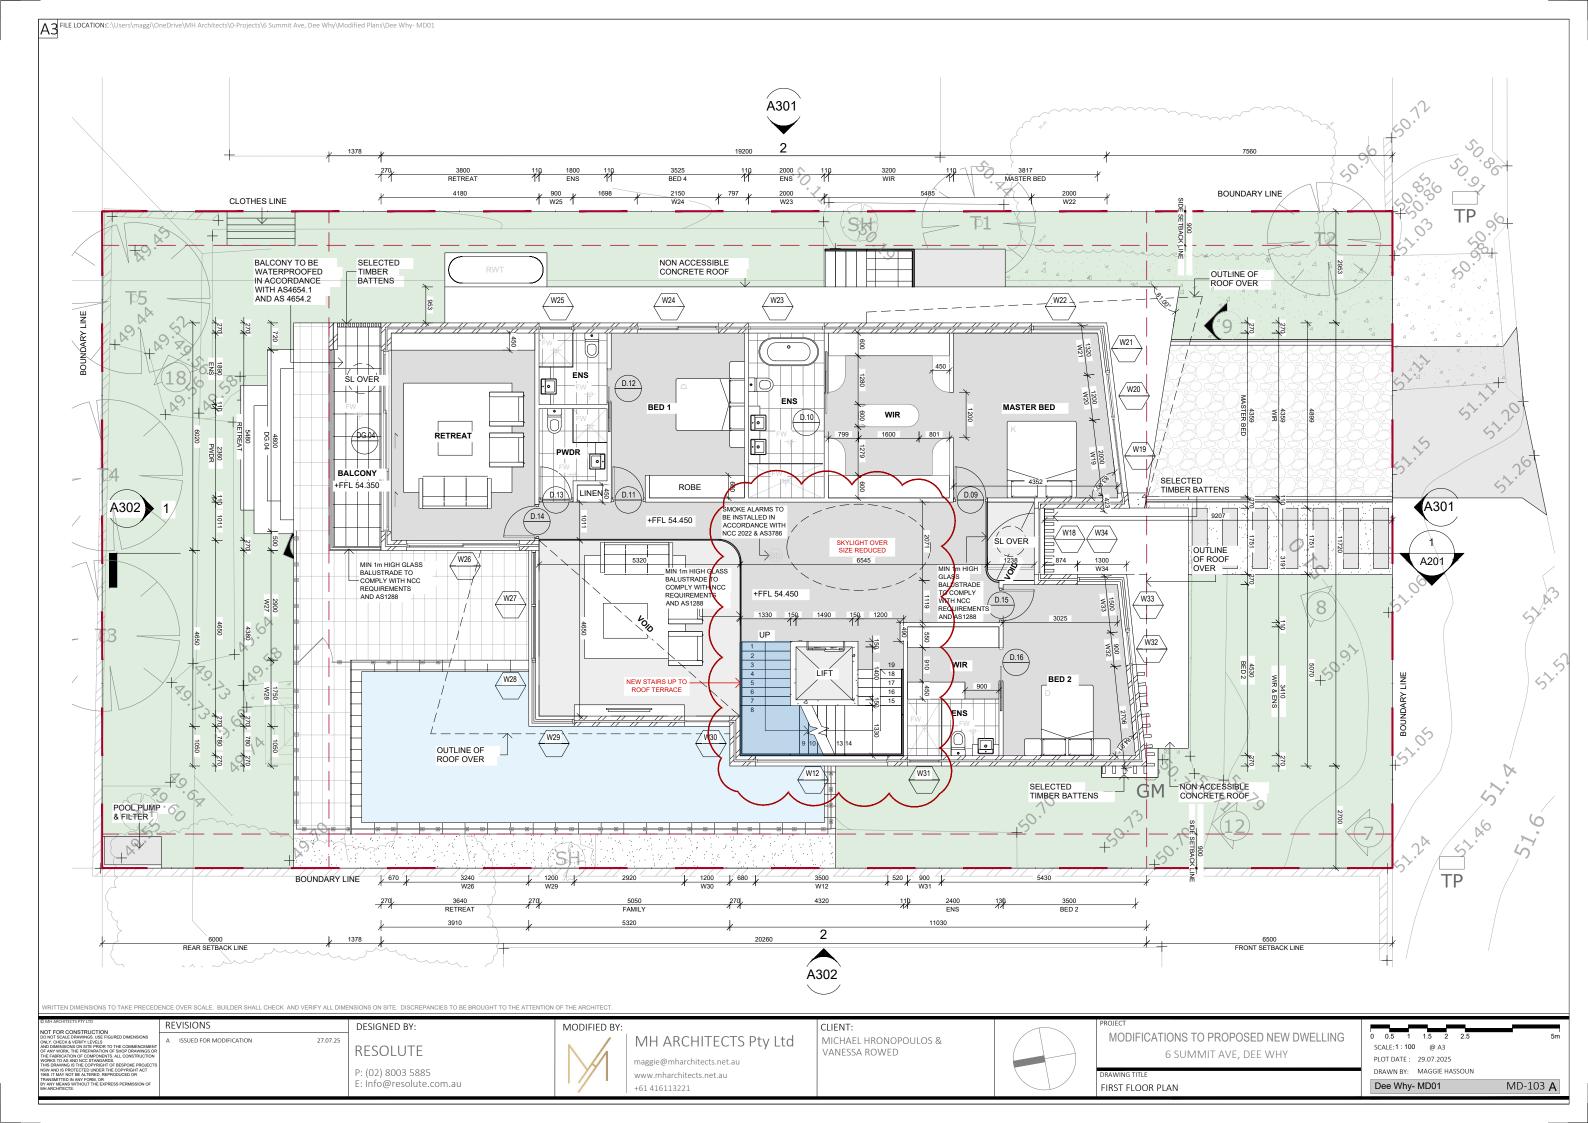

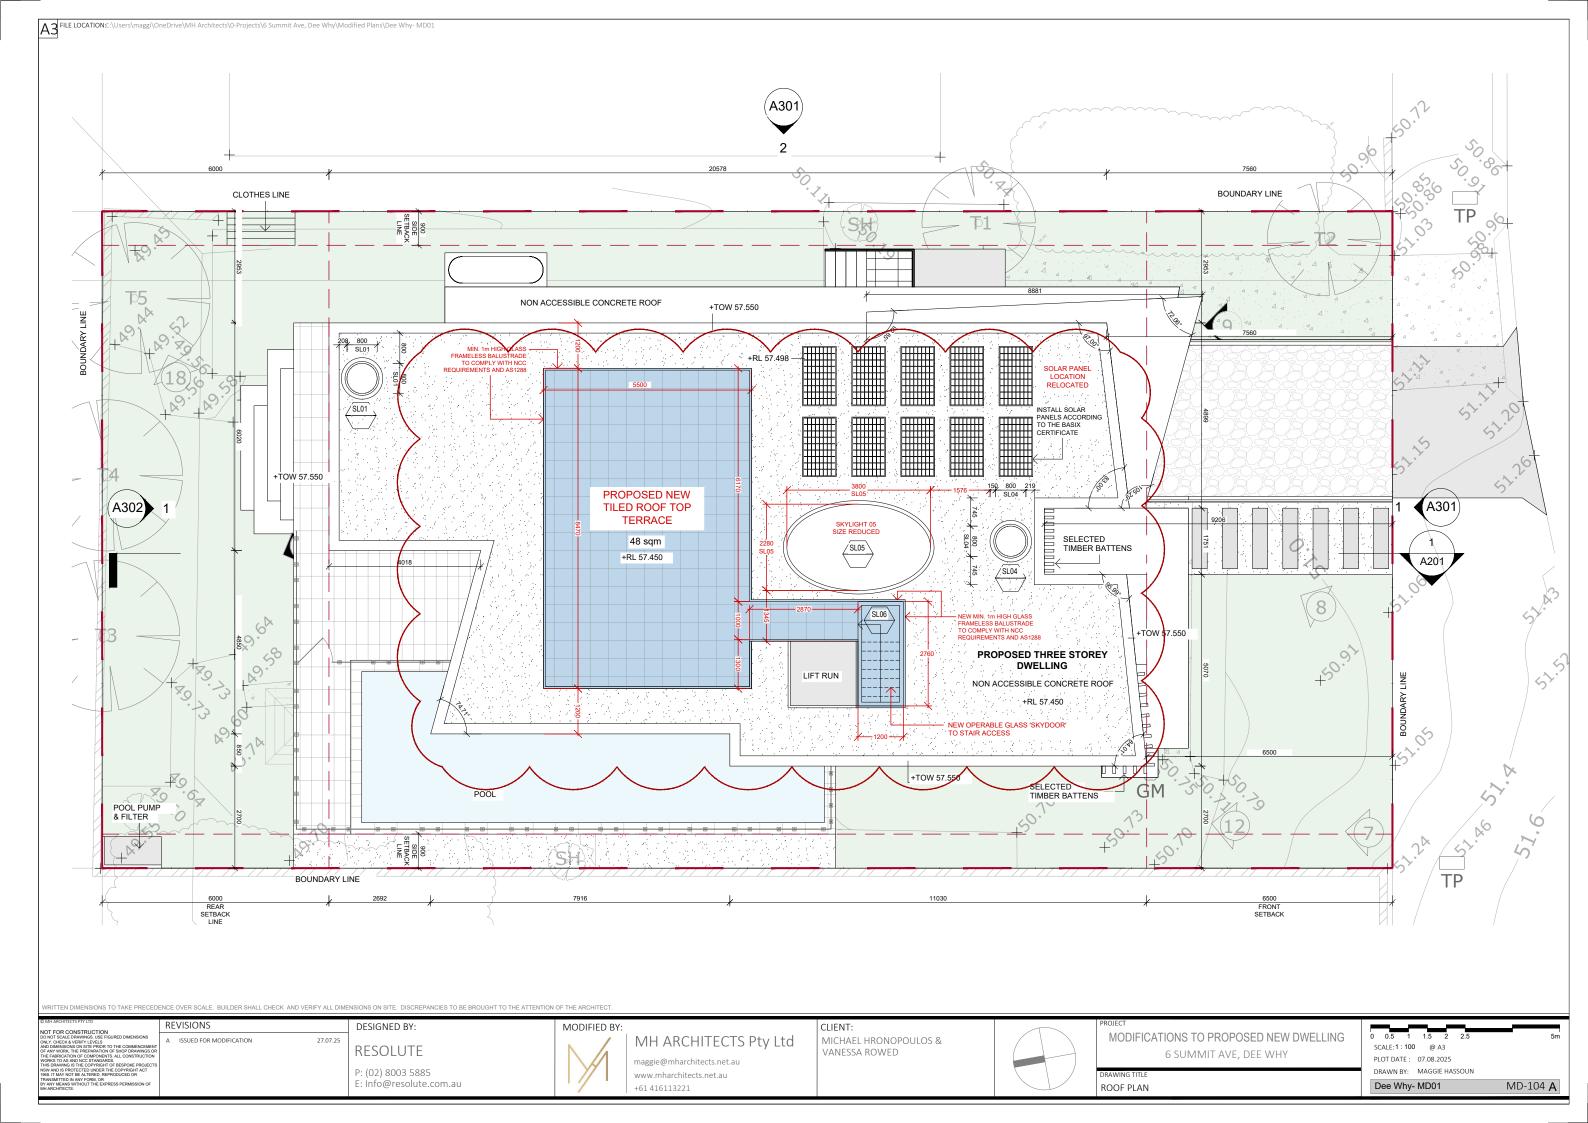

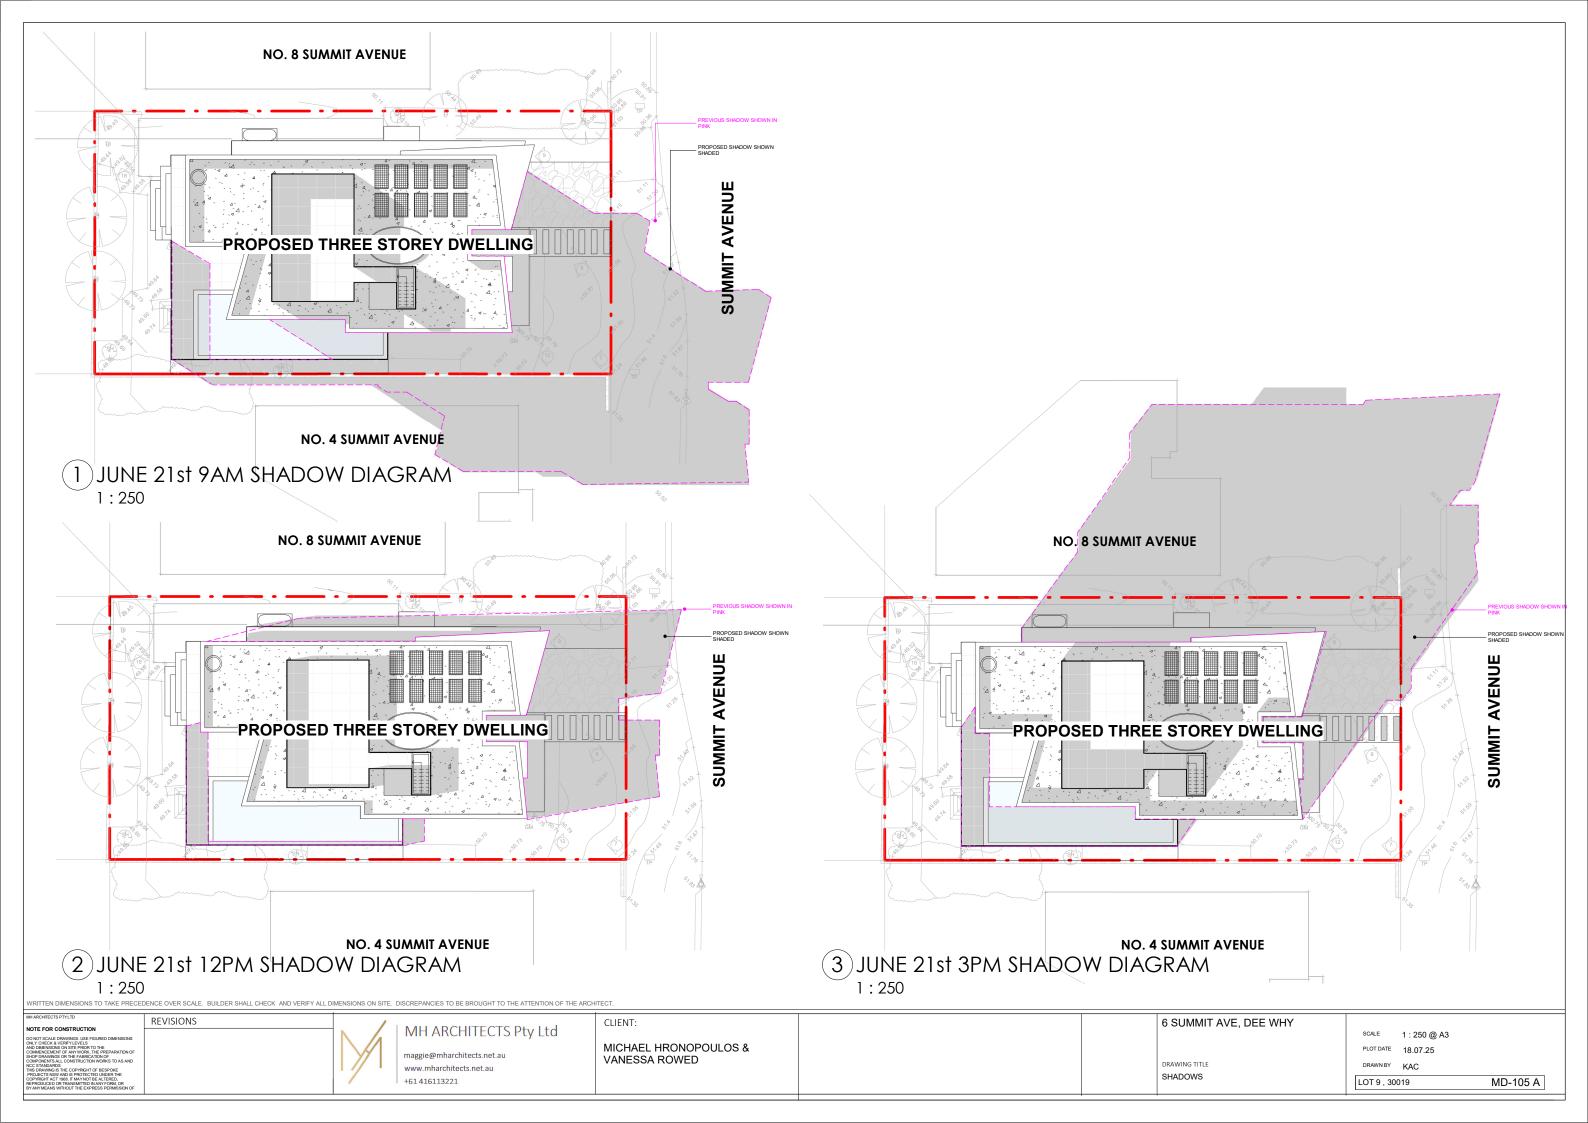

 $\begin{tabular}{ll} A3 & FILE LOCATION {\it C.} \label{table LOCATION C.} \label{table LOCATION C.} \label{table LOCATION C.} \label{table LOCATION C.} \end{tabular} A rehitects $$ \end{tabular} $$ O - Projects $$ 0 - Projects $$$ 0 - Pro$

REVISIONS DESIGNED BY: MODIFIED BY MODIFICATIONS TO PROPOSED NEW DWELLING MH ARCHITECTS Pty Ltd A ISSUED FOR MODIFICATION MICHAEL HRONOPOULOS & SCALE:1:100 @ A3 RESOLUTE VANESSA ROWED 6 SUMMIT AVE, DEE WHY PLOT DATE: 29.07.2025 maggie@mharchitects.net.au P: (02) 8003 5885 E: Info@resolute.com.au DRAWN BY: MAGGIE HASSOUN www.mharchitects.net.au Dee Why- MD01 MD-201 A **BUILDING SECTION** +61 416113221

