DEVELOPMENT APPLICATION - PROPOSED NEW HOUSE & SWIMMING POOL

16 FAIRLIGHT CRESCENT, FAIRLIGHT NSW 2094, OT 9, DP 3742



LOCATION PLAN NSW IMAGERY, SIX MAPS

Landscape Plan

26.10.21 SECTION 4.55

ISSUE DATE

Date 1 DA SUBMISSION

20.05.19 PANEL RECONSIDERATION SUBMISSION

DESCRIPTION

Geotechnical report

SUPPORTING DOCUMENTS Statement of Environmetnal effects Clause 4.6 Variation Stormwater drainage plans

Vaughan Architects Vaughan Architects Quantum Engineer's Edwina Stuart Landscape Architect. Jack Hodgson Consultants Pty Ltd Vaughan Archtiects

Thermal Comfort Commitments	Show on DA plans	Show on CC/CDC plans & specs	Certifier check
General features			
The dwelling must not have more than 2 storeys.	~	~	V
The conditioned floor area of the dwelling must not exceed 300 square metres.	~	~	-
The dwelling must not contain open mezzanine area exceeding 25 square metres.	~	~	-
The dwelling must not contain third level habitable attic room.	~	~	V
Floor, walls and ceiling/roof	100		
The applicant must construct the floor(s), walls, and ceiling/roof of the dwelling in accordance with the specifications listed in the table below.	-	~	~

Construction	Additional insulation required (R-Value)	Other specifications
floor - concrete slab on ground, 169 square metres	nil	
floor - above habitable rooms or mezzanine, 140 square metres, concrete	nil	
floor - suspended floor above garage, concrete	nil	in-slab heating system
external wall - brick veneer	1.86 (or 2.40 including construction)	
external wall - framed (weatherboard, fibre cement, metal clad)	2.00 (or 2.40 including construction)	
external wall - cavity brick	0.50 (or 1.17 including construction)	
ceiling and roof - flat ceiling / flat roof, concrete/plasterboard	ceiling: 4.5 (up), roof: foil backed blanket (100 mm)	concrete/plasterboard internal; dark (solar absorptance > 0.70)

Skylight no.	Maximum area (square metres)	Туре	Shading device	
S01	0.20	timber, low-E/double/argon fill	adjustable louvre	
Skylight no.	Maximum area (square metres)	Туре	Shading device	
S02	0.50	timber, low-E/double/argon fill	adjustable louvre	

Window/glazed door no.	Maximum height (mm)	Maximum width (mm)	Туре	Shading Device (Dimension within 10%)	Overshadowing
North-East facing					
G11	2400	600	U-value: 2, SHGC: 0.279 - 0.341 (timber/UPVC/fibreglass, double (argon), Hi-Tsol Low-e/clear)	none	>4 m high, 2-5 m away
F10	700	2400	aluminium, single, clear	solid overhang 900 mm, 0 mm above head of window or glazed door	>4 m high, 2-5 m away
G6	1800	2000	U-value: 2.2, SHGC: 0.351 - 0.429 (composite, double (argon), Lo-Tsol Low-e/clear)	external louvre/vertical blind (fixed)	>4 m high, 2-5 m away
G4	2400	3400	U-value: 2, SHGC: 0.207 - 0.253 (timber/UPVC/fibreglass, double (argon), Lo-Tsol Low-e/clear)	solid overhang 5000 mm, 0 mm above head of window or glazed door	>4 m high, 2-5 m away
G8	2160	500	U-value: 4.3, SHGC: 0.450 - 0.550 (timber/UPVC/fibreglass, single, Hi-Tsol Low-e)	none	>4 m high, 2-5 m away
F8	700	1400	aluminium, single, clear	solid overhang 900 mm, 0 mm above head of window or glazed door	>4 m high, 2-5 m away
G7	2505	500	U-value: 2.2, SHGC: 0.351 - 0.429 (composite, double (argon), Lo-Tsol Low-e/clear)	external louvre/vertical blind (adjustable)	>4 m high, 2-5 m away
G10	600	1700	U-value: 2, SHGC: 0.279 - 0.341 (timber/UPVC/fibreglass, double (argon), Hi-Tsol Low-e/clear)	none	>4 m high, 2-5 m away
G9	2100	900	U-value: 2.2, SHGC: 0.288 - 0.352 (composite, double (argon), Lo-Tsol Low-e/clear)	solid overhang 500 mm, 0 mm above head of window or glazed door	>4 m high, 2-5 m away
F5	1550	1200	aluminium, single, clear	eave 1200 mm, 0 mm above head of window or glazed door	not overshadowed

			320	window or glazed door	
South-East facin	ng				
G3	2000	550	U-value: 2, SHGC: 0.279 - 0.341 (timber/UPVC/fibreglass, double (argon), Hi-Tsol Low-e/clear)	solid overhang 1200 mm, 0 mm above head of window or glazed door	not overshadowed
G2	2000	3100	U-value: 2.2, SHGC: 0.351 - 0.429 (composite, double (argon), Lo-Tsol Low-e/clear)	solid overhang 1200 mm, 0 mm above head of window or glazed door	not overshadowed
F11	1550	700	aluminium, single, clear	eave 1200 mm, 0 mm above head of window or glazed door	not overshadowed
F3	1800	500	U-value: 5.4, SHGC: 0.522 - 0.638 (aluminium, single, Hi-Tsol Low-e)	solid overhang 1300 mm, 0 mm above head of window or glazed door	not overshadowed
F7	1550	700	aluminium, single, clear	eave 1200 mm, 0 mm above head of window or glazed door	not overshadowed
F2	2400	3200	U-value: 5.4, SHGC: 0.522 - 0.638 (aluminium, single, Hi-Tsol Low-e)	solid overhang 1350 mm, 0 mm above head of window or glazed door	not overshadowed
F9	1550	700	aluminium, single, clear	eave 1200 mm, 0 mm above head of window or glazed door	not overshadowed
G5	2400	4600	U-value: 4.3, SHGC: 0.450 - 0.550 (timber/UPVC/fibreglass, single, Hi-Tsol Low-e)	solid overhang 5000 mm, 0 mm above head of window or glazed door	not overshadowed
F6	1550	700	aluminium, single, clear	eave 1200 mm, 0 mm above head of window or glazed door	not overshadowed
G1	2200	350	U-value: 2.2, SHGC: 0.351 - 0.429 (composite, double (argon), Lo-Tsol Low-e/clear)	solid overhang 2600 mm, 0 mm above head of window or glazed door	not overshadowed
F4	1800	4300	U-value: 5.4, SHGC: 0.522 - 0.638 (aluminium, single, Hi-Tsol Low-e)	solid overhang 1300 mm, 0 mm above head of window or glazed door	not overshadowed
F1	1600	1100	U-value: 5.4, SHGC: 0.522 - 0.638 (aluminium, single, Hi-Tsol Low-e)	solid overhang 1700 mm, 0 mm above head of window or glazed door	not overshadowed
South-West facil	ng				
F17	950	2300	U-value: 5.4, SHGC: 0.522 - 0.638 (aluminium, single, Hi-Tsol Low-e)	eave 1550 mm, 0 mm above head of window or glazed door	not overshadowed
F20	1800	1100	U-value: 5.4, SHGC: 0.522 - 0.638 (aluminium, single, Hi-Tsol Low-e)	eave 5000 mm, 0 mm above head of window or glazed door	not overshadowed
G14	2700	1500	U-value: 5.4, SHGC: 0.522 - 0.638 (aluminium, single, Hi-Tsol Low-e)	external louvre/vertical blind (adjustable)	not overshadowed
F16	2500	600	U-value: 5.4, SHGC: 0.522 - 0.638 (aluminium, single, Hi-Tsol Low-e)	none	not overshadowed
F15	2500	3000	U-value: 5.4, SHGC: 0.522 - 0.638 (aluminium, single, Hi-Tsol Low-e)	external louvre/vertical blind (adjustable)	not overshadowed
G13	2700	2700	U-value: 5.4, SHGC: 0.522 - 0.638 (aluminium, single, Hi-Tsol Low-e)	external louvre/vertical blind (adjustable)	not overshadowed
F19	1600	1200	aluminium, single, clear	eave 670 mm, 0 mm above head of window or glazed door	not overshadowed
North-West facil	ng				ATT.
G12	2200	800	U-value: 5.4, SHGC: 0.441 - 0.539 (aluminium, single, Hi-Tsol Low-e)	external louvre/vertical blind (adjustable)	not overshadowed
G16	2700	4800	U-value: 4.3, SHGC: 0.450 - 0.550 (timber/UPVC/fibreglass, single, Hi-Tsol Low-e)	solid overhang 4300 mm, 0 mm above head of window or glazed door	not overshadowed
F18	2400	3800	U-value: 5.4, SHGC: 0.522 - 0.638 (aluminium, single, Hi-Tsol Low-e)	solid overhang 2400 mm, 0 mm above head of window or glazed door	not overshadowed
F13	2400	500	U-value: 5.4, SHGC: 0.522 - 0.638 (aluminium, single, Hi-Tsol Low-e)	eave 1400 mm, 0 mm above head of window or glazed door	not overshadowed
F14	1500	2200	U-value: 5.4, SHGC: 0.522 - 0.638 (aluminium, single, Hi-Tsol Low-e)	external louvre/vertical blind (adjustable)	not overshadowed

	DA DRAWING LIST	
Sheet Number	Sheet Name	Current Revision

COVER SHEET & LOCATION PLAN	9	
SITE ANALYSIS PLAN	6	
SITE & ROOF PLAN	7	
PROPOSED BASEMENT PLAN	9	
PROPOSED GROUND FLOOR & SWIMMING POOL PLAN	9	
PROPOSED FIRST FLOOR PLAN	9	
NORTH & SOUTH ELEVATIONS	9	
EAST & WEST ELEVATIONS	9	
SECTIONS	9	
SWIMMING POOL / BASEMENT RUMPUS SECTIONS	9	
GFA CALCULATIONS	9	
EXCAVATION PLAN	1	
SHADOW DIAGRAMS - JUNE 21 9AM	6	
SHADOW DIAGRAMS - JUNE 21 12PM	6	
SHADOW DIAGRAMS - JUNE 21 3PM	6	
SCHEDULE OF COLOURS AND FINISHES - EXTERNAL	8	
DIGITAL MODEL IMAGES	6	
DIGITAL MODEL IMAGES	6	
PHOTO MONTAGE (SUPERSEDED)	2	
NOTIFICATION PLAN	6	
OPEN SPACE & LANDSCAPE AREA PLANS	6	
ROOF PLAN WITH POLE SURVEY		
	SITE ANALYSIS PLAN SITE & ROOF PLAN PROPOSED BASEMENT PLAN PROPOSED GROUND FLOOR & SWIMMING POOL PLAN PROPOSED FIRST FLOOR PLAN NORTH & SOUTH ELEVATIONS EAST & WEST ELEVATIONS SECTIONS SWIMMING POOL / BASEMENT RUMPUS SECTIONS GFA CALCULATIONS EXCAVATION PLAN SHADOW DIAGRAMS - JUNE 21 9AM SHADOW DIAGRAMS - JUNE 21 12PM SHADOW DIAGRAMS - JUNE 21 3PM SCHEDULE OF COLOURS AND FINISHES - EXTERNAL DIGITAL MODEL IMAGES PHOTO MONTAGE (SUPERSEDED) NOTIFICATION PLAN OPEN SPACE & LANDSCAPE AREA PLANS	SITE ANALYSIS PLAN SITE & ROOF PLAN PROPOSED BASEMENT PLAN PROPOSED GROUND FLOOR & SWIMMING POOL PLAN PROPOSED FIRST FLOOR PLAN NORTH & SOUTH ELEVATIONS EAST & WEST ELEVATIONS SECTIONS SWIMMING POOL / BASEMENT RUMPUS SECTIONS GFA CALCULATIONS EXCAVATION PLAN SHADOW DIAGRAMS - JUNE 21 9AM SHADOW DIAGRAMS - JUNE 21 12PM SHADOW DIAGRAMS - JUNE 21 3PM SCHEDULE OF COLOURS AND FINISHES - EXTERNAL DIGITAL MODEL IMAGES DIGITAL MODEL IMAGES PHOTO MONTAGE (SUPERSEDED) NOTIFICATION PLAN 6 OPEN SPACE & LANDSCAPE AREA PLANS 6

ABOVE FLOOR LEVEL
AIR CONDITIONING FLOOR GRILL AC FG:

ALARM SENSOR STANDING SEAM COLORBOND CLADDING

BOX GUTTER BALUSTRADE BG: BAL:

BRICK LIGHT RECESSED CLOTHES LIINE OFF FORM CONCRETE

CL: CO: CT: CP: CB: DP: DIM: D1.1: COOK TOP CONCRETE BLOCK DOWNPIPE DIMMER DOOR No

DISH WASHER FACE BRICK
FLUSH SET FIBRES CEMENT SHEET CLADING WITH SKIM COAT AND PAINT FINISH

AIRCONDITIONING UNIT IN CEILING

FLB: TIMBER FLOOR BOARDS FR: **FRIDGE**

FLOOR TILE

FIXED PANEL (glazing/joinery panel)
SS SMART TILE FLOOR WASTE, (allow required set downs to suit)

GB: GAS B: GLASS BALUSTRADE

GAS BAYONET INSTANT GAS HOTWATER SERVICE

JOINERY (number) AC LINEAL DIFFUSER LINEN CUPBOARD J(1.1): LD: SOFT LANDSCAPING

MEDICINE CABINET METAL DECK ROOF SHEETING

MD: MX: MIXER TAP

PB: PEBBLE FINISH

SET PLASTERBOARD, PAINT FINISH EXTERNAL PAVING TILE TELEPHONE POINT

RENDERED MASONRY

REDUCED LEVEL RENDERED SLAB EDGE

RAIN WATER OUTLET CAST INTO SLAB RWO: SUSPENDED PLASTERBOARD CEILING SHOWER ROSE, 3 STAR WATER RATING

SK: SMH:

SEWER MAN HOLE CONCRETE SLAB SOFFIT EXPOSED SOF: TAP SPOUT, WALL MOUNTED

MOVABLE GARDEN SPIKE LIGHT STAINLESS STEEL STONE TILE


LAUNDRY TUB TIMBER CLADDING AS SPECIFIED TIMBER DECKING AS SPECIFIED

TOP OF GUTTER TIMBER STUD TV: TELEVISION POINT VANITY WITH BASINS VILLA BOARD, PAINT FINISH

W(1.1): WINDOW (number) WASHING MACHINE

\$	vaughan architects a. studio 6/13-15 smail st, ultimo 2007 nsw m. simon vaughan 0414 996 271 simon@vaughanarchitects.com.au www.vaughanarchitects.com.au
	abn. 89 644 086 413

	PROJECT: 16 FAIRLIGHT CRESCENT, NSW 2094 LOT 9 DP 3742	COVER SHEET & LOCATION PLAN				DRAWING NO:	
au	NOTES: 1. Use only figured dimensions, do not scale drawings. 2. All discrepancies and omissions to be referred to Vaughan Architects Pty Ltd prior to construction. 3. Check all dimensions, Building Good of Australia, relevant codes and council approvals. Copyright remains the property of Vaughan Architects. Reproduction of the whole or part of this document constitutes an infringement of copyright.	SCALE: @ A2 1:100	DATE: 26.10.21	DRAWN BY:		ISSUE: C	1801

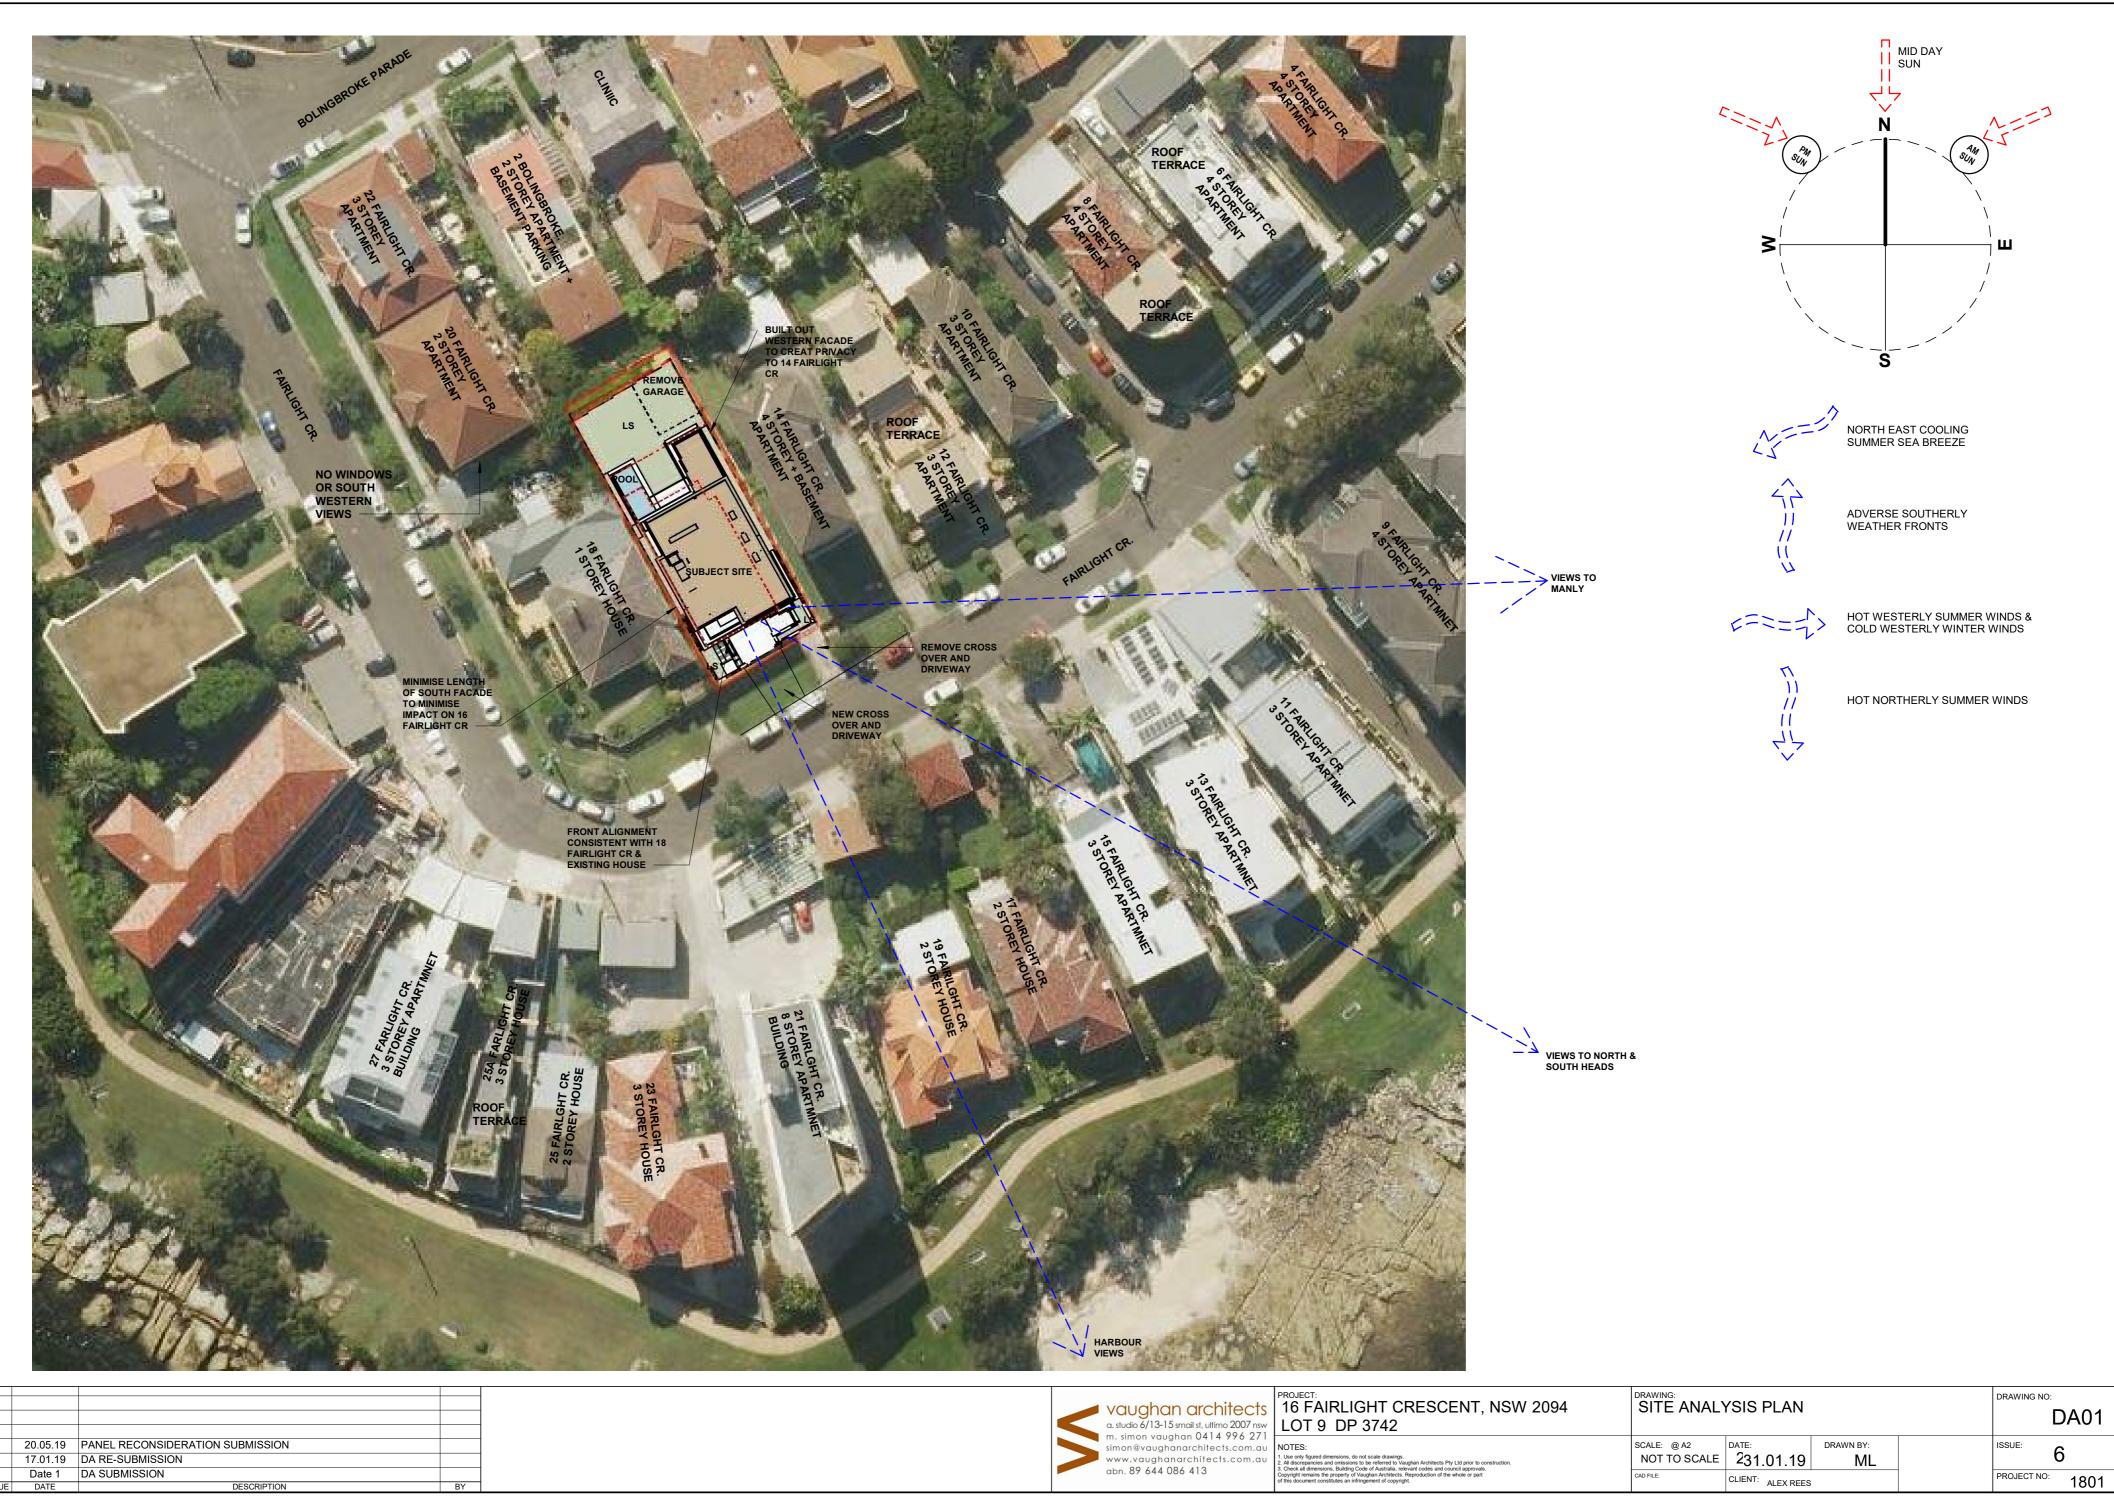

 6
 20.05.19
 PANEL RECONSIDERATION SUBMISSION

 3
 17.01.19
 DA RE-SUBMISSION

 1
 Date 1
 DA SUBMISSION

 ISSUE
 DATE
 DESCRIPTION


1801


PROJECT NO:


SCALE: @ A2 DATE: NOT TO SCALE 231.01.19


CLIENT: ALEX REES


DRAWN BY: ML

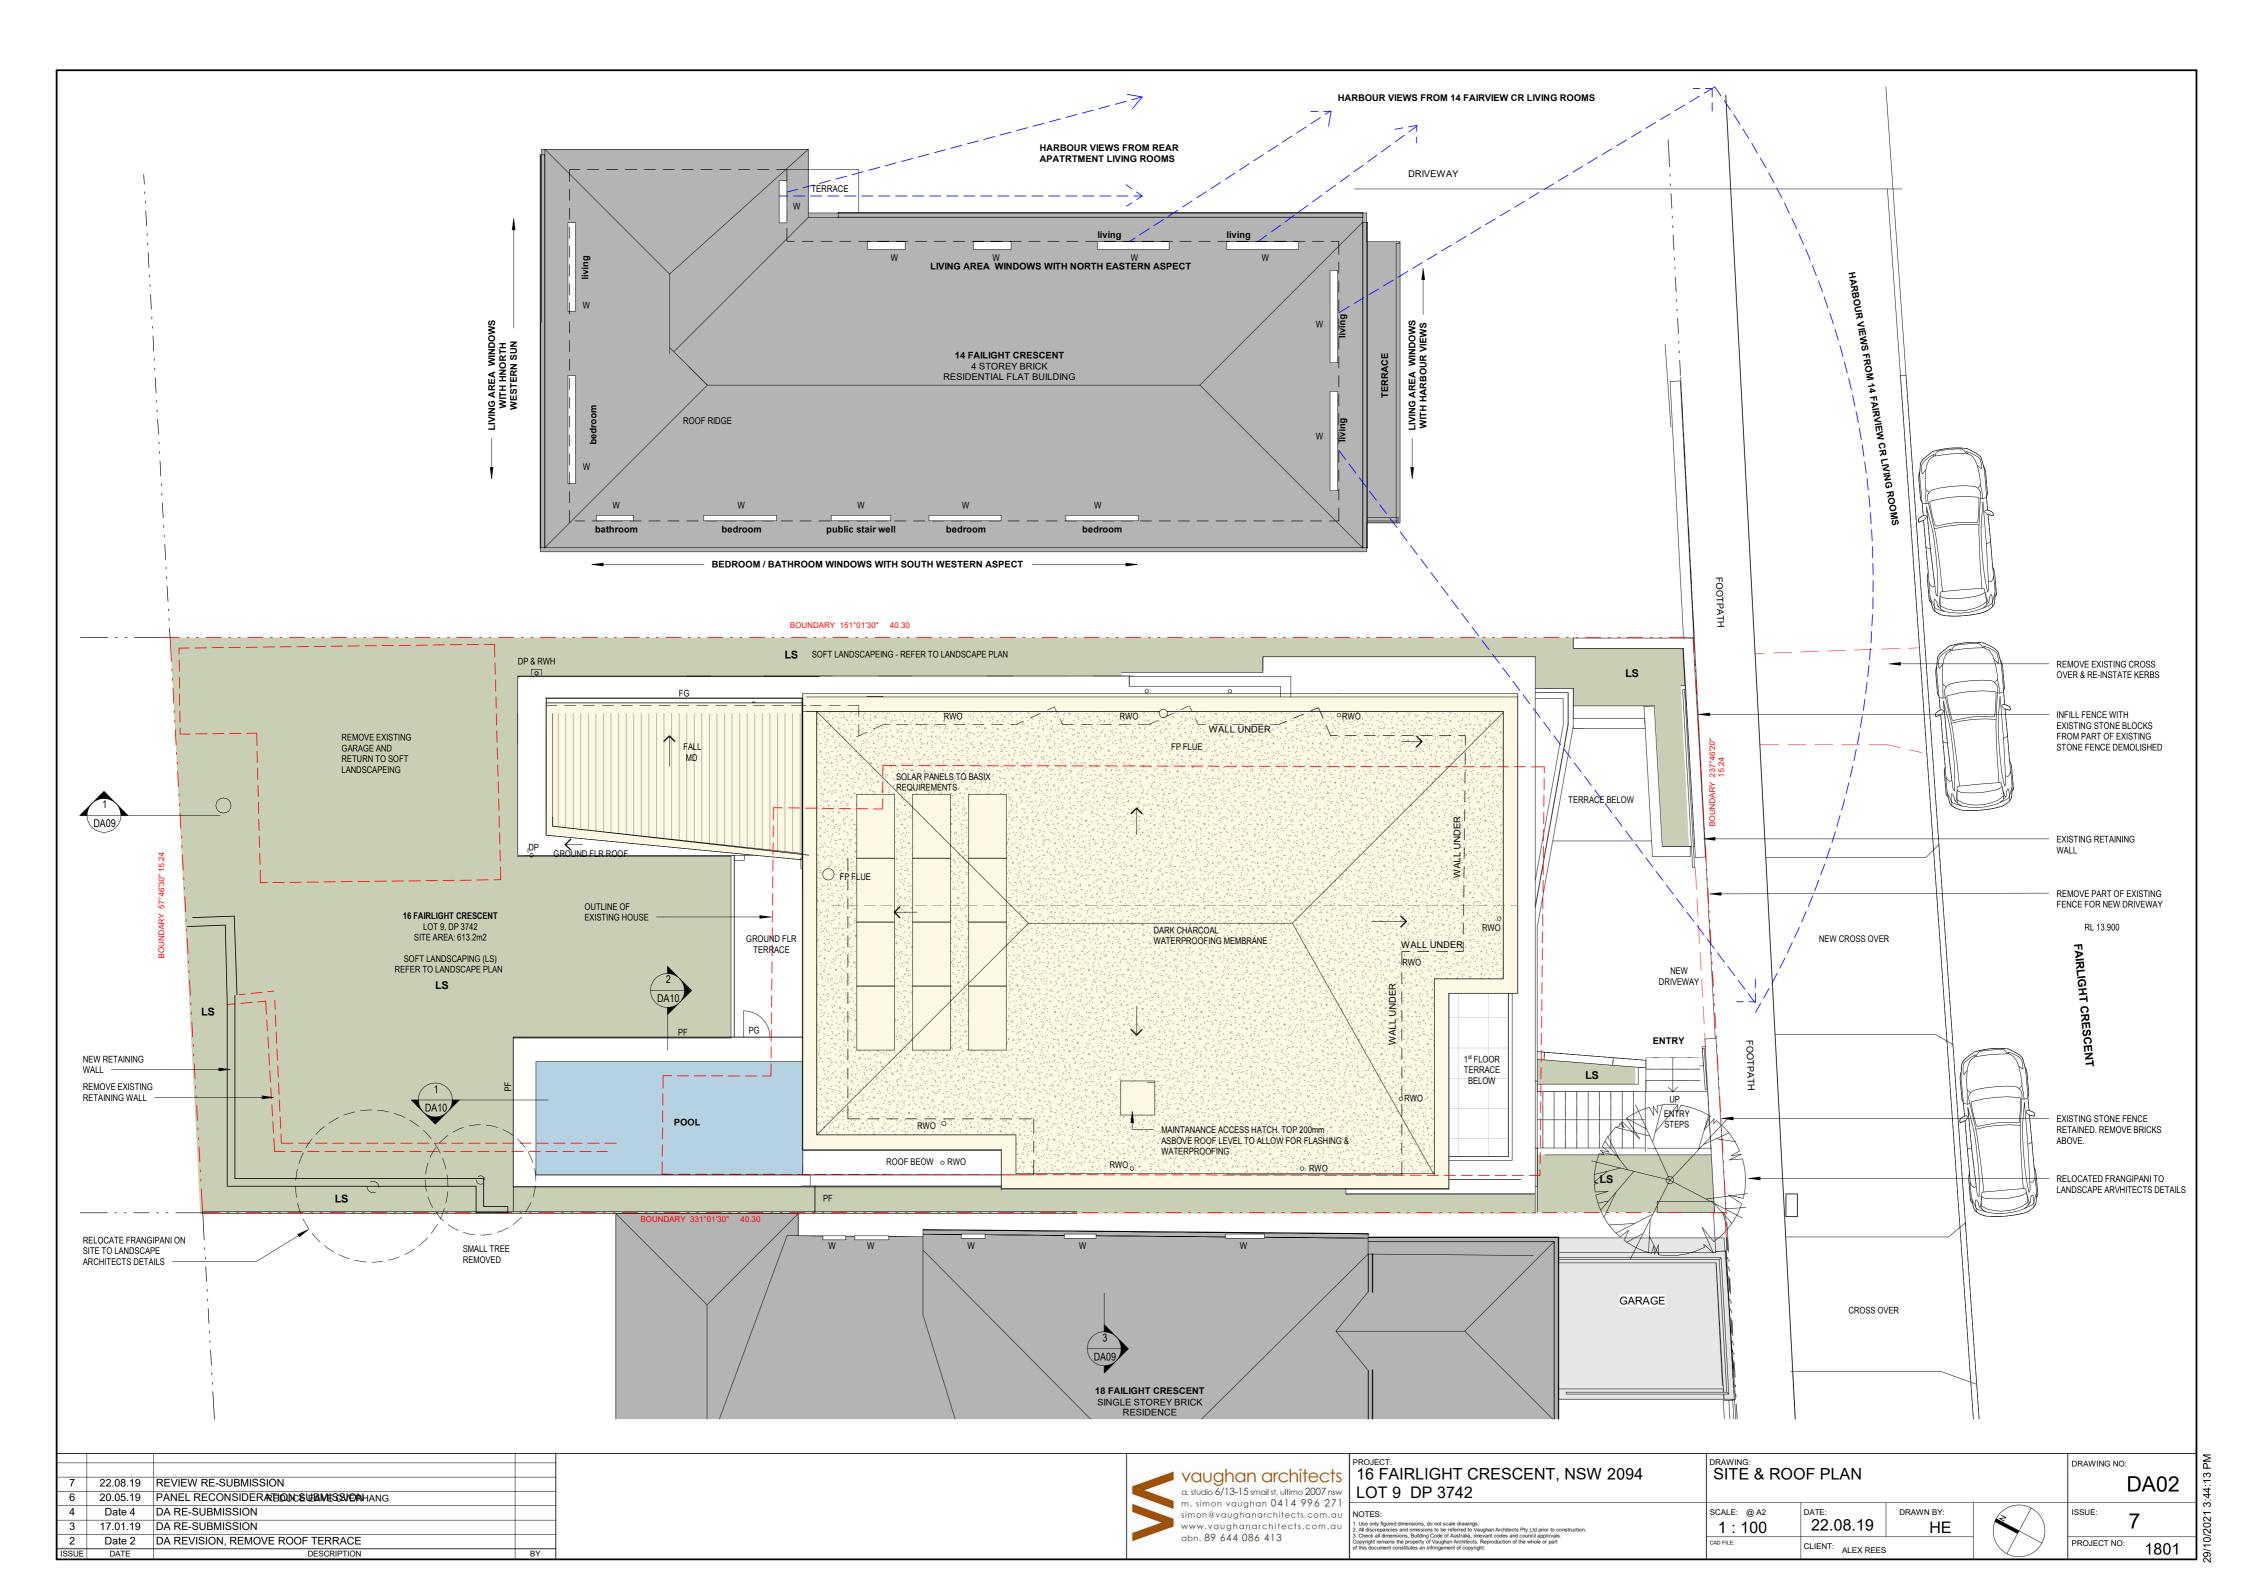


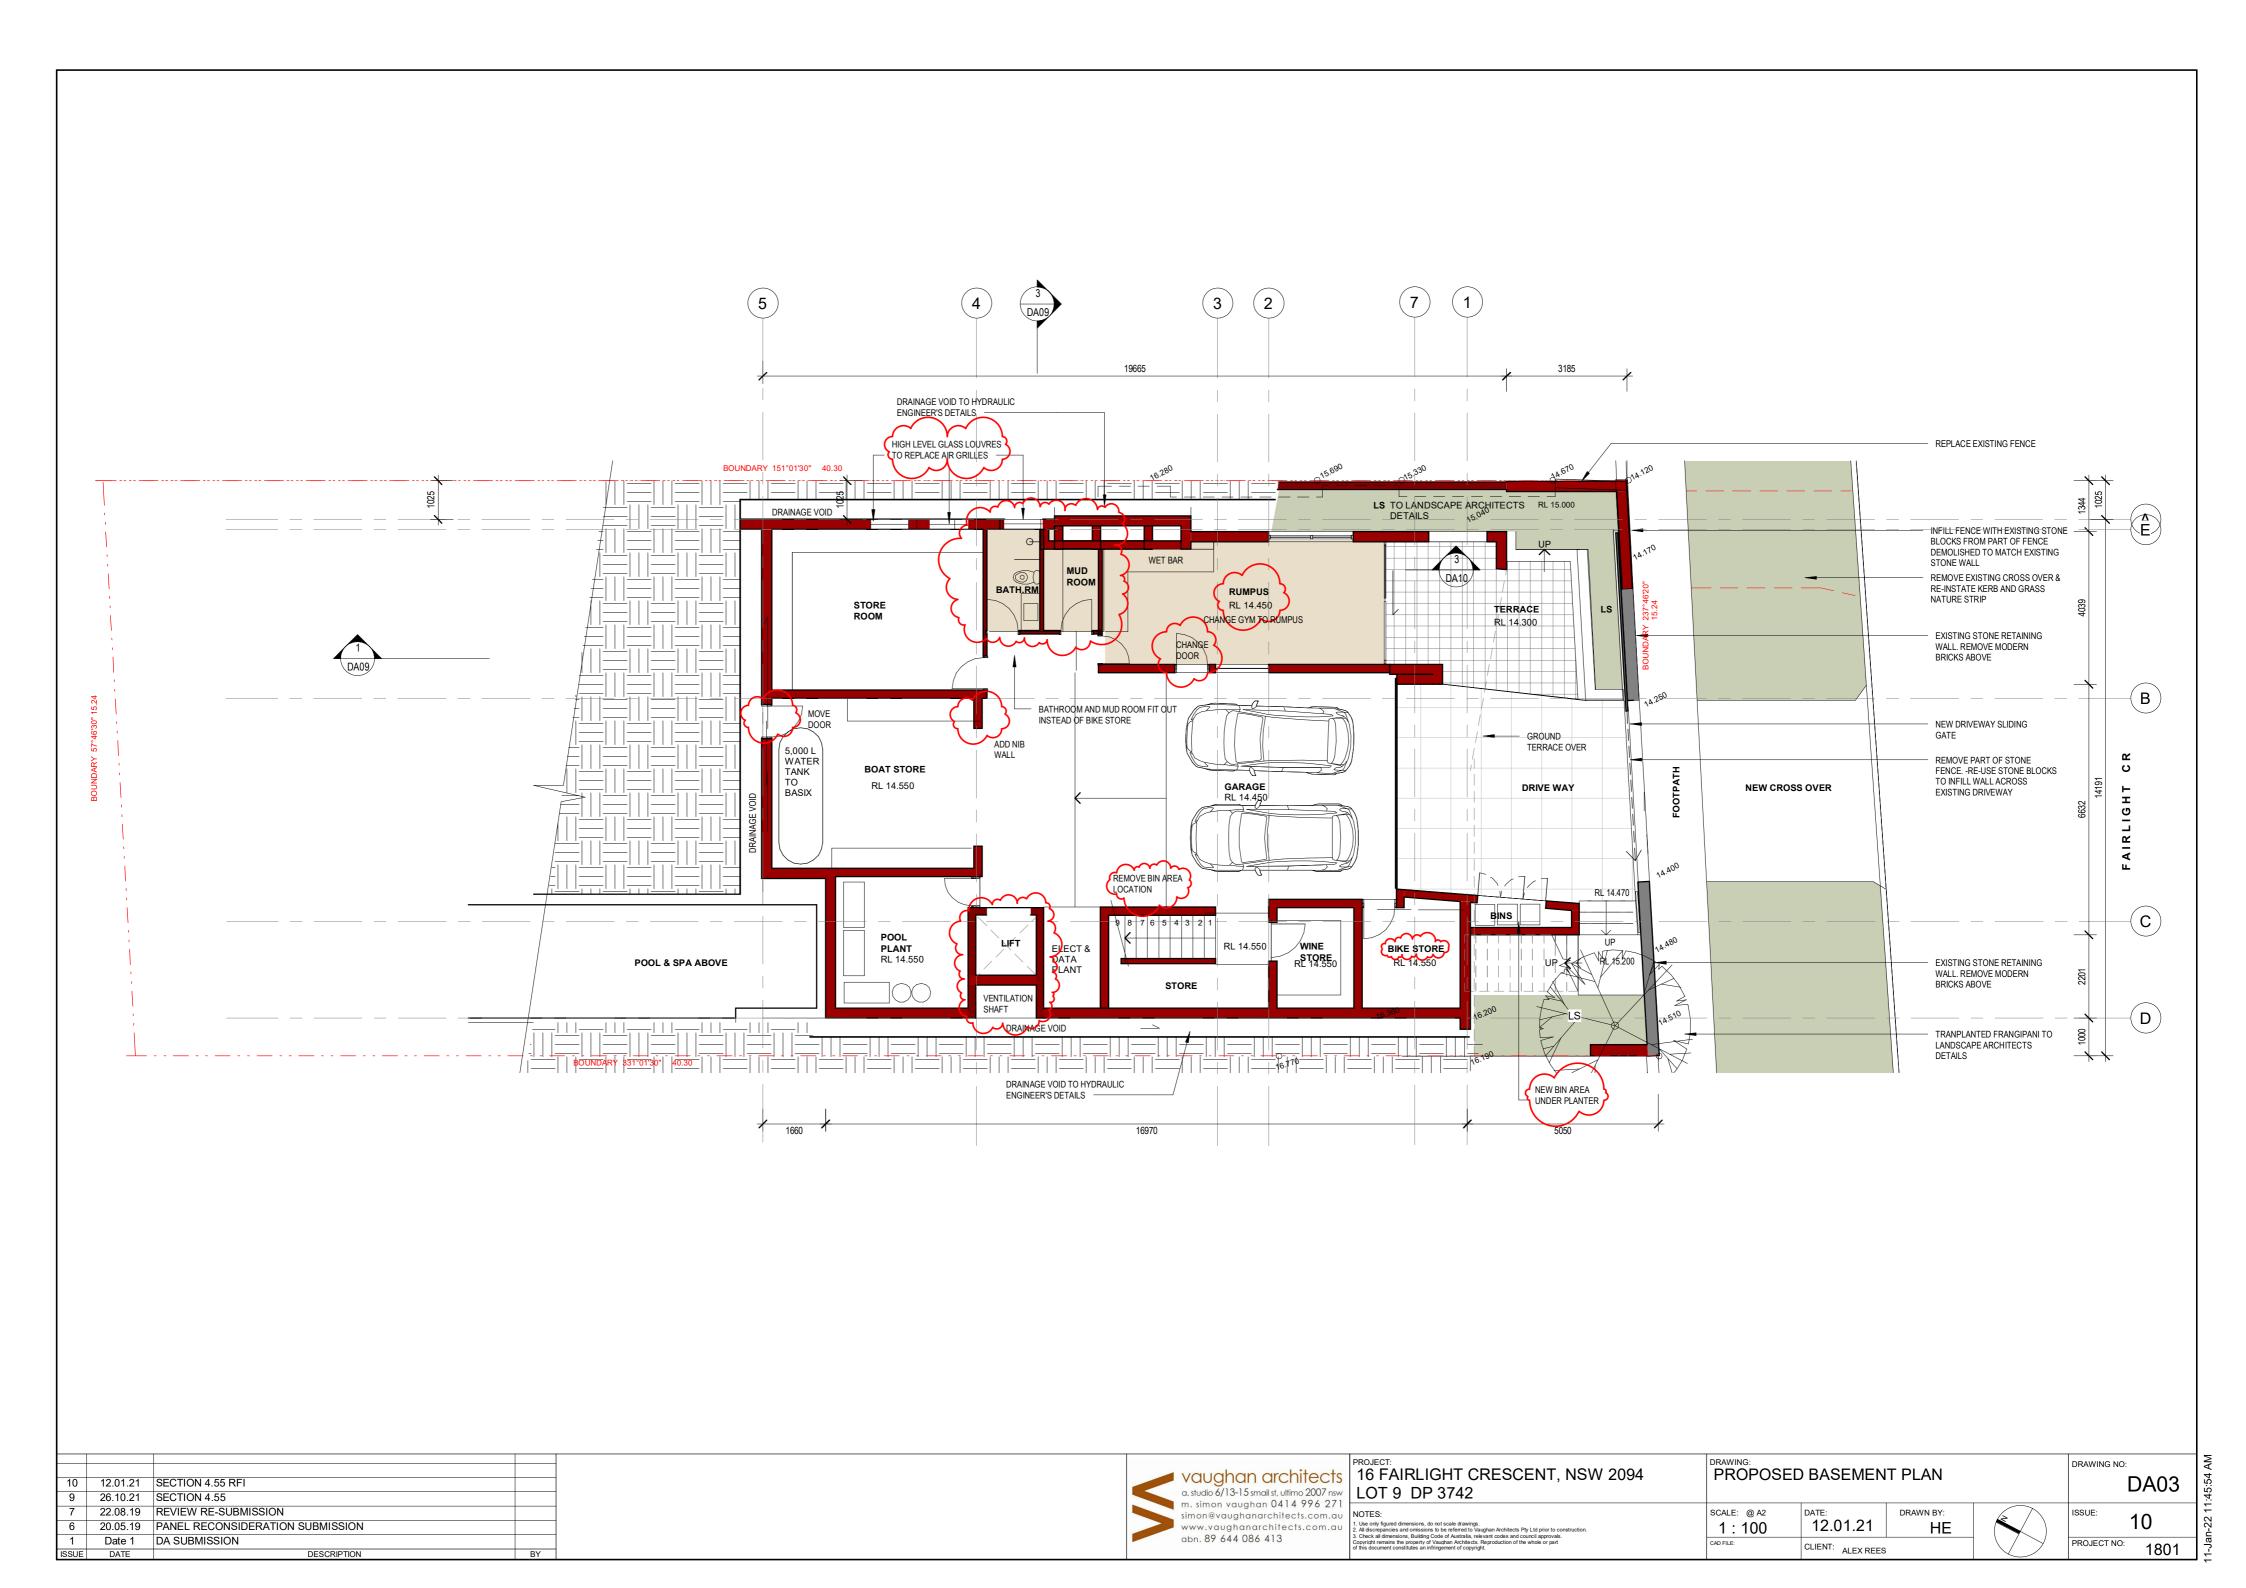

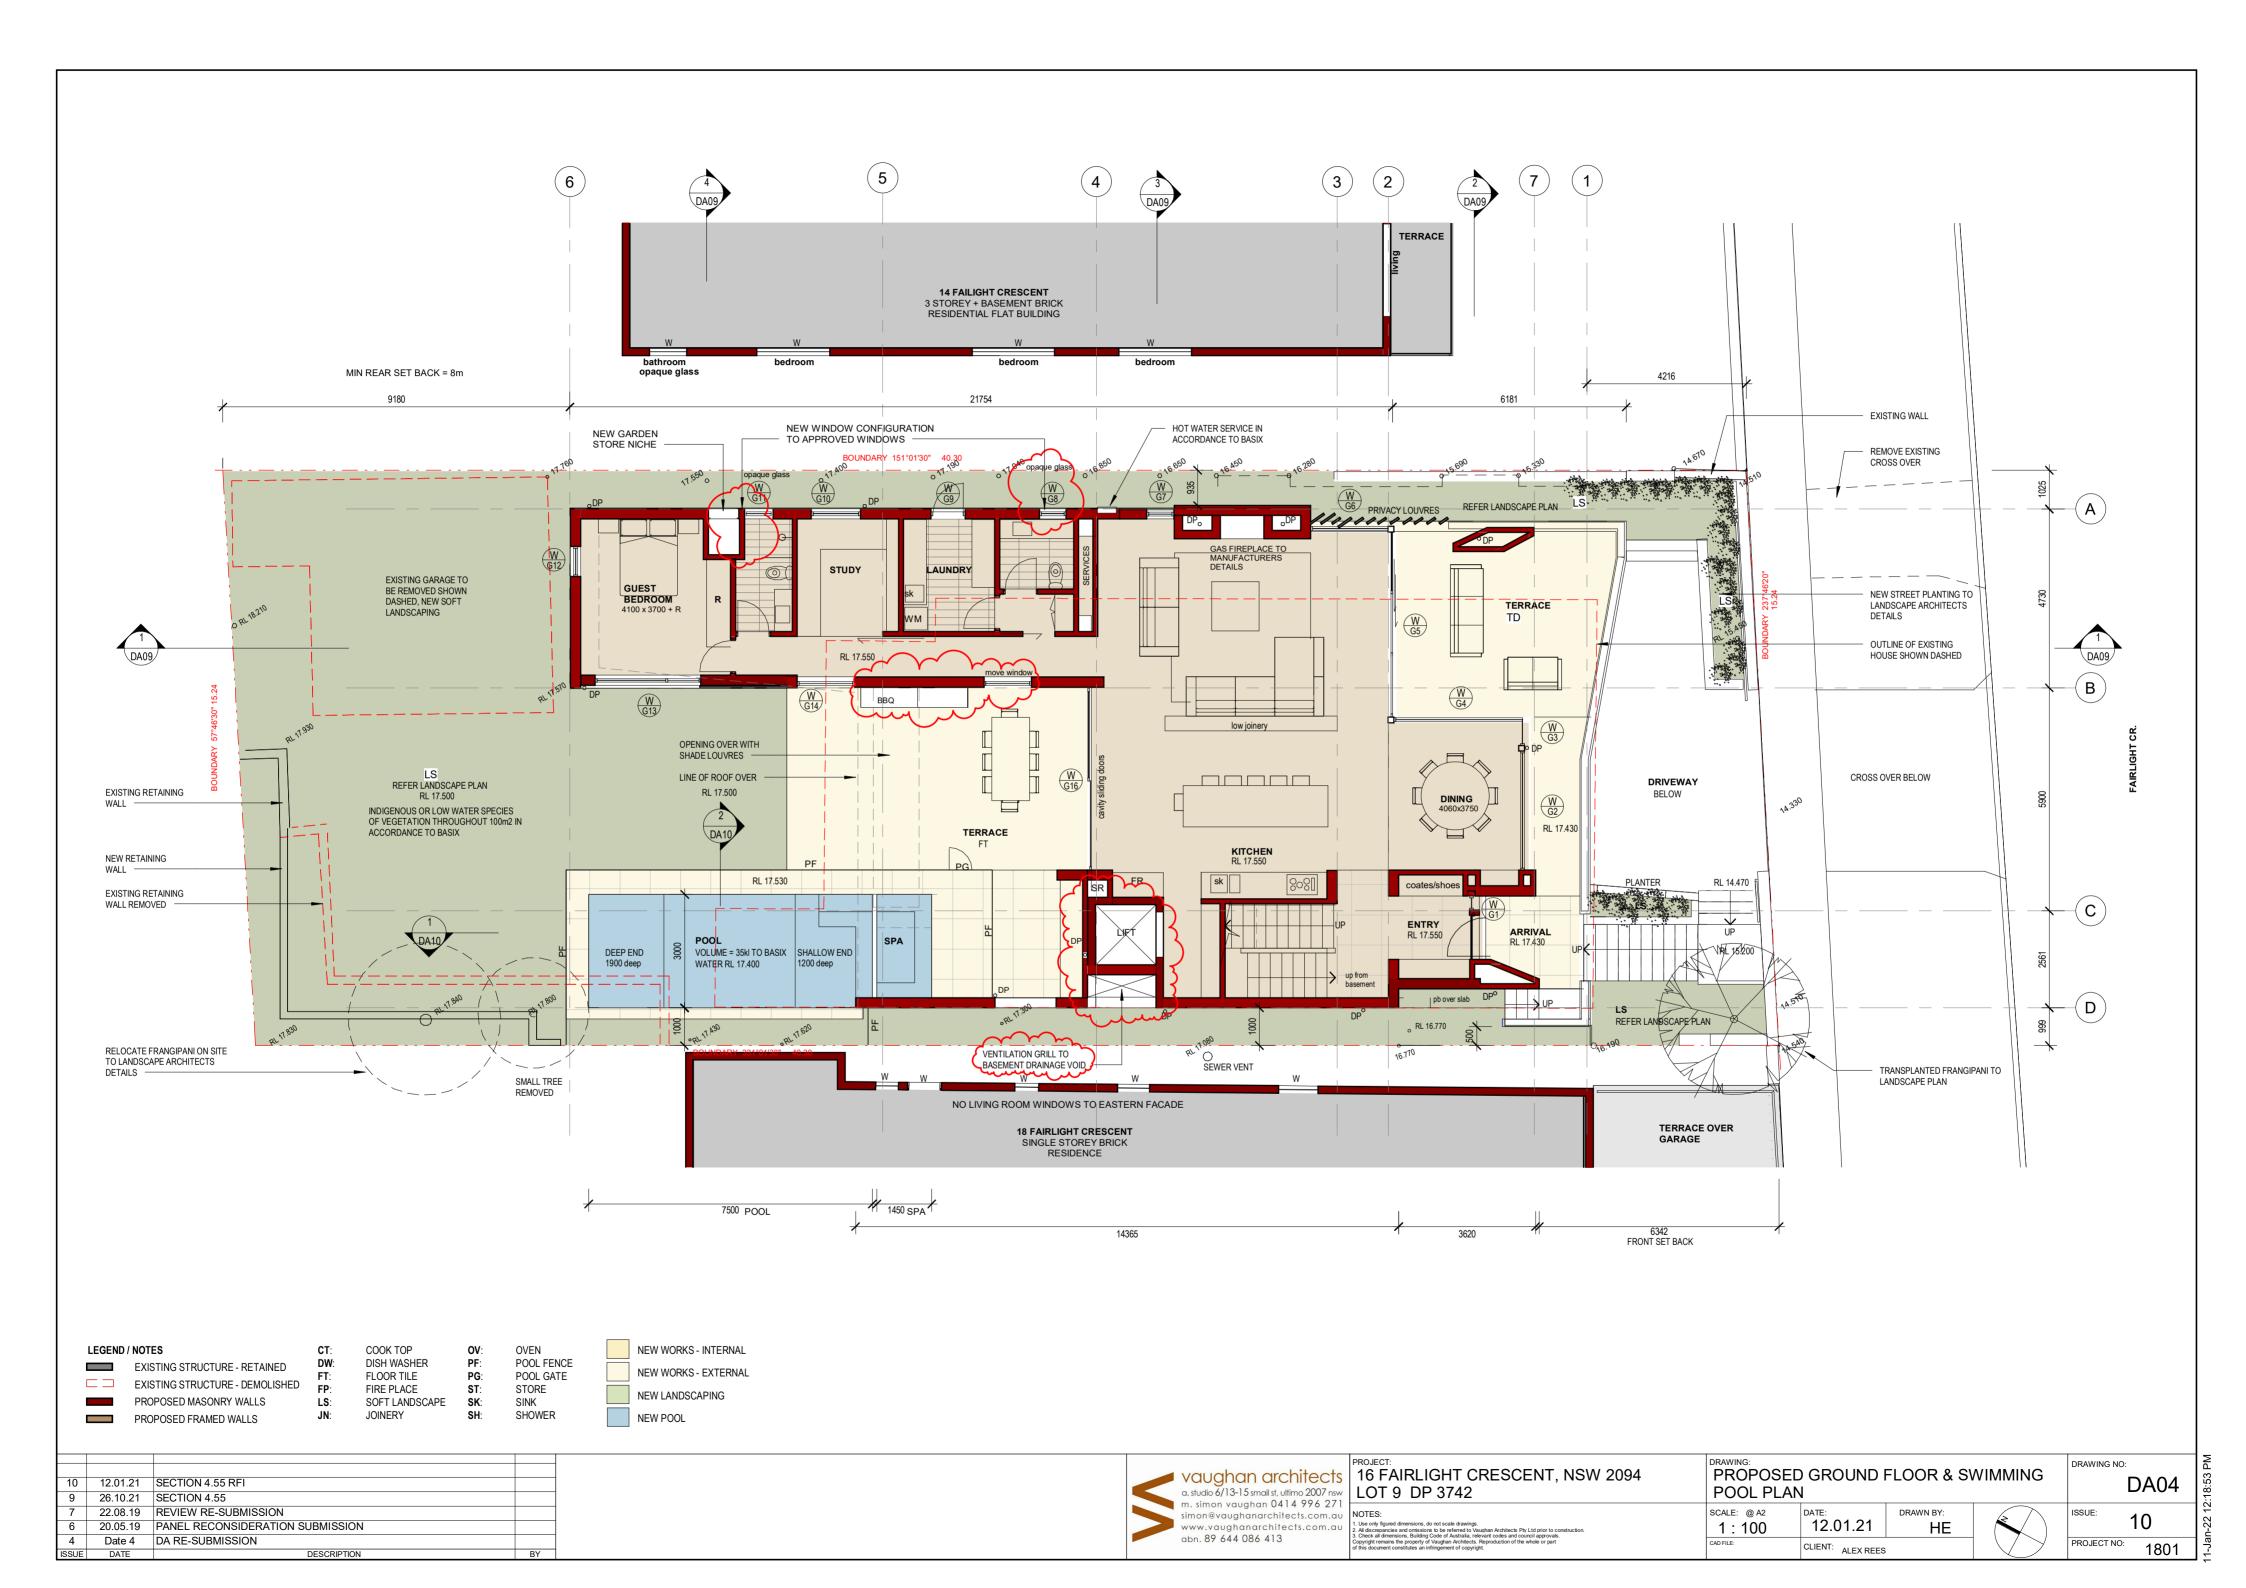

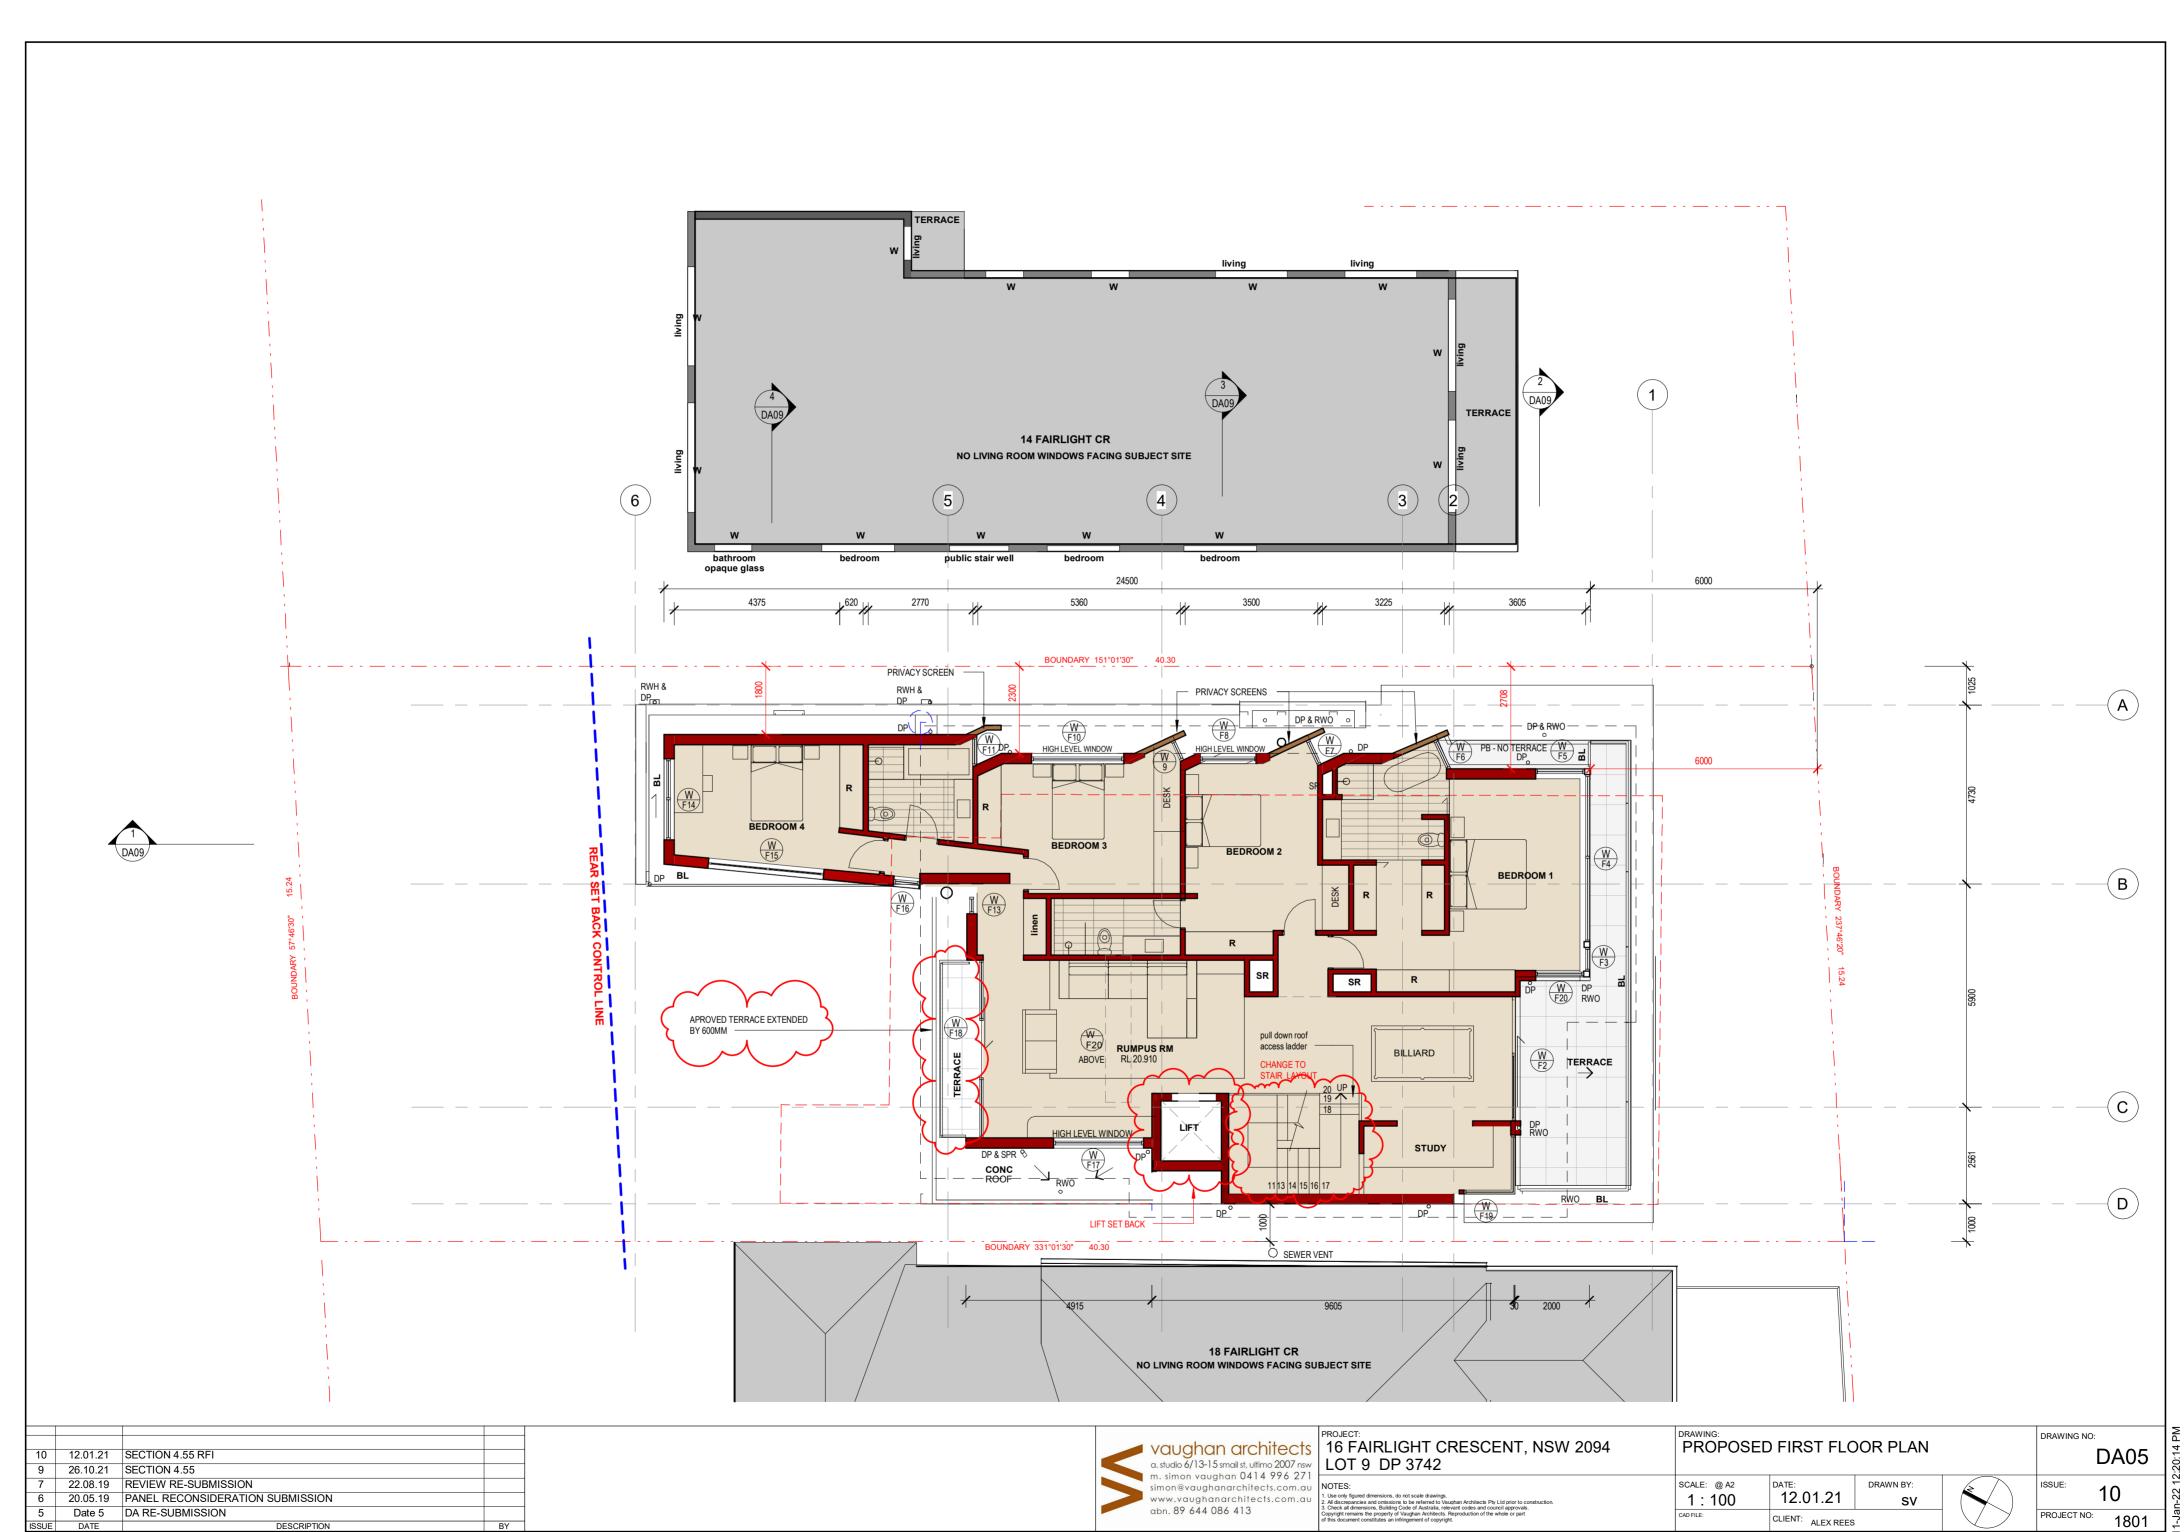

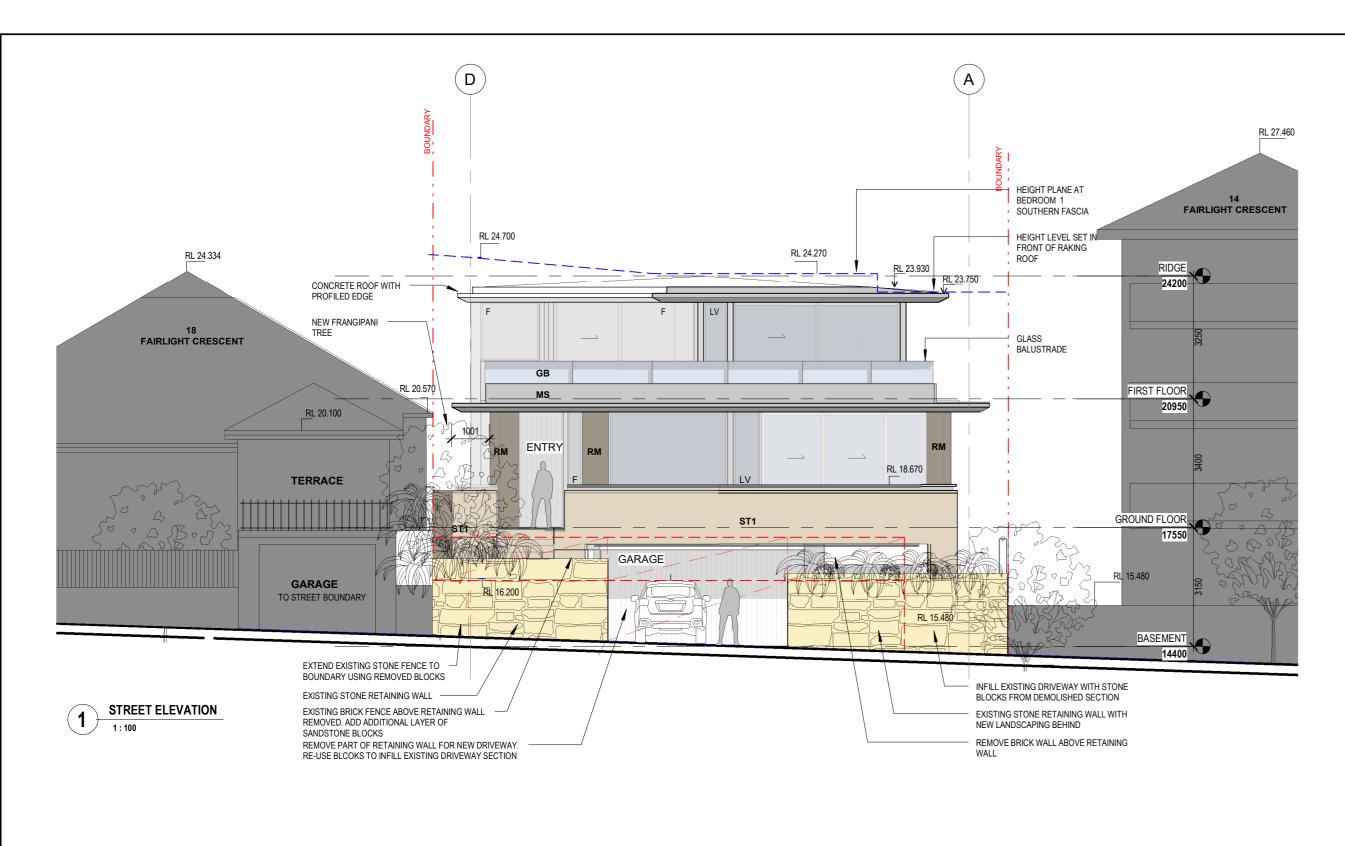

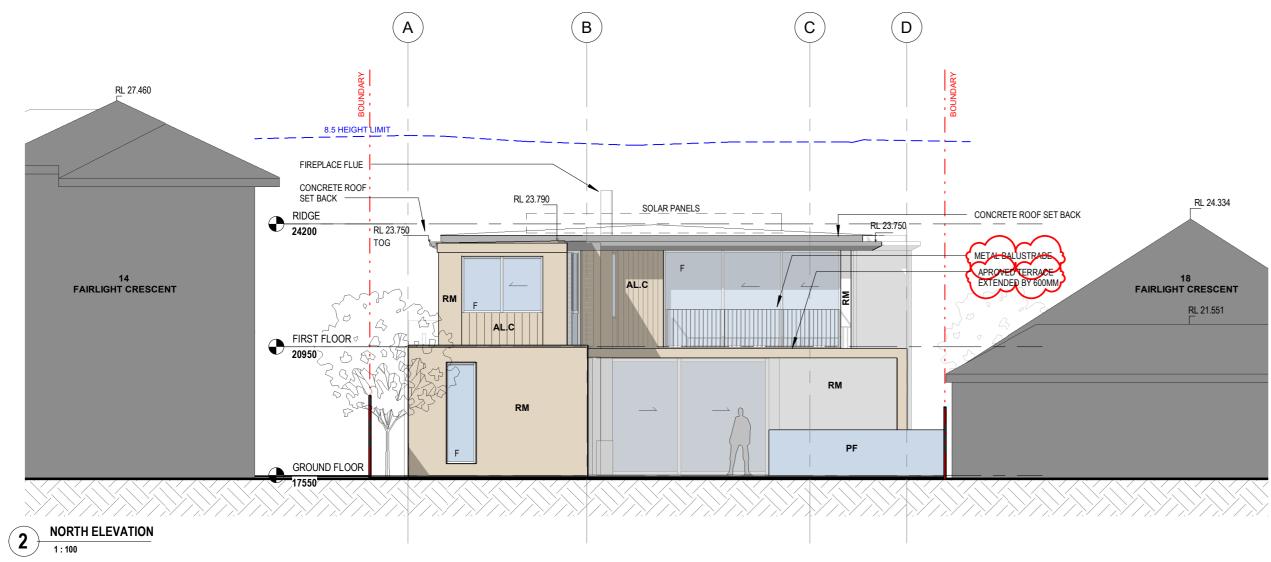




REAR PERSPECTIVE


9	26.10.21	SECTION 4.55	
7	22.08.19	REVIEW RE-SUBMISSION	
6	20.05.19	PANEL RECONSIDERATION SUBMISSION	
4	Date 4	DA RE-SUBMISSION	
3	17.01.19	DA RE-SUBMISSION	
ISSUE	DATE	DESCRIPTION	BY

m. simon vaughan 0414 996 271 simon@vaughanarchitects.com.au www.vaughanarchitects.com.au abn. 89 644 086 413	vaughan architects a. studio 6/13-15 smail st, ultimo 2007 nsw
---	--


							. 5
PROJECT: 16 FAIRLIGHT CRESCENT, NSW 2094 LOT 9 DP 3742	NORTH & SOUTH ELEVATIONS				DRAWING NO: DA07		2:15:36 PN
NOTES: 1. Use only figured dimensions, do not scale drawings. 2. All discrepancies and omissions to be referred to Vaughan Architects Pty Ltd prior to construction. 3. Check all dimensions. Building Code of Australia, relevant codes and council approvals. Copyright remains the property of Vaughan Architects. Reproduction of the whole or part of the document constitutes an infringement of copyright.	SCALE: @ A2 1:100	DATE: 26.10.21 CLIENT: ALEX REES	DRAWN BY:		PROJECT NO:	1801	3/10/2021 1



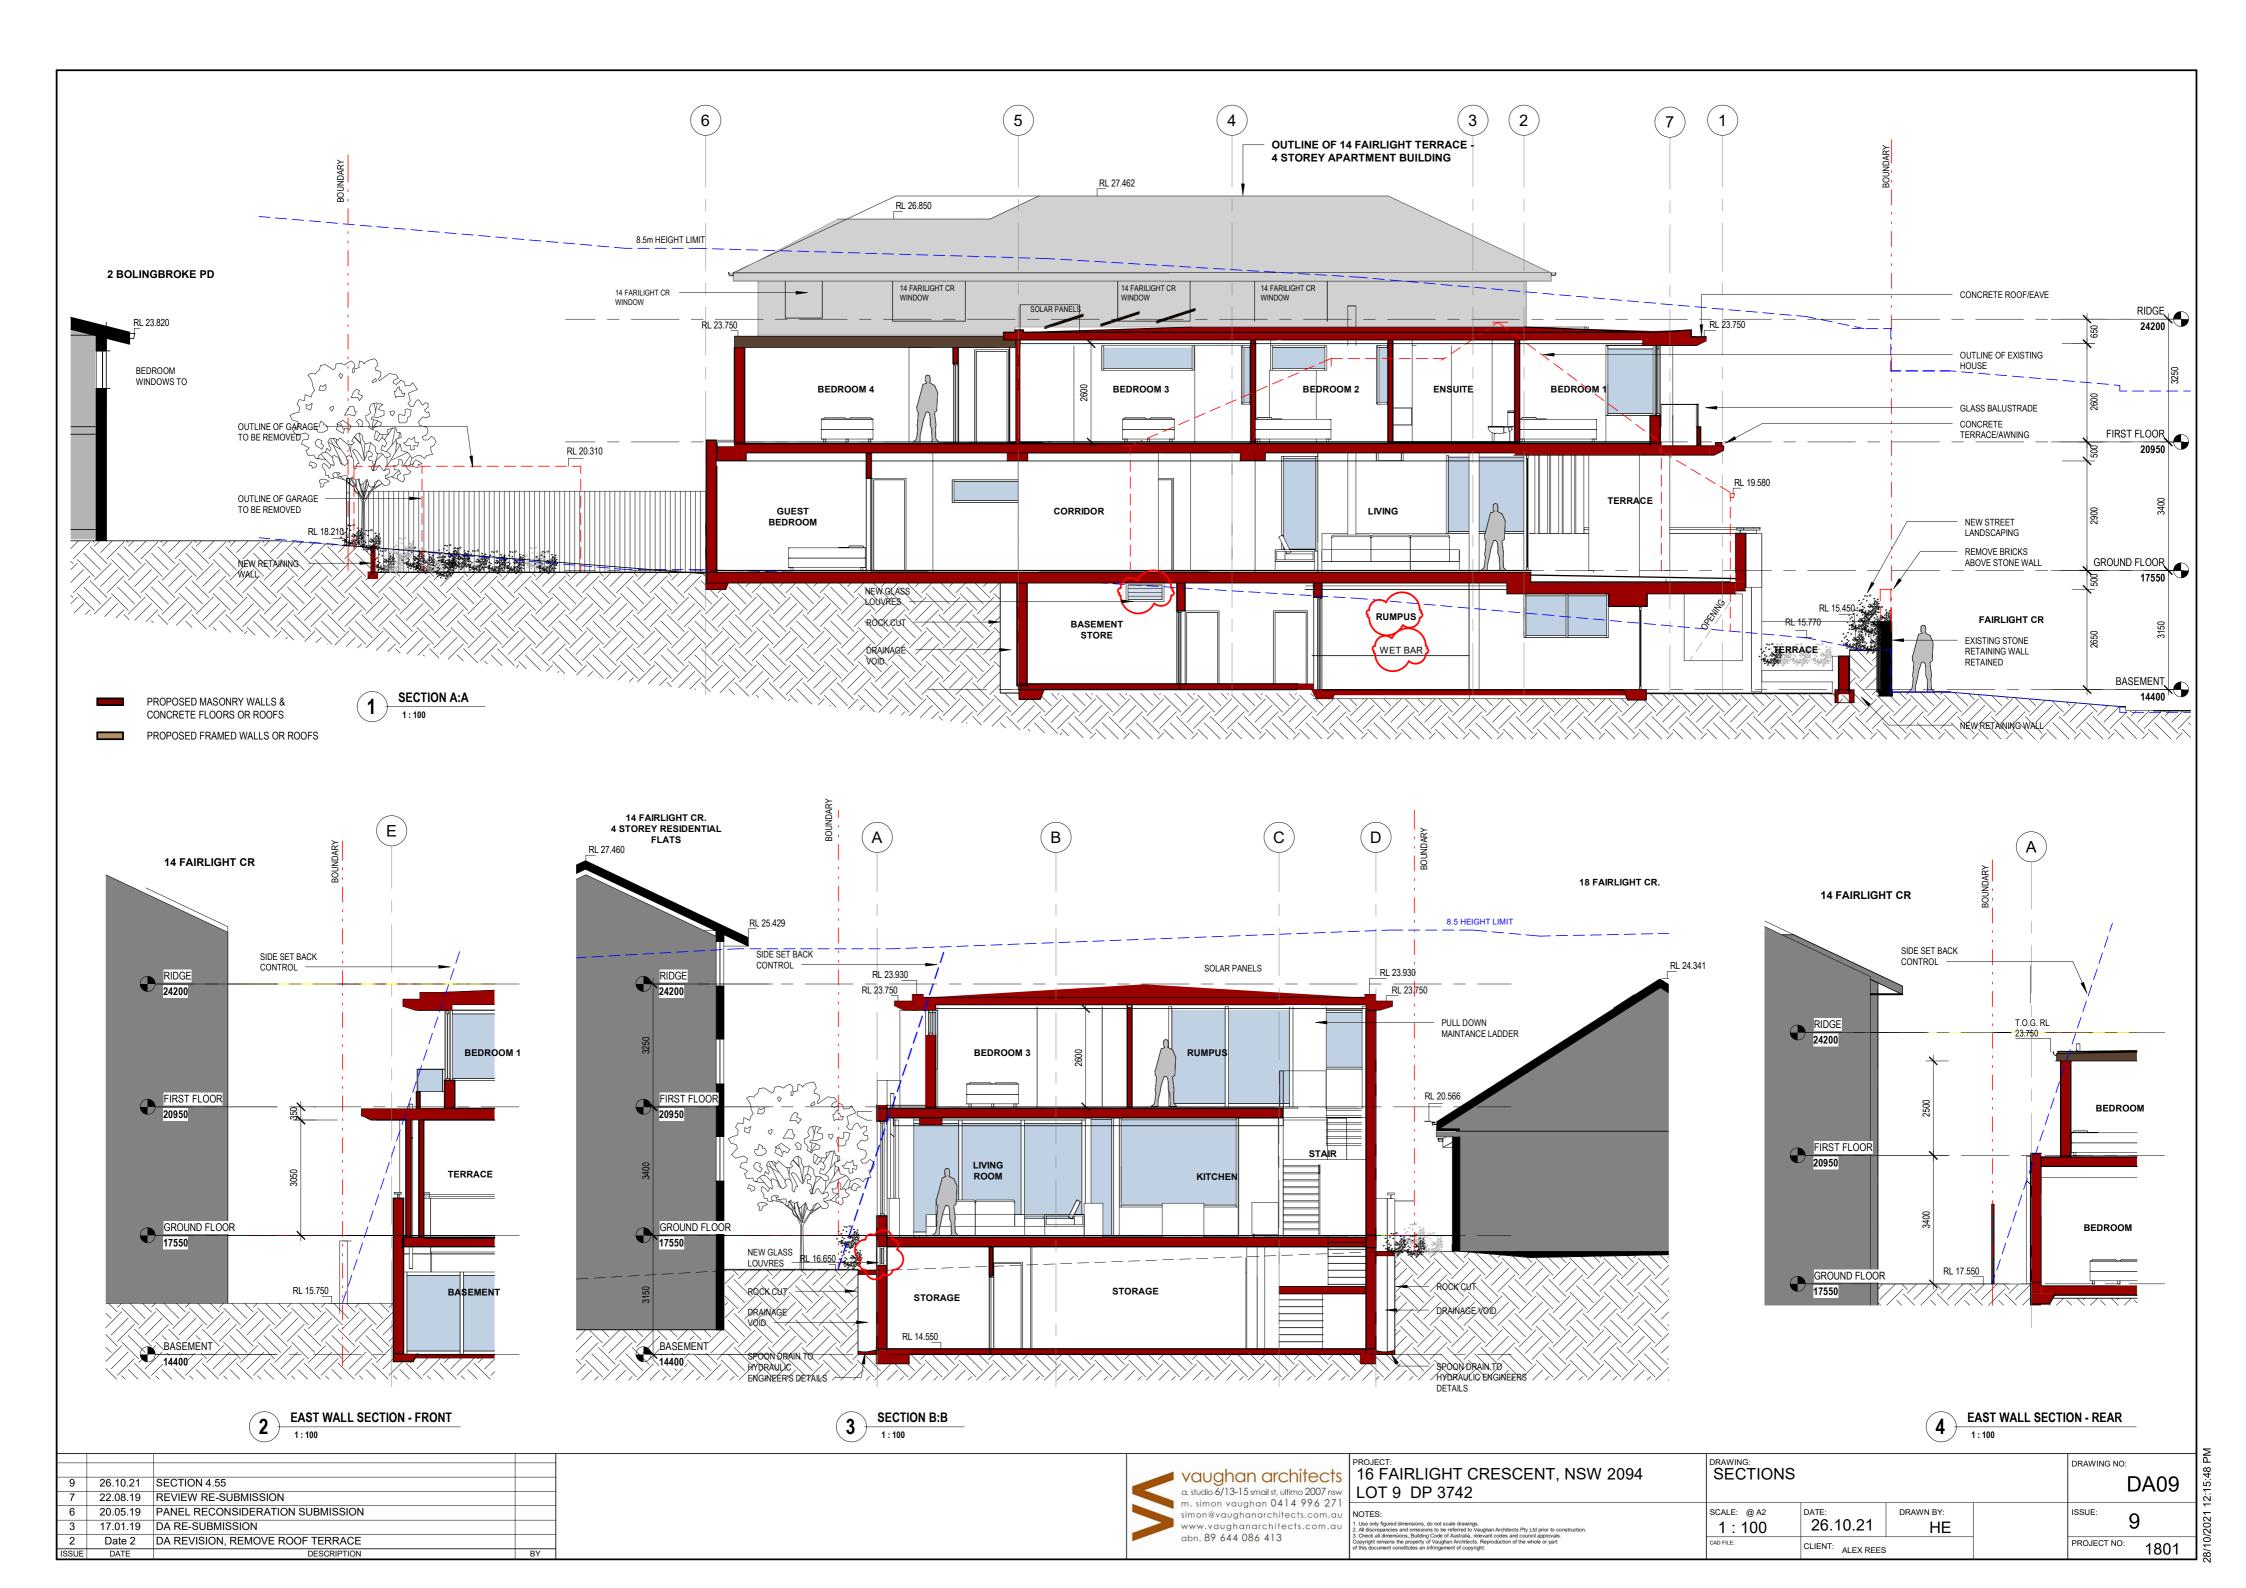


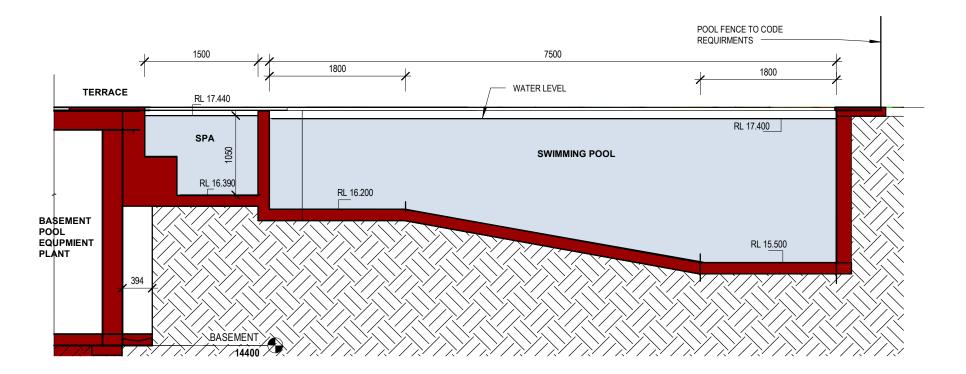



POOL LONG SECTION

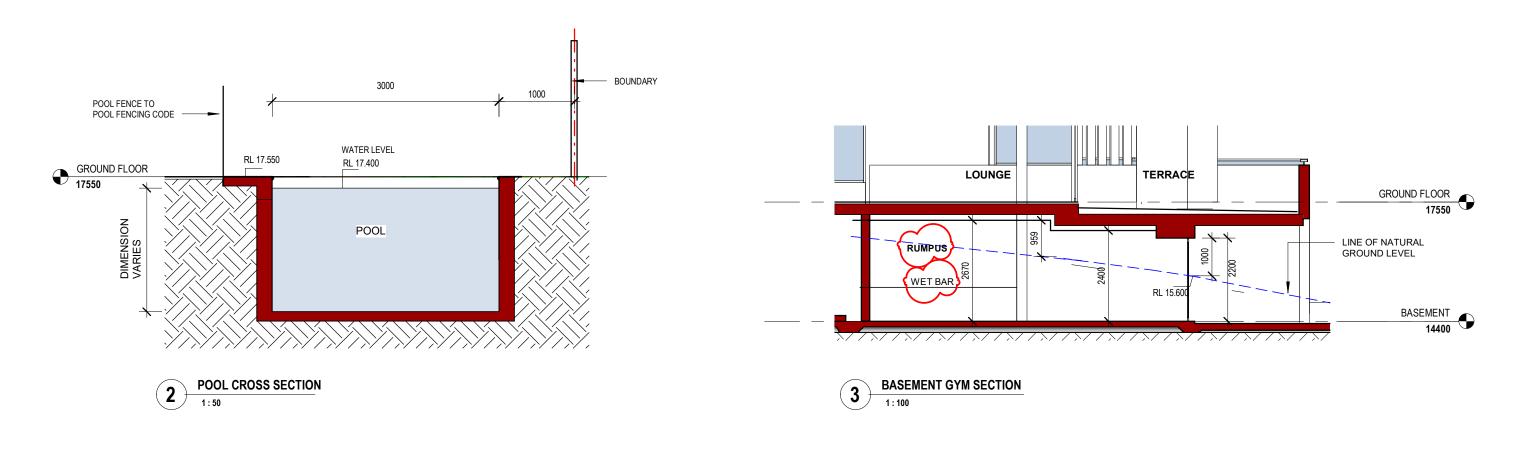

	vaughan architects a. studio 6/13-15 smail st, ultimo 2007 nsw m. simon vaughan 0414 996 271	,	SWIMMING POOL / BASEMENT RUMPUS SECTIONS	DRAWING NO:
9 26.10.21 SECTION 4.55 7 22.08.19 REVIEW RE-SUBMISSION 6 20.05.19 PANEL RECONSIDERATION SUBMISSION ISSUE DATE DESCRIPTION	simon@vaughanarchitects.com.au www.vaughanarchitects.com.au abn. 89 644 086 413	NOTES: 1. Use only figured dimensions, do not scale drawings. 2. All discrepancies and omissions to be referred to Vauphan Architects Pty Ltd prior to construction. 3. Check all dimensions, Building Code of Australa, relevant codes and council approvals. Copyright remains the property of Vauphan Architects. Reproduction of the whole or part of this document constitutes an infringement of copyright.	SCALE: As indicated 26.10.21 DRAWN BY: Author CAD FILE: CLIENT: ALEX REES	PROJECT NO: 1801

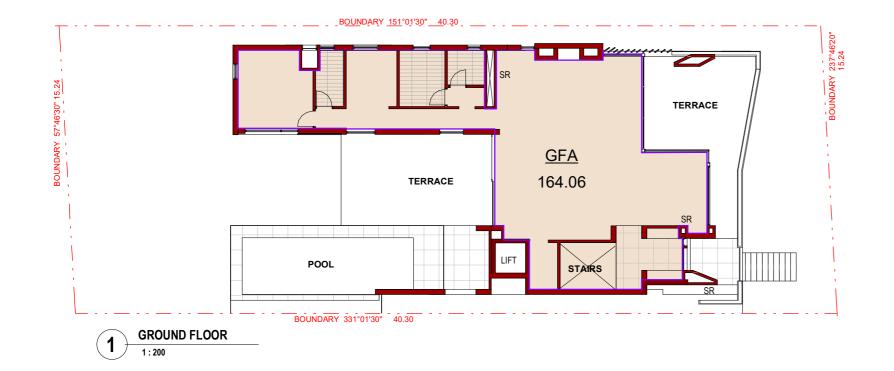

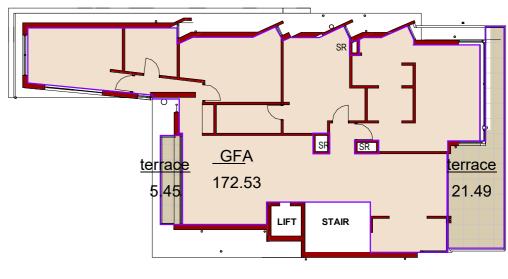

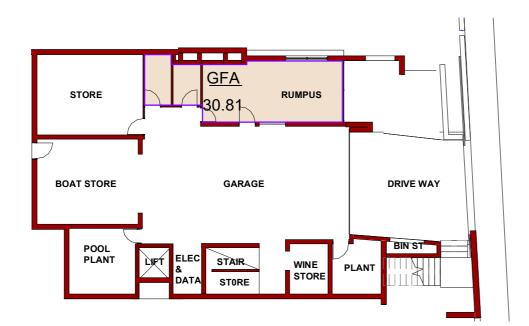

SITE AREA = 613.2m2

FIRST FLOOR

1:200

(3)

Area Schedule (GFA (Proposed))			
Level	GFA Area	FSR	
Not Placed	Not Placed		
BASEMENT	30.81 m ²	0.05	
GROUND FLOOR	164.06 m ²	0.27	
FIRST FLOOR	172.53 m ²	0.28	
	367.40 m ²	0.60	

2 BASEMENT
1:200

10	12.01.21	SECTION 4.55 RFI		
9	26.10.21	SECTION 4.55		
7	22.08.19	REVIEW RE-SUBMISSION		
6	20.05.19	PANEL RECONSIDERATION SUBMISSION		
1	Date 1	DA SUBMISSION		
ISSUE	DATE	DESCRIPTION	BY	

vaughan architects a. studio 6/13-15 smail st, ultimo 2007 nsw m. simon vaughan 0414 996 271 simon@vaughanarchitects.com.au www.vaughanarchitects.com.au abn. 89 644 086 413

	16 FAIRLIGHT CRESCENT, NSW 2094 LOT 9 DP 3742
1	NOTES: 1. Use only figured dimensions, do not scale drawings. 2. All discrepancies and omissions to be referred to Vaushan Architects Pty Ltd prior to construction. 3. Check all dimensions, Building Code of Australia, relevant codes and council approvals. Copyright remains the property of Vaushan Architects. Reproduction of the whole or part of this document constitutes an infringement of copyright.

GFA CALCU	JLATIONS		DAMING NO:	411
SCALE: 1:200	DATE: 12.01.21	DRAWN BY: Author	ISSUE:	10
CAD FILE:	CLIENT: ALEX REES	3	PROJECT NO:	1801