Certificate number: 1123584S

Water Commitments	Show on DA plans	Show on CC/CDC plans & specs	Certifier check
Fixtures			
The applicant must install showerheads with a minimum rating of 3 star (> 7.5 but <= 9 L/min) in all showers in the development.		~	~
The applicant must install a toilet flushing system with a minimum rating of 4 star in each toilet in the development.		~	~
The applicant must install taps with a minimum rating of 4 star in the kitchen in the development.		~	
The applicant must install basin taps with a minimum rating of 4 star in each bathroom in the development.		~	
Alternative water		·	
Rainwater tank			
The applicant must install a rainwater tank of at least 2000 litres on the site. This rainwater tank must meet, and be installed in accordance with, the requirements of all applicable regulatory authorities.	~	~	~
The applicant must configure the rainwater tank to collect rain runoff from at least 180 square metres of the roof area of the development (excluding the area of the roof which drains to any stormwater tank or private dam).		~	~
The applicant must connect the rainwater tank to:			
all tollets in the development		~	~
the cold water tap that supplies each clothes washer in the development		V	~
 at least one outdoor tap in the development (Note: NSW Health does not recommend that rainwater be used for human consumption in areas with potable water supply.) 		~	~
Thermal Comfort Commitments	Show on DA plans	Show on CC/CDC plans & specs	Certifier

consumption in areas with potable water supply.)	7	~	~
Thermal Comfort Commitments	Show on DA plans	Show on CC/CDC plans & specs	Certifier check
Simulation Method			
The applicant must attach the certificate referred to under "Assessor Details" on the front page of this BASIX certificate (the "Assessor Certificate") to the development application and construction certificate application for the proposed development (or, if the applicant is applying for a complying development entificate for the proposed development, to that application). The applicant must also attach the Assessor Certificate to the application for an occupation certificate for the proposed development.			
The Assessor Certificate must have been issued by an Accredited Assessor in accordance with the Thermal Comfort Protocol.			
The details of the proposed development on the Assessor Certificate must be consistent with the details shown in this BASIX certificate, including the Cooling and Heating loads shown on the front page of this certificate.			
The applicant must show on the plans accompanying the development application for the proposed development, all matters which the Assessor Certificate requires to be shown on those plans. Those plans must bear a stamp of endorsement from the Accredited Assessor to certify that this is the case. The applicant must show on the plans accompanying the application for a construction certificate (or complying development certificate, if applicable), all thermal performance specifications set out in the Assessor Certificate, and all aspects of the proposed development which were used to calculate those specifications.	~	~	~
The applicant must construct the development in accordance with all thermal performance specifications set out in the Assessor Certificate, and in accordance with those aspects of the development application or application for a complying development certificate which were used to calculate those specifications.		~	~
The applicant must construct the floors and walls of the dwelling in accordance with the specifications listed in the table below.	~	~	~

floor - suspended floor above garage				
	All or part of floor area			
Energy Commitments		Show on DA plans	Show on CC/CDC plans & specs	Certifier check
Hot water				
The applicant must install the following hot water system in the development, or a system wit instantaneous with a performance of 6 stars.	h a higher energy rating: gas	~	V	~
Cooling system				
The applicant must install the following cooling system, or a system with a higher energy ratir airconditioning; Energy rating: EER 3.0 - 3.5	ng, in at least 1 living area: 3-phase		V	~
The applicant must install the following cooling system, or a system with a higher energy ratir airconditioning; Energy rating: EER 3.0 - 3.5	ng, in at least 1 bedroom: 3-phase		~	~
The cooling system must provide for day/night zoning between living areas and bedrooms.			~	V
Heating system		100		
The applicant must install the following heating system, or a system with a higher energy rati airconditioning; Energy rating: EER 3.0 - 3.5	ng, in at least 1 living area: 3-phase		~	~
The applicant must install the following heating system, or a system with a higher energy ratinal airconditioning; Energy rating: EER 3.0 - 3.5	ng, in at least 1 bedroom: 3-phase		~	V
The heating system must provide for day/night zoning between living areas and bedrooms.			V	V
Ventilation				
The applicant must install the following exhaust systems in the development:		Ì		
At least 1 Bathroom: individual fan, not ducted; Operation control: interlocked to light				
Witches individual for dusted to foodle or seef. Operation control manual quitch on off			×	•
Kitchen: individual fan, ducted to façade or roof; Operation control: manual switch on/off Laundry: natural ventilation only, or no laundry; Operation control: n/a			~	~
Education Control of the Education Control of the C			~	~
Artificial lighting				
The applicant must ensure that the "primary type of artificial lighting" is fluorescent or light en following rooms, and where the word "dedicated" appears, the fittings for those lights must or	nitting diode (LED) lighting in each of the			
light emitting diode (LED) lamps:	ly be capable of accepting fluorescent or			
light emitting diode (LED) lamps: • at least 6 of the bedrooms / study; dedicated	lly be capable of accepting fluorescent or			,
at least 6 of the bedrooms / study; dedicated	ily be capable of accepting fluorescent or	Show on	Show on CC/CDC	Certifier
at least 6 of the bedrooms / study; dedicated Energy Commitments	ily be capable of accepting fluorescent or	Show on DA plans	Show on CC/CDC plans & specs	Certifier check
at least 6 of the bedrooms / study; dedicated	ily be capable of accepting fluorescent or			
at least 6 of the bedrooms / study; dedicated Energy Commitments	ily be capable of accepting fluorescent or			
at least 6 of the bedrooms / study; dedicated Energy Commitments at least 3 of the living / dining rooms;	ily be capable of accepting fluorescent or			
at least 6 of the bedrooms / study; dedicated Energy Commitments at least 3 of the living / dining rooms; the kitchen;	ily be capable of accepting fluorescent or			
at least 6 of the bedrooms / study; dedicated Energy Commitments at least 3 of the living / dining rooms; the kitchen; all bathrooms/toilets;	ily be capable of accepting fluorescent or			
at least 6 of the bedrooms / study; dedicated Energy Commitments at least 3 of the living / dining rooms; the kitchen; all bathrooms/toilets; the laundry; all hallways;	ily be capable of accepting fluorescent or			
at least 6 of the bedrooms / study; dedicated Energy Commitments at least 3 of the living / dining rooms; the kitchen; all bathrooms/toilets; the laundry; all hallways; Natural lighting	lly be capable of accepting fluorescent or			
at least 6 of the bedrooms / study; dedicated Energy Commitments at least 3 of the living / dining rooms; the kitchen; all bathrooms/toilets; the laundry; all hallways; Natural lighting The applicant must install a window and/or skylight in the kitchen of the dwelling for natural lighting.	nly be capable of accepting fluorescent or			
at least 6 of the bedrooms / study; dedicated Energy Commitments at least 3 of the living / dining rooms; the kitchen; all bathrooms/toilets; the laundry;	nly be capable of accepting fluorescent or			
at least 6 of the bedrooms / study; dedicated Energy Commitments at least 3 of the living / dining rooms; the kitchen; all bathrooms/toilets; the laundry; all hallways; Natural lighting The applicant must install a window and/or skylight in the kitchen of the dwelling for natural lighting. The applicant must install a window and/or skylight in 4 bathroom(s)/toilet(s) in the development of the dwelling for natural lighting.	nly be capable of accepting fluorescent or			



<u>AREAS</u>	
SITE:	725.60 m²
GROUND FLOOR:	163.55 m²
FIRST FLOOR:	174.86 m ²
GARAGE:	34.23 m²
PORCH:	1.87 m²
BALCONY:	N/A m ²
ALFRESCO:	N/A m²
	m²
TOTAL:	374.51 m ²

2.5 JUNE ELEVATION SHADOW 2.4 NEIGHBOUR NOTIFICATION PLAN

									2.3 S	HADOW DIAGRAM
									2.2 S	TE ANALYSIS PLAN
									2.1 C	ONSTRUCTION MANAGEMENT
QUOTE	DATE	QUOTE NUMBER	REV							
KITCHEN			-							
ZURCORP ELECTRICAL			-							
TILES			-							
CARPET			-						10 W	ET AREA DETAILS
ZURCORP SECURITY			-						9 W	ET AREA DETAILS
EHI			-						8 E	LECTRICAL LAYOUT
AIR CONDITIONING			-						7 S	ECTION
STAIRS			-						6 E	LEVATIONS
LANDSCAPE									5 E	LEVATIONS
HYDRAULICS				D	17.08.20	DA DRAWINGS, HYDRAULICS & EXTERNAL COLOU	JRS P	G.	4 FI	RST FLOOR PLAN
ENGINEER				С	22.07.20	PCV 1	M.	.H.	3 G	ROUND FLOOR PLAN
PEG OUT				В	07.07.20	CONTRACT DRAWINGS	PG.	./AK	2 S	TE PLAN
				Α	15.06.20	TENDER	В	3G	1 C	OVER SHEET
T'S SIGNATURE:		DATE:		REV	DATE	AMENDMENTS	В	SY S	SHEET D	ESCRIPTION
		© ALL RIGHTS RE	SERVED	PRO	DUCT:	CLIENT:				

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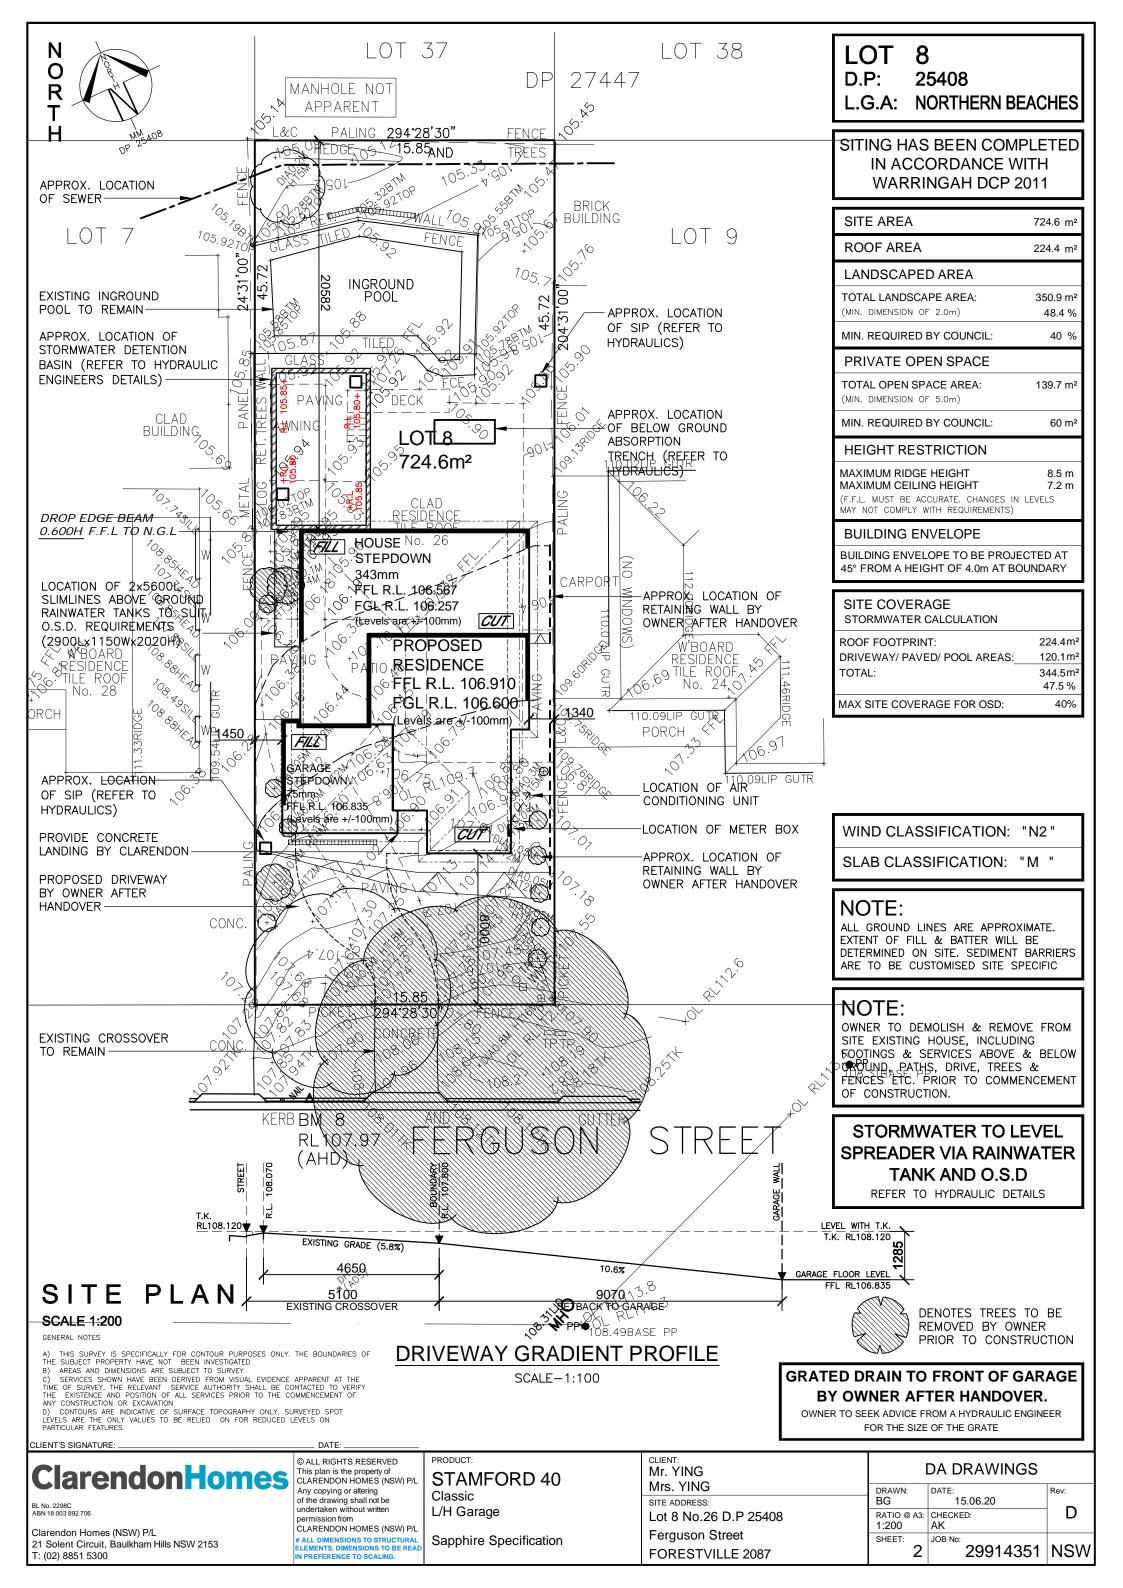
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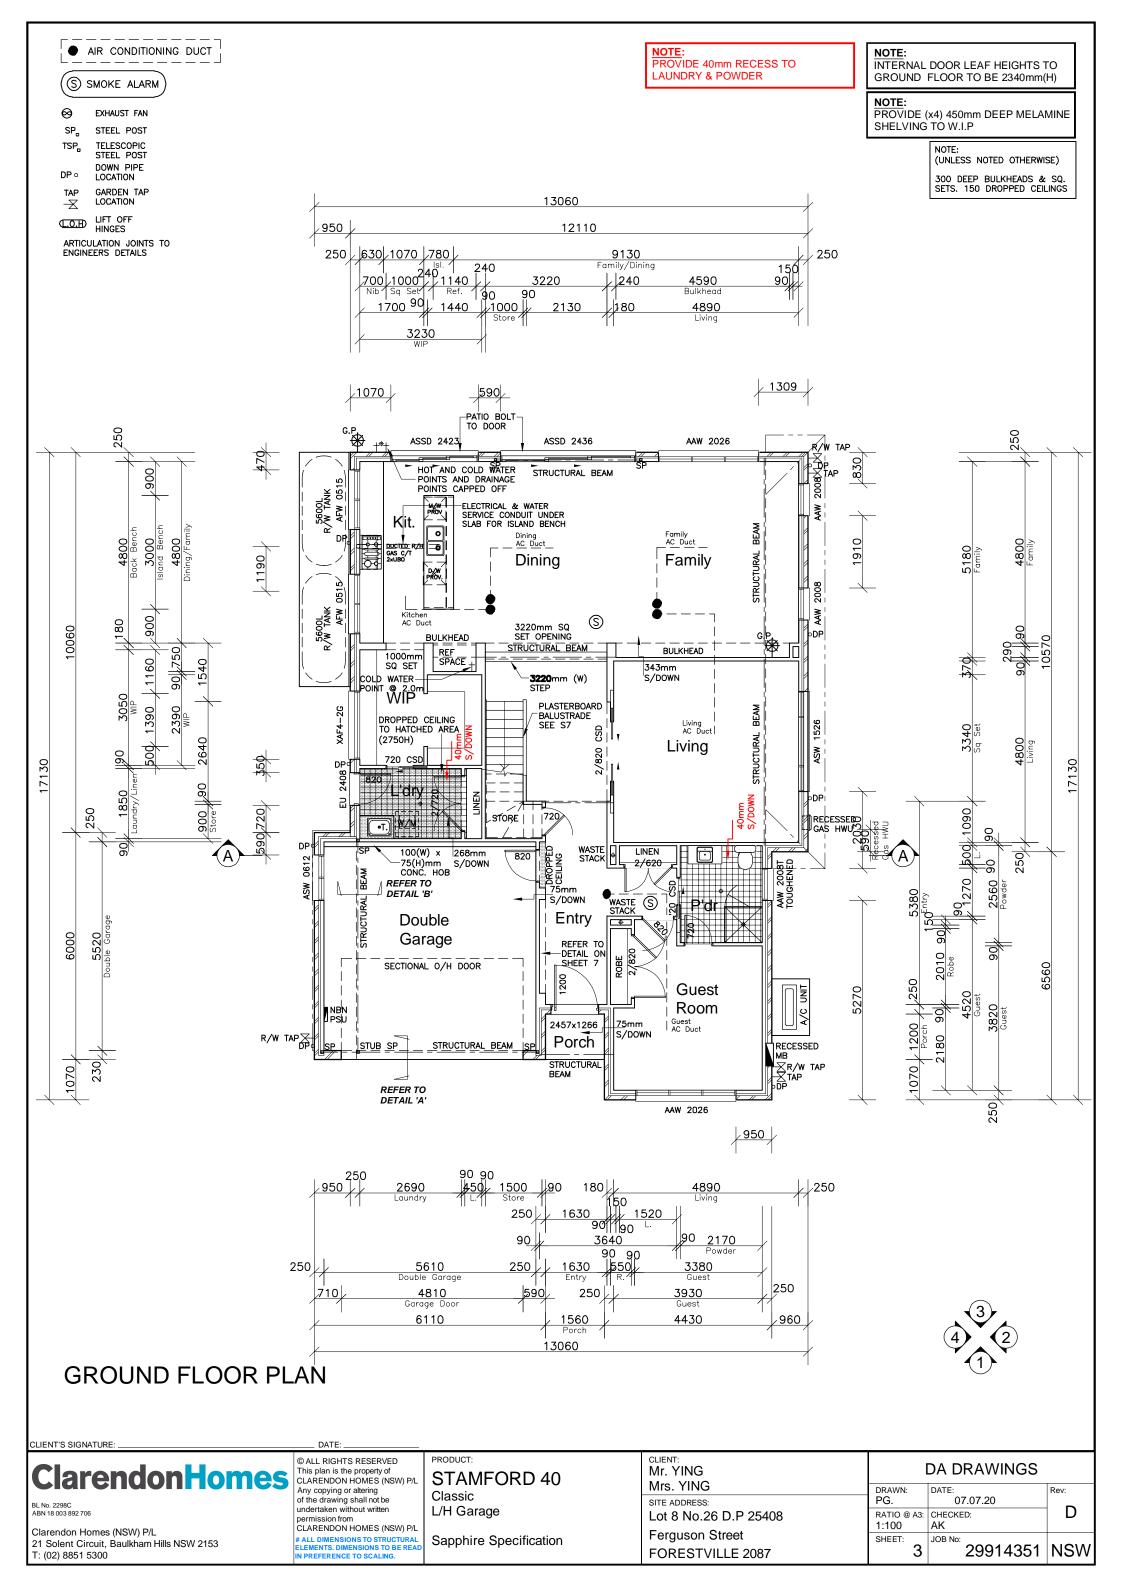
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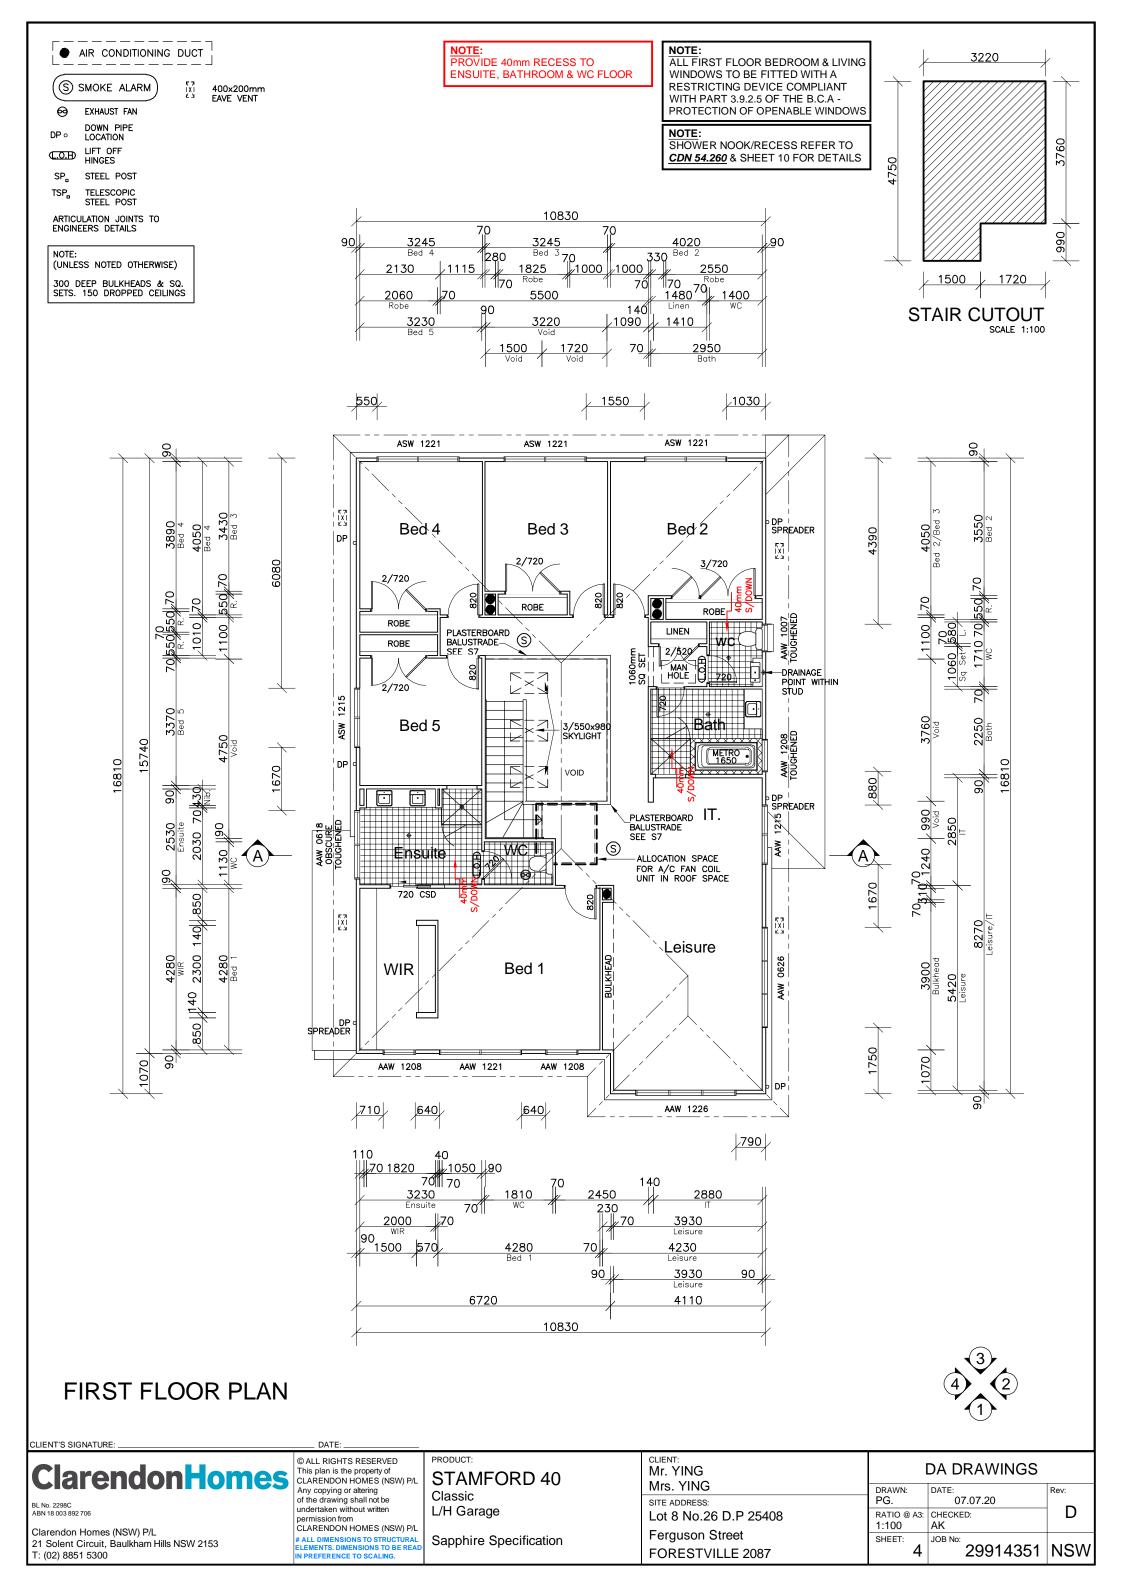
STAMFORD 40 Classic L/H Garage


Sapphire Specification Master Issued: 20.04.20


CLIENT: Mr. YING		DA DRAWINGS	
Mrs. YING	DRAWN:	DATE:	Rev:
SITE ADDRESS:	PG.	07.07.20	_
Lot 8 No.26 D.P 25408	RATIO @ A3:	CHECKED:	D
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Ferguson Street	SHEET:	JOB No:	
FORESTVILLE 2087	1	29914351	NSW







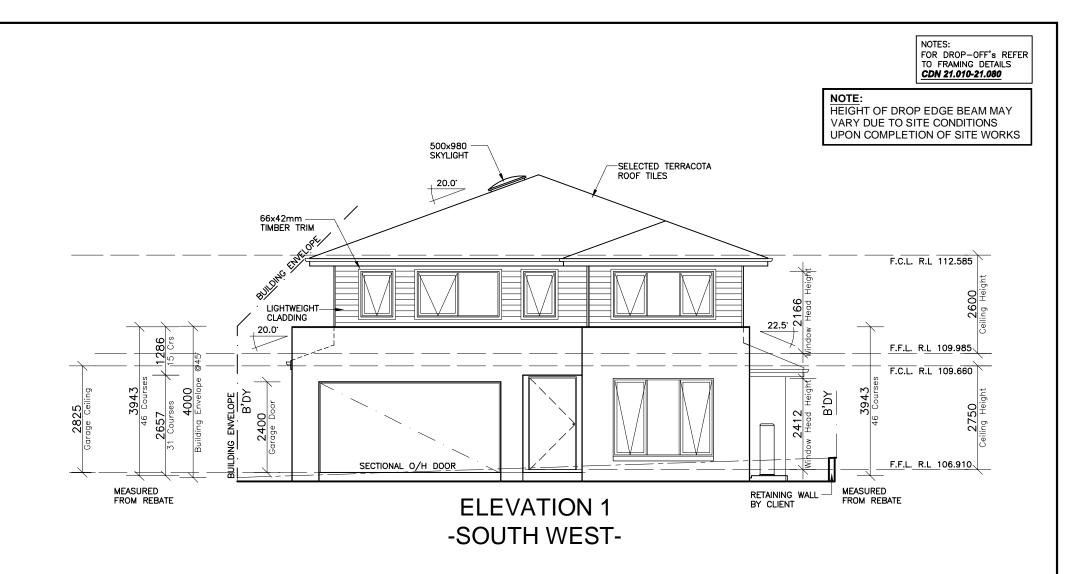

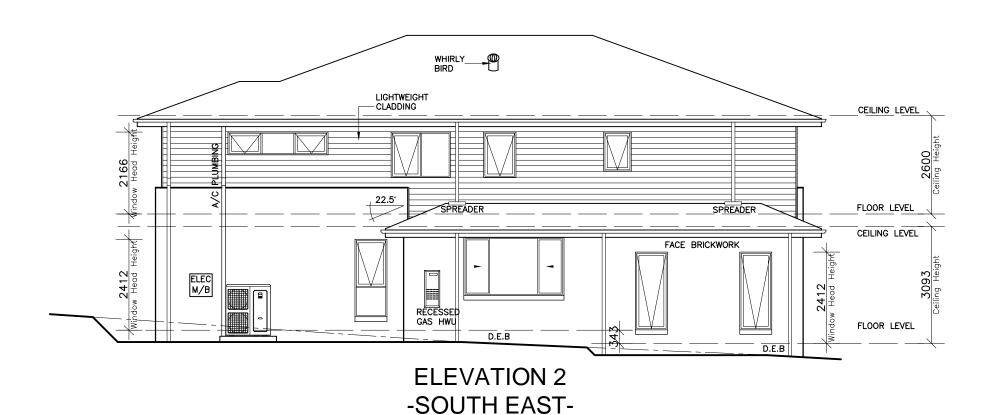

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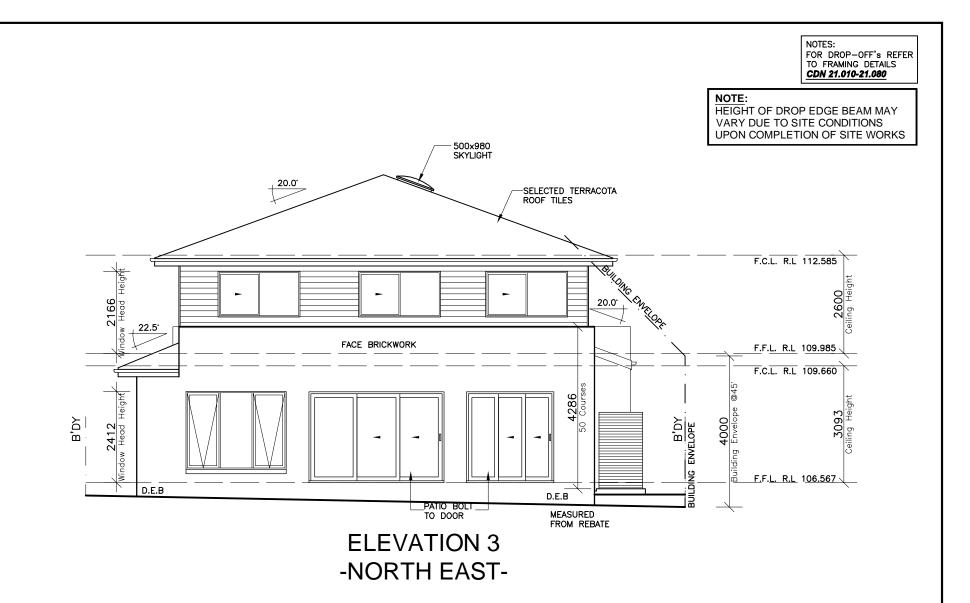
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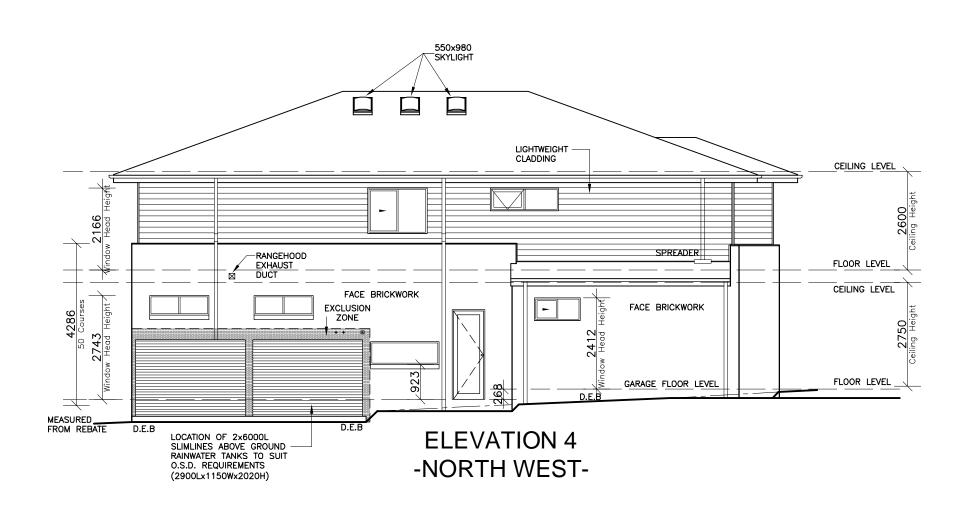
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IN PREFERENCE TO SCALING.

STAMFORD 40 Classic L/H Garage

Sapphire Specification

CLIENT: Mr. YING	DA DRAWINGS			
Mrs. YING	DRAWN:	DATE:	Rev:	
SITE ADDRESS:	PG.	07.07.20		
Lot 8 No.26 D.P 25408	RATIO @ A3: 1:100	CHECKED:	ט	
Ferguson Street	SHEET:	JOB No:		
FORESTVILLE 2087	5	29914351	NSW	





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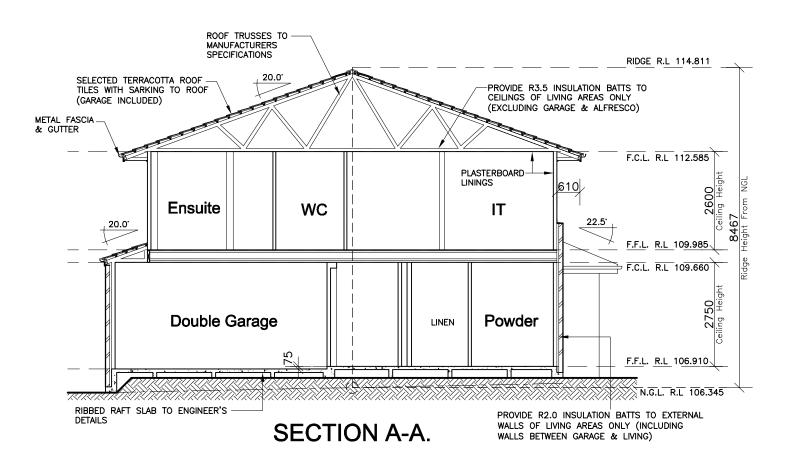
STAMFORD 40 Classic L/H Garage


Sapphire Specification

CLIENT: Mr. YING	DA DRAWINGS				
Mrs. YING	DRAWN:	DATE:	Rev:		
SITE ADDRESS:	PG.	07.07.20	_		
Lot 8 No.26 D.P 25408	RATIO @ A3: 1:100	CHECKED:	ט		
Ferguson Street	SHEET:	JOB No:			
FORESTVILLE 2087	6	29914351	NSW		

NOTE: INTERNAL DOOR LEAF HEIGHTS TO GROUND FLOOR TO BE 2340mm(H)

PROVIDE R2.0 INSULATION BATTS TO CEILING JOISTS BETWEEN GARAGE & FIRST FLOOR



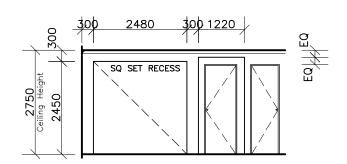

ENTRY HALLWAY DETAIL

CLIENT'S SIGNATURE:

T: (02) 8851 5300

DATE:

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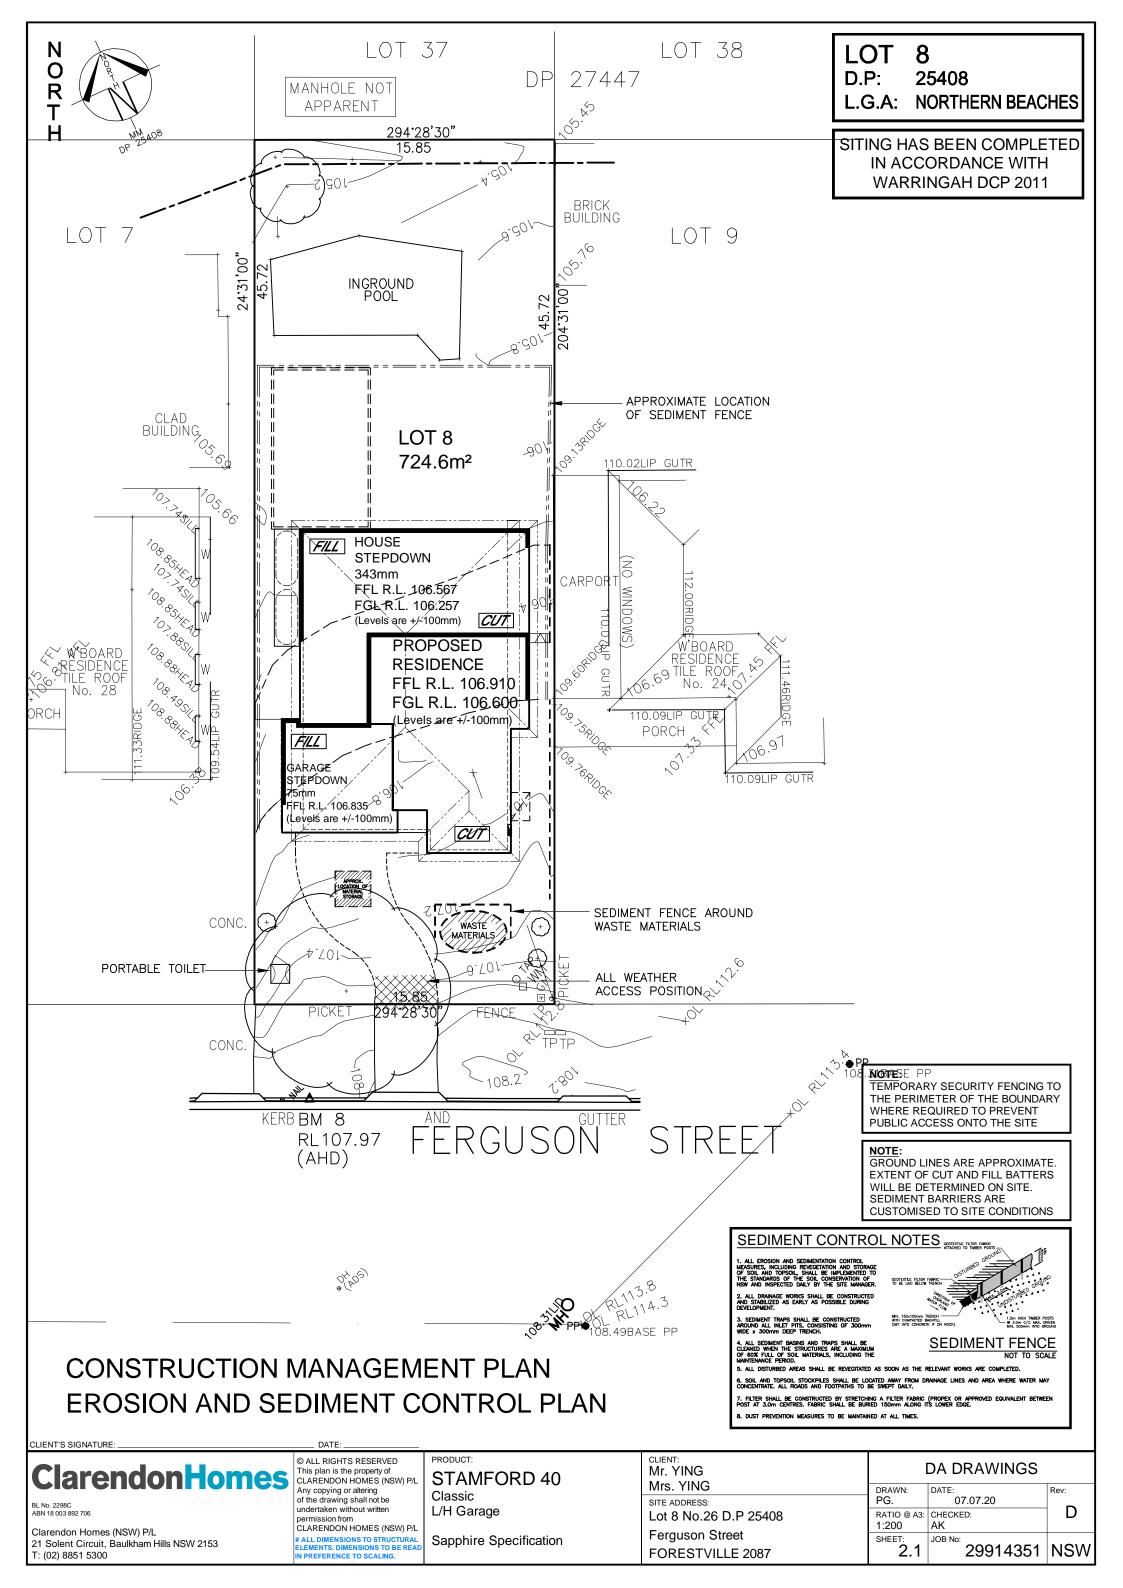
Sapphire Specification


CLIENT: Mr. YING DA DRAWINGS Mrs. YING DRAWN: DATE: PG. 07.07.20 SITE ADDRESS: Lot 8 No.26 D.P 25408 RATIO @ A3: CHECKED: 1:100 AK Ferguson Street SHEET: JOB No: 29914351 FORESTVILLE 2087

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STAMFORD 40 Classic L/H Garage

Sapphire Specification

 Mr. YING
 DA DRAWINGS


 Mrs. YING
 DRAWN: PG. 07.07.20

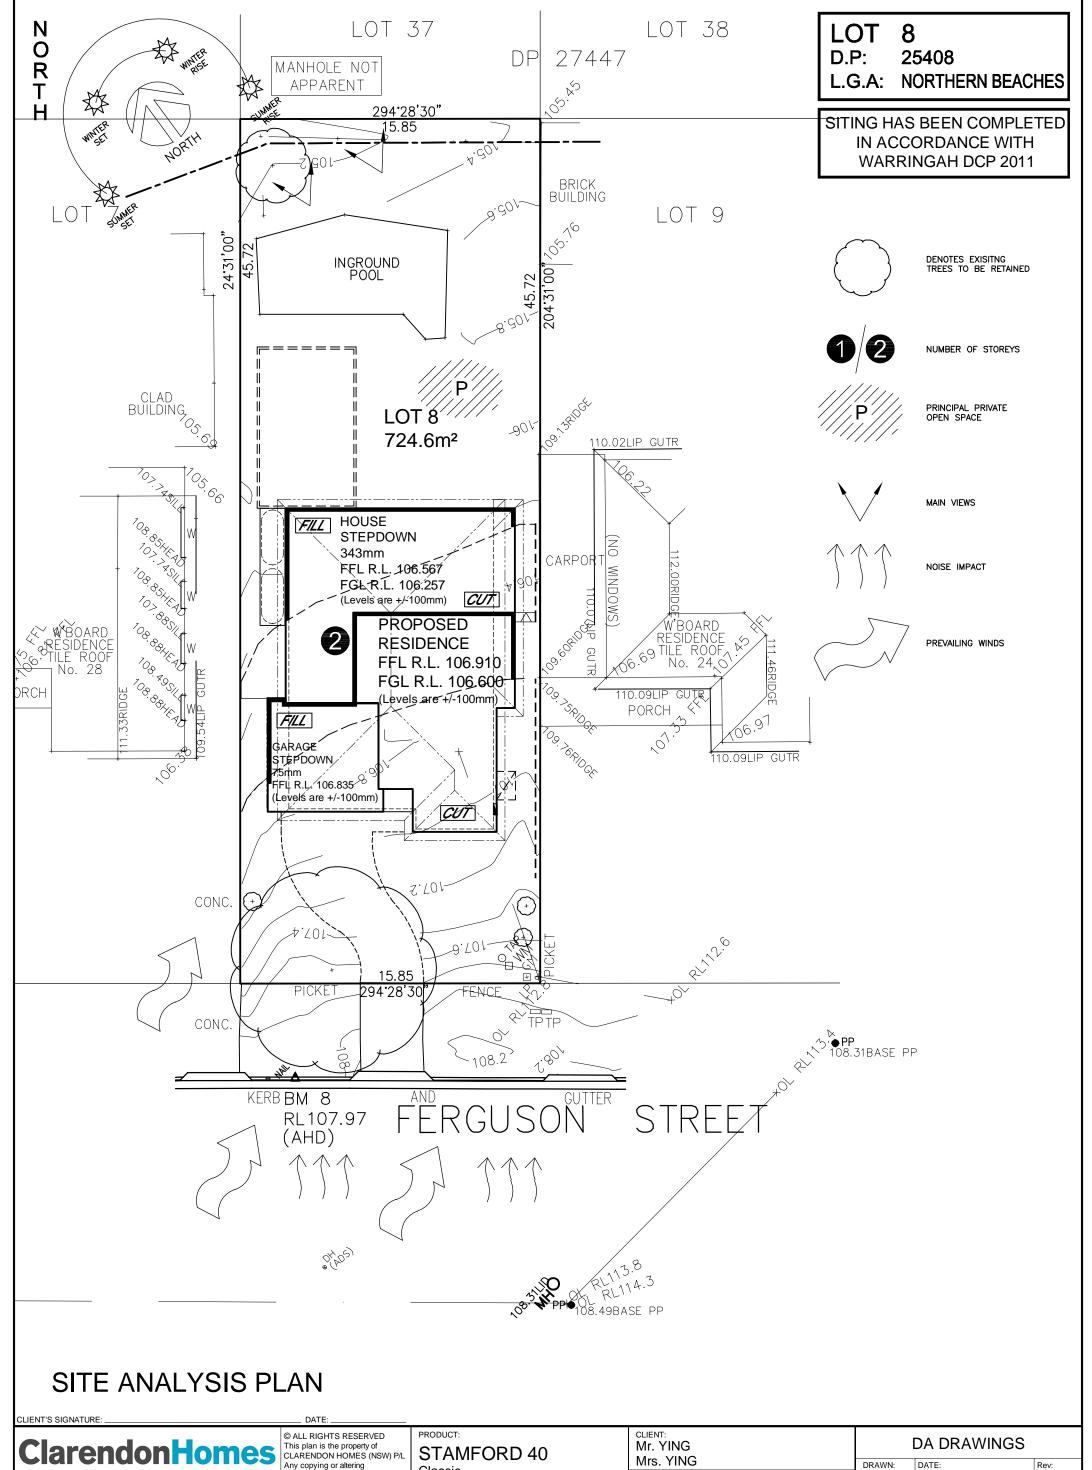
 SITE ADDRESS: Lot 8 No.26 D.P 25408
 PG. 07.07.20

 Ferguson Street
 RATIO @ A3: CHECKED: AK

 FORESTVILLE 2087
 JOB NO: 29914351

 NSW

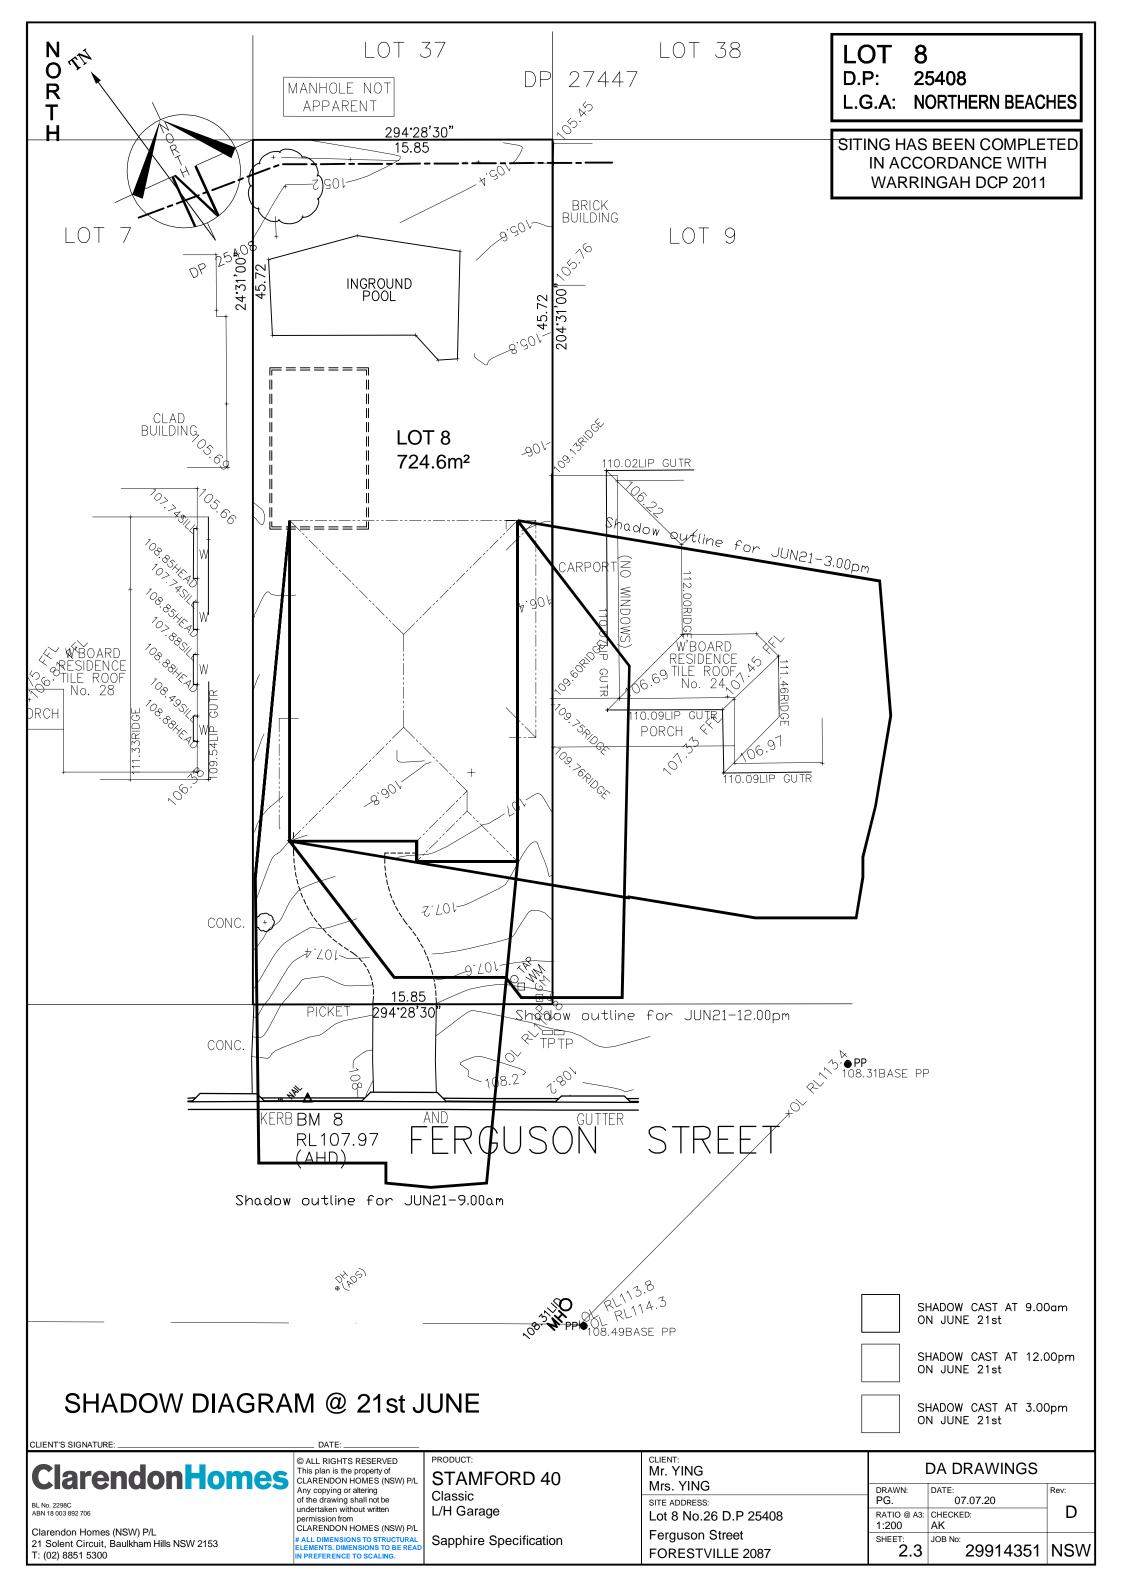


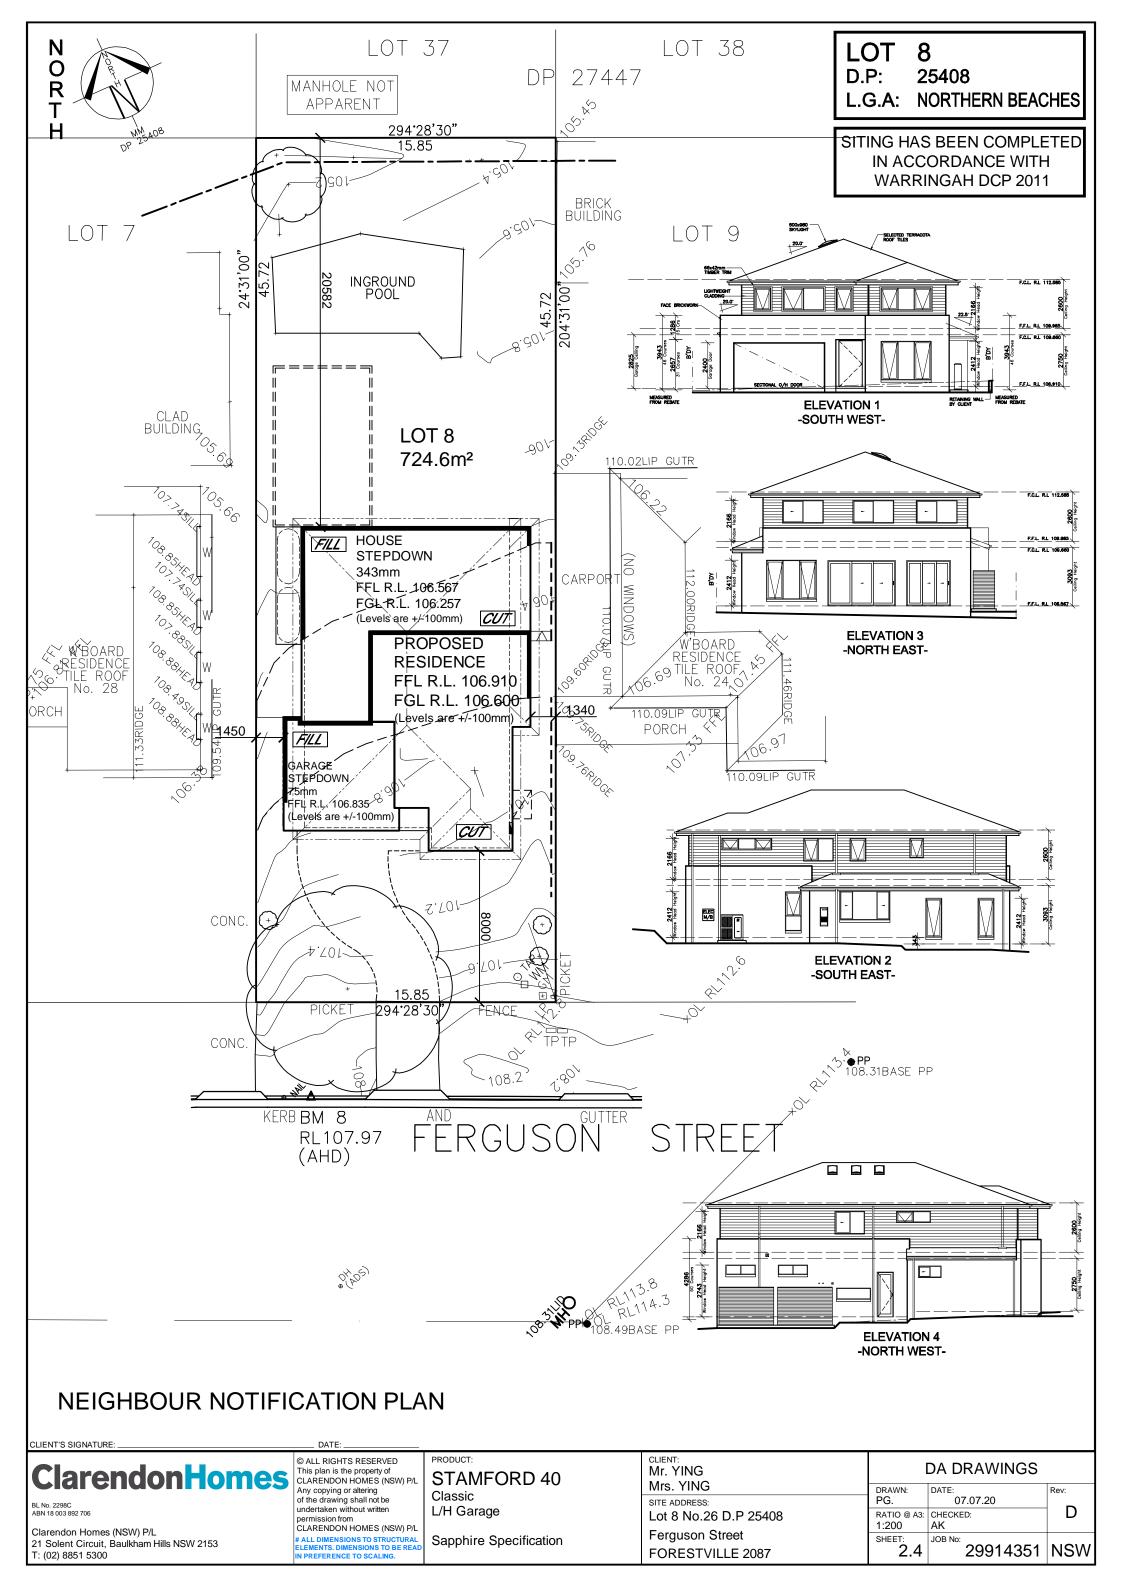


LOT 8 D.P: 25408

L.G.A: NORTHERN BEACHES


SITING HAS BEEN COMPLETED IN ACCORDANCE WITH WARRINGAH DCP 2011

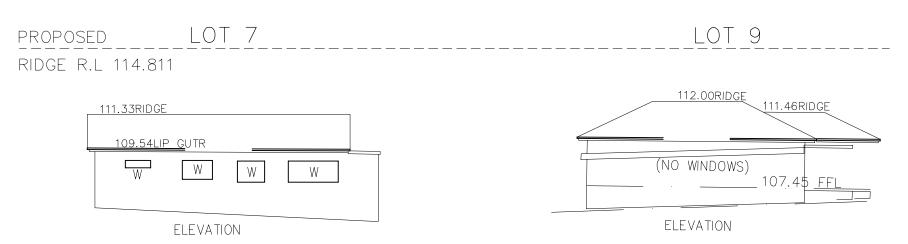

Shadow outline for JUN21-9.00am

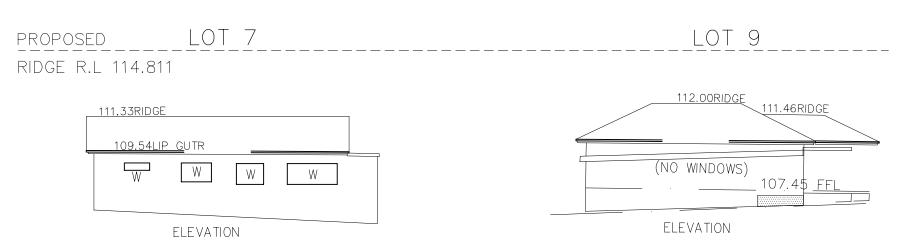


Shadow outline for JUN21-9.00am

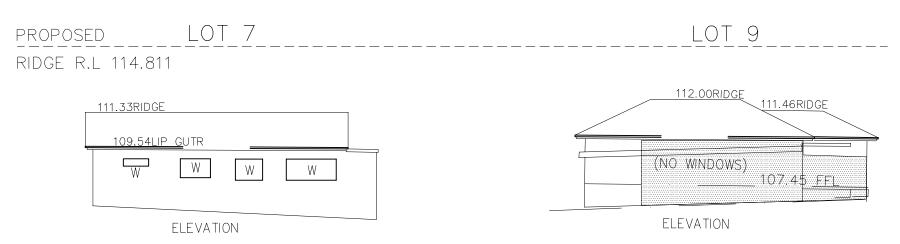

Shadow outline for JUN21-9.00am

ELEVATIONAL SHADOWS @ 21st JUNE

CLIENT'S SIGNATURE:	DATE:					
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BL No. 2298C	of the drawing shall not be	Classic	Mrs. YING SITE ADDRESS:	DRAWN: PG.	DATE: 07.07.20	Rev:
ABN 18 003 892 706	undertaken without written permission from CLARENDON HOMES (NSW) P/L	L/H Garage	Lot 8 No.26 D.P 25408	RATIO @ A3: 1:200	CHECKED: AK	D
Clarendon Homes (NSW) P/L 21 Solent Circuit, Baulkham Hills NSW 2153 T: (02) 8851 5300	# ALL DIMENSIONS TO STRUCTURAL ELEMENTS. DIMENSIONS TO BE READ IN PREFERENCE TO SCALING.	Sapphire Specification	Ferguson Street FORESTVILLE 2087	SHEET: 2.5	JOB No: 29914351	NSW

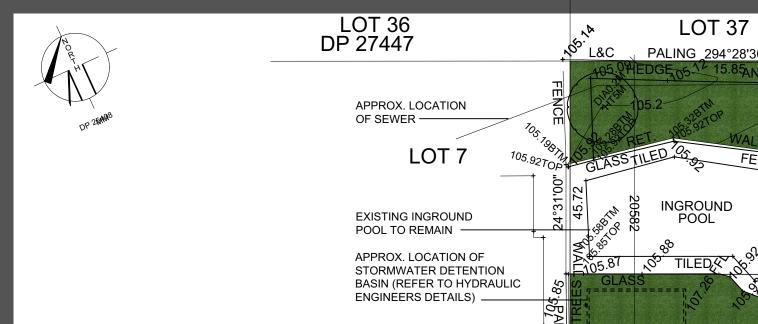

LOT 37 DP 27447 **LOT 38** Legend PALING 294°28'30" FENCE Colour Concrete / Paving HEDGE 05.16 15.85 AND **Mulched Paths Planting Areas** Lawn Areas BRICK BUILDING **Retaining Wall** LOT 9 1800mm High Boundary Fencing FENCE **Existing Trees To Be Removed Existing Trees To Be Retained** BANEL CLAD BUILDING 110.02LIP GUTR DROP EDGE BEAM <u>0.600H</u> F.F.L TO N.G.L-HOUSE CARPORTO ON 1100 **STEPDOWN** Timber sleeper or masonry retaining 343mm FFL R.L. 106.567 W'BOARD W'BOARD RESIDENCE TILE ROOF **PROPOSED** RESIDENCE TILE ROOF No. 28 **RESIDENCE** No. 24 FFL R.L. 106.910 rw 106.800 110.09LIP GUTR BW 106.740 **PORCH** 106.97 GARAGE STEPDOWN 75mm Timber sleeper or masonry retaining FFL R.L. 106.835 110.09LIP GUTR Side gates are to be set back from front facade. Side fences are not to extend forward of the side gate TW 107.14 3W 106.74 Brick or timber edging to all garden beds CONC. 3-Mglg Front fence and integrated letterbox to **EXISTING CROSSOVER** TO REMAIN 108.2 FERGUSON STREET KERBM 8 RL107,97

(AHD)

Revision Schedule

By: Date: Issue: | Description: Submission Plan JS 31/07/20

Drafted: Scale: 1:200 JS

Sheet: Reference: 1 of 4 LP 01

Designed by:

Julian Saw Diploma of Horticulture (Landscape Design)

 See Architects drawings for site levels, setbacks and extent of cut and fill.

manufacturer/engineers specifications.

- 2. This plan shall be read in conjunction with the Hydrauli
- Ingineers drawings 3. All relevant australian standards are to be adhered to.
- 4. Any structural items are to be installed as per the

SITE CALCULATIONS LOT AREA 724.6 sq m

LANDSCAPED AREA TOTAL 350.9 sq m

Click Here to View Our Plant Profiles!

Mr Ying Mrs Ying

Client Signatures:

2.

Job No. 200236

Drawing: Landscape Plan

Address: Lot 8 No. 26 Ferguson Street

Forestville

Council: **Northen Beaches/DA**



Ph: 0437 043 112 www.dappledesigns.com.au

Any existing trees are to be protected in accordance with councils Tree **Protection Detail**

Side gates are to be set back from

front facade. Side fences are not to

extend forward of the side gate

Coloured concrete or paved

LANDSCAPE SPECIFICATION

SITE ESTABLISHMENT

ALL RUBBISH, DEBRIS, FALLEN BRANCHES SHALL BE CLEARED FROM LANDSCAPED AREAS AND DISPOSED OF USING SKIP BINS ONSITE OR BY TRANSPORTING TO THE LOCAL WASTE MANANAGEMENT FACILITY. ANY UNUSED BRICKS, CONCRETE BLOCKS OR TIMBER SHOULD BE EITHER RE-USED ONSITE WHERE POSSIBLE OR RECYCLED AT THE LOCAL WASTE MANANAGEMENT FACILITY.

TREE PROTECTION

TREES TO BE RETAINED SHALL BE PROTECTED DURING SITE WORKS AND TREE PROTECTION BARRIERS INSTALLED ACCORDING TO TREE PROTECTION DETAILS. NO EXCAVATION OR CHANGE IN SOIL LEVEL SHOULD TAKE PLACE AROUND THE BASE OF SUCH TREES. ANY ARBORIST REPORT MUST BE ADHERED TO AND TREE PROTECTION ZONES MAINTAINEDWHERE APPLICABLE.

WEED ERADICATION

AREAS TO BE LANDSCAPED ARE TO BE SPRAYED WITH GLYPHOSATE AT THE RECOMMENDED RATE AT LEAST 1 WEEK PRIOR TO ANY LANDSCAPE WORKS TAKING PLACE IN ORDER TO ALLOW WEEDS TO DIE OFF. CARE IS TO BE TAKEN TO PROTECT REMAINING VEGETATION FROM THE HERBICIDE APPLICATION AND SHOULD ONLY BE UNDERTAKEN IN STILL WEATHER. ALL WEEDS ARE THEN TO BE DISPOSED OF APPROPRIATELY AT THE LOCAL WASTE MANANAGEMENT FACILITY.

GARDEN BED PREPERATION

ENSURE ALL GARDEN BEDS HAVE BEEN EXCAVATED TO 250MM BELOW FINISHED LEVELS. RIP THE SUBGRADE A FURTHER 100MM IN DEPTH. INSTALL PREMIUM GARDEN SOIL OR MIX NATURAL TOP SOIL WITH IMPORTED SOIL TO A DEPTH OF 250MM. INSTALL 75MM DEPTH OF LEAF LITTER MULCH FROM ANL LANDSCAPE SUPPLIES OR EQUIVALENT.

EXCAVATE LAWN AREAS TO A DEPTH OF 100MM BELOW REQUIRED FINISHED LEVELS. DO NOT EXCAVATE WITHIN WITHIN TREE PROTECTION ZONES WHERE APPLICABLE OR WITHIN 1500MM OF THE TRUNK OF ANY EXISTING TREES TO BE RETAINED. ENSURE THAT ALL SURFACE WATER IS DIRECTED TOWARD ANY DRAINAGE PITS, KERBS AND AWAY FROM ANY BUILDINGS. SUBGRADE IS TO BE RIPPED TO A DEPTH OF 150MM AND A 50MM DEEP LAYER OF TURF UNDERLAY INSTALLED ON TOP. LAWNS SHOULD HAVE AN EVEN GRADE SO THAT NO PONDING OR POOLING OCCURS. 'SIR LAUNCHER' FERTILISER OR EQUIVELANT SHOULD BE SPREAD OVER LAWN AREAS PRIOR TO LAYING TURF. LAY 'SIR WALTER BUFFALO' TURF ROLLS CLOSELY BUTTED ENSURING NO GAPS BETWEEN ARE PRESENT. ROLL AND WATER THOROUGHLY AFTER LAYING.

PLANTS ARE TO BE HEALTHY. FREE OF PEST/DISEASES AND TRUE TO TYPE & SPECIES, REFER TO LANDSCAPE PLAN FOR LOCATION AND SPACING. ALL PLANTS SHOULD BE PLACED IN A HOLE DUG TWICE THE SIZE OF THE POT. GENTLY TEESE THE ROOTS OF ANY POT BOUND PLANTS. THE BASE OF THE TRUNK SHOULD BE INSTALLED LEVEL WITH THE SURFACE OF THE GROUND AND DISH CREATED AROUND THE BASE OF EACH PLANT TO AID WITH WATER RETENTION. WATER THOROUGHLY AFTER PLANTING.

STAKING

ALL TREES AND TOP HEAVY SCREENING SHRUBS SHOULD BE STAKED WITH 2 X 25MM X 25MM LONG TIMBER STAKES PER PLANT. LENGTH OF STAKES IS DEPENDENT ON THE HEIGHT AND STABILITY OF THE TREE/SHRUB. STAKES SHOULD BE FIRMLY POSITIONED. HESSIAN TAPE IS TO BE PLACED AROUND THE TREE AND STAKES ALLOWING SOME MOVEMENT IN ORDER TO ALLOW THE TRUNK TO DEVELOP STRENGTH OVERTIME.

GARDEN EDGING

USE EITHER "HAVEN" BRICK EDGING OR SIMILAR LAID ON A 50MM THICK BED OF MORTAR, OR TREATED TIMBER **EDGING** SECURED WITH INGROUND TIMBER STAKES. ALL GARDENS ARE TO HAVE EDGING INSTALLED AND BE INSTALLED AS PER PLAN.

RETAINING WALLS

REFER TO MANUFACTURERS INSTRUCTIONS FOR CONSTRUCTION OF RETAINING WALLS. DETAILS ON THIS PLAN ARE A GUIDE ONLY.

COMPLETION

SITE IS TO BE CLEARED OF ANY SURPLUS MATERIALS AND DEBRIS PRIOR TO PRACTICAL COMPLETION. WORK IS TO BE COMPLETED TO THE SATISFACTION OF COUNCILS GUIDELINES AND ANY DA CONDITIONS

MAINTENANCE PERIOD

A 12 MONTH MAINTENANCE PERIOD FROM THE DATE OF PRACTICAL COMPLETION WILL APPLY. DURING THIS TIME THE OWNER IS RESPONSIBLE FOR RECTIFYING ANY DEFECTIVE WORK. DURING THE MAINTENACE PERIOD THE FOLLOWING ACTIVITIES ARE

TO BE UNDERTAKEN

a) REPLACEMENTS: ANY PLANTS/TREES THAT HAVE DIED SHALL BE REPLACED WITH THE SAME SPECIES AND SIZE AS INDICATED ON THIS PLAN. THE SPECIMENS MUST BE IN GOOD HEALTH AND FREE FROM PESTS AND DISEASES. b) WATERING: REGULAR WATERING OF PLANTS IS REQUIRED. PLANTS SHOULD BE WATERED TWICE A WEEK WITHIN

2 MONTHS OF PLANTING AND AND DURING DRY PERIODS. LESS FREQUENT WATERING IS REQUIRED ONCE PLANTS ARE ESTABLISHED AND DURING PERIODS OF RAIN. THE CONTRACTOR/OWNER SHOULD USE THEIR DISCRETION. c) GARDEN BEDS: GARDEN AREAS SHOULD BE REGULARLY WEEDED AND MULCH TOPPED UP IF REQUIRED. NO BARE

SOIL IS TO BE PRESENT AND SPECIFIED DEPTHS MAINTAINED. d) LAWN AREAS: LAWN AREAS SHALL BE MOWN REGULARLY (AT LEAST ONCE A WEEK IN GROWING SEASON) IN ORDER TO PROMOTE A THICK LAWN THAT OUTCOMPETES ANY WEEDS. LAWN CLIPPINGS ARE NOT TO BE SPREAD OVER GARDEN AREAS. ANY DEAD AREAS OF LAWN OCCURING THE MAINTENANCE PERIOD, ARE TO BE REPLACE WITH THE TURF VARIETY SPECIFED IN THE PLAN.

e) PRUNING: ADEQUATE HORTICULTURAL PRUNING METHODS SHOULD BE USED ON PLANTS AS BECOMES NECESSARY. ANY HEDGES ARE TO BE TRIMMED REGULARLY, DEAD AND DANGEROUS TREE BRANCHES PRUNED AND LIGHT PRUNING OF SHRUBS TO PROMOTE THICK FOLIAGE COVER.

f) FERTILISING: 'ORGANIC LIFE' FERTILISER OR EQUIVELANT SHALL BE APPLIED AS PER MANUFACTURERS INSTRUCTIONS TO ALL GARDEN BEDS ONCE PER MONTH. DYNAMIC LIFTER OR SIMILAR SHOULD BE APPLIED TO ALL LAWN AREAS TWICE A YEAR, ONCE IN MID SPRING AND ONCE IN EARLY SUMMER. WATER THOROUGHLY AFTER EACH APPLICATION OF FERTILISER.

PLANT LIST

TYPE	SYMBOL	BOTANIC NAME	COMMON NAME	MATURE HEIGHT X WIDTH	NATIVE?	QTY	POT SIZE
TREES							
	Mglg	MAGNOLIA 'LITTLE GEM'	LIITLE GEM MAGNOLIA	5M X 3M	NO	3	45LTR
	Рс	PYRUS CALLERYANA 'CAPITAL'	CAPITAL PEAR	11M X 3M	NO	1	45LTR
SHRUBS							
	Gf	GARDENIA FLORIDA	GARDENIA FLORIDA	1.5M X 1M	NO	6	200MM

Revision Schedule

Issue:	Descripti	on:	By:	Date:	
Α	Submission	Plan	JS	31/07/20	
Drafted:		Scal	e: 1:2	00	

JS Sheet: Reference: 2 of 4 LP 01

Designed by:

Julian Saw Diploma of Horticulture (Landscape Design)

General Notes:

- See Architects drawings for site levels, setbacks and extent of cut and fill.
- 2. This plan shall be read in conjunction with the Hydraulie ngineers drawings.
- 3. All relevant australian standards are to be adhered to.
- 4. Any structural items are to be installed as per the manufacturer/engineers specifications.
- 5. This plan is indicative only and not for construction purposes
- SITE CALCUL ATIONS

	LANDSCAPED AREA TOTAL	350.9 sq m	48.425%
	LOT AREA	724.6 sq m	
- 1			
- 1	JITE CALCULATIONS		

Click Here to View Our Plant Profiles!

Mr Ying Mrs Ying

Client Signatures:

2.

Job No. 200236

Drawing: Plant List/Specification


Address: Lot 8 No. 26 Ferguson Street **Forestville**

Council:

Northen Beaches/DA



Ph: 0437 043 112 www.dappledesigns.com.au

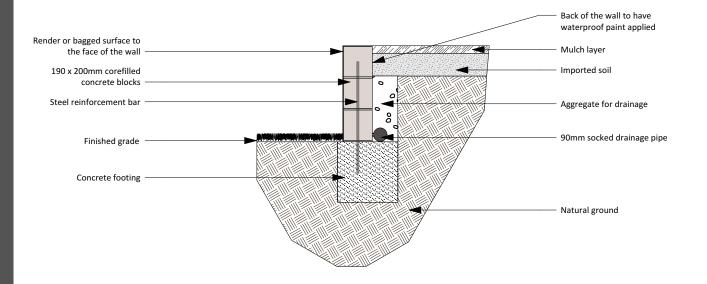

75mm x 200mm treated pine sleepers Bevelled edge 75mm x 200mm treated pine sleepers as posts 125mm galvanised bugle screws Finished grade Concrete footing Geotech fabric Mulch layer Imported soil Aggregate for drainage 90mm socked drainage pipe

DETAILS


- 1. ENSURE THAT THERE IS ADEQUATE DRAINAGE BEHIND THE WALL
- 2. WALL IS TO BE STAIGHT
- 3. REFER TO PLAN FOR HEIGHTS
- 4. REFER TO ENGINEERS PLANS FOR WALLS OVER EXEMPT & COMPLYING DEVELOPMENT HEIGHTS

RENDERED/BAGGED RETAINING WALL DETAIL

SCALE 1:25

TOP VIEW

FRONT VIEW

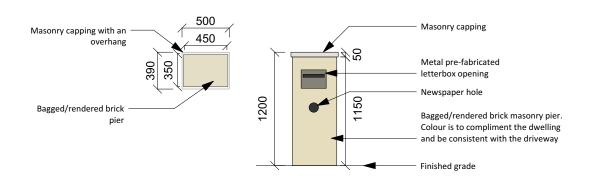

DETAILS

- 1. COLOUR CHOSEN IS TO COMPLIMENT THE DWELLING
- 2. ENSURE THAT NO CEMENT OR RENDER IS LEFT ON THE BRICKWORK OR LETTERBOX OPENING
- 3. BRICK PIER IS TO LEVEL AND STRAIGHT


LETTERBOX DETAIL

SCALE 1:40

DETAILS

- 1. ENSURE THAT THERE IS ADEQUATE DRAINAGE BEHIND THE WALL
- 2. WALL IS TO BE STAIGHT OR SLIGHTLY SLANTED TOWARDS THE SOIL BEING RETAINED
- 3. TIMBER IS TO BE FREE OF CRACKS AND KNOTS
- 4. REFER TO PLAN FOR HEIGHTS
- 5. REFER TO ENGINEERS PLANS FOR WALLS OVER EXEMPT & COMPLYING DEVLOPMENT HEIGHTS

TREATED TIMBER RETAINING WALL DETAIL

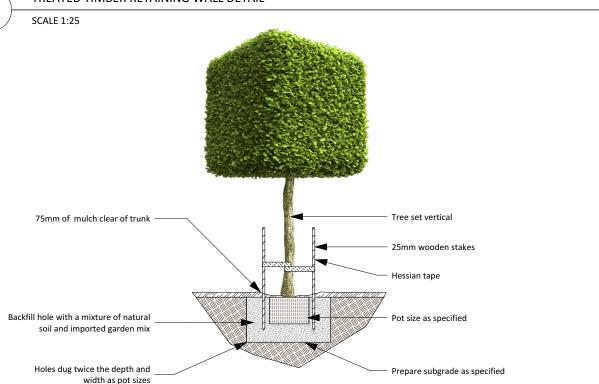

DETAILS

- 1. SPECIMENS ARE TO BE IN GOOD HEALTH AND FREE FROM PESTS AND DISEASES
- 2. WATER THROUROUGHLY AFTER PLANTING

TREE PLANTING DETAIL

SCALE 1:40

Revision Schedule

Issue:	Description:	Ву:	Date:
Α	Submission Plan	JS	31/07/20

Drafted:	Scale: 1:200		
JS	0 0 1 2 3M		
Sheet:	Reference:		
3 of 4	LP 01		

Designed by:

Julian Saw Diploma of Horticulture (Landscape Design)

Conoral Notos

- 1. See Architects drawings for site levels, setbacks and extent of cut and fill.
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SITE CALCULATIONS

LOT AREA	724.6 sq m
<u> </u>	

LANDSCAPED AREA TOTAL 350.9 sq m 48.425%

Click Here to View Our Plant Profiles!

Client: Mr Ying Mrs Ying

Client Signatures:

2.

•

Job No. **200236**

Drawing: Construction Details


Address: Lot 8 No. 26 Ferguson Street


Forestville

Council: Northen Beaches/DA



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DETAILS

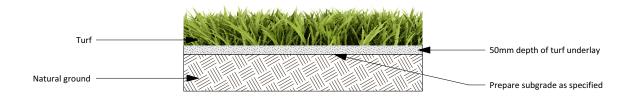- 1. TURF ROLLS ARE TO BE IN GOOD HEALTH, FREE FROM PESTS AND DISEASES AND WITHOUT HOLES
- 2. APPLY WATER SAVING CRYSTALS TO THE GROUND PRIOR TO LAYING
- 3. BUT ROLLS CLOSELY TOGETHER TO AVOID GAPS AND DIEBACK
- 4. WATER THROUROUGHLY AFTER PLANTING AND REGULARLY UNTIL ESTABLISHED

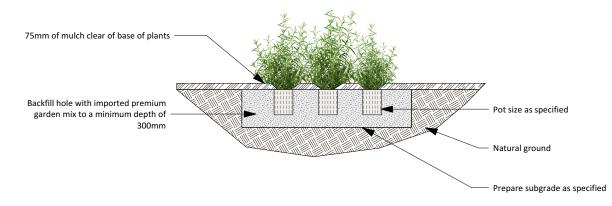TURF LAYING DETAIL

SCALE 1:20

DETAILS

- 1. SPECIMENS ARE TO BE IN GOOD HEALTH AND FREE FROM PESTS AND DISEASES
- 2. GENTLY LOOSEN ROOTS IF REQUIRED, PRIOR TO PLANTING
- 3. WATER THROUROUGHLY AFTER PLANTING
- 4. REFER TO PLAN FOR QUANTITIES AND SPACING

SHRUB & GROUNDCOVER PLANTING DETAIL

SCALE 1:30

Revision Schedule

Issue:	Description:	By:	Date:		
Α	Submission Plan	JS	31/07/20		

Drafted: Scale: 1:200

Sheet:

Reference:

4 of 4 LP 01

Designed by:

Julian Saw Diploma of Horticulture (Landscape Design)

General Note

- 1. See Architects drawings for site levels,
- setbacks and extent of cut and fill.
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LANDSCAPED AREA TOTAL 350.9 sq m 48.425%

SITE CALCULATIONS

LOT AREA 724.6 sq m

Click Here to View Our Plant Profiles!

Client: Mr Ying
Mrs Ying

Client Signatures:

1.

2.

Job No. **200236**

Drawing: Planting Details

Address: Lot 8 No. 26 Ferguson Street

Forestville

ncil[.]

Northen Beaches/DA



Ph: 0437 043 112 www.dappledesigns.com.au

LIFESTYLE

- STUDIO -

BY CLARENDON HOMES

Client:	Mr Christopher and Mrs Natalie Ying			
Site Address:	Lot 8 Ferguson Street, Forestville			
Job Number:	29914351	House Type:	Stamford 40	
Date Issued:	7/8/20	Developer:	n/a	

	Roof BASIX Rating:	dark	Wall BASIX Rating:	dark	
--	--------------------	------	--------------------	------	--





Window Frame Colour: Pearl white


Front Entry Door Colour: Stained, sikkens silver grev



Other:

Applied Render Finish: Not applicable

Gutter: surfmist Fascia: surfmist

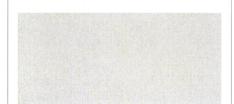

Lightweight Cladding: t/m Foxtail t161 5nh43



Driveway Colour: grey

*By client after handover

Roof Type/Style/Colour: Terracotta shingle tile, eclipse



Downpipes: t/m foxtail

t161 5nh43

Watertank: monument



Garage Door Type/Colour: Flatline, surfmist



Letterbox:

*By client after handover

NOTE: Colours are indicative only and should not be used as a true representation of the product.