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Mona Vale NSW 1660
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Environmental Compliance 8am to 6pm Mon - Thurs, 8am to 5pm Fri Phone 9970 1111

7 September 2009

Frank & Marie Nero 13 Alameda Way WARRIEWOOD NSW 2102



Dear Frank and Marie Nero

Re Modified Construction Certificate CC0246/09
Property 13 ALAMEDA WAY WARRIEWOOD NSW 2102

Please find enclosed your approved Modified Construction Certificate and stamped plans

Yours faithfully **Development Compliance Group**

Per



Site Details

13 ALAMEDA WAY WARRIEWOOD NSW 2102

Legal Description

Lot 21 DP 228171

Type of Development

Building Work

Modified Construction Certificate – Alteration to swimming pool Description

shape and volume only

Associated Development Consent No

N0210/09

Dated

15/07/2009

COPY

Building Code of Australia Certification Class 10b

Details of plans, documents or Certificates to which this Certificate relates

- Swimming pool site plan and structural engineering details prepared by John Cavasınni and Associates P/L Drawing No.- 2009PR1063A Sheet 1/2 and Sheet 2/2 Amendment A dated 3 September 2009
- BASIX Certificate number A66155 dated 5 September 2009

I hereby certify that the above plans, documents or Certificates satisfy

- The relevant provisions of the Building Code of Australia, and
- The relevant conditions of Development Consent No N0210/09

And, that work completed in accordance with the documentation accompanying the application for this certificate (and any modifications as verified by me and shown on that documentation) will comply with the requirements of the Environmental Planning and Assessment Regulation, referred to in section 81A(5) of the Epyrronmental Planning and Assessment Act, 1979

Darren Greenow

Development Compliance Group

7 September 2009 **Date of Endorsement**

Note You are reminded that pursuant to provisions of Clause 81A, you must nominate whether Council or an accredited certifier will be the principal certifying authority, also you must give notice to Council of your intention to commence work at least two days beforehand

BASI

Building Sustainability Index www basix nsw gov au

Alterations and Additions

Certificate number A66155

This certificate confirms that the proposed development will meet the NSW government's requirements for sustainability, if it is built in accordance with the commitments set out below. Terms used in this certificate, or in the commitments, have the meaning given by the document entitled "BASIX Alterations and Additions Definitions" dated 29/9/2006 published by Department of Planning. This document is available at www basix nsw gov au

Director-General

Date of issue Saturday, 05 September 2009



NSW GOVERNMENT

Department of Planning

Description of project

Section number

0

7

Lot number

Project type

Dwelling type

Separate dwelling house

My renovation work is valued at \$50,000 or more, and includes a pool (and/or spa)

Type of alteration and

Plan type and number

Local Government Area

Pittwater Council

13 Alameda Way, Warriewood (Rev 2)

13 Alameda Way Warriewood 2102

Deposited Plan 228171

Project address
Project name
Street address

PHTTWATER COUNCIL CONSTRUCTION CERTIFICATE

Number CC 0246/09 mod

This is a copy of submitted plans, documents or Certificates associated with the issue of the Construction Certificate

Endorsed by

Date

17 5EP 2009

Show on Certifier CC/CDC Check Plans & specs
4
<u> </u>
<u> </u>
2.4.000,4.4.4.4.4.4.4.4.4.4.4.4.4.4.4.4.4

	<	The applicant must ensure new or altered taps have a flow rate no greater than 9 litres per minute or minimum 3 star water rating
<	<	The applicant must ensure new or altered toilets have a flow rate no greater than 4 litres per average flush or a minimum 3 star water rating
		Fixtures. The applicant must ensure new or altered showerheads have a flow rate no greater than 9 litres per minute or a 3 star water rating
<	<	light-emitting-diode (LED) lamps
	specs	
Certifier Check	Show on Show on DA Plans CC/CDC Plans &	

BASIX Certificate number A66155

		dark (solar absorptance > 0 70)	ceiling R2 50 (up), roof foil/sarking	flat ceiling, pitched roof
			nıl	external wall external insulated façade system (EIFS)(façade panel 70 mm)
			nil	floor above existing dwelling or building
			nii	concrete slab on ground floor
		Other specifications	Additional insulation required (R-value)	Construction
< 	۲	cots) in accordance with the specifications listed in construction is less than 2m2, b) insulation specified	tionstruction (floor(s), walls, and ceilings/ro tion is not required where the area of new cowhere insulation already exists	The applicant must construct the new or altered construction (floor(s), walls, and ceilings/roots) in account the table below, except that a) additional insulation is not required where the area of new construction is not required for parts of altered construction where insulation already exists
				insulation regulements
Show on Certifier CC/CDC Check Plans & specs	Show on DA Plans			Construction

	_		
			W3 N 06 0 none standard aluminium, single pyrolytic low-e, (U-value 5 7, SHGC 0 47)
			W2 E 0 72 0 eave/verandah/pergola/balcony standard alumınıum, sıngle pyrolytic low-e, >=450 mm (U-value 5 7, SHGC 0 47)
			W1 E 0 72 0 eave/verandah/pergola/balcony standard alumınıum, sıngle pyrolytic low-e, >=450 mm (U-value 5 7, SHGC 0 47)
			no. Height Distance inc. (m) (m) (m) (m2)
			ows and glazed doors gla w Orientation Area of
4	<		Pergolas with fixed battens must have battens parallel to the window or glazed door above which they are situated, unless the pergola also shades a perpendicular window. The spacing between battens must not be more than 50 mm.
H. A.	<		Pergolas with polycarbonate roof or similar translucent material must have a shading coefficient of less than 0 35
<	<	<	For projections described in millimetres, the leading edge of each eave, pergola, verandah, balcony or awning must be no more than 500 mm above the head of the window or glazed door and no more than 2400 mm above the sill
<	<		Each window or glazed door with improved frames, or pyrolytic low-e glass, or clear/air gap/clear glazing, or toned/air gap/clear glazing must have a U-value and a Solar Heat Gain Coefficient (SHGC) no greater than that listed in the table below. Total system U-values and SHGCs must be calculated in accordance with National Fenestration Rating Council (NFRC) conditions. The description is provided for information only. Alternative systems with complying U-value and SHGC may be substituted.
4	<		Each window or glazed door with standard aluminium or timber frames and single clear or toned glass may either match the description, or, have a U-value and a Solar Heat Gain Coefficient (SHGC) no greater than that listed in the table below. Total system U-values and SHGCs must be calculated in accordance with National Fenestration Rating Council (NFRC) conditions.
die,	<		The following requirements must also be satisfied in relation to each window and glazed door
· Committee of the comm	*	\	The applicant must install the windows, glazed doors and shading devices, in accordance with the specifications listed in the table below Relevant overshadowing specifications must be satisfied for each window and glazed door
			Windows and glazed doors
Certifier Check	Show on CC/CDC Plans & specs	Show on DA Plans	Glazing requirements

							Show on Certifier DA Plans CC/CDC Check Plans & specs
Window / door no.	Window Orientation / door no.	Area of glass inc. frame (m2)	Overshadowing Height Distan (m) (m)	Overshadowing Height Distance (m) (m)	Shading device	Frame and glass type	
W4	W		0	0	eave/verandah/pergola/balcony >=450 mm	standard aluminium, single pyrolytic low-e, (U-value 57, SHGC 047)	
W5	S	1 62	0	0	none	standard aluminium, single clear, (or U-value 7 63, SHGC 0 75)	
W6	Z	2 52	0	0	eave/verandah/pergola/balcony >=450 mm	standard aluminium, single pyrolytic low-e, (U-value 57, SHGC 047)	
W7	Z	07	0	0	eave/verandah/pergola/balcony >=450 mm	standard aluminium, single pyrolytic low-e, (U-value 57, SHGC 047)	
W8	Z	1 62	0	0	eave/verandah/pergola/balcony >=450 mm	standard aluminium, single pyrolytic low-e, (U-value 57, SHGC 047)	
W9	Z	2 52	0	0	eave/verandah/pergola/balcony >=450 mm	standard aluminium, single pyrolytic low-e, (U-value 57, SHGC 047)	
W10	×	0 75	0	0	eave/verandah/pergola/baicony >=450 mm	standard alumınıum, sıngle pyrolytıc low-e, (U-value 57, SHGC 047)	
2	S	10 29	0	0	none	standard alumınıum, sıngle clear, (or U-value 7 63, SHGC 0 75)	
D2	Z	5 04	0	0	eave/verandah/pergola/balcony >=450 mm	standard aluminium, single pyrolytic low-e, (U-value 57, SHGC 047)	
D3	Ø	0 6	0	0	none	standard aluminium, single clear, (or U-value 7 63, SHGC 0 75)	
Q	S	6 72	0	0	eave/verandah/pergola/balcony >=450 mm	standard aluminium, single clear, (or U-value 7 63, SHGC 0 75)	
D5	S	5 67	0	0	eave/verandah/pergola/balcony >=450 mm	standard aluminium, single clear, (or U-value 7 63, SHGC 0 75)	_

Department of Planning


Legend

In these commitments, "applicant" means the person carrying out the development

development application is to be lodged for the proposed development) Commitments identified with a "🎺" in the "Show on DA plans" column must be shown on the plans accompanying the development application for the proposed development (if a

certificate / complying development certificate for the proposed development Commitments identified with a "</" in the "Show on CC/CDC plans & specs" column must be shown in the plans and specifications accompanying the application for a construction

Commitments identified with a "🎺" in the "Certifier check" column must be certified by a certifying authority as having been fulfilled, before a final occupation certificate for the development may be issued

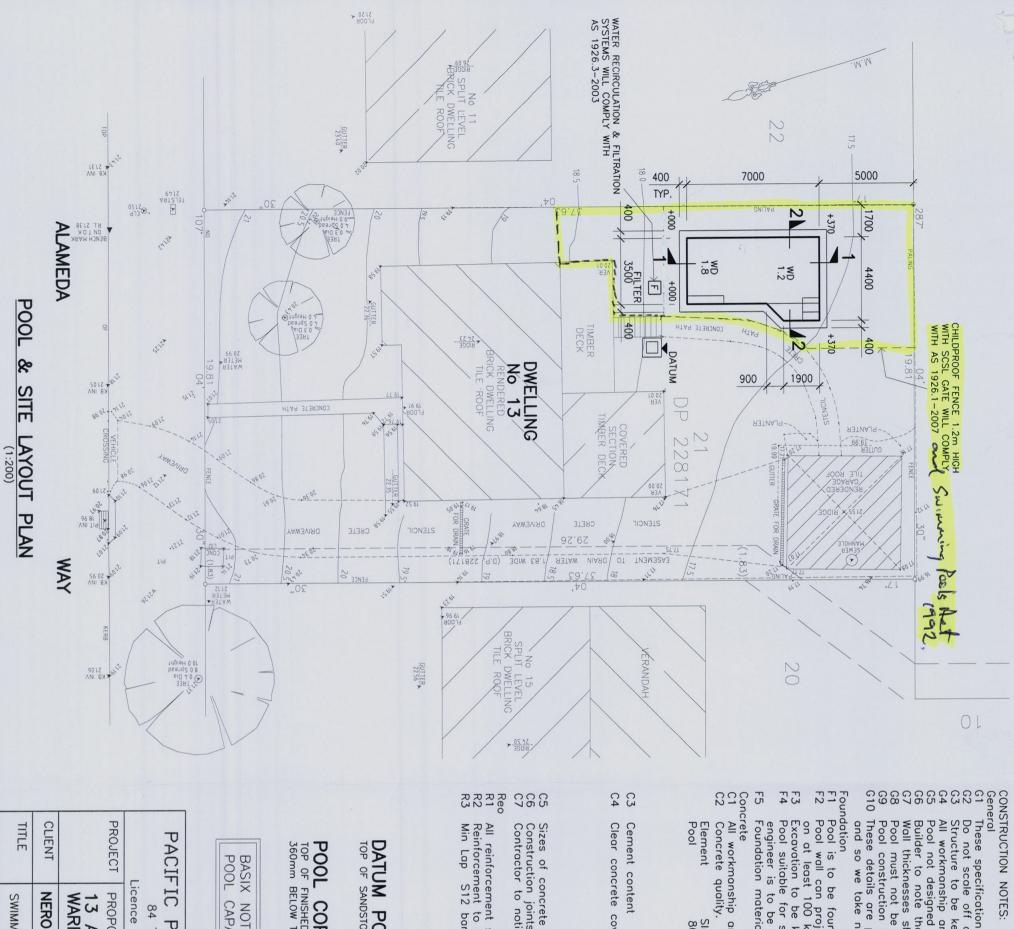

These specification are to be read in conjunction with the Architectural drawings.

Do not scale off any of the details use written dimensions only.

Structure to be kept in a stable condition and no part is to be overstressed.

All workmanship and materials to be in accordance with the relevant codes and ordinances.

Pool not designed for surcharge loading from other structures.

Builder to note that records must be kept as outlined in clause 6.4 of AS2783.

Wall thicknesses shown have no negative tolerances.

Pool must not be emptied until ground water pressures have been removed from pool base and wall.

Pool construction to conform with AS2783.

Inese details are primarily for structural details. and so we take no responsibility. All other ancillary information has been given by others

Pool is to be founded on approved natural groups on at least 100 kpa. If > 600mm protrusion excavation to be kept free of water. If surface ground with a bearing capacity of at least 100 kpa. I'm out of natural ground with that wall having bearing on engineer to be notified and revised details given. face deteriorates loose or soft material is to be removed.

Excavation to be kept free of war Pool suitable for site Classed A, AS2870 any other condition and

engineer is to be notified Foundation material to be sed A, S or M as per AS2870 any other condition and details modified.

approved by engineers prior to pouring of shell.

Element Pool Concrete quality. workmanship and materials to be in accordance with AS3600. Slump 80 Max. Agg. Size 10 Classification Exposure Coping width schedule

Cement content

Clear concrete cover to reo. to reo. Exposure Cover
Formed face of insitu concrete 40
Exposed face of pneumatically applied concrete 50
Concrete placed in contact with ground 60
Faces exposed in aggresive water 70

Internal Finish;

As Req'd.

Construction joints located to the approval of the Engineer. Contractor to notify Engineer 24hrs prior to any concrete between the contractor to notify Engineer 24hrs prior to any concrete between the contractors are constructed by the contractors are constructed by the contractors are contractors and contractors are contractors are contractors are contractors and contractors are contractors and contractors are contractors. Sizes of concrete do not include applied finishes Construction joints located to the approval of the

AS1304.

All reinforcement shall comply value Reinforcement to be supported Min Lap S12 bars — 450mm with approved chairs spaced 1000 max.

concrete being poured.

B2 B2 Solls AS3600 Fc (Mpa) 25 25 32 32 32

200 300 400 600 900 Reo 2S12 3S12 4S12 6S12 8S12 required

Relief value as per details
Design details comply with:
AS1170 Pt 1 SAA Loading Code
AS3600 SAA Concrete Structures Code
AS2783 SAA Concrete Pool Code
AS2780 SAA Pool Part 2 Private Spas Pool Data Maximum length_7.0 M Maximum depth 1.80 M

PACIFIC POOL COPING LEVEL TOP OF FINISHED COPING TO BE 360mm BELOW THE DATUM POINT DATUM POINT TOP OF SANDSTONE SU POOL CAPACITY 35.80KL Licence No 62686C SANDSTONE SURROUND OF FISH POND PROPOSED REINFORCED CONCRETE POOL 84 THIRD RD, BERKSHIRE PARK PUULS P/L (ACN 067 579 195) Ph 9897 5566 02461 2765 109 mas CIVIL & STRUCTURAL ENGINEERING CONSULTANTS P 0 BOX 22 1838 THE HORSLEY DR HORSLEY PARK 2175 HORSLEY PARK 2175 JOHN CAVASINNI & ASSOC. AMENDMENT:
A 03/9/2009 POOL SHAPE ALTERED Signature.. ACN 000 906 936 Mr John Cavasinni
MIEAust CPENG (Civil / Structurol) Registered Professional Engineer Registered on the NPER in the category of National Professional Engineers Register Civil / Structural Mobile: 0418 25 8645 Ph: 9620 1161 Fax: 9620 1180 229550 NPER P/L

POOL

TITLE

SWIMMING POOL DETAILS

Drawing

No.

2009PR1063A

8

Date: APRIL 2009

Scale: As noted

NERO


WARRIEWOOD

13 ALAMEDA

WAY

Drawn: Approved:

RM

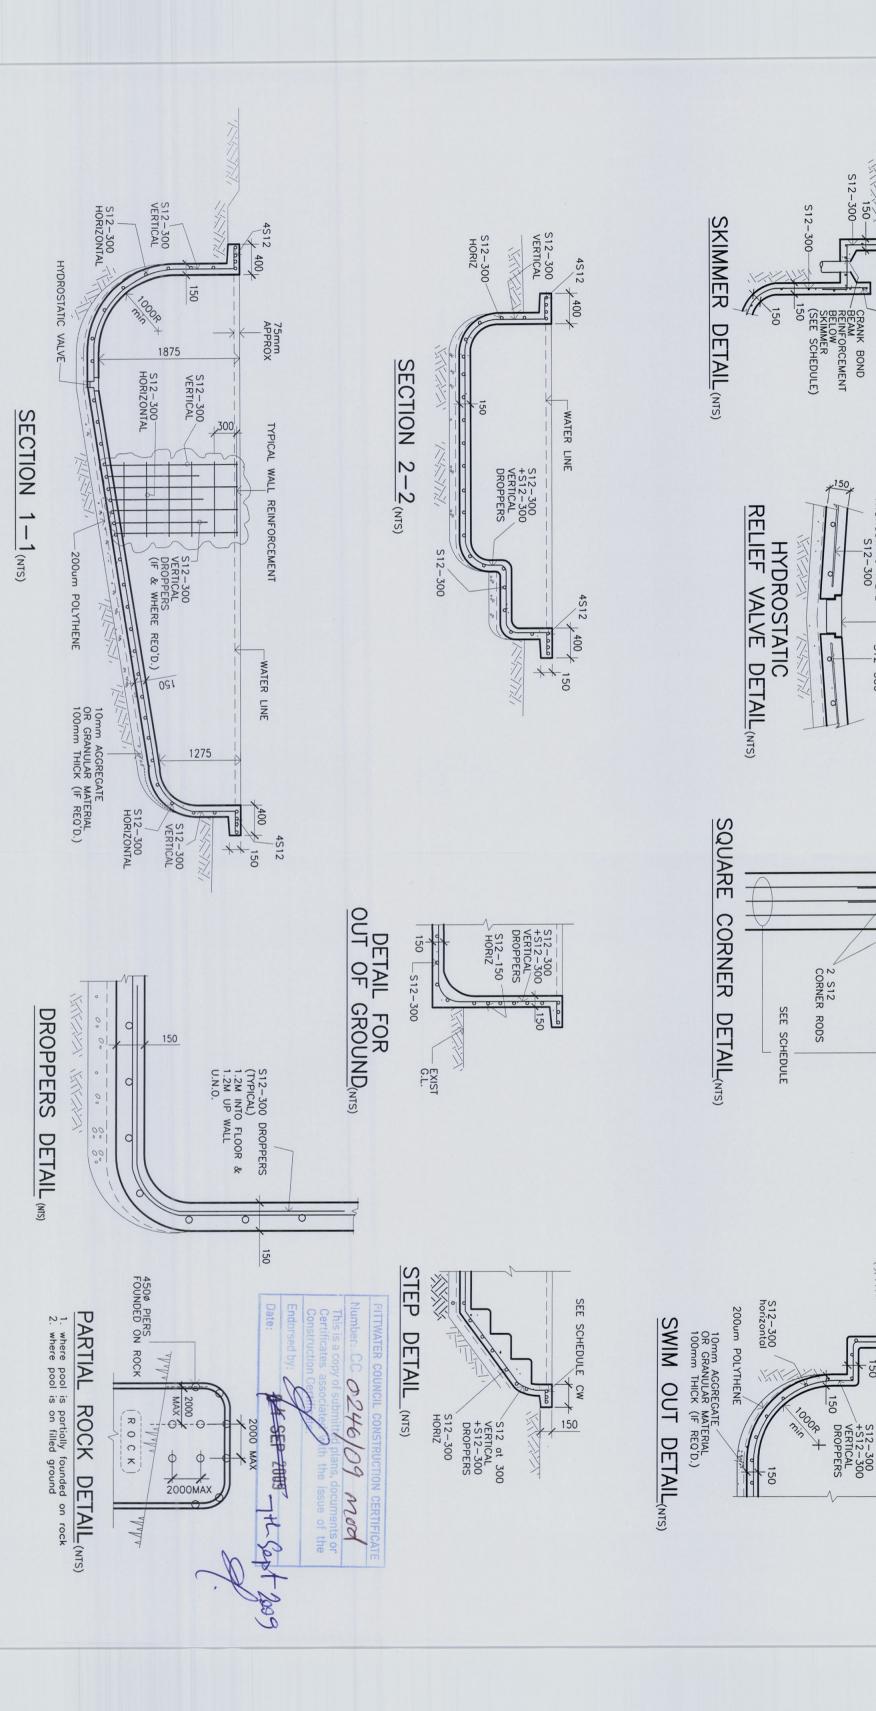

JOHN CAVASINNI & ASSOC TO BE USED IN CONJUCTION WITH COVER SHEET

DWG No:

2009PR1063A

2/2

S12-300-

2 S12 EXTRA HORIZ 2000 LONG BELOW SKIMMER

HYDROSTATIC VALVE \$12-300

S12-300

SEE SCHEDULE

+CW

WATER LINE

This DA Submission Form must be completed and attached to your submission.

	DA No: N0345/09
The General Manager Pittwater Council PO Box 882 MONA VALE NSW 1660	Name POBERT - EXAMS Address 145 PRINCE HERBOD DE NEWBOLT.
(Fax No: 9970 7150)	Phone 04/8 40/ 586. Date 07/09/09
Proposed Development additions to the dwelling	/ '
At. 136 PRINCE ALFRED PARADE NEWPORT N	SW 2106
I have inspected the DA plans, I have considered the relevant Locality Plans and Development Control Plans. I am willing to provide expert reports to supplement my control plans. I am willing to provide evidence to the Land and application is appealed.	comments should a conflict Environment Court if the Yes No Yes No
In the interests of public transparency please note available to the applicant or other interested persons Council's Internet site through Council's transparer You are encouraged, as is the applicant, to discuss concern	on request and will also be made available on nt Development Application tracking process.
COMMENTS: (You may use the space provided or at the space provided or a	Lister regal to super recipitation of view freed to free to the second to some the second to some the second to second the second t
Political Donations and Gifts Disclosure Statement (s Please read the information enclosed concerning polithe appropriate box below:	
I have made a political gift or donation (Please complete details of your political donations)	
I have NOT made a political gift or fun Name: XOBERI LEVASSINATURE	Date: 07/09/09
Note For more information see www planning risw gov aurolanning ref	forms/donations asp

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Fax sent by