WARRINGAH LEP & DCP 2011 Accessed 30 Nov 2023 at 13:41

LOT 15 SITE AREA: 593.(m ²	
PROPOSED BASEMENT FLOOR:	75.07m ²
PROPOSED GROUND FLOOR	172.10m ²
PROPOSED FIRST FLOOR:	142.24m ²
PROPOSED PORCH AREA:	5.06m ²
PROPOSED ALFRESCO AREA	41.68m ²
PROPOSED BALCONY AREA:	13.91m ²
PROPOSED GARAGE AREA:	104.85m ²

PROPOSED FLOOR AREA: REQUIRED MAX. FLOOR AREA: N/A PROPOSED TOTAL FLOOR AREA 389.41m²

LANDSCAPE REQUIRED MIN.40% LANDSCAPE AREA
PROPOSED TOTAL LANDSCAPE AREA 237.2m² 237 99m²

PRIVATE OPEN SPACE REQUIRED (MIN. DIMENSIONS 5m): 60 PROPOSED PRIVATE OPEN SPACE 86.4m

SETBACKS FRONT SETBACK 6.5m REAR SETBACK SIDE SETBACK 2.0m - 2.95m

8.5m

BUILDING HEIGHT PERMITTED MAX. BUILDING HEIGHT

PROPOSED MAX. BUILDING HEIGHT: 8.25m Certificate No. 0012112215

BASIX™Certificate

BASIX COMMITMENTS

FOR DETAILS: SEE THE BASIX CERTIFICATE NO. 1733445S

The applicant must install a rainwater tank of at least 4000 litres. The rainwater tank to collect rain runoff from at least 170 m2 of the roof. The applicant must connect the rainwater tank to:

all toilets in the development
the cold water tap that supplies each clothes washer · at least one outdoor tap in the development

Fixtures

Shower heads 3 star (>7.5 but <= 9.0 L/min) ·Toilets...... ·Kitchen tap. ...4 star ...5 star

·Basin Tans 5 star Hot Water System: gas instantaneous with a performance of 5.0 stars /or a

system with a higher energy rating/
Heating/Cooling: In at least 1 living area and 1 bedroom: 3-phase Airconditioning; Energy rating: EER 2.5 - 3.0 (Zoned)

Ventilation ·At least 1 Bathroom: individual fan, ducted to façade or roof; Operation control:

interlocked to light with timer off
Kitchen: individual fan, ducted to façade or roof; Operation control: manual switch on/off

·Laundry: natural ventilation only, or no laundry; Operation control: n/a Natural lighting ·The applicant must install a window and/or skylight in the kitchen of the dwelling

for natural lighting. The applicant must install a window and/or skylight in 4 bathroom(s)/toilet(s) in the development for natural lighting.

Artificial lighting:

• The applicant must ensure that a minimum of 80% of light fixtures are fitted with fluorescent, compact fluorescent, or light-emitting-diode (LED) lamps. OTHER

The applicant must install a gas cooktop & electric oven in the kitchen of the

The applicant must install a fixed outdoor clothes drying line as part of the development.

The swimming pool must not have a volume greater than 56 kilolitres. •The swimming pool must be outdoors.
•The development must not incorporate any heating system for the swimming

The applicant must install the following pump for the swimming pool in the development, or a pump with higher energy rating: single speed with a performance of 3 stars.

The applicant must install a timer for the swimming pool pump in the development.

The applicant must install a photovoltaic system as part of the development. The applicant must connect this system to the development's electrical system.

The photovoltaic system must consist of photovoltaic collectors with the capacity to generate at least 2 peak kilowatts of electricity, installed at an angle of 0 degrees to the horizontal facing north.

The Basix certificate should be read in conjunction with the Nathers certificate (including the additional notes pages 4 & 5).

FOR DETAILS: SEE THE NatHERS CERTIFICATE NO.

Thermal Comfort-Simulation method

A detailed method of assessment with greater flexibility of solution choice and capacity to assess complex dwelling designs.
The dwelling design has been assessed with NatHERS software

External Walls

·Cavity Brick, Foil Sided Bubble Wrap, Anti-glare One Side

Garage)
Single Skin Brick, No Insulation (All Others)

Unventilated roofspace

Note: All coffer ceiling verticals and walls against the roof-space, t be insulated, with the same insulation as the ceiling insulation

(sealed) rated as per BS EN 60529:1992, European IEC

BUILDING ELEMENTS

Tilt up Concrete, No Insulation
Tilt Up Concrete, Lined Timber Stud Frame, R2.5 Bulk Insulation

·Single Skin Brick, R2.5 Bulk Insulation, No Air Gap (Against

External Floor Concrete Slab on Ground

Suspended Floor (Open to Air)- R2.5
Internal Floor/Ceiling
Concrete Timber Framed Above Plasterboard, R2.0 Bulk

Insulation (Above Garage)
Concrete Timber Framed Above Plasterboard, No Insulation (All

External Ceiling


·Concrete, Plasterboard with Timber Frame R5.0 Bulk Insulation Roof

Waterproofing Membrane, No Insulation, Only an Air Gap

Note: All downlights: IC-F /IC-4/ (insulation covered/ including the control gears/) rated as per AS/NZS standard 60598 and IP

Note: (where the roof is extended over an open area such as a deck or carport): A barrier to be installed within the roof space to separate the space above the zoned part of the house and the space above the open veranda. Note-Ceiling fans: For the number and the location, see the

For additional information please refer to the additional notes on the Nathers certificate.

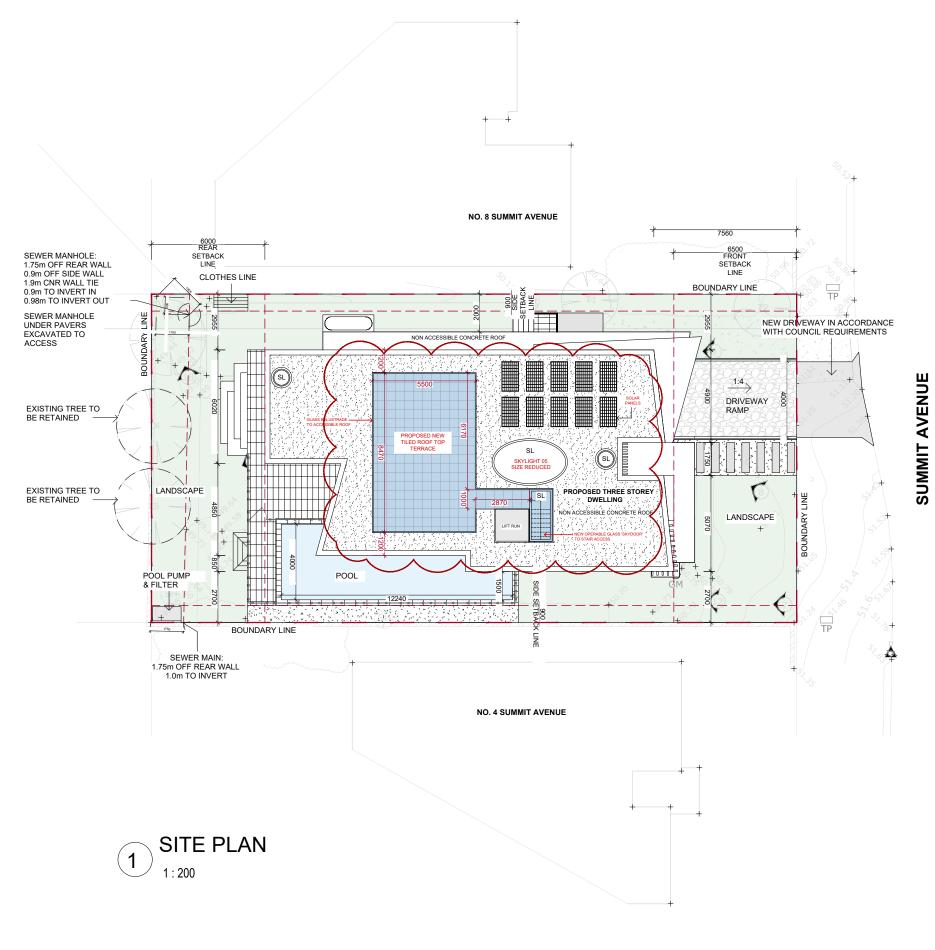

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REVISIONS ISSUED FOR MODIFICATION

DESIGNED BY: RESOLUTE

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CLIENT: MICHAEL HRONOPOULOS & VANESSA ROWED



PROPOSED NEW DWELLING 12 HOLLYWOOD STREET,


MONTEREY, 2217


SITE PLAN


SCALE:1:100 @ A3 PLOT DATE: 29.07.2025 DRAWN BY: MAGGIE HASSOUN


Dee Why- MD01


MD-100 A

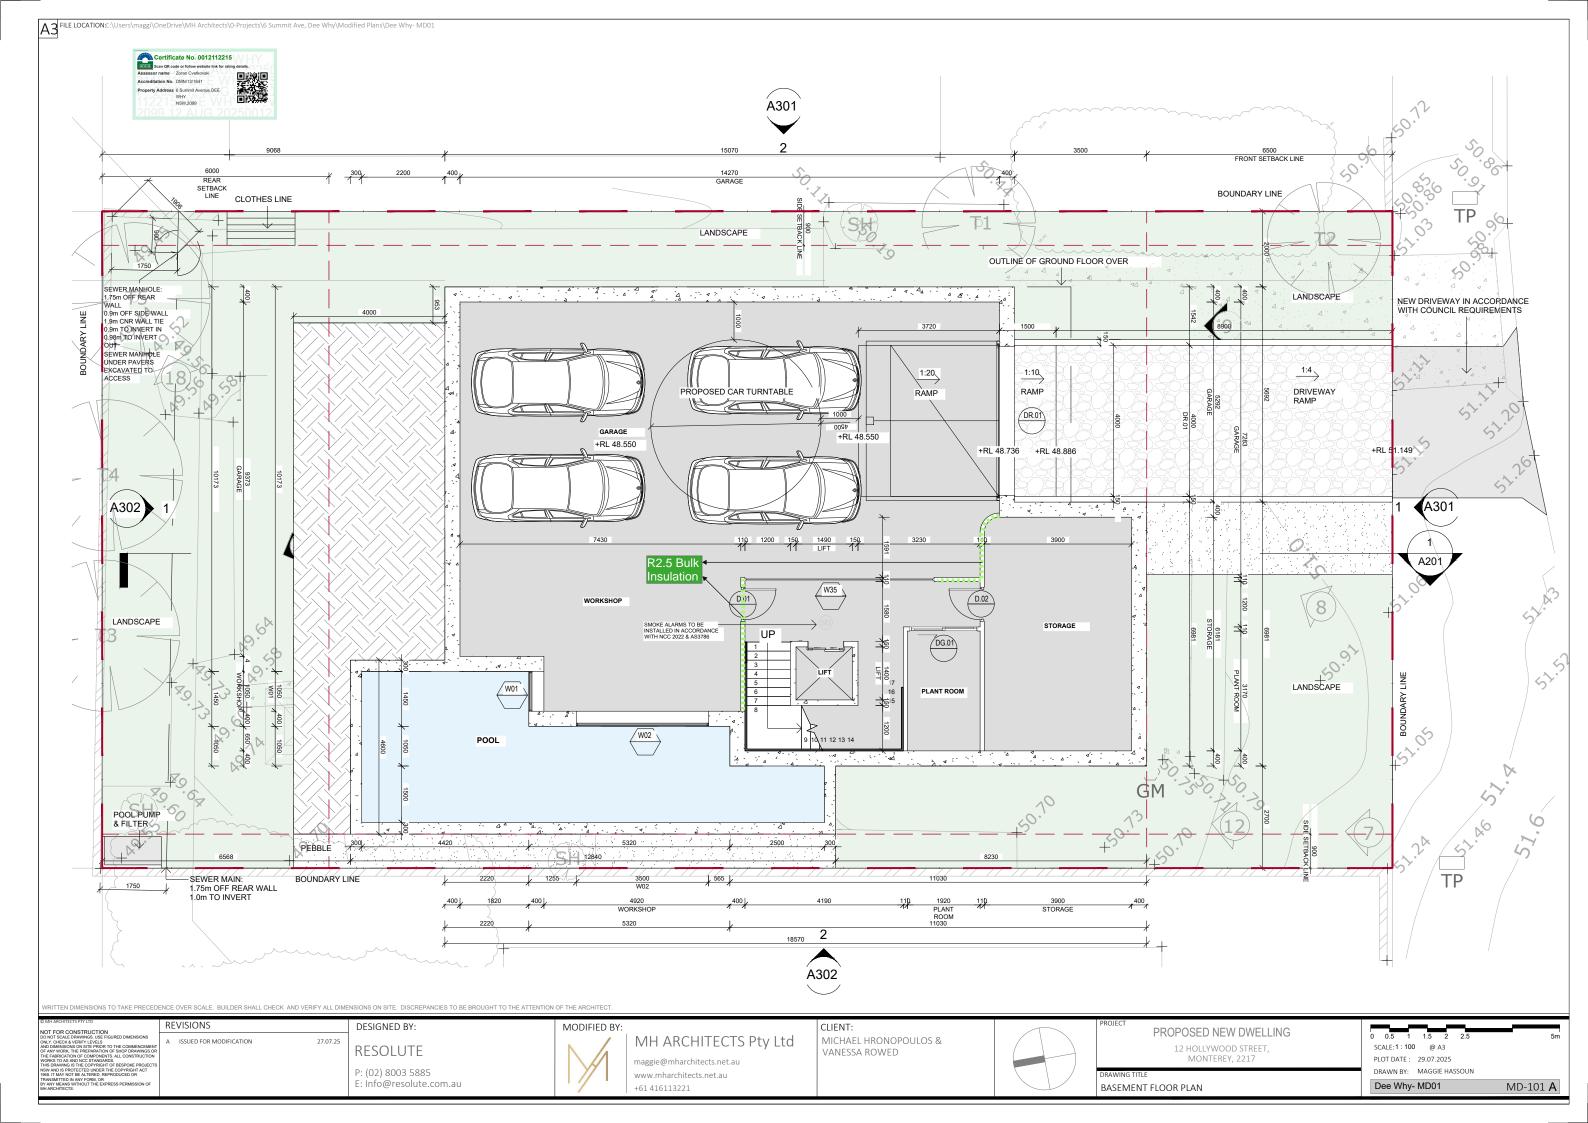

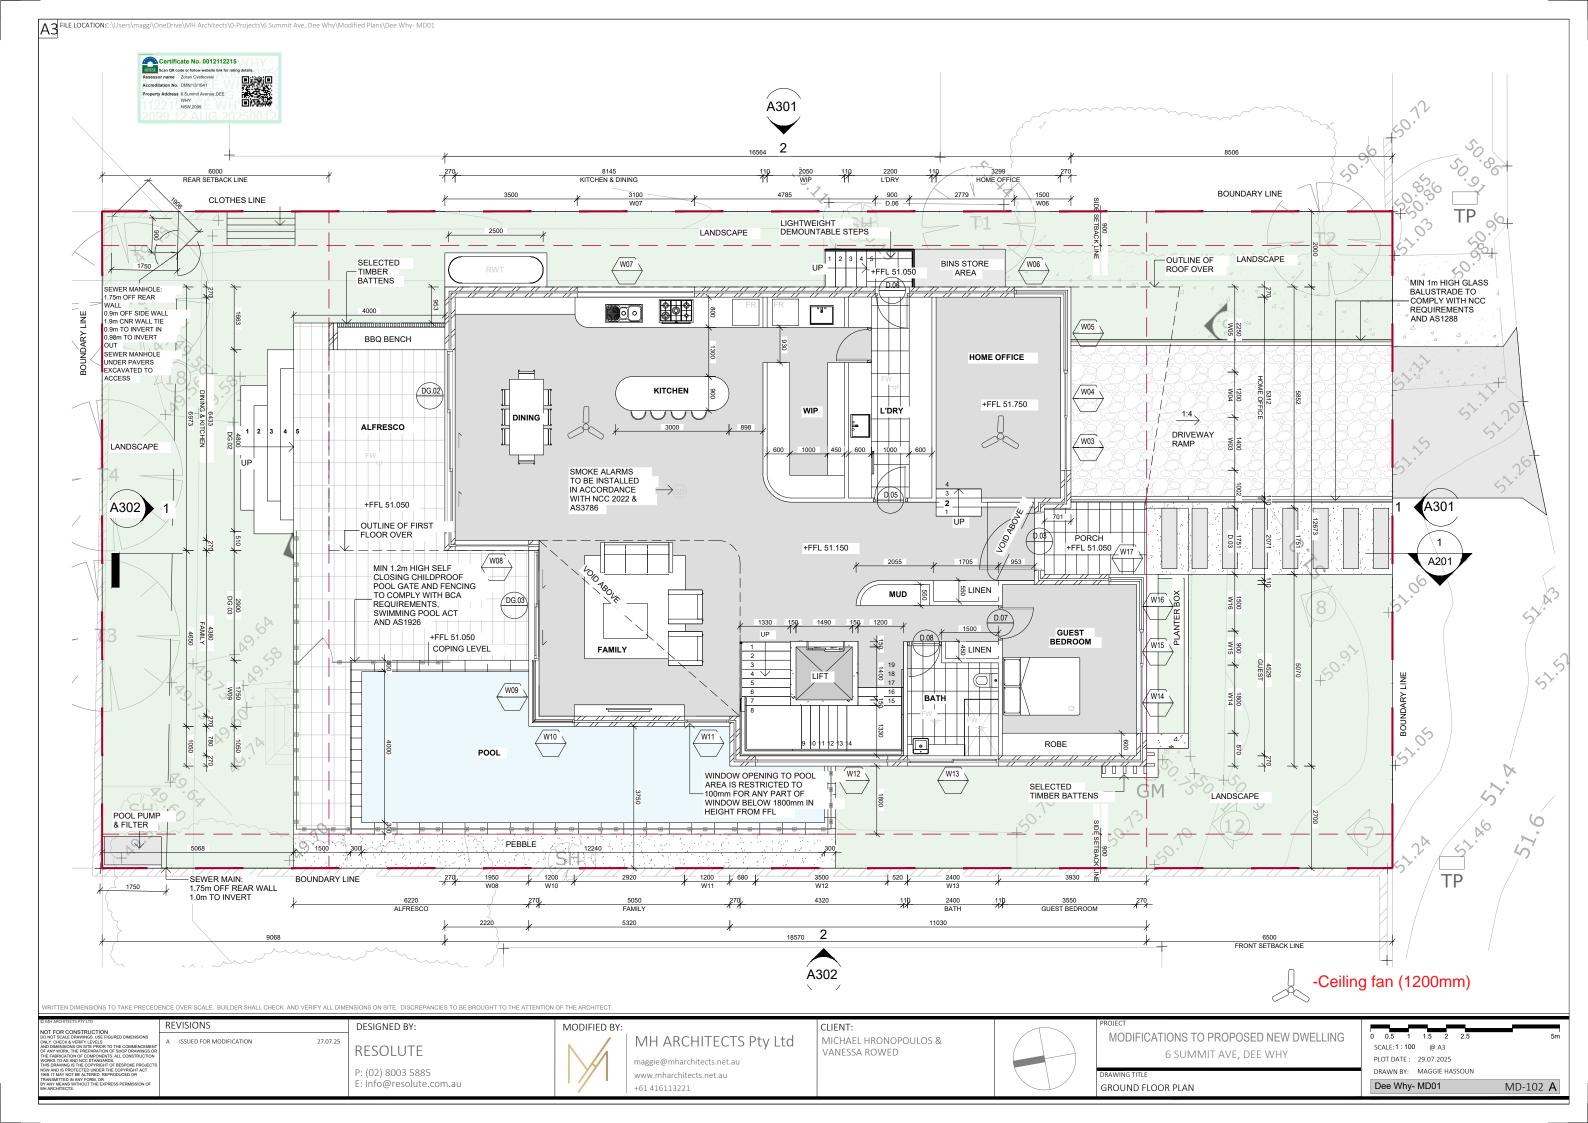

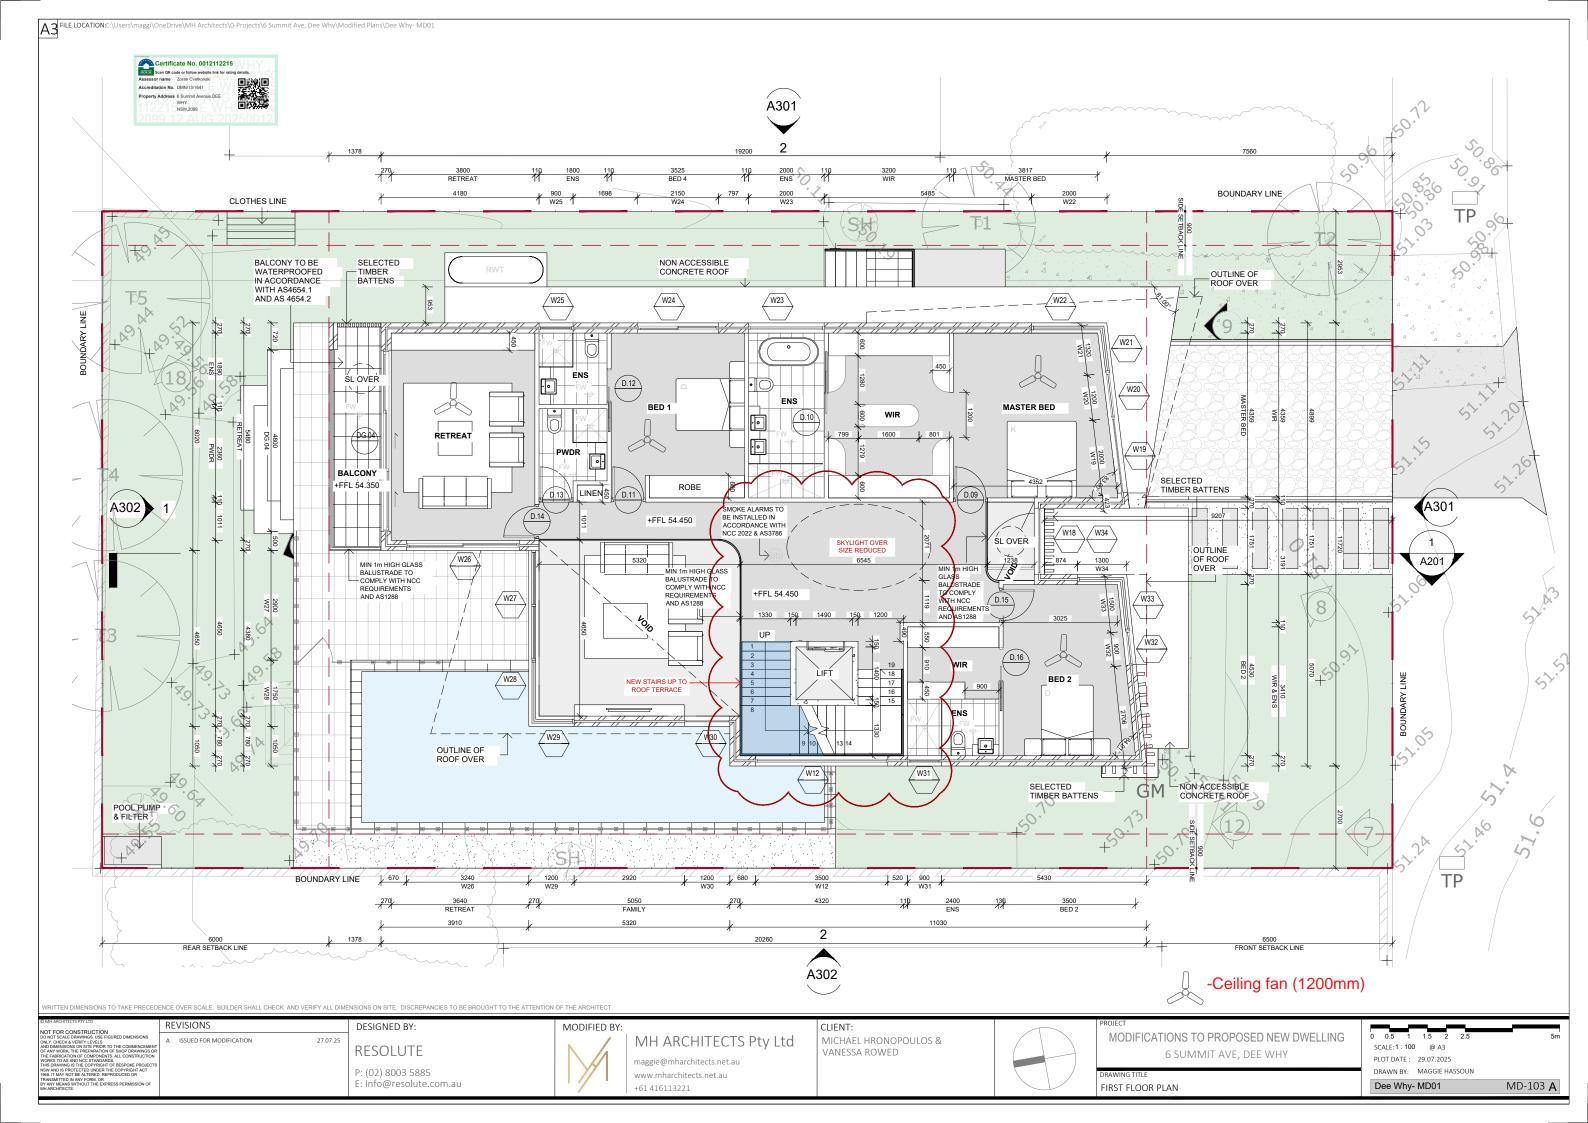

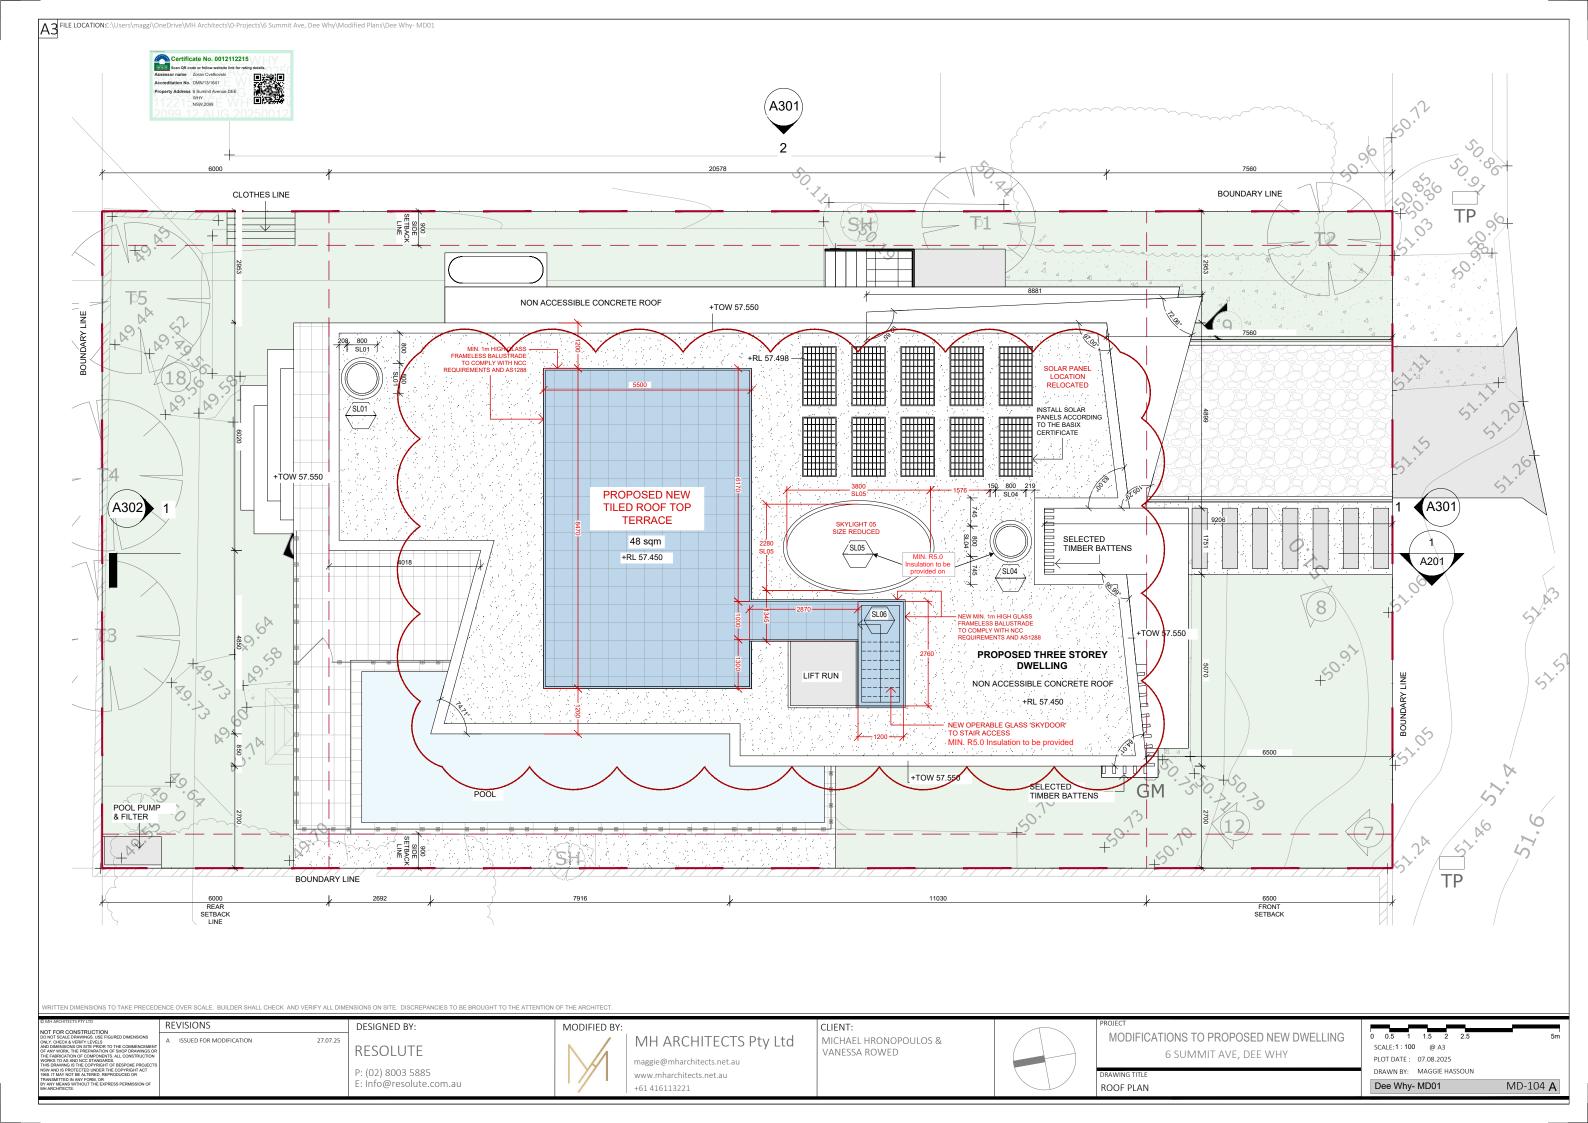

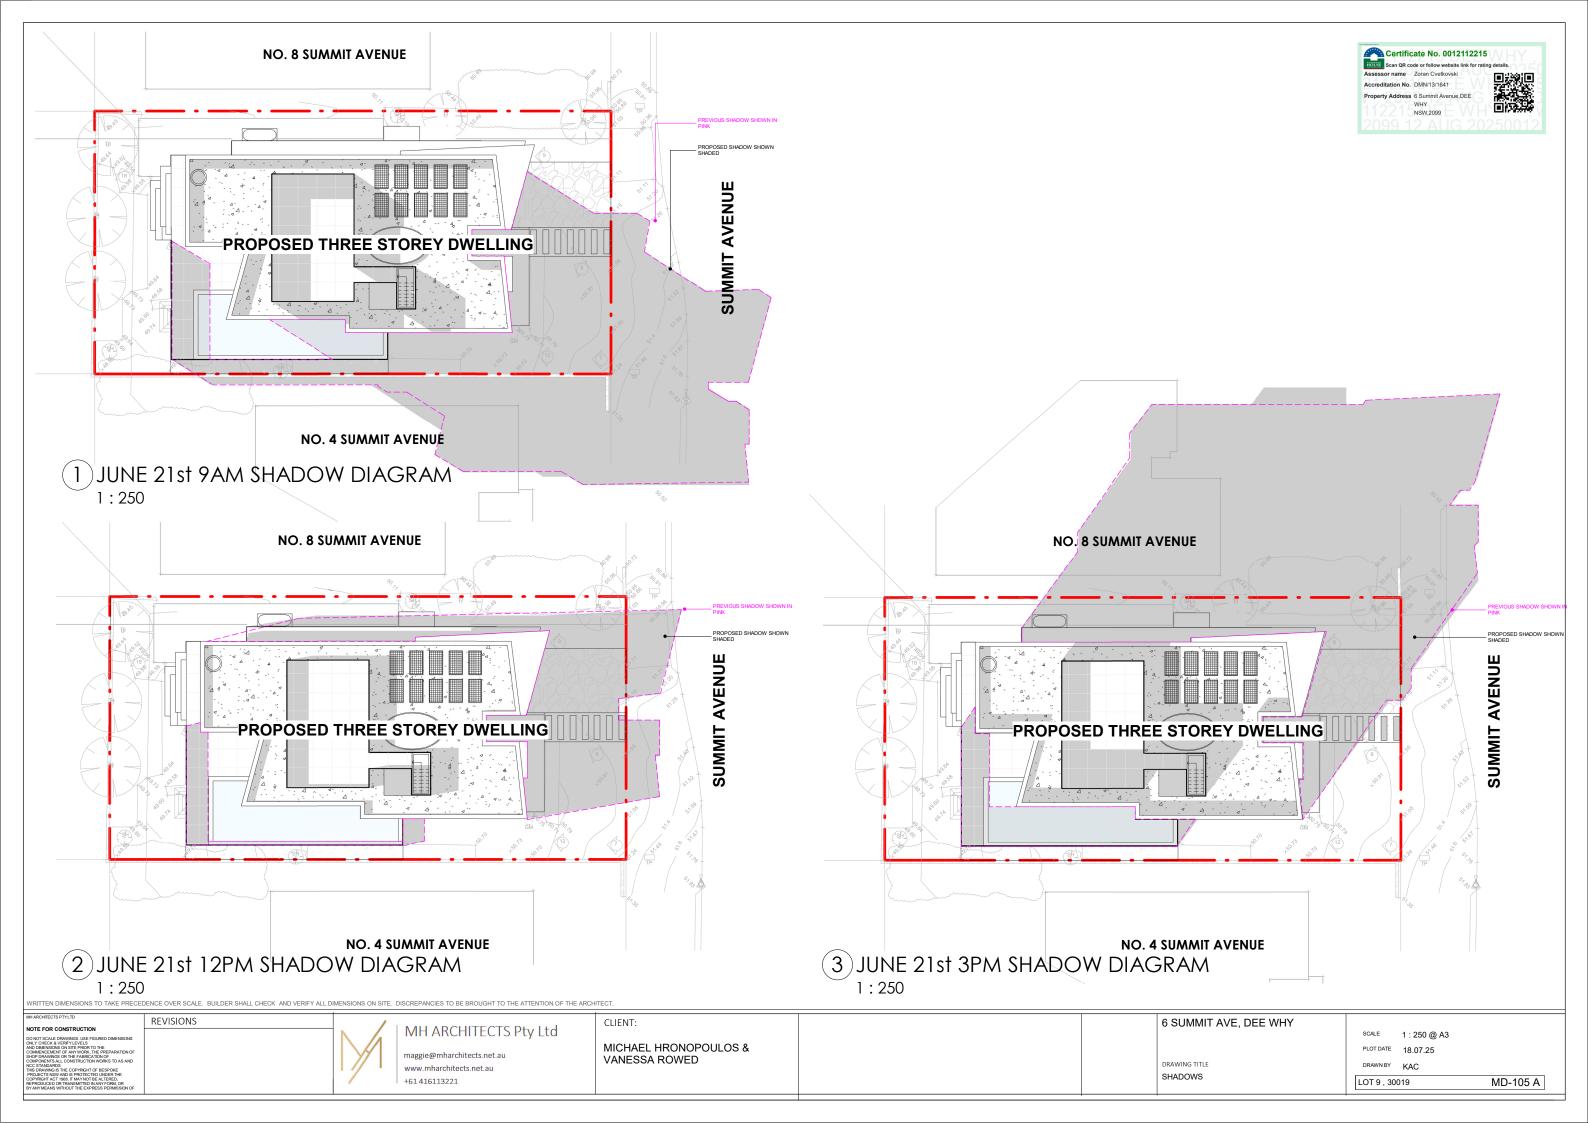


Certificate No. 0012112215 Accreditation No. DMN/13/1641

NSW,2099

BASIX™Certificate

Single Dwelling



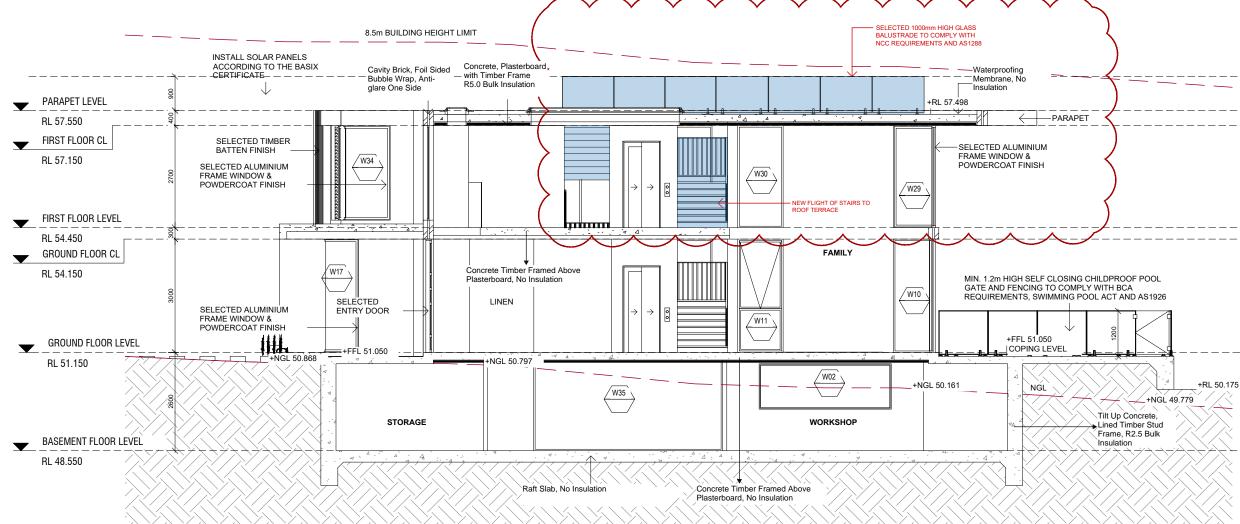

Basix-Commitments /for details: See the **Basix certificate/**

Alternative water

The applicant must install a rainwater tank of at least 4000 litres.

The rainwater tank to collect rain runoff from at least 170 m2 of the roof.

The applicant must connect the rainwater tank

all toilets in the development

the cold water tap that supplies each clothes

• at least one outdoor tap in the development

Fixtures

Shower heads 3 star (>7.5 but <= 9.0 L/min) Kitchen tap... ...5 star Basin Taps..

Hot Water System: gas instantaneous with a performance of 5.0 stars /or a system with a higher energy rating/

Heating/Cooling: In at least 1 living area and 1 bedroom: 3-phase Air-conditioning; Energy rating: EER 2.5 - 3.0 (Zoned)

_Ventilation

At least 1 Bathroom: individual fan, ducted to façade or roof; Operation control: interlocked to light with timer off

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The swimming pool must be

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The Basix certificate should be read in conjunction with the Nathers certificate (including the additional notes pages 4 & 5).

REVISIONS

ISSUED FOR MODIFICATION

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DESIGNED BY:



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CLIENT: MICHAEL HRONOPOULOS & VANESSA ROWED

MODIFICATIONS TO PROPOSED NEW DWELLING 6 SUMMIT AVE, DEE WHY BUILDING SECTION

SCALE:1:100 @ A3 PLOT DATE: 29.07.2025 Dee Why- MD01

DRAWN BY: MAGGIE HASSOUN

MD-201 A

