GRATTAN HOUSE

SECTION NAME	DRAWING No.	DESCRIPTION
01 DEVELOPMEN	IT APPLICATION	
	A01	COVER PAGE
	A02	SCHEDULES
	A03	SURVEY
	A04	SITE PLAN/WASTE MANAGEMENT PLAN
	A05	SITE ANALYSIS AND LOCATION MAP
	A06	EXISTING PLANS AND ELEVATIONS 1
	A07	EXISTING PLANS AND ELEVATIONS 2
	A08	PERSPECTIVES
	A09	GROUND FLOOR
	A10	LEVEL 1 PLAN
	A11	ROOF PLAN
	A12	ELEVATION STREET, E1 AND E2
	A13	ELEVATION E3 AND E4
	A14	SECTION A AND C
	A15	SECTION B AND D
	A16	BASIX 1
	A17	BASIX 2
	A18	SHADOWS JUNE 21-9AM
	A19	SHADOWS JUNE 21-12NOON
	A20	SHADOWS JUNE 21-3PM
	A21	LANDCAPE CALCULATION
	A22	FINISHES SCHEDULE

GENERAL CONSTRUCTION NOTES

ROOFS:

ROOF STRUCTURE: TIMBER FRAMED
ALL ROOFS TO BE SARKED AS SPECIFIED.
ALL ROOFS CONNECTED TO STORMWATER SYSTEM.
NEW GUTTERS AND DOWNPIPES IN LOCATIONS AS
SPECIFIED.

STORMWATER:

REFER TO STORMWATER DRAWINGS FOR DETAILS.

STRUCTURAL:

REFER TO STRUCTURAL DRAWINGS FOR DETAILS.

INSULATION:

REFER TO SPECIFICATION FOR FLOOR, WALL, ROOF ACOUSTIC AND THERMAL INSULATION.

BASIX:

REFER TO BASIX FOR SUSTAINABILITY REQUIREMENTS.



DEVELOPMENT APPLICATION A

FLOOR SCHEDULE				
CODE ID	DESCRIPTION			
F-C1	NEW floor structure with NEW carpet.			
F-CON1	NEW concrete structure. As per engineer's detail.			
F-EC	EXISTING floor structure with EXISTING carpet.			
F-EC1	EXISTING floor structure with NEW carpet.			
F-ECON	EXISTING concrete slab, Keep and protect.			
F-ED	EXISTING deck, Keep and protect.			
F-EPAV	EXISTING paving, Keep and protect.			
F-ET	EXISTING floor structure with EXISTING floorboards. Keep and Protect.			
F-ET1	EXISTING floor structure with NEW floorboards to match existing.			
F-ETL	EXISTING floor structure with EXISTING tiles. Keep and Protect.			
F-ETL1	EXISTING floor structure with NEW tiles.			
F-PAV1	NEW paving to match existing.			

ROOF SCHEDULE				
CODE ID	DESCRIPTION			
DP	NEW downpipe, as specified.			
e-DP	EXISTING downpipe. Make good as required.			
R-EM	EXISTING timber framed roof structure with EXISTING metal roofing.			
R-M1	NEW framed roof structure with NEW corrugated (e.g custom orb) metal sheet, as specified. As per engineer's detail.			
R-M2	NEW framed roof structure with NEW flat pan (e.g kliplock) metal roof sheeting, as specified. As per engineer's detail.			

WALL SCHEDULE				
CODE ID	DESCRIPTION			
P-ES	EXISTING steel post structure.			
P-ET	EXISTING timber post structure.			
P-S1	NEW steel post structure. Painted, as specified. As per engineer's detail.			
W-ELW	EXISTING timber framed wall structure with EXISTING lightweight cladding. Infill cladding to match existing. Make good as required.			
W-LW1	NEW framed wall structure with NEW weatherboard cladding to match existing with NEW paint, as specified.			
W-LW2	NEW framed wall structure with NEW FC (AXON SCYON OR EQUIVALENT) cladding with NEW paint, as specified.			
W-ST1	NEW masonary wall with NEW stone cladding and capping, as specified.			

WINDOW, DOOR & SKYLIGHT SCHEDULE				
CODE ID	DESCRIPTION			
DE	EXISTING door to remain. Make good as required.			
DN	NEW internal timber door, painted as specified.			
W01	(W01, W02etc) NEW aluminium framed window.			
VVOI	Painted as specified. Refer to BASIX requirements.			
WE	EXISTING window to remain. Make good as required.			

ID	DESCRIPTION	DATE
Α	DEVELOPMENT APPLICATION	23/08/2024

CONFIDENTIAL
DOCUMENTS ARE NOT TO BE DISTRIBUTED OR
SHARED WITH OTHER PARTIES WITHOUT THE PRIOR
CONSENT OF THE ARCHITECT.



Architect - Catherine Seeto - Reg. 8345

14 Cook Street, Forestville 2087 NSW
T: 0421 846 288
E: studio@dfarch.com.au

www.dragonflyarchitects.com.au

E: studio@cdfarch.com.au
www.dragonflyarchitects.com.au

SCALE: NTS @ A3
DATE PRINTED: 23/08/2024
DRAWN BY: ES, CS
CLIENT: REBECCA GRATTAN

The Architect retains copyright. Authority should be requested for any reproductions

120 CROWN ROAD QUEENSCLIFF NSW 2096

SCHEDULES


TITLE INDICATES THAT LOT B IN D.P.925573 IS SUBJECT TO: RESERVATIONS AND CONDITIONS IN THE CROWN GRANT(S).

SURVEYED DRAWN CHECKED
MB CJR MB APPROVED RM SCALE SURVEY INSTRUCTION


23247 / 1:100@A1 DRAWING NAME 23247detail

CAD FILE 23247detail 1.dwg

5/03/2024 SHEET 1 OF 1

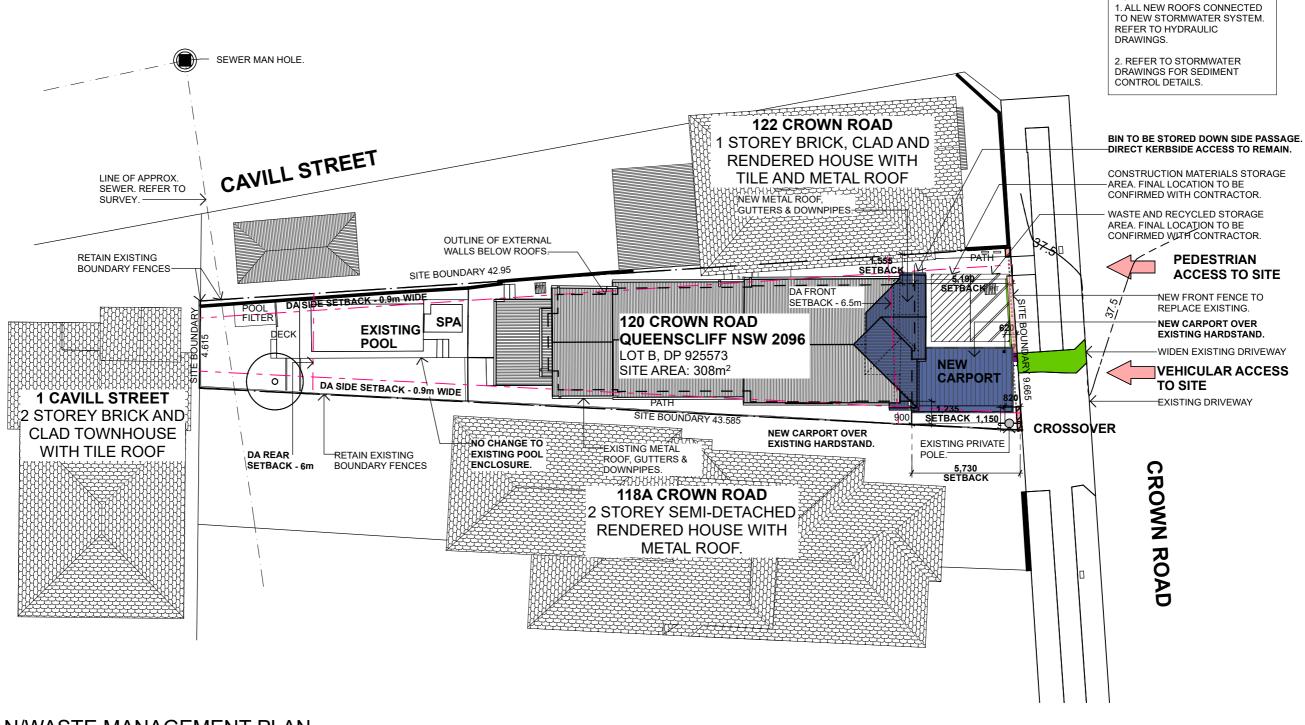


SITE PLAN/WASTE MANAGEMENT PLAN Scale 1:200

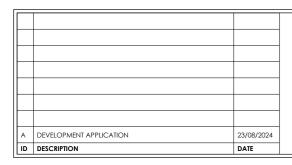

DEVELOPMENT APPLICATION

CONFIDENTIAL DOCUMENTS ARE NOT TO BE DISTRIBUTED OR SHARED WITH OTHER PARTIES WITHOUT THE PRIOR CONSENT OF THE ARCHITECT.

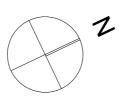



Architect - Catherine Seeto - Reg. 8345

14 Cook Street, Forestville 2087 NSW T: 0421 846 288 E: studio@dfarch.com.au


www.dragonflyarchitects.co


SCALE: DATE PRINTED CLIENT:

1:200 **@ A3** 23/08/2024 REBECCA GRATTAN

120 CROWN ROAD **QUEENSCLIFF NSW 2096**

SITE PLAN/WASTE **MANAGEMENT PLAN**

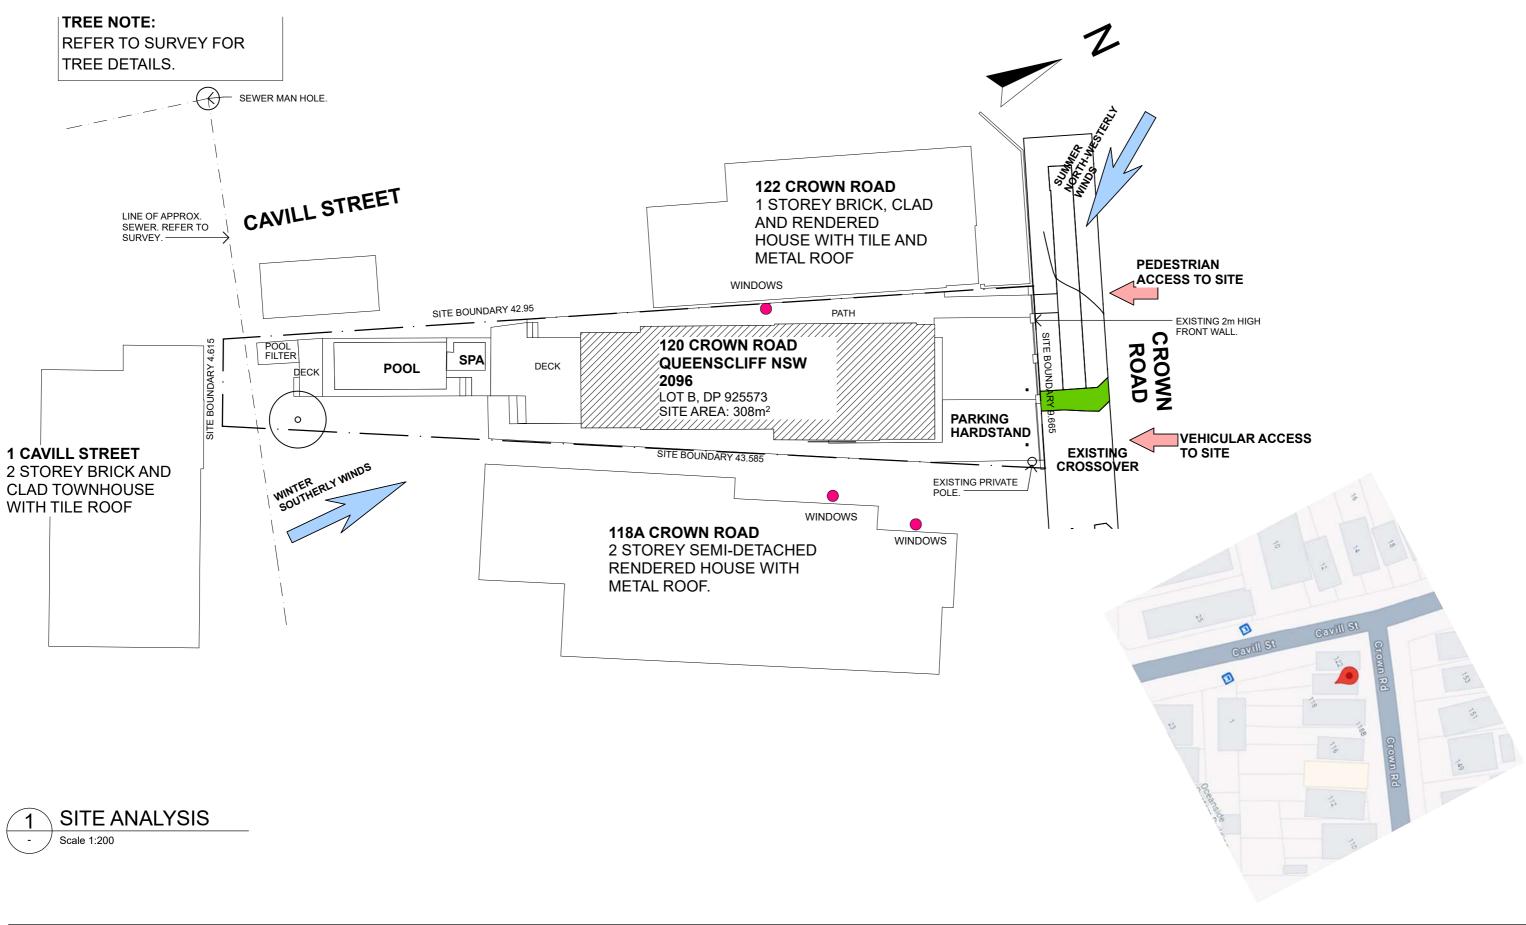

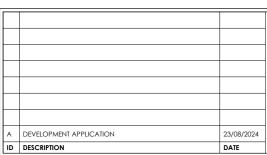

CONFIDENTIAL DOCUMENTS ARE NOT TO BE DISTRIBUTED OR SHARED WITH OTHER PARTIES WITHOUT THE PRIOR CONSENT OF THE ARCHITECT.





Architect - Catherine Seeto - Reg. 8345

14 Cook Street, Forestville 2087 NSW


T: 0421 846 288 E: studio@dfarch.com.au www.dragonflyarchitects.co

SCALE : DATE PRINTED : CLIENT:


1:200 @ A3 23/08/2024 ES, CS REBECCA GRATTAN

120 CROWN ROAD **QUEENSCLIFF NSW 2096**


SITE ANALYSIS AND LOCATION MAP

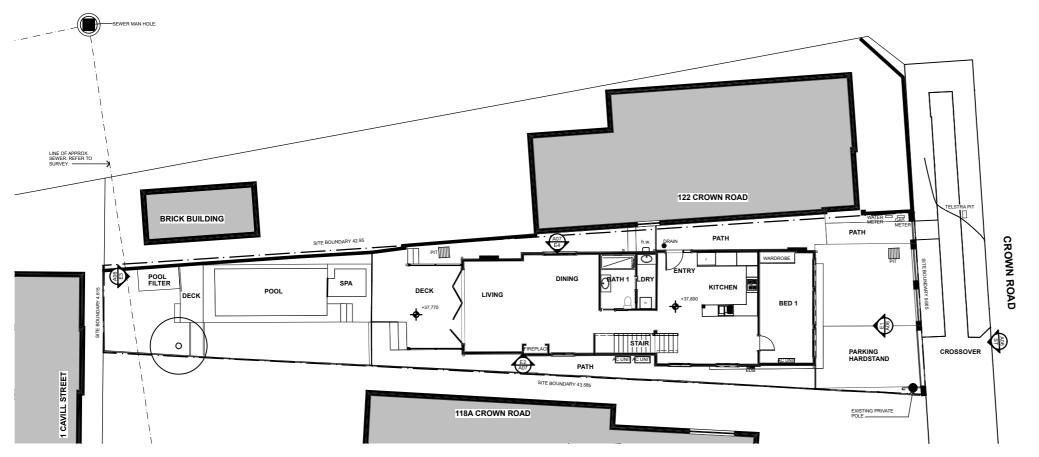

1 GROUND FLOOR

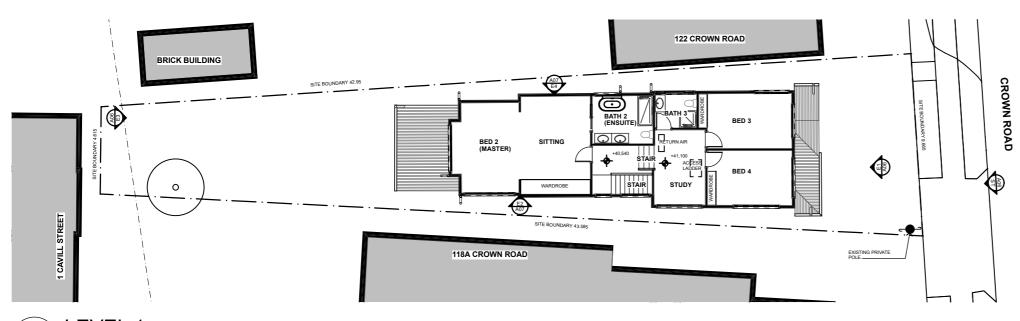


2 LEVEL 1
- Scale 1:200

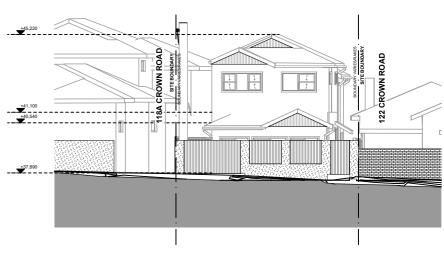


3 EXISTING ELEVATION ST (STREET)

Scale 1:200

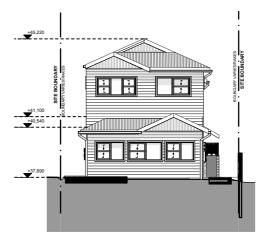

4 EXISTING ELEVATION E1 (NORTH)

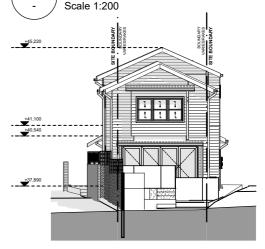

5 EXISTING ELEVATION E3 (SOUTH)

Scale 1:200

A DEVELOPMENT APPLICATION 23/08/2024

ID DESCRIPTION DATE

DEVELOPMENT APPLICATION

CONFIDENTIAL
DOCUMENTS ARE NOT TO BE DISTRIBUTED OR
SHARED WITH OTHER PARTIES WITHOUT THE PRIOR
CONSENT OF THE ARCHITECT.





Architect - Catherine Seeto - Reg. 8345 14 Cook Street, Forestville 2087 NSW

T: 0421 846 288
E: studio@dfarch.com.au


www.dragonflyarchitects.com.au

SCALE: DATE PRINTED: DRAWN BY: CLIENT: 1:200 @ A3
23/08/2024
ES, CS
REBECCA GRATTAN


right. Authority

120 CROWN ROAD QUEENSCLIFF NSW 2096


EXISTING PLANS AND ELEVATIONS 1

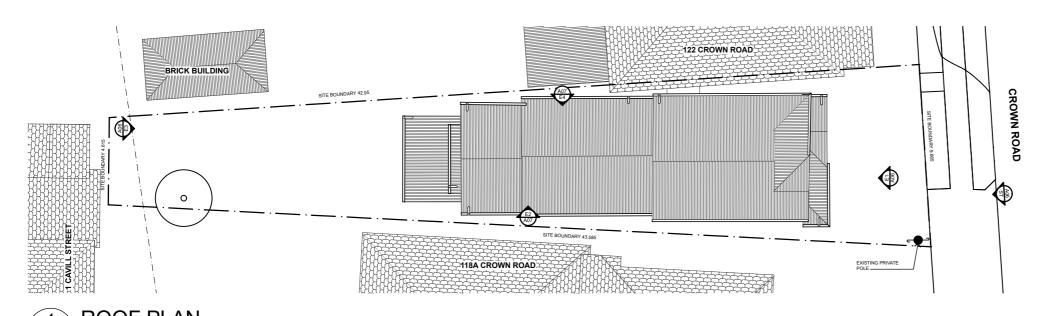



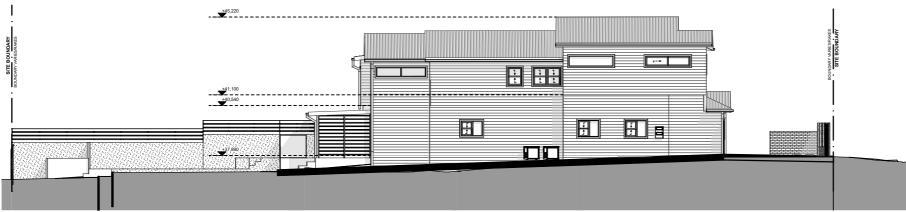

EXISTING ELEVATION E2 (EAST)

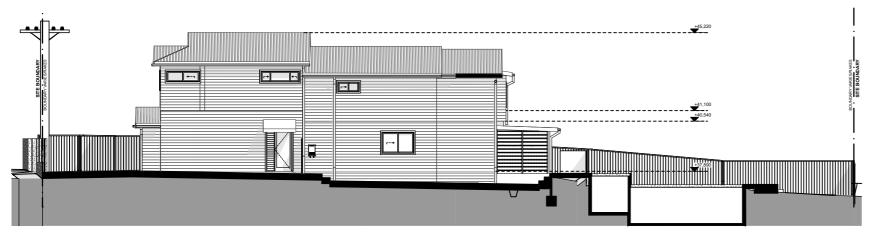


EXISTING ELEVATION E4 (WEST)

A DEVELOPMENT APPLICATION 23/08/2024 ID DESCRIPTION DATE

DEVELOPMENT APPLICATION

CONFIDENTIAL DOCUMENTS ARE NOT TO BE DISTRIBUTED OR SHARED WITH OTHER PARTIES WITHOUT THE PRIOR CONSENT OF THE ARCHITECT.

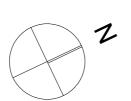



Architect - Catherine Seeto - Reg. 8345

14 Cook Street, Forestville 2087 NSW T: 0421 846 288 E: studio@dfarch.com.au

www.dragonflyarchitects.com SCALE : DATE PRINTED :

CLIENT:

1:200 @ A3 23/08/2024 ES, CS REBECCA GRATTAN

120 CROWN ROAD **QUEENSCLIFF NSW 2096**

EXISTING PLANS AND ELEVATIONS 2





FRONT VIEW 1

FRONT VIEW 2

_		
А	DEVELOPMENT APPLICATION	23/08/2024
ID	DESCRIPTION	DATE

DEVELOPMENT APPLICATION

CONFIDENTIAL DOCUMENTS ARE NOT TO BE DISTRIBUTED OR SHARED WITH OTHER PARTIES WITHOUT THE PRIOR CONSENT OF THE ARCHITECT.



Architect - Catherine Seeto - Reg. 8345


14 Cook Street, Forestville 2087 NSW T: 0421 846 288 E: studio@dfarch.com.au


www.dragonflyarchitects.com.a


SCALE : DATE PRINTED : NTS @ A3
23/08/2024
ES, CS
REBECCA GRATTAN CLIENT:


120 CROWN ROAD **QUEENSCLIFF NSW 2096**

PERSPECTIVES

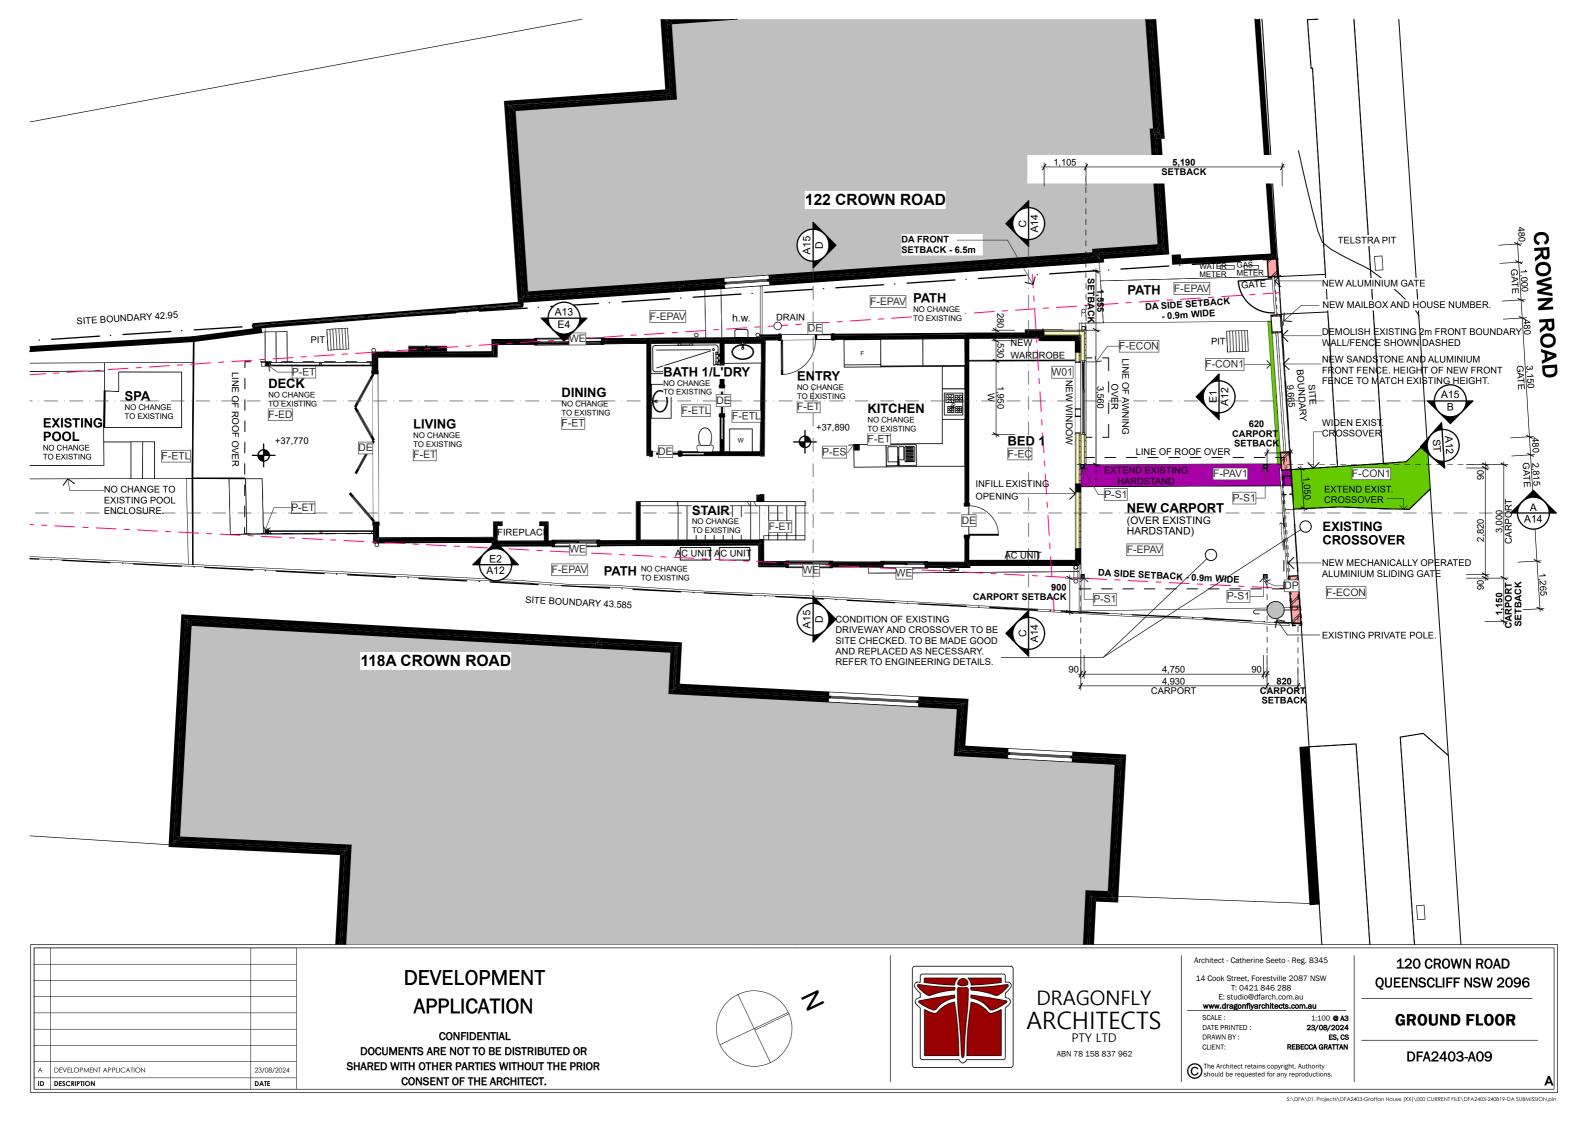


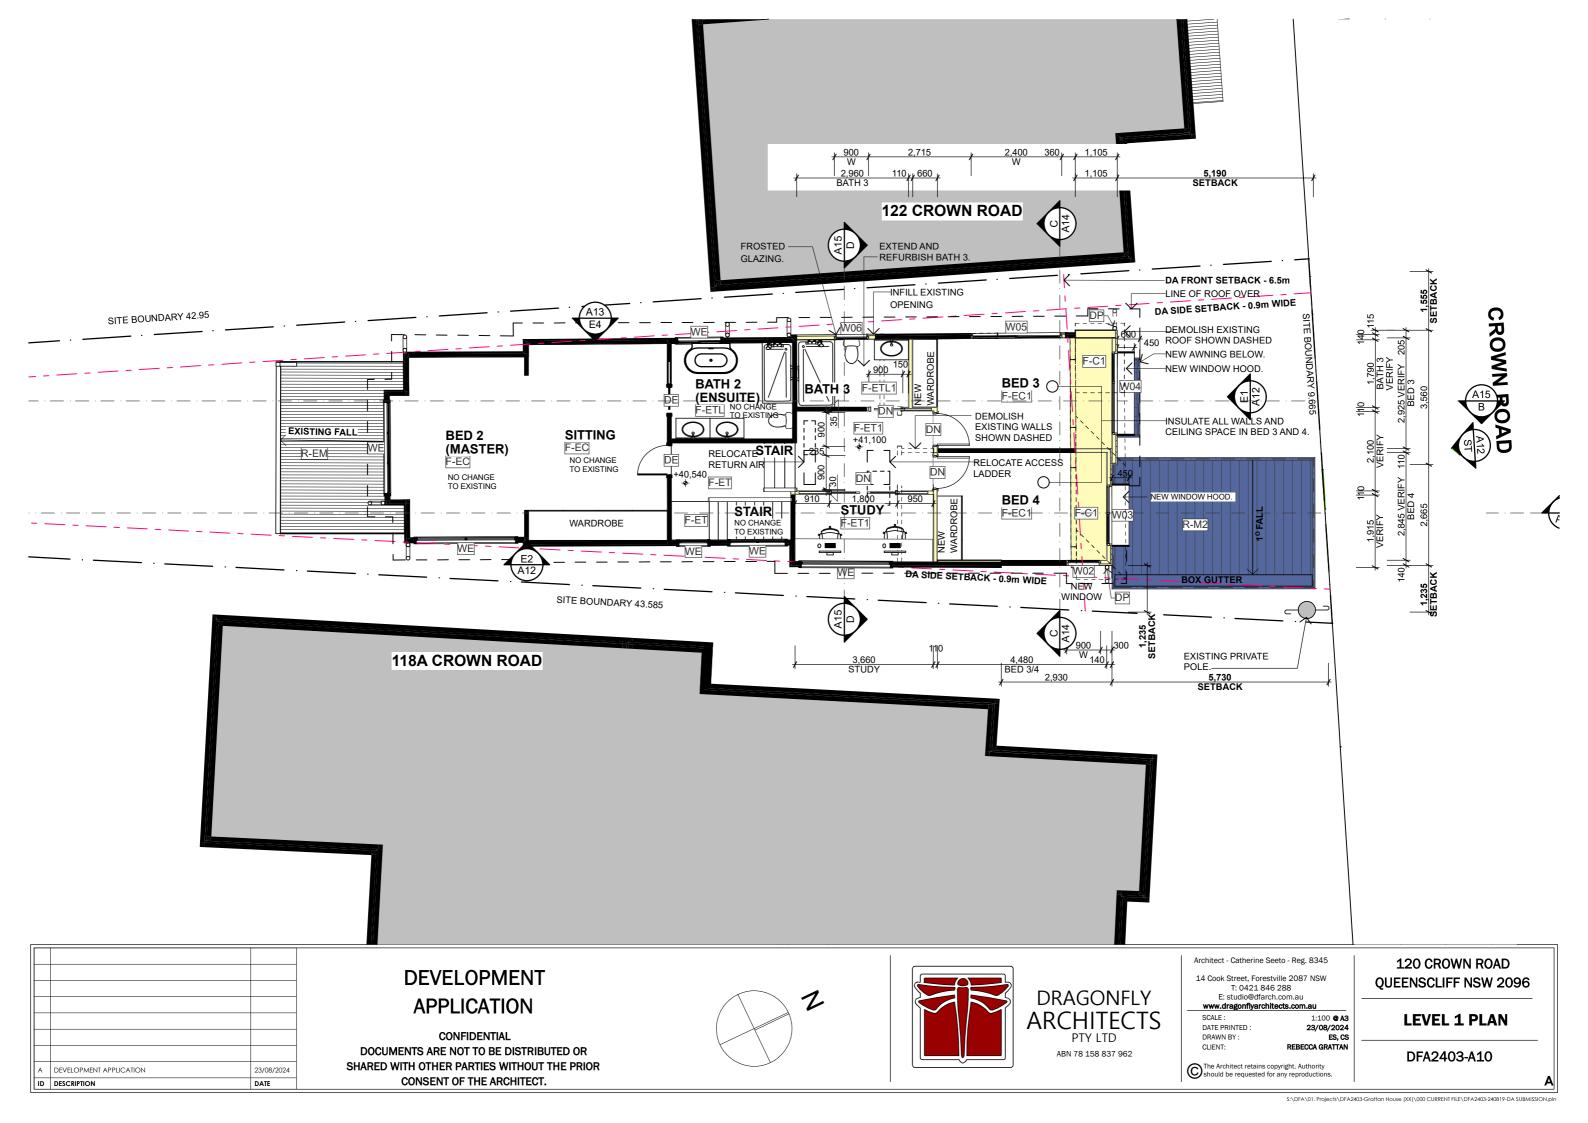

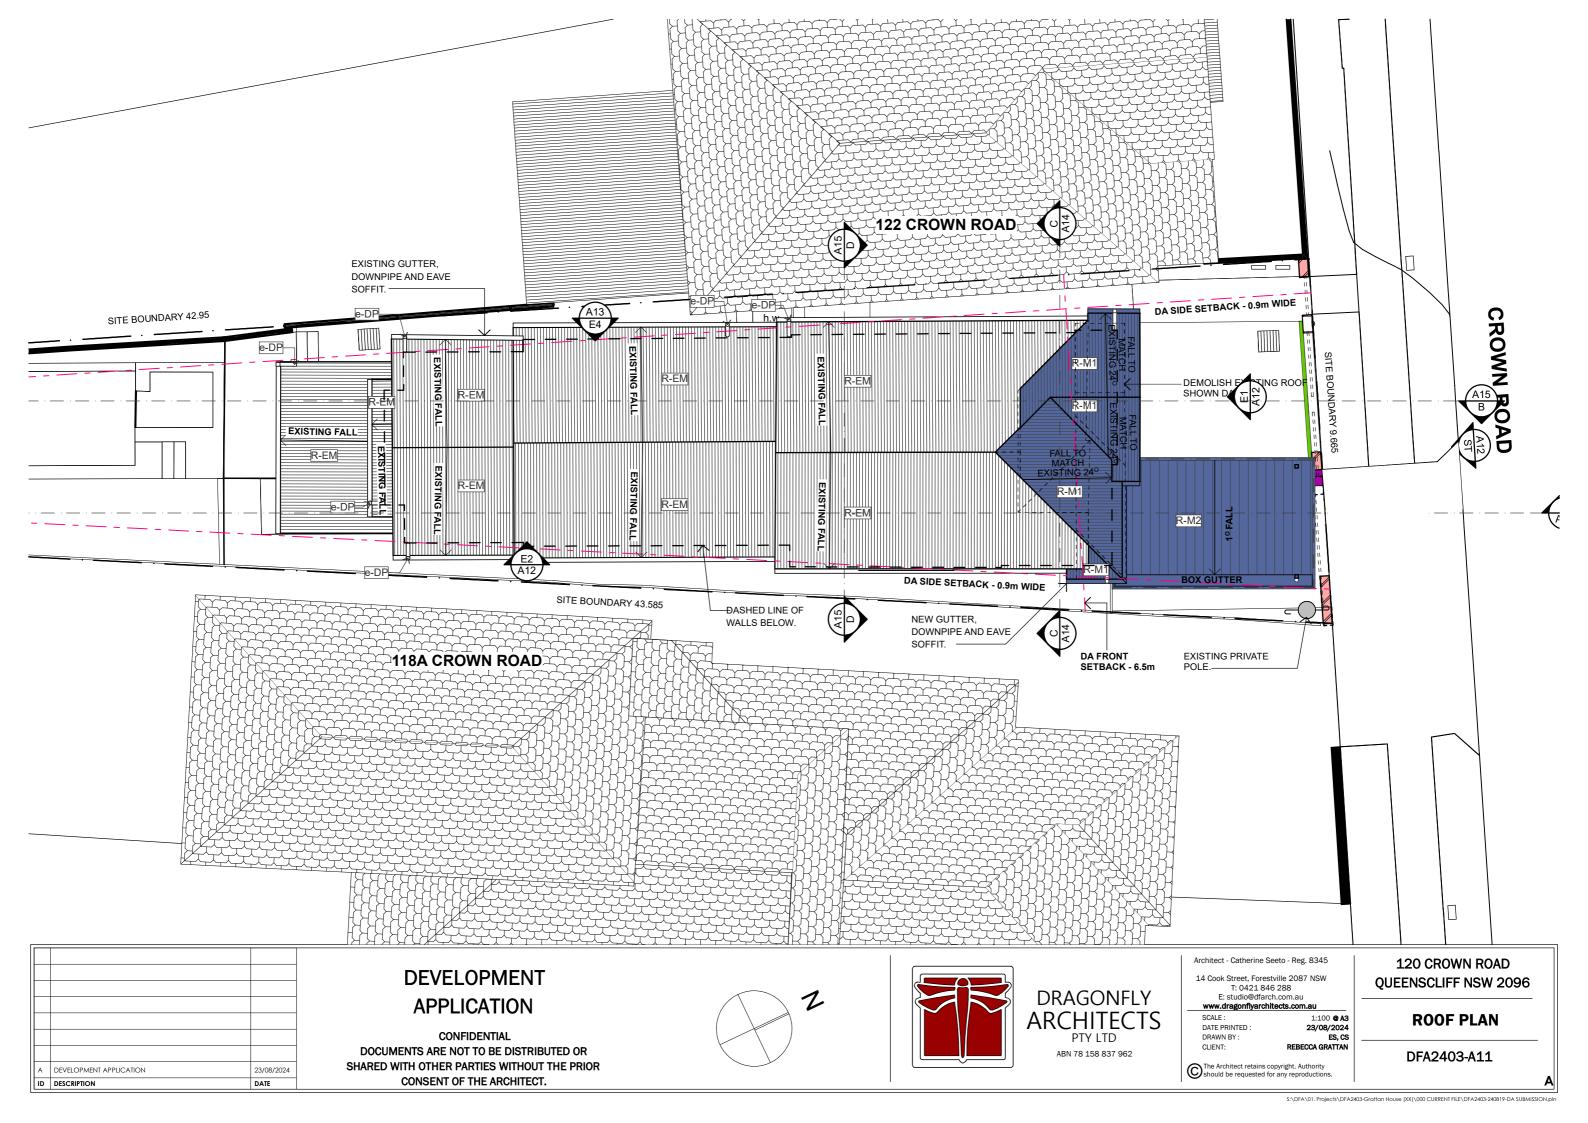

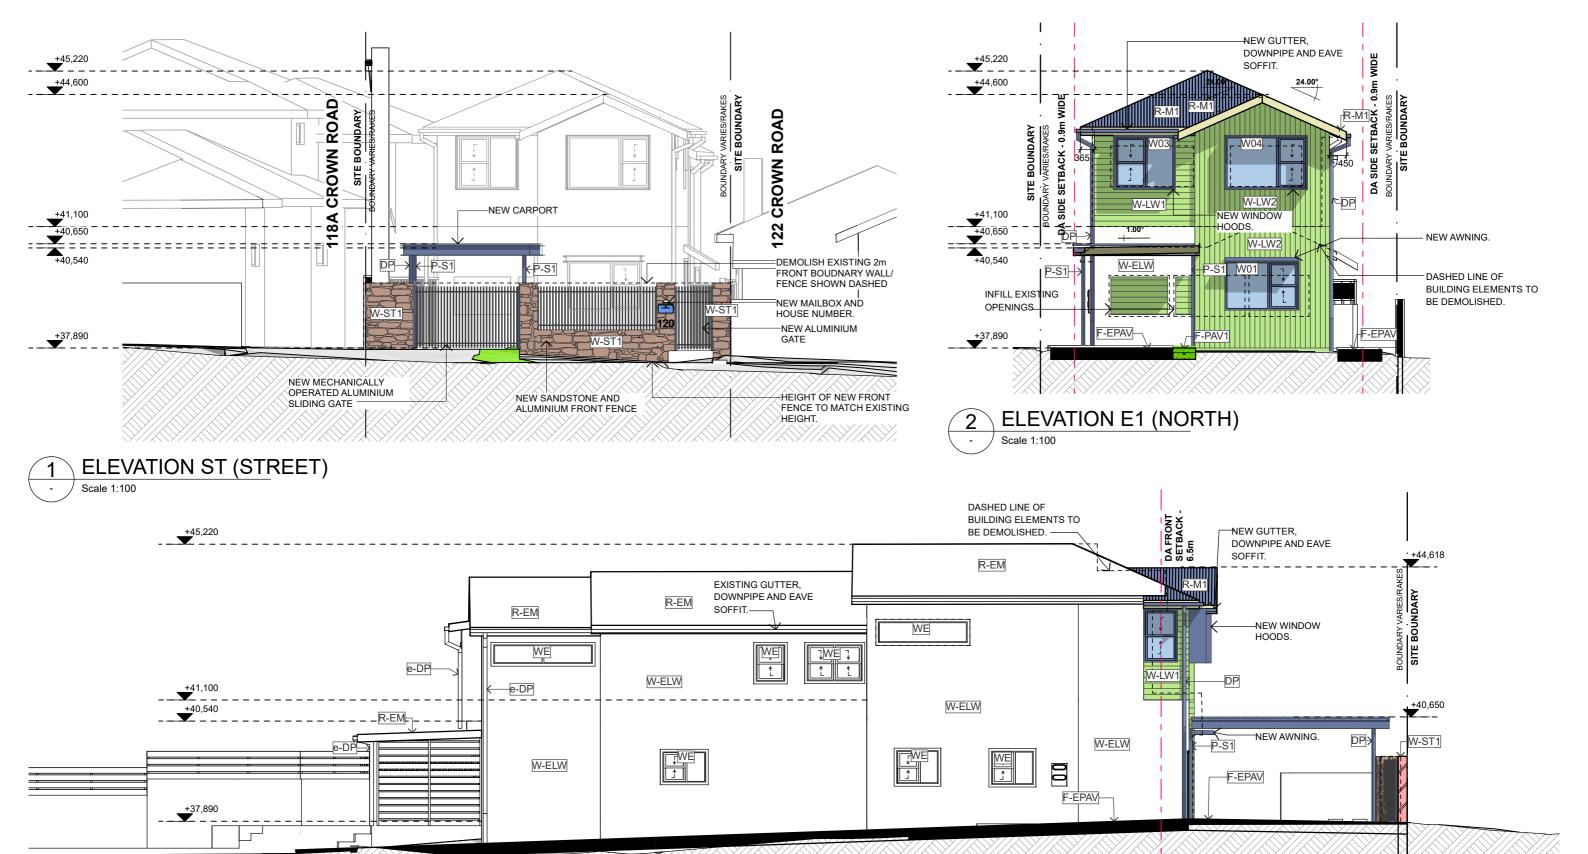



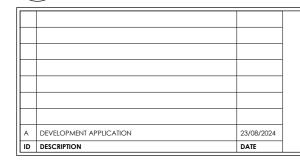

CONFIDENTIAL
DOCUMENTS ARE NOT TO BE DISTRIBUTED OR
SHARED WITH OTHER PARTIES WITHOUT THE PRIOR
CONSENT OF THE ARCHITECT.



Architect - Catherine Seeto - Reg. 8345

14 Cook Street, Forestville 2087 NSW
T: 0421 846 288
E: studio@dfarch.com.au
www.dragonflyarchitects.com.au

1. 042 1.040 2.00
E: studio@dfarch.com.au

www.dragonflyarchitects.com.au

SCALE: 1:100 @ A3

DATE PRINTED: 23/08/2024

DRAWN BY: ES. CS

CLIENT:

ELEVATION STREET, E1
AND E2


120 CROWN ROAD


QUEENSCLIFF NSW 2096

DFA2403-A12


Intect retains copyright. Authority
the requested for any reproductions.

REBECCA GRATTAN

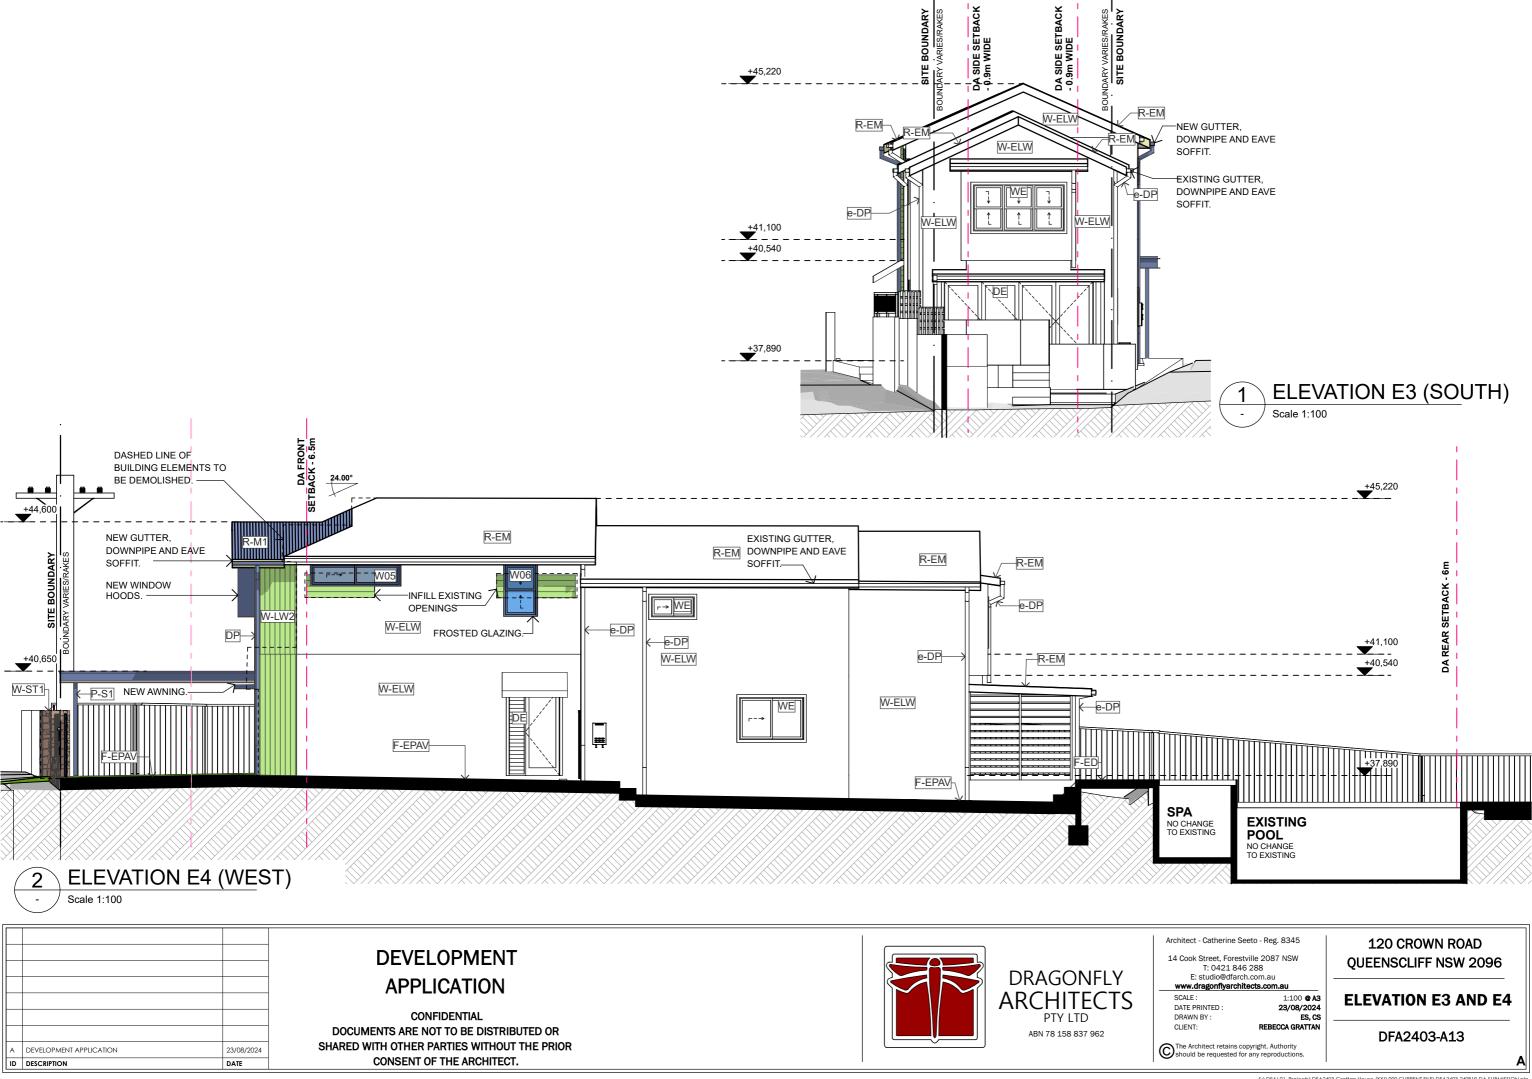

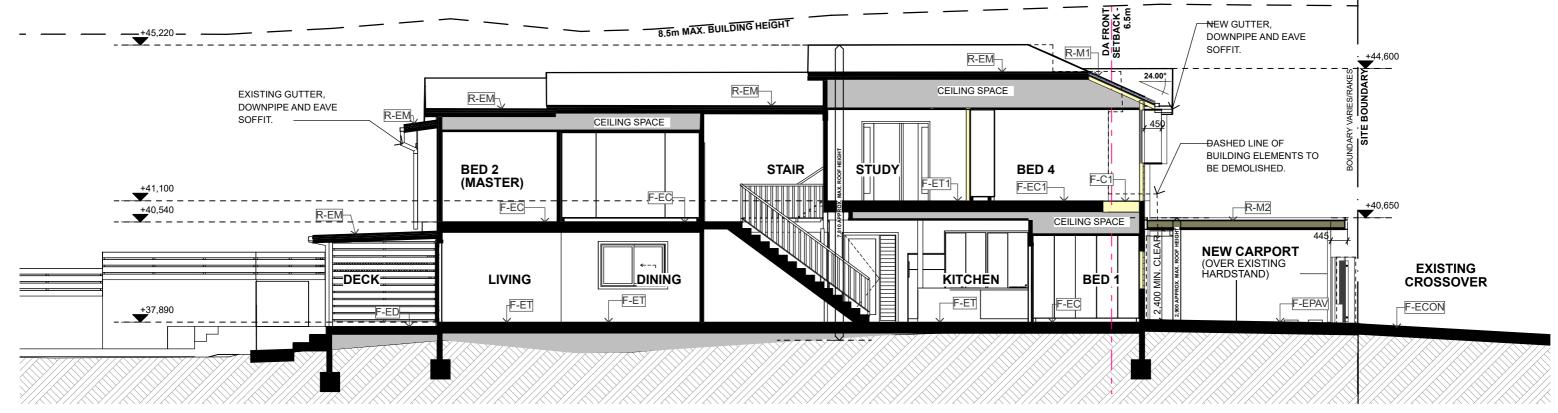


SECTION A
- Scale 1:100

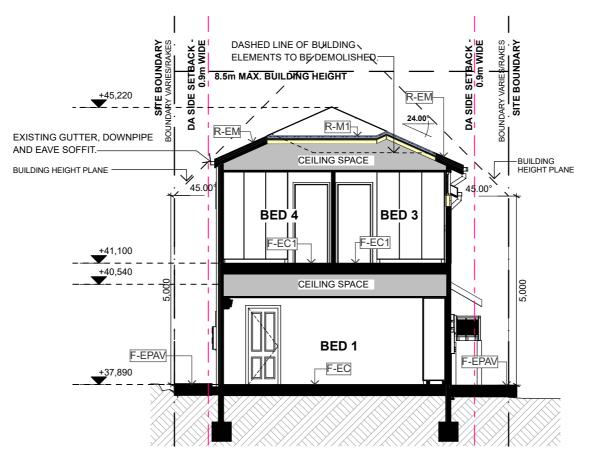

SECTION C

Scale 1:100

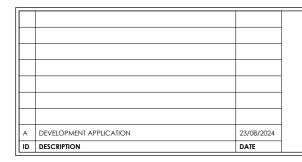

DEVELOPMENT APPLICATION

CONFIDENTIAL
DOCUMENTS ARE NOT TO BE DISTRIBUTED OR
SHARED WITH OTHER PARTIES WITHOUT THE PRIOR
CONSENT OF THE ARCHITECT.



Architect - Catherine Seeto - Reg. 8345

14 Cook Street, Forestville 2087 NSW T: 0421 846 288 E: studio@dfarch.com.au www.dragonflyarchitects.com.au


SCALE : DATE PRINTED : DRAWN BY : CLIENT: 1:100 @ A3 23/08/2024 ES, CS REBECCA GRATTAN


SECTION A AND C

120 CROWN ROAD

QUEENSCLIFF NSW 2096

The Architect retains copyright. Authority

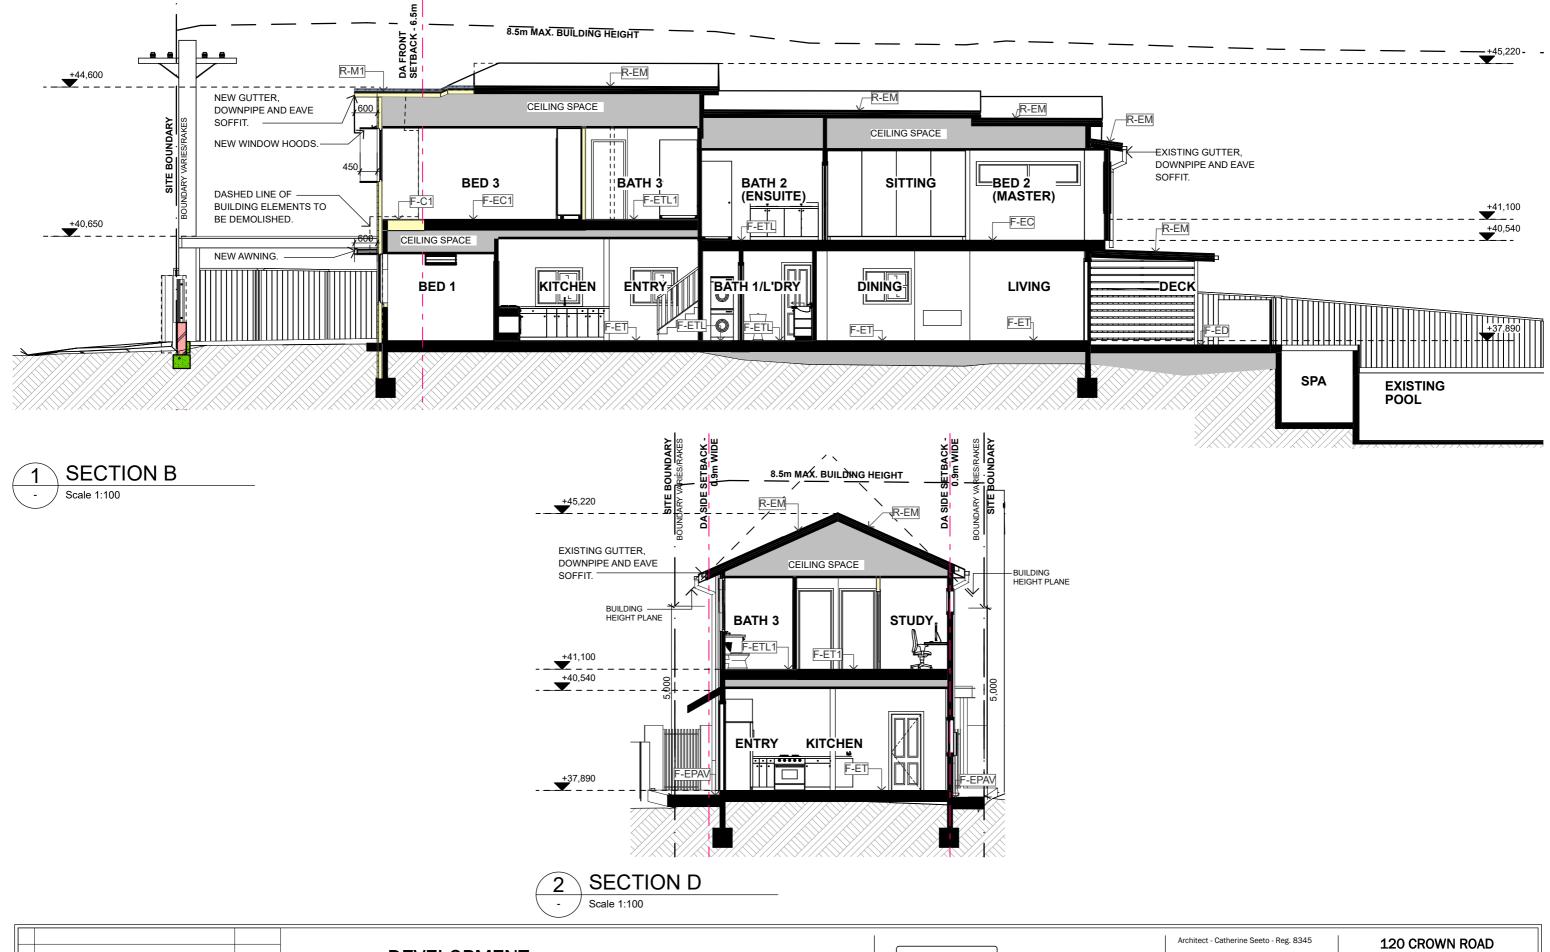

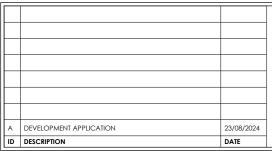

CONFIDENTIAL DOCUMENTS ARE NOT TO BE DISTRIBUTED OR SHARED WITH OTHER PARTIES WITHOUT THE PRIOR CONSENT OF THE ARCHITECT.



14 Cook Street, Forestville 2087 NSW T: 0421 846 288 E: studio@dfarch.com.au

SCALE: DATE PRINTED

CLIENT:

1:100 @ A3 23/08/2024 REBECCA GRATTAN

SECTION B AND D

QUEENSCLIFF NSW 2096



Alterations and Additions

Certificate number: A1760465

This certificate confirms that the proposed development will meet the NSW government's requirements for sustainability, if it is built in accordance with the commitments set out below. Terms used in this certificate, or in the commitments, have the meaning given by the document entitled "BASIX Definitions" dated 10/09/2020 published by the Department. This document is available at www.basix.nsw.gov.au

Secretary
Date of issue: Monday, 19 August 2024
To be valid, this certificate must be lodged within 3 months of the date of issue.



Project address				
Project name	Grattan House			
Street address	120 CROWN Road QUEENSCLIFF 2096			
Local Government Area	Northern Beaches Council			
Plan type and number	Deposited Plan DP925573			
Lot number	В			
Section number	-			
Project type				
Dwelling type	Dwelling house (detached)			
Type of alteration and addition	The estimated development cost for my renovation work is \$50,000 or more, and does not include a pool (and/or spa).			
N/A	N/A			
Certificate Prepared by (please complete before submitting to Council or PCA)				
Name / Company Name: DRAGONFLY ARCHITECTS PTY LTD				
ABN (if applicable): 78158837962				

BASIX Certificate number:A1760465

Fixtures and systems	Show on DA Plans	Show on CC/CDC Plans & specs	Certifier Check
Lighting			
The applicant must ensure a minimum of 40% of new or altered light fixtures are fitted with fluorescent, compact fluorescent, or light-emitting-diode (LED) lamps.		v	v
Fixtures			
The applicant must ensure new or altered showerheads have a flow rate no greater than 9 litres per minute or a 3 star water rating.		v	v
The applicant must ensure new or altered toilets have a flow rate no greater than 4 litres per average flush or a minimum 3 star water rating.		v	v
The applicant must ensure new or altered taps have a flow rate no greater than 9 litres per minute or minimum 3 star water rating.		v	

Construction			Show on DA Plans	Show on CC/CDC Plans & specs	Certifier Check
Insulation requirements					
The applicant must construct the new or alter listed in the table below, except that a) addit insulation specified is not required for parts of the construction of th	ional insulation is not required where the are	a of new construction is less than 2m2, b)	V	V	v
Construction	Additional insulation required (R-value)	Other specifications			
floor above existing dwelling or building.	nil	N/A			
external wall: framed (weatherboard, fibro, metal dad)	R1.30 (or R1.70 including construction)				
flat ceiling, pitched roof	ceiling: R1.45 (up), roof: foil backed blanket (55 mm)	medium (solar absorptance 0.475 - 0.70)			

Planning Industry And Environment Building Sustainability Index www.basix.nsw.gov.au

Glazing requirements	Show on DA Plans	Show on CC/CDC Plans & specs	Certifier Check
Windows and glazed doors			
The applicant must install the windows, glazed doors and shading devices, in accordance with the specifications listed in the table below. Relevant overshadowing specifications must be satisfied for each window and glazed door.	v	v	U
The following requirements must also be satisfied in relation to each window and glazed door:		v	U
Each window or glazed door with improved frames, or pyrolytic low-e glass, or clear/air gap/clear glazing, or toned/air gap/clear glazing must have a U-value and a Solar Heat Gain Coefficient (SHGC) no greater than that listed in the table below. Total system U-values and SHGCs must be calculated in accordance with National Fenestration Rating Council (NFRC) conditions. The description is provided for information only. Alternative systems with complying U-value and SHGC may be substituted.		J	v
For projections described in millimetres, the leading edge of each eave, pergola, verandah, balcony or awning must be no more than 500 mm above the head of the window or glazed door and no more than 2400 mm above the sill.	~	v	v
Pergolas with polycarbonate roof or similar translucent material must have a shading coefficient of less than 0.35.		v	v
Pergolas with fixed battens must have battens parallel to the window or glazed door above which they are situated, unless the pergola also shades a perpendicular window. The spacing between battens must not be more than 50 mm.		v	J

Planning Industry And Environment Building Sustainability Index www.basix.nsw.gov.au Planning Industry And Environment Building Sustainability Index www.basix.nsw.gov.au

Α	DEVELOPMENT APPLICATION	23/08/2024
ID	DESCRIPTION	DATE

DEVELOPMENT APPLICATION

CONFIDENTIAL DOCUMENTS ARE NOT TO BE DISTRIBUTED OR SHARED WITH OTHER PARTIES WITHOUT THE PRIOR CONSENT OF THE ARCHITECT.



DRAGONFLY **ARCHITECTS** PTY LTD ABN 78 158 837 962

Architect - Catherine Seeto - Reg. 8345

14 Cook Street, Forestville 2087 NSW T: 0421 846 288 E: studio@dfarch.com.au

www.dragonflyarchitects.com.au SCALE: DATE PRINTED :

CLIENT:

NTS @ A3 23/08/2024 REBECCA GRATTAN

The Architect retains copyright. Authority should be requested for any reproductions.

120 CROWN ROAD **QUEENSCLIFF NSW 2096**

BASIX 1

BASIX Certificate number:A1760465

lazing requir	ements						Show on DA Plans	Show on CC/CDC Plans & specs	Certifie Check
indows and gla	zed doors glazing	g requirements							
Window/door number	Orientation	Area of glass including frame (m2)	Overshadowing height (m)	Overshadowing distance (m)	Shading device	Frame and glass type			
W01	N	2.54	0	0	eave/ verandah/ pergola/balcony >=600 mm	aluminium, double Lo- Tsol/air gap/ clear, (U-value: 4.9, SHGC: 0.33)			
W02	E	1.26	0	0	eave/ verandah/ pergola/balcony >=450 mm	improved aluminium, clear/air gap/ clear, (U-value: 4.12, SHGC: 0.66)			
W03	N	2.24	0	0	eave/ verandah/ pergola/balcony >=450 mm	aluminium, double Lo- Tsol/air gap/ clear, (U-value: 4.9, SHGC: 0.33)			
W04	N	3.06	0	0	eave/ verandah/ pergola/balcony >=450 mm	aluminium, double Lo- Tsol/air gap/ clear, (U-value: 4.9, SHGC: 0.33)			
W05	w	1.44	0	0	eave/ verandah/ pergola/balcony >=450 mm	improved aluminium, clear/air gap/ clear, (U-value: 4.12, SHGC: 0,66)			

Planning Industry And Environment

Glazing requirements					Show on DA Plans	Show on CC/CDC Plans & specs	Certifier Check		
Window/door number	Orientation	Area of glass including frame (m2)	Overshadowing height (m)	Overshadowing distance (m)	Shading device	Frame and glass type			
W06	w	1.26	0	0	eave/ verandah/ pergola/balcony >=450 mm	improved aluminium, clear/air gap/ clear, (U-value: 4.12, SHGC: 0.66)			

Planning Industry And Environment Building Sustainability Index www.basix.nsw.gov.au

BASIX Certificate number:A1760465

DRAGONFLY **ARCHITECTS** PTY LTD ABN 78 158 837 962

Commitments identified with a w in the "Show on DA plans" column must be shown on the plans accompanying the development application for the proposed development (if a development application is to be lodged for the proposed development). Commitments identified with a w in the "Show on CC/CDC plans & specs" column must be shown in the plans and specifications accompanying the application for a construction certificate / complying development certificate for the proposed development. Commitments identified with a V in the "Certifier check" column must be certified by a certifying authority as having been fulfilled, before a final occupation certificate for the development may be issued.

 ${\it Architect - Catherine Seeto - Reg. \, 8345}$

14 Cook Street, Forestville 2087 NSW T: 0421 846 288 E: studio@dfarch.com.au

SCALE : DATE PRINTED : NTS @ A3 23/08/2024 ES, CS DRAWN BY: REBECCA GRATTAN CLIENT:

BASIX 2

120 CROWN ROAD

QUEENSCLIFF NSW 2096

DFA2403-A17


A DEVELOPMENT APPLICATION 23/08/2024 ID DESCRIPTION DATE


DEVELOPMENT APPLICATION


CONFIDENTIAL DOCUMENTS ARE NOT TO BE DISTRIBUTED OR SHARED WITH OTHER PARTIES WITHOUT THE PRIOR CONSENT OF THE ARCHITECT.

page 7/7

Building Sustainability Index www.basix.nsw.gov.au

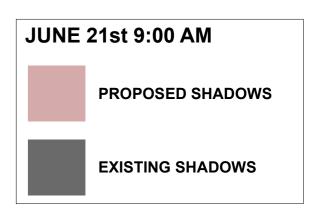

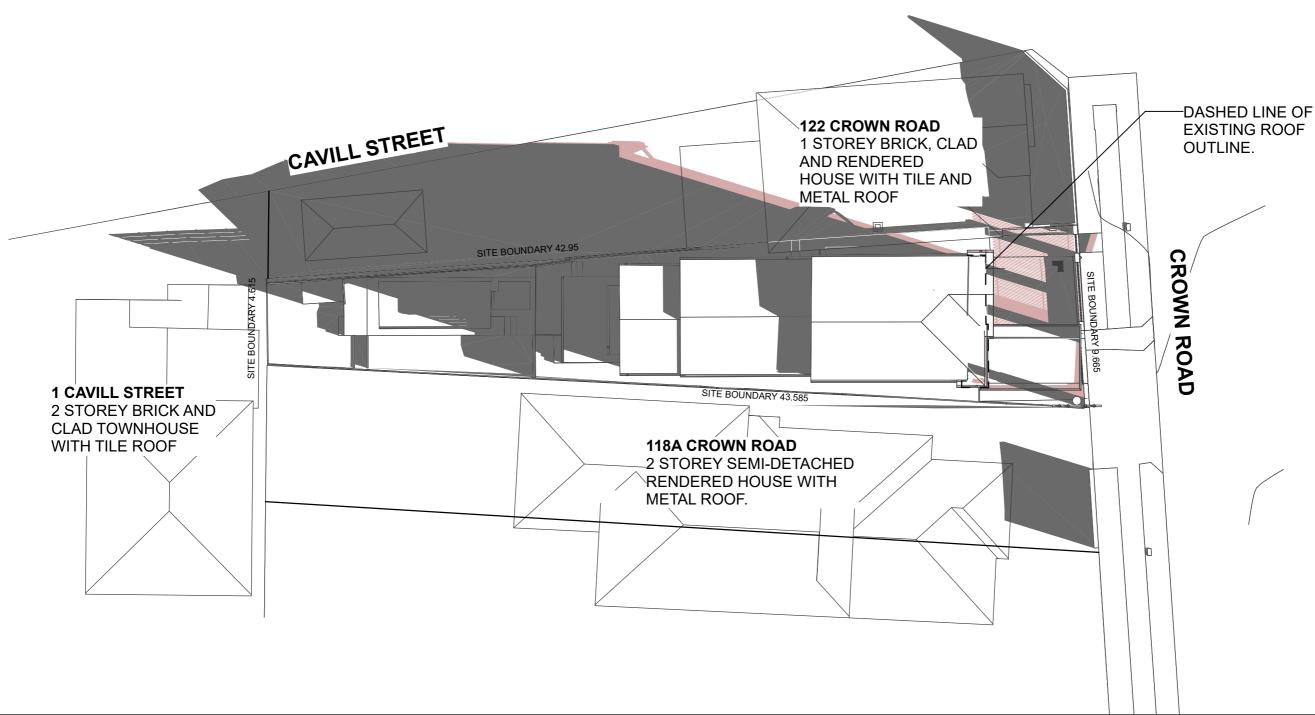

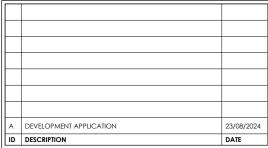

CONFIDENTIAL
DOCUMENTS ARE NOT TO BE DISTRIBUTED OR
SHARED WITH OTHER PARTIES WITHOUT THE PRIOR
CONSENT OF THE ARCHITECT.





Architect - Catherine Seeto - Reg. 8345

14 Cook Street, Forestville 2087 NSW T: 0421 846 288 E: studio@dfarch.com.au

> 1:200 @ A3 23/08/2024

ES, CS REBECCA GRATTAN


E: studio@dfarch.com.au www.dragonflyarchitects.com.a SCALE:


SCALE:
DATE PRINTED:
DRAWN BY:
CLIENT:


The Architect retains copyright. Authority should be requested for any reproductions.

120 CROWN ROAD QUEENSCLIFF NSW 2096


SHADOWS JUNE 21-9AM

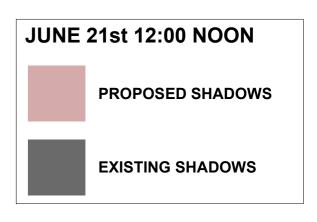

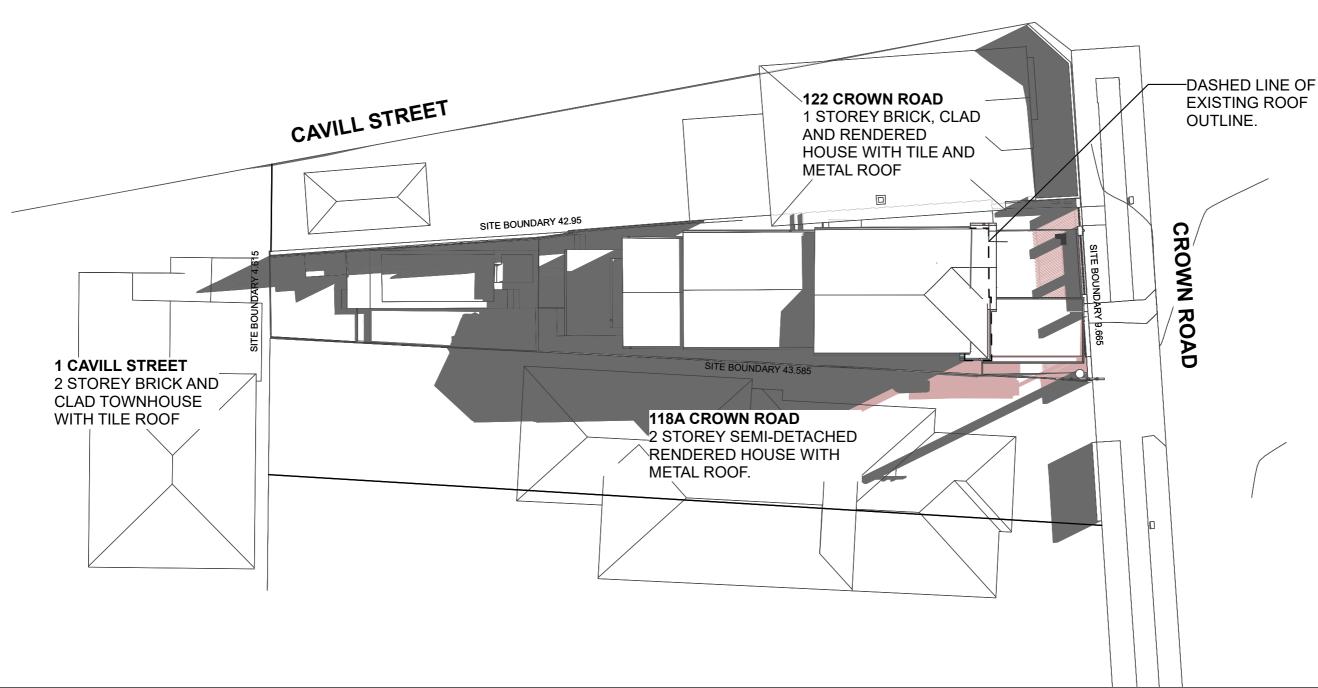

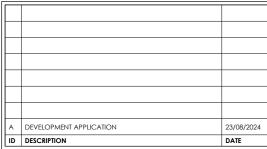

CONFIDENTIAL
DOCUMENTS ARE NOT TO BE DISTRIBUTED OR
SHARED WITH OTHER PARTIES WITHOUT THE PRIOR
CONSENT OF THE ARCHITECT.

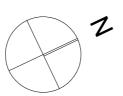



Architect - Catherine Seeto - Reg. 8345

14 Cook Street, Forestville 2087 NSW T: 0421 846 288 E: studio@dfarch.com.au


E: studio@dfarch.com.au www.dragonflyarchitects.com.a


SCALE: DATE PRINTED: DRAWN BY: CLIENT: 1:200 @ A3 23/08/2024 ES, CS REBECCA GRATTAN


The Architect retains copyright. Authority should be requested for any reproductions

120 CROWN ROAD QUEENSCLIFF NSW 2096

> SHADOWS JUNE 21-12NOON

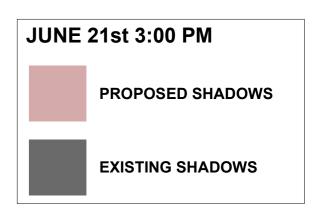

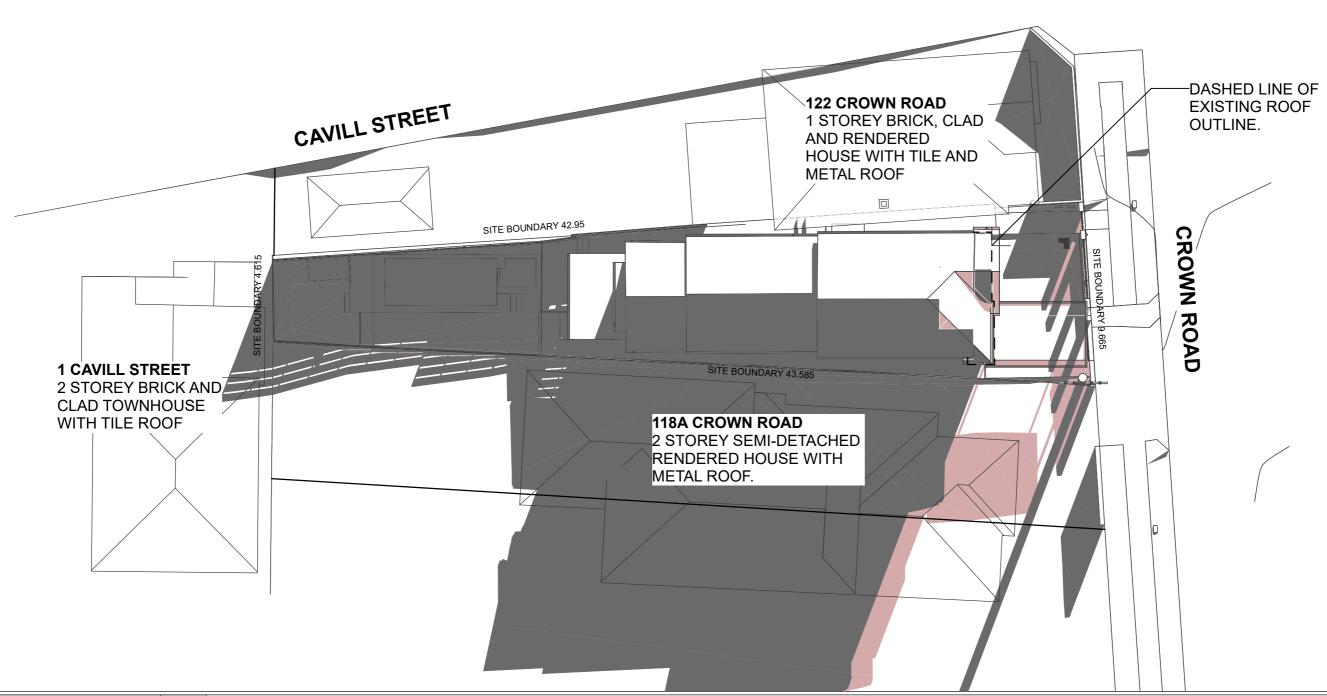

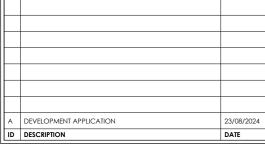

CONFIDENTIAL
DOCUMENTS ARE NOT TO BE DISTRIBUTED OR
SHARED WITH OTHER PARTIES WITHOUT THE PRIOR
CONSENT OF THE ARCHITECT.





Architect - Catherine Seeto - Reg. 8345

14 Cook Street, Forestville 2087 NSW T: 0421 846 288 E: studio@dfarch.com.au


E: studio@dfarch.com.au www.dragonflyarchitects.com.

SCALE: DATE PRINTED: DRAWN BY: CLIENT: 1:200 @ A3 23/08/2024 ES, CS REBECCA GRATTAN

opyright. Authority

120 CROWN ROAD QUEENSCLIFF NSW 2096

SHADOWS JUNE 21-3PM

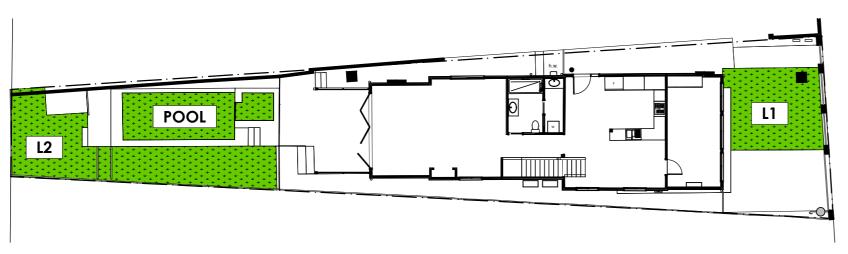

 LANDSCAPE EXISTING

 NAME
 AREA

 L1
 22.35

 L2
 36.63

 POOL
 17.59

 76.57 m²

 EXISTING DOES NOT COMPLY

1 DA LANDSCAPE AREAS EXISTING
- Scale 1:200

PRIVATE OPEN SPACE NORTHERN BEACHES COUNCIL DCP - PART D2

3 OR MORE BEDROOMS WITH A MIN. DIMENSION OF 5m. MIN. REQUIRED PRIVATE OPEN SPACE = $60m^2$

COMPLIES


LANDSCAPE CALCULATIONS NORTHERN BEACHES COUNCIL DCP - PART D1

NOTE: SOFT LANDSCAPE AREAS WITH MIN. DIMENSION GREATER THAN 2,000mm

TOTAL SITE IS 308m²

MIN LANDSCAPE REQUIRED IS 40% MIN. LANDSCAPE (0.40 X 308m²)= 123.2m²

MIN. REQUIRED SOFT LANDSCAPE = 123.2m²

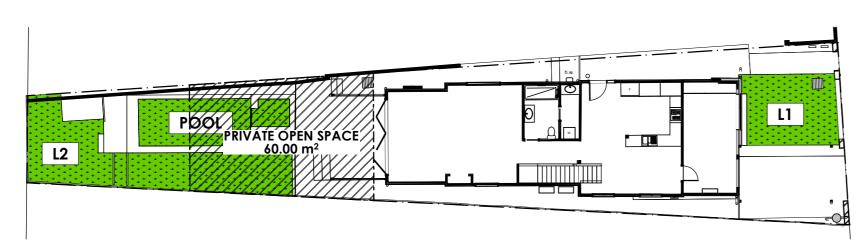

LANDSCAPE PROPOSED					
NAME	AREA				
L1	19.64				
L2	36.63				
POOL	17.59				
	73.86 m ²				
CREASE NON-CO	MPLIANCE BY 2.71 n				


DA LANDSCAPE AREAS PROPOSED

Scale 1:200

D	DESCRIPTION	DATE
4	DEVELOPMENT APPLICATION	23/08/2024

DEVELOPMENT APPLICATION

CONFIDENTIAL
DOCUMENTS ARE NOT TO BE DISTRIBUTED OR
SHARED WITH OTHER PARTIES WITHOUT THE PRIOR
CONSENT OF THE ARCHITECT.

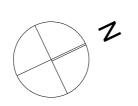



Architect - Catherine Seeto - Reg. 8345	
14 Cook Street, Forestville 2087 NSW	
T: 0421 846 288	
E: studio@dfarch.com.au	
www.dragonflyarchitects.com.au	

E: studio@dfarch.com.au

www.dragonflyarchitects.com.au

SCALE: 1:200 @ A3


DATE PRINTED: 23/08/2024

DRAWN BY: ES, CS
CLIENT: REBECCA GRATTAN

The Architect retains copyright. Authority should be requested for any reproductions.

120 CROWN ROAD QUEENSCLIFF NSW 2096

LANDCAPE CALCULATION

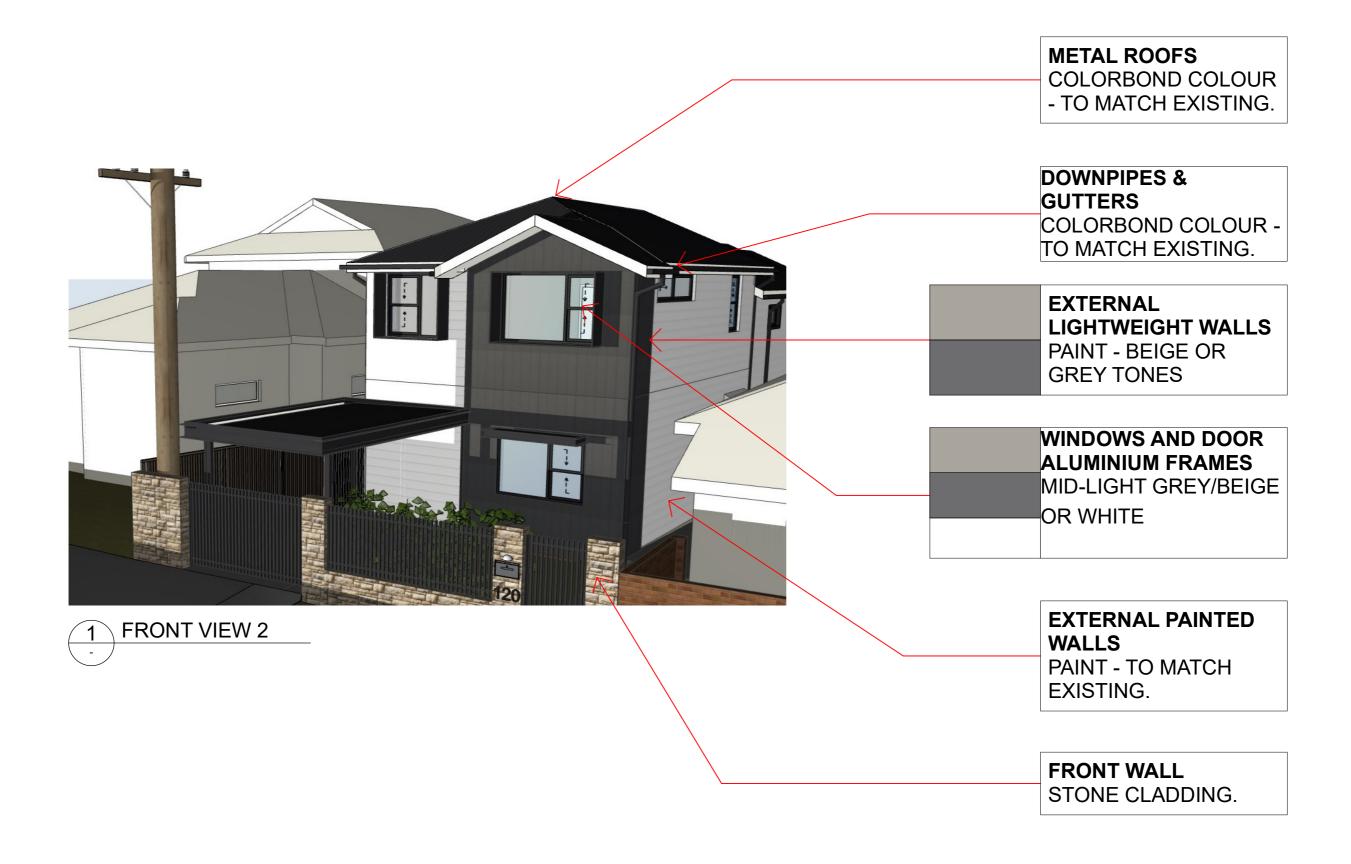

Α	DEVELOPMENT APPLICATION	23/08/2024
ID	DESCRIPTION	DATE

CONFIDENTIAL
DOCUMENTS ARE NOT TO BE DISTRIBUTED OR
SHARED WITH OTHER PARTIES WITHOUT THE PRIOR
CONSENT OF THE ARCHITECT.



Architect - Catherine Seeto - Reg. 8345

14 Cook Street, Forestville 2087 NSW T: 0421 846 288 E: studio@dfarch.com.au

E: studio@dfarch.com.au www.dragonflyarchitects.com.

SCALE:
DATE PRINTED:
DRAWN BY:
CLIENT:

NTS @ A3
23/08/2024
ES, CS
REBECCA GRATTAN

The Architect retains copyright. Authority should be requested for any reproductions.

120 CROWN ROAD QUEENSCLIFF NSW 2096

FINISHES SCHEDULE