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private residence

52 pitt road, north curl curl

alterations and additions development application architectural perspectives

TERRACE TILES or similar



POLYSTYRENE CLADDING MASTERWALL WHITE or similar




DRIVEWAY CONCRETE or similar





GUTTERS DOWNPIPES ROOF COLORBOND WINDSPRAY or similar to match existing





WINDOWS POWDERCOATED BLACK

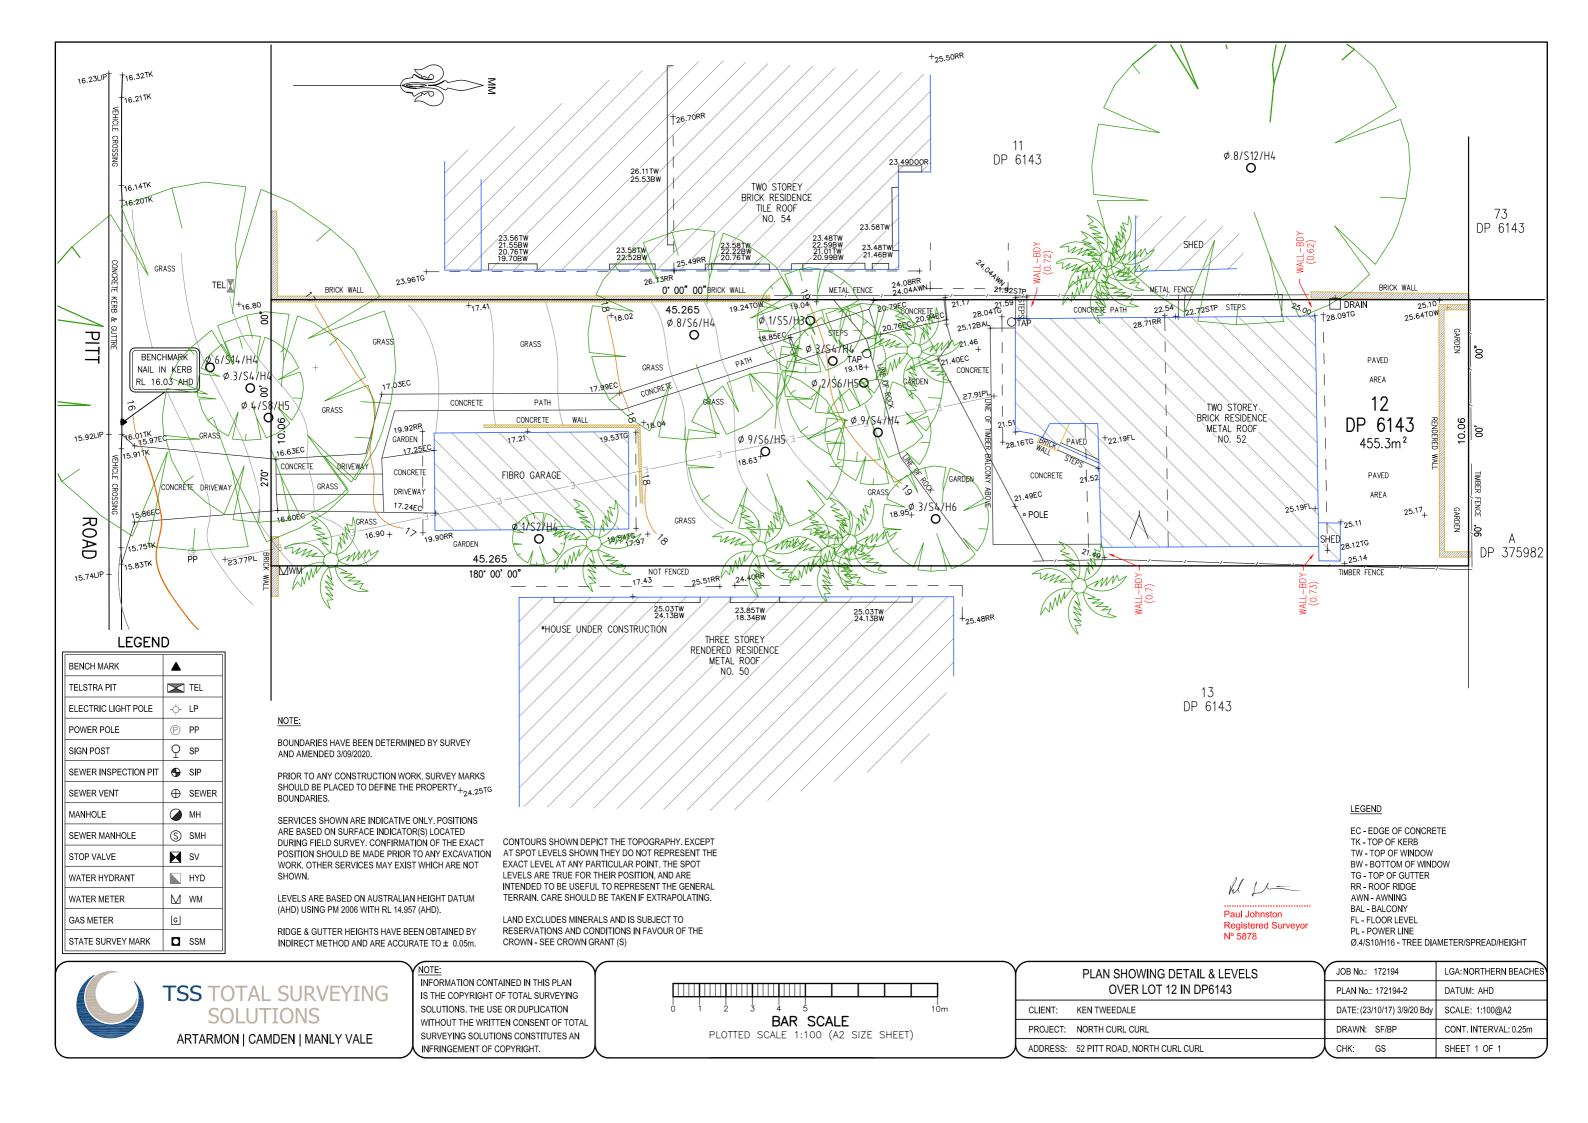


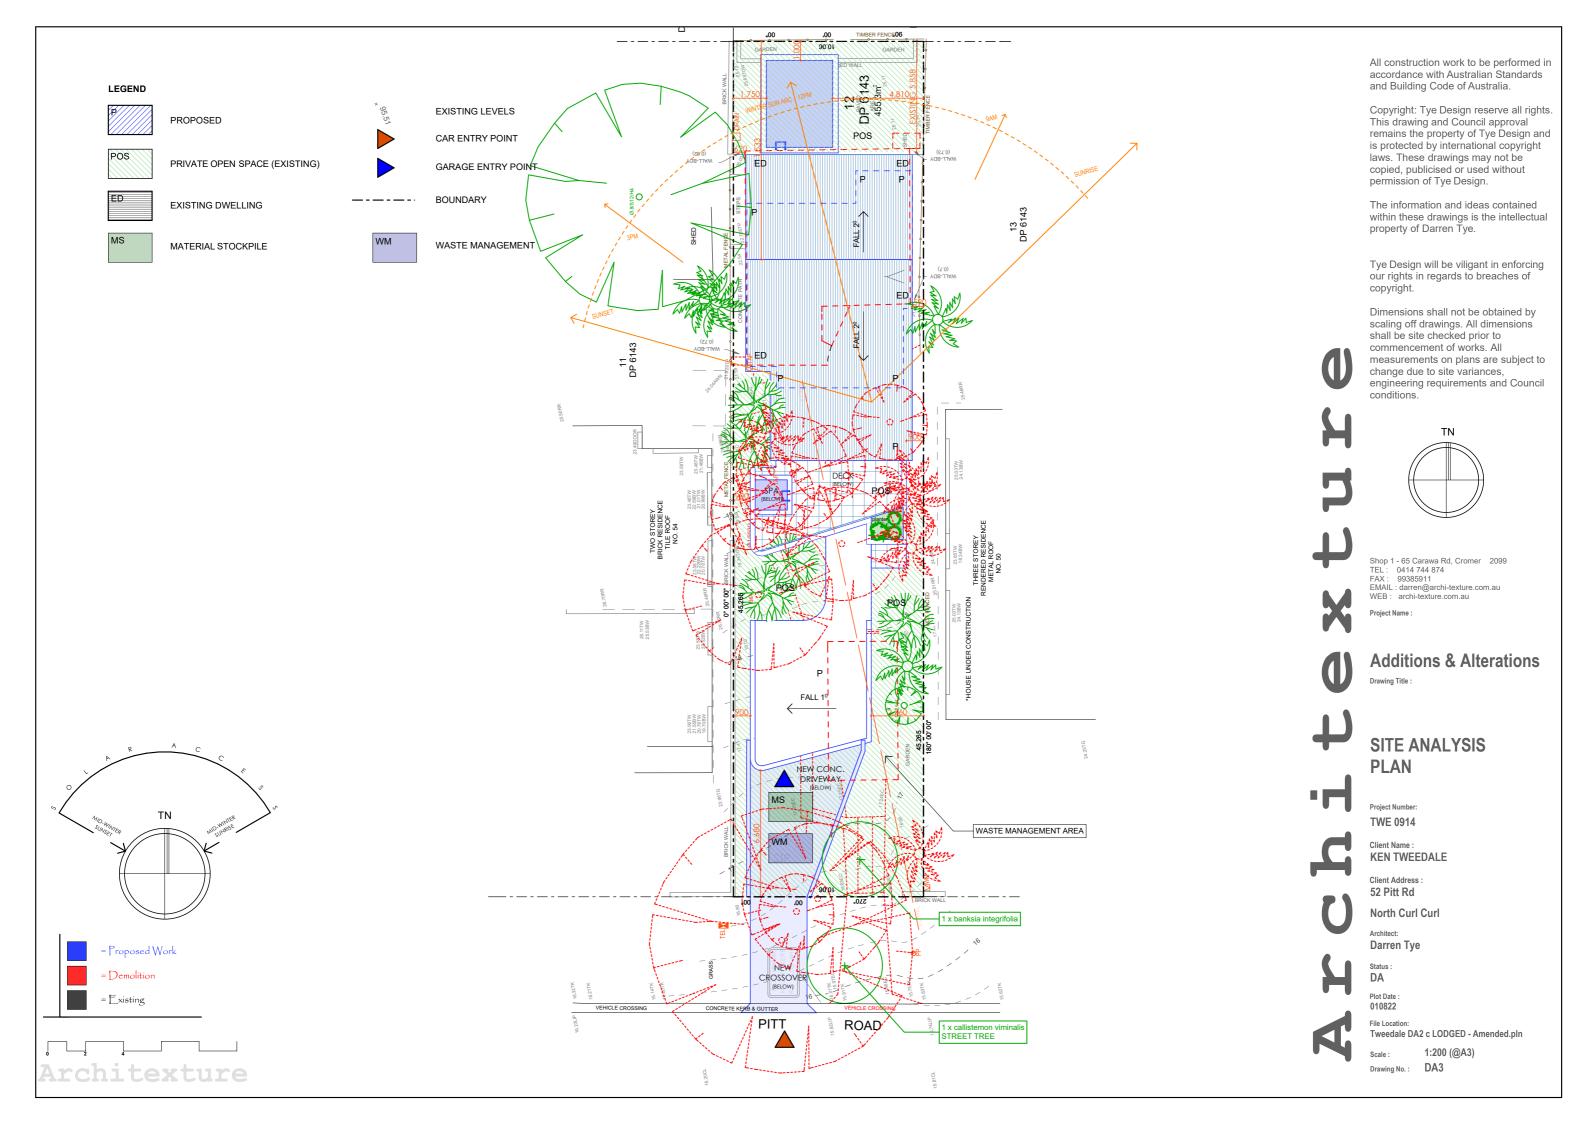


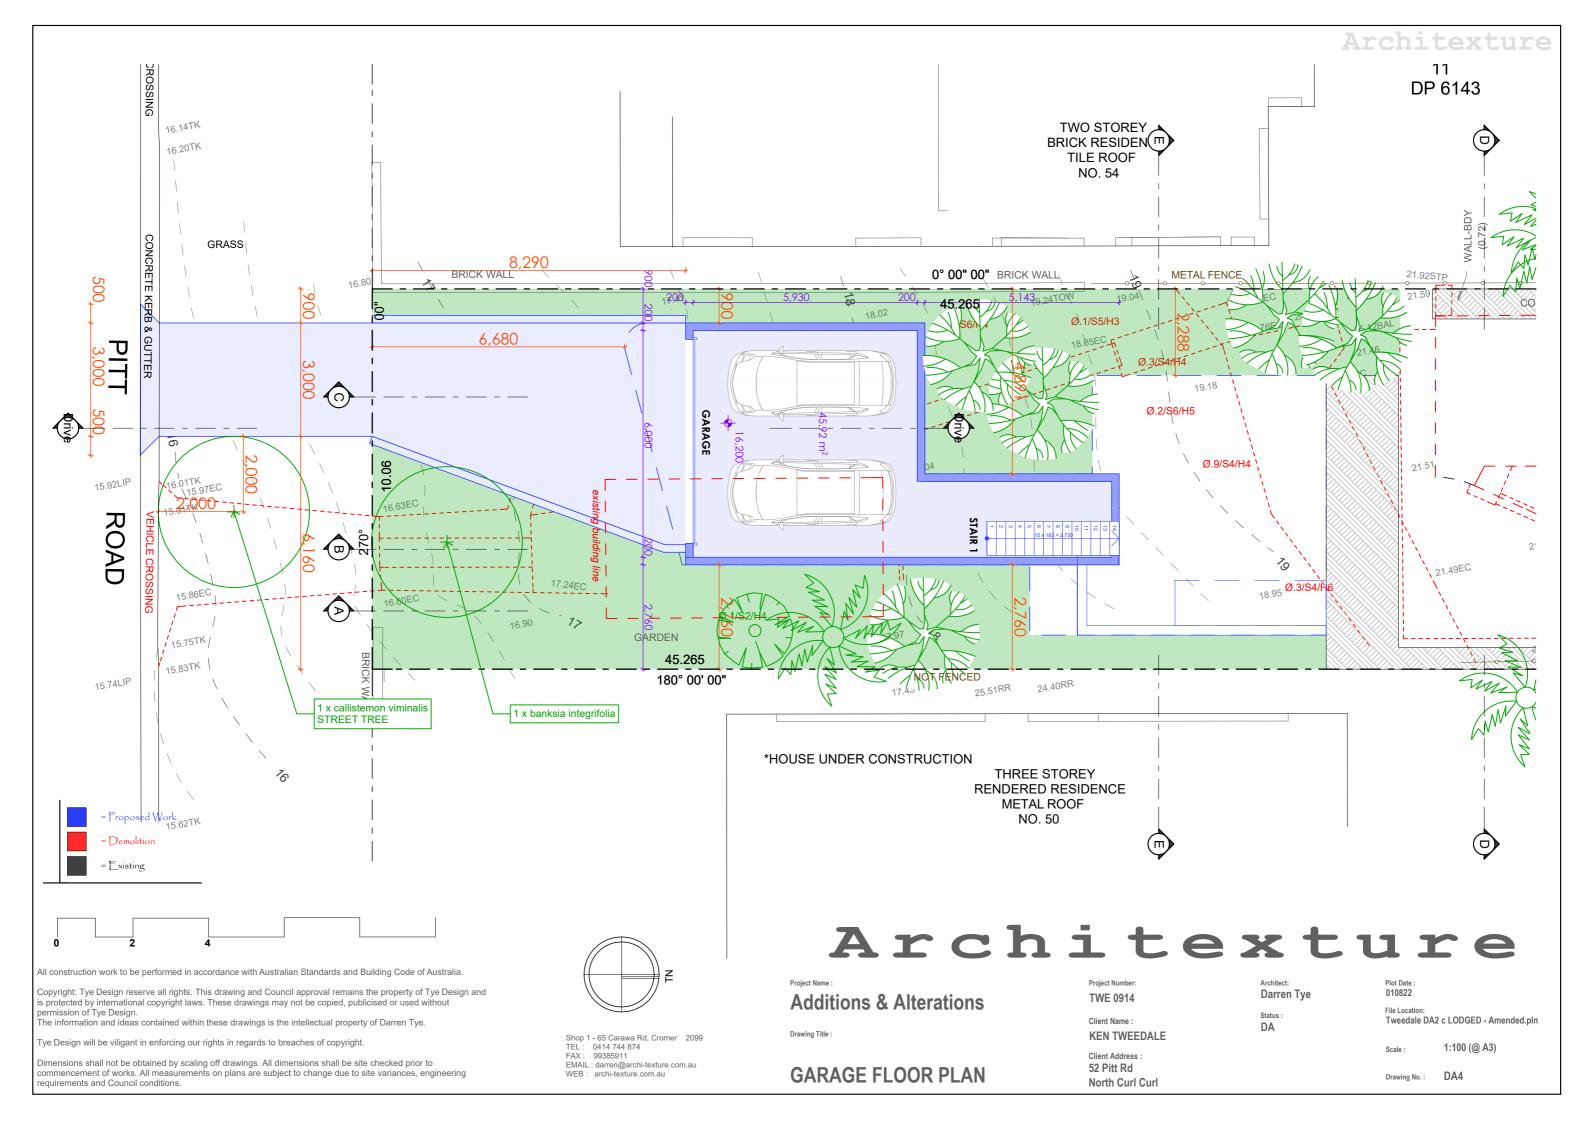


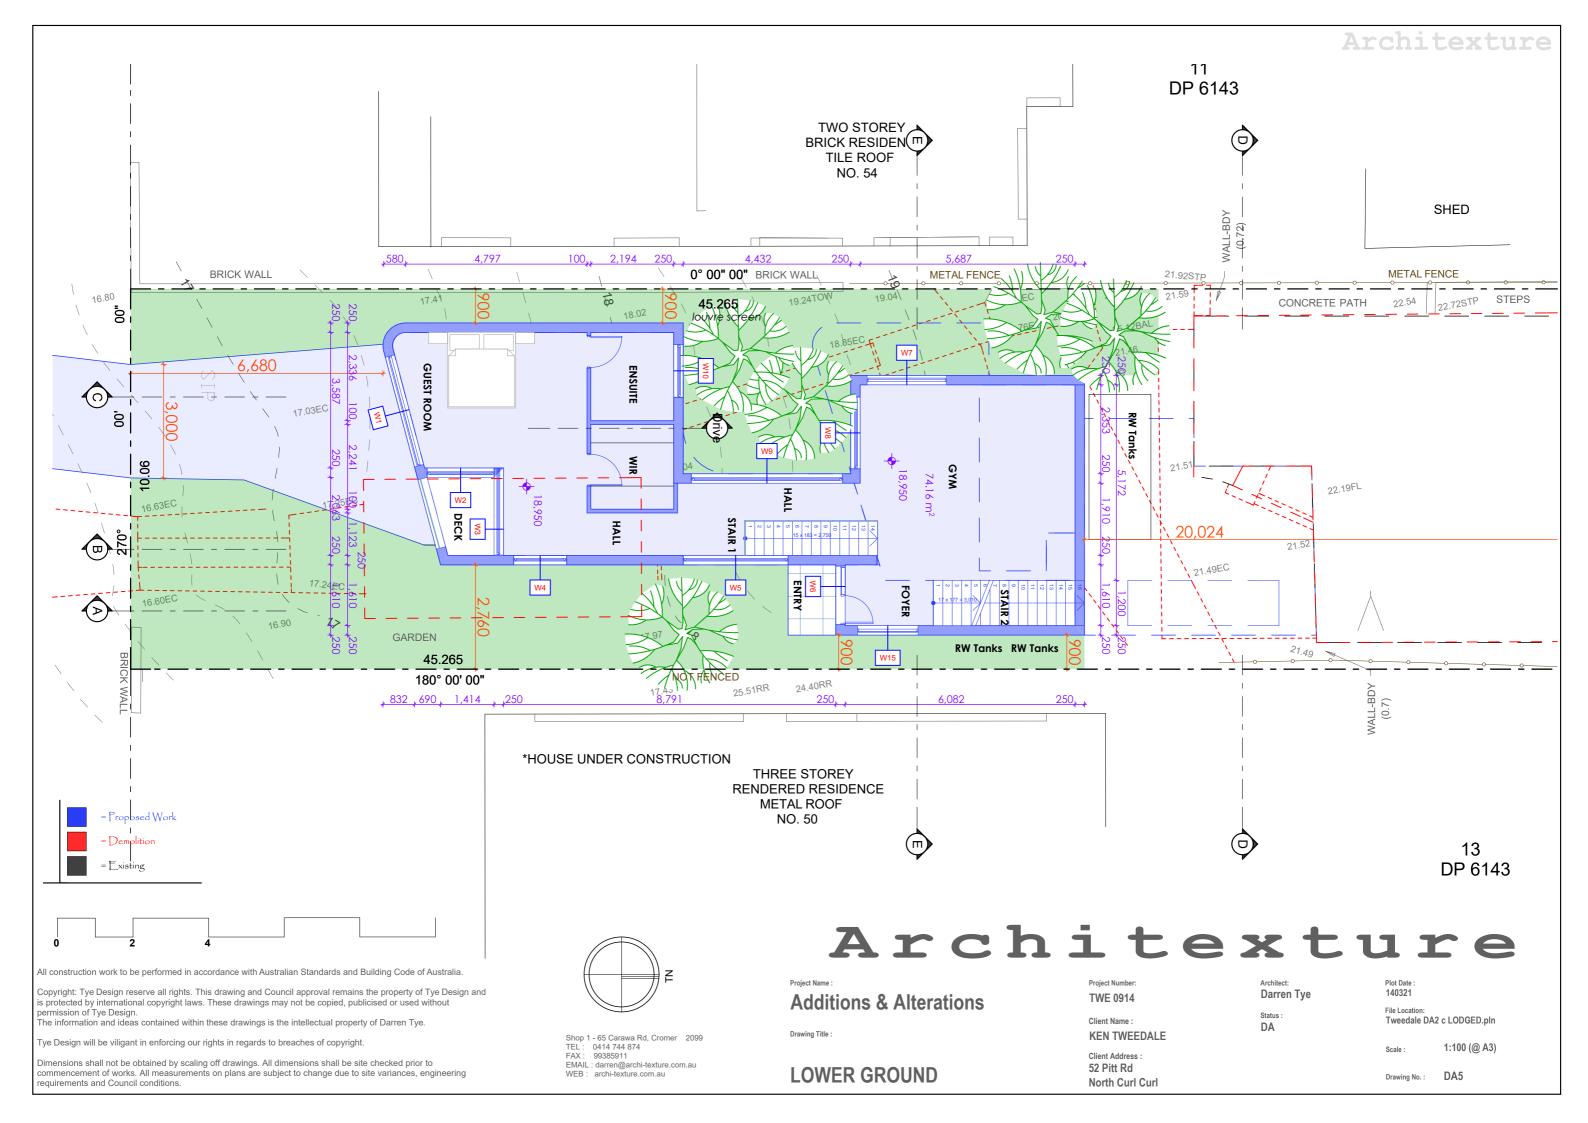

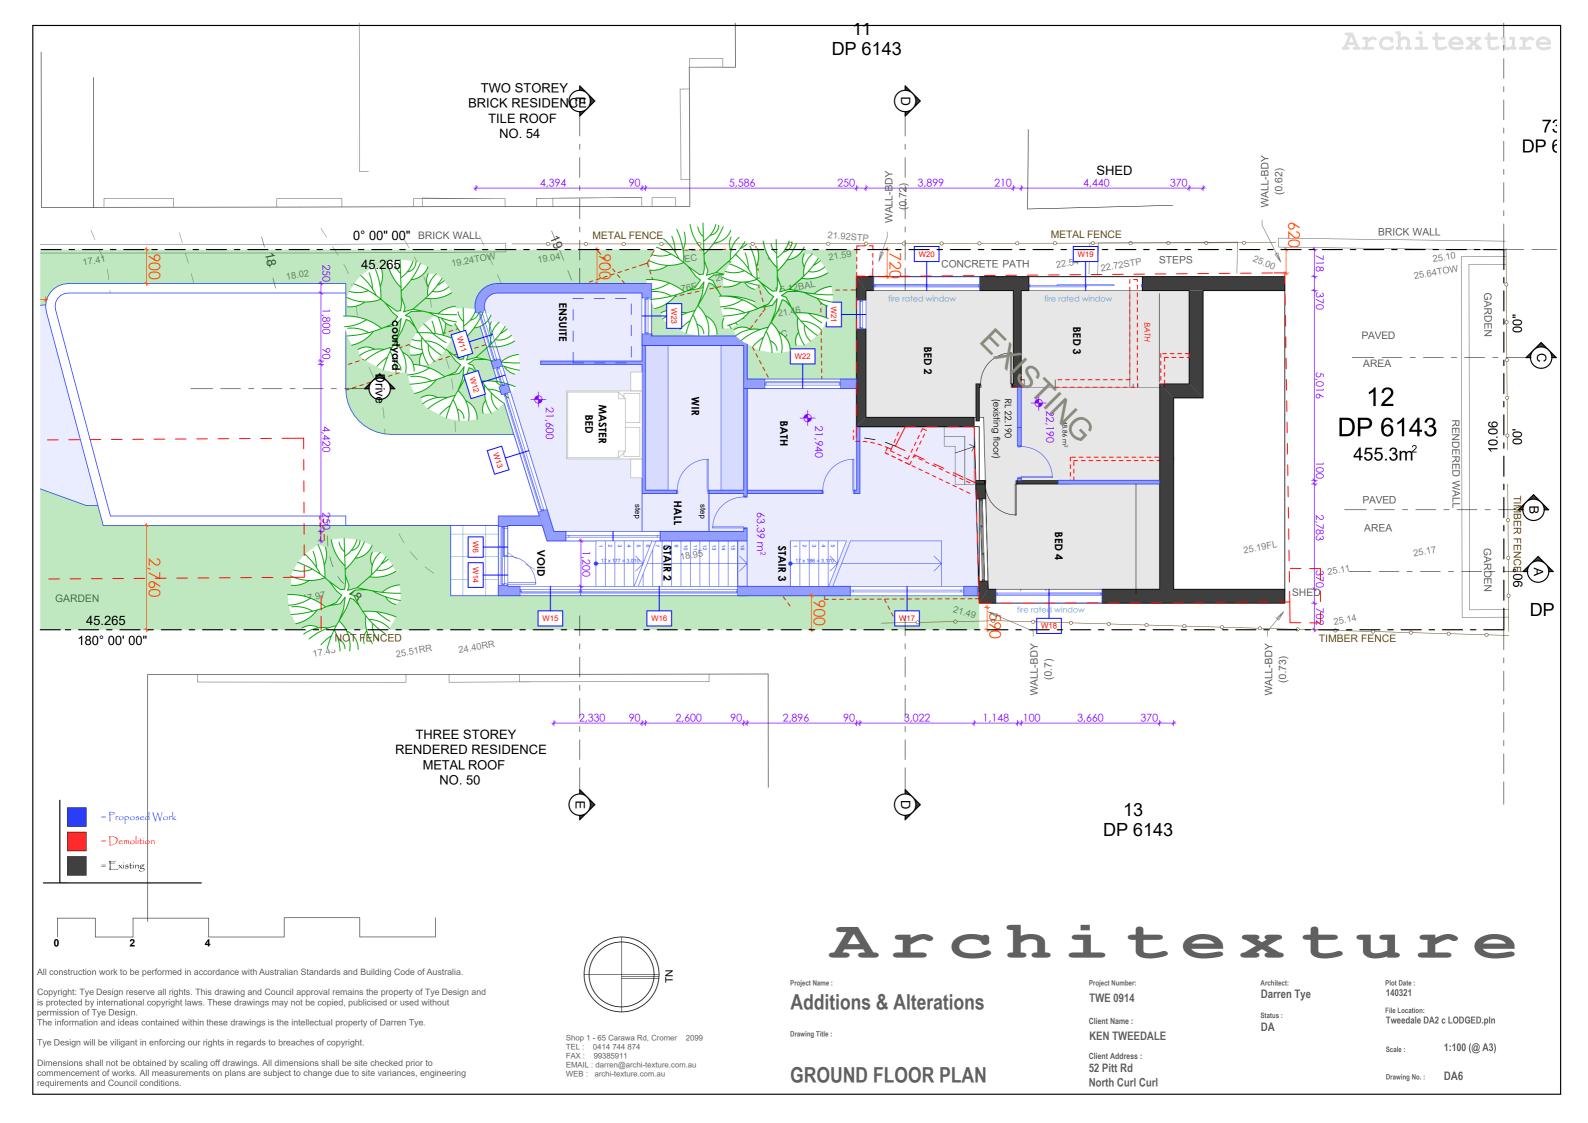

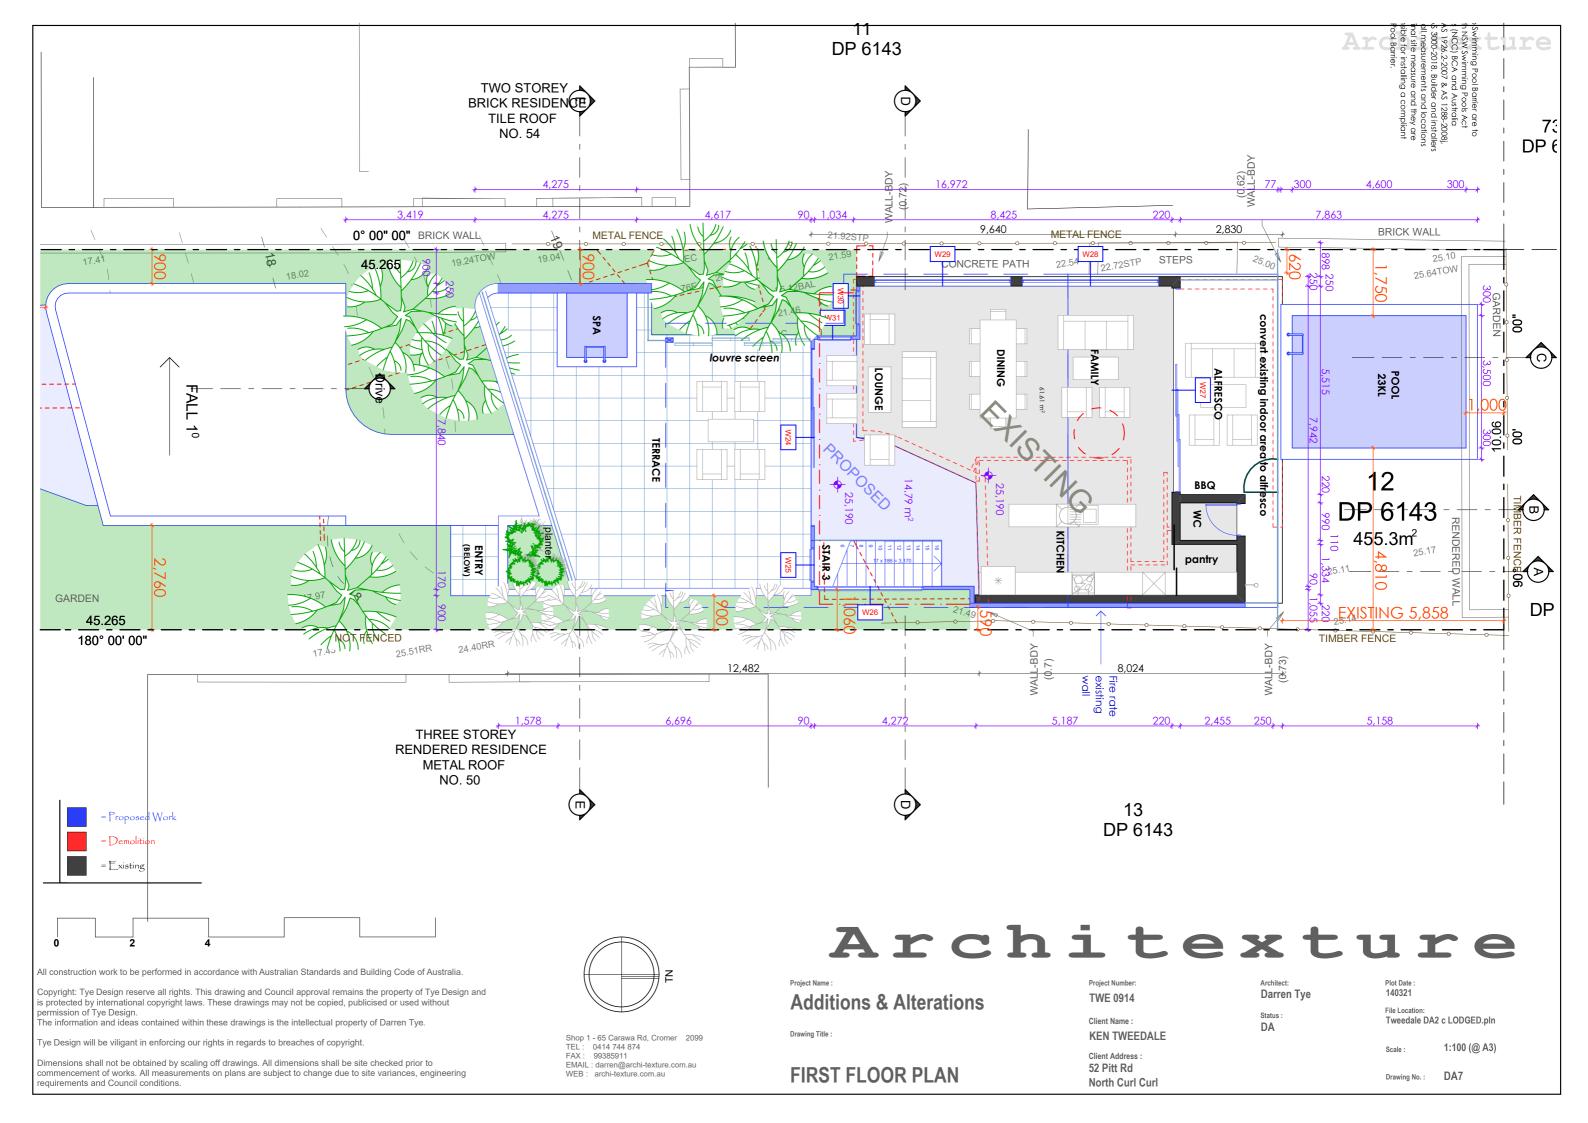

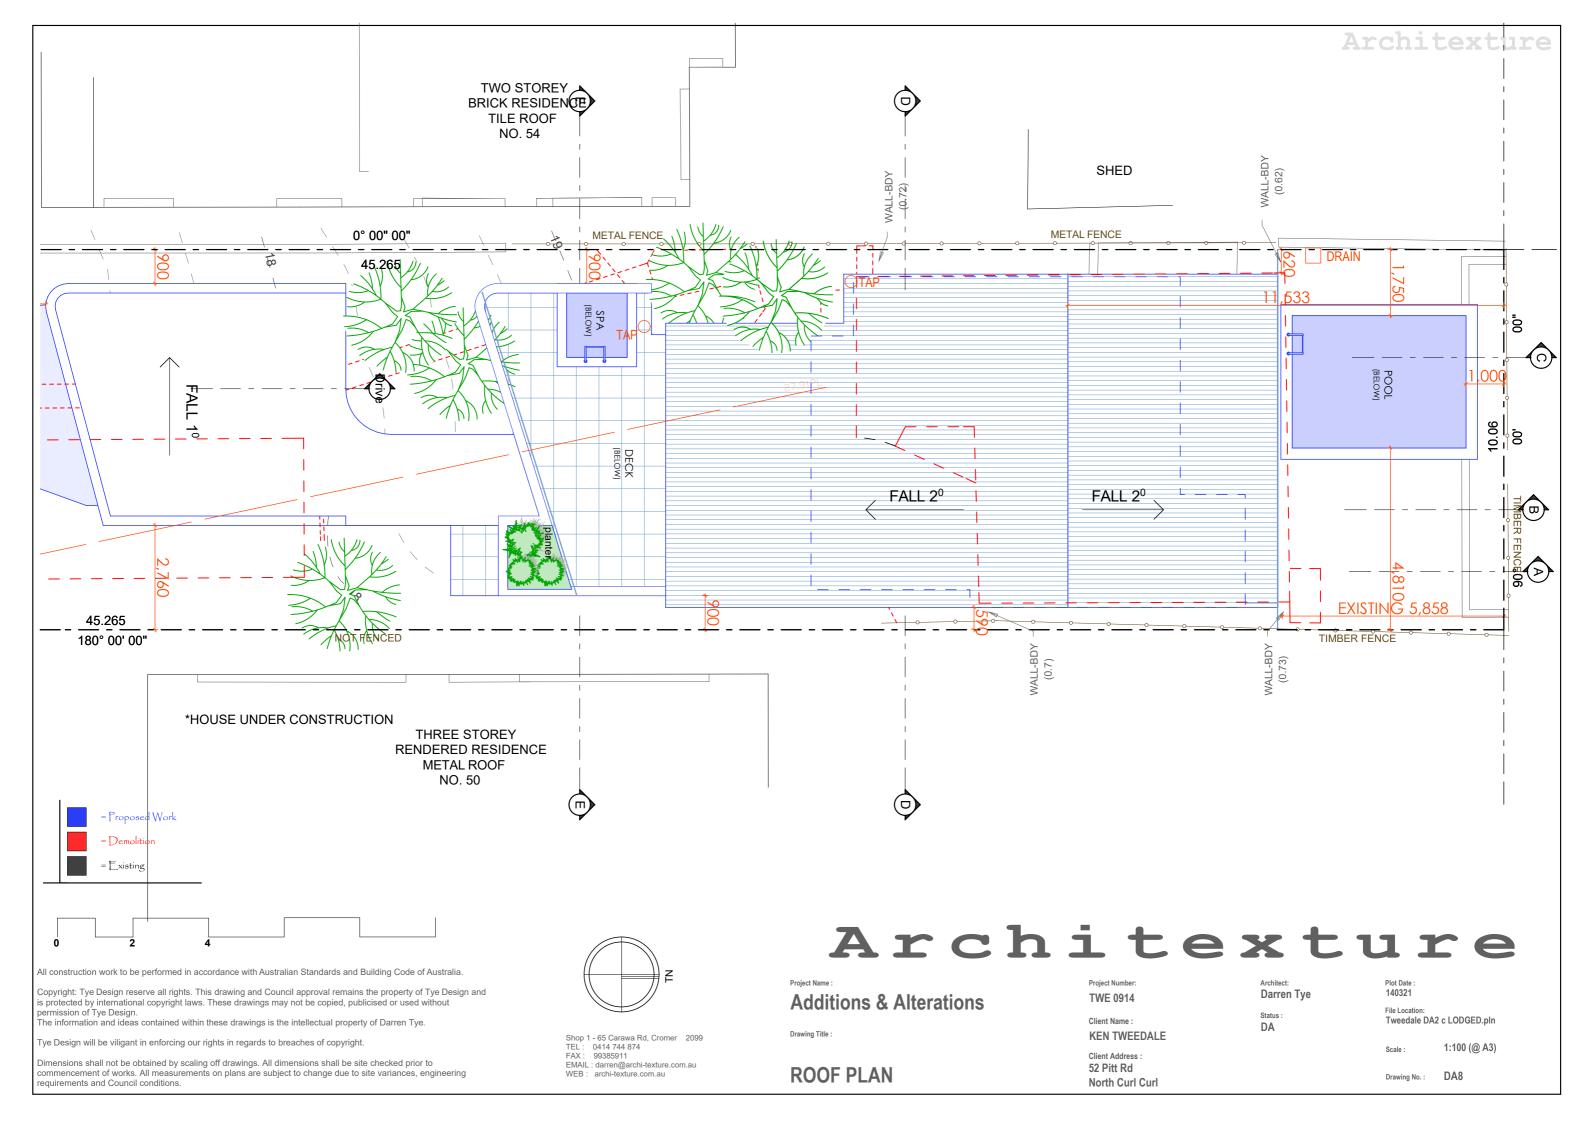

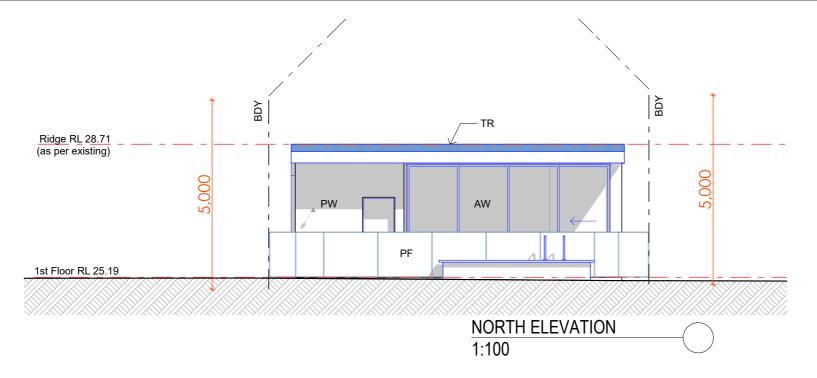

LEGEND

TR timber framed roof with Colorbond cladding

WB timber framed weatherboard wall


PW painted wall SW stone feature wall

AW aluminium window RA PF PS rail to BCA/NCC

pool fence and gate to AS1926 & BCA/NCC

privacy screen

Architexture

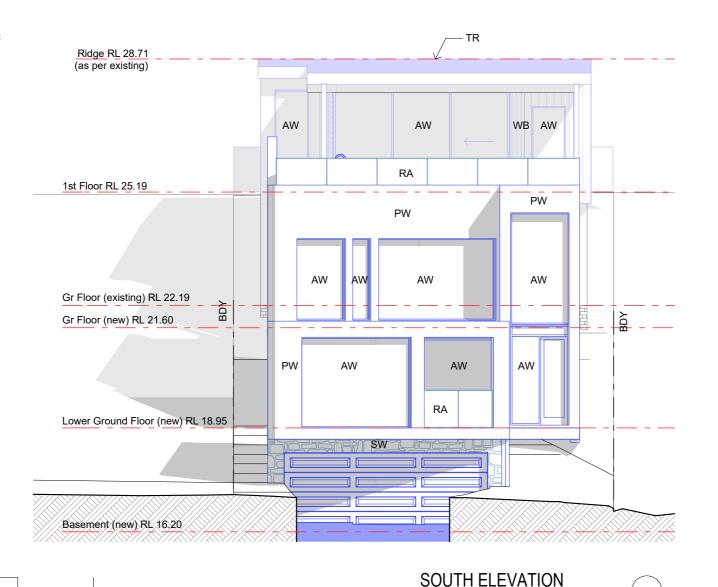

1:100

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EMAIL : darren@archi-texture.com.au WEB : archi-texture.com.au

Additions & Alterations

ELEVATIONS, N

Project Number: TWE 0914

Client Name : KEN TWEEDALE

Client Address 52 Pitt Rd

North Curl Curl


Darren Tye


DA


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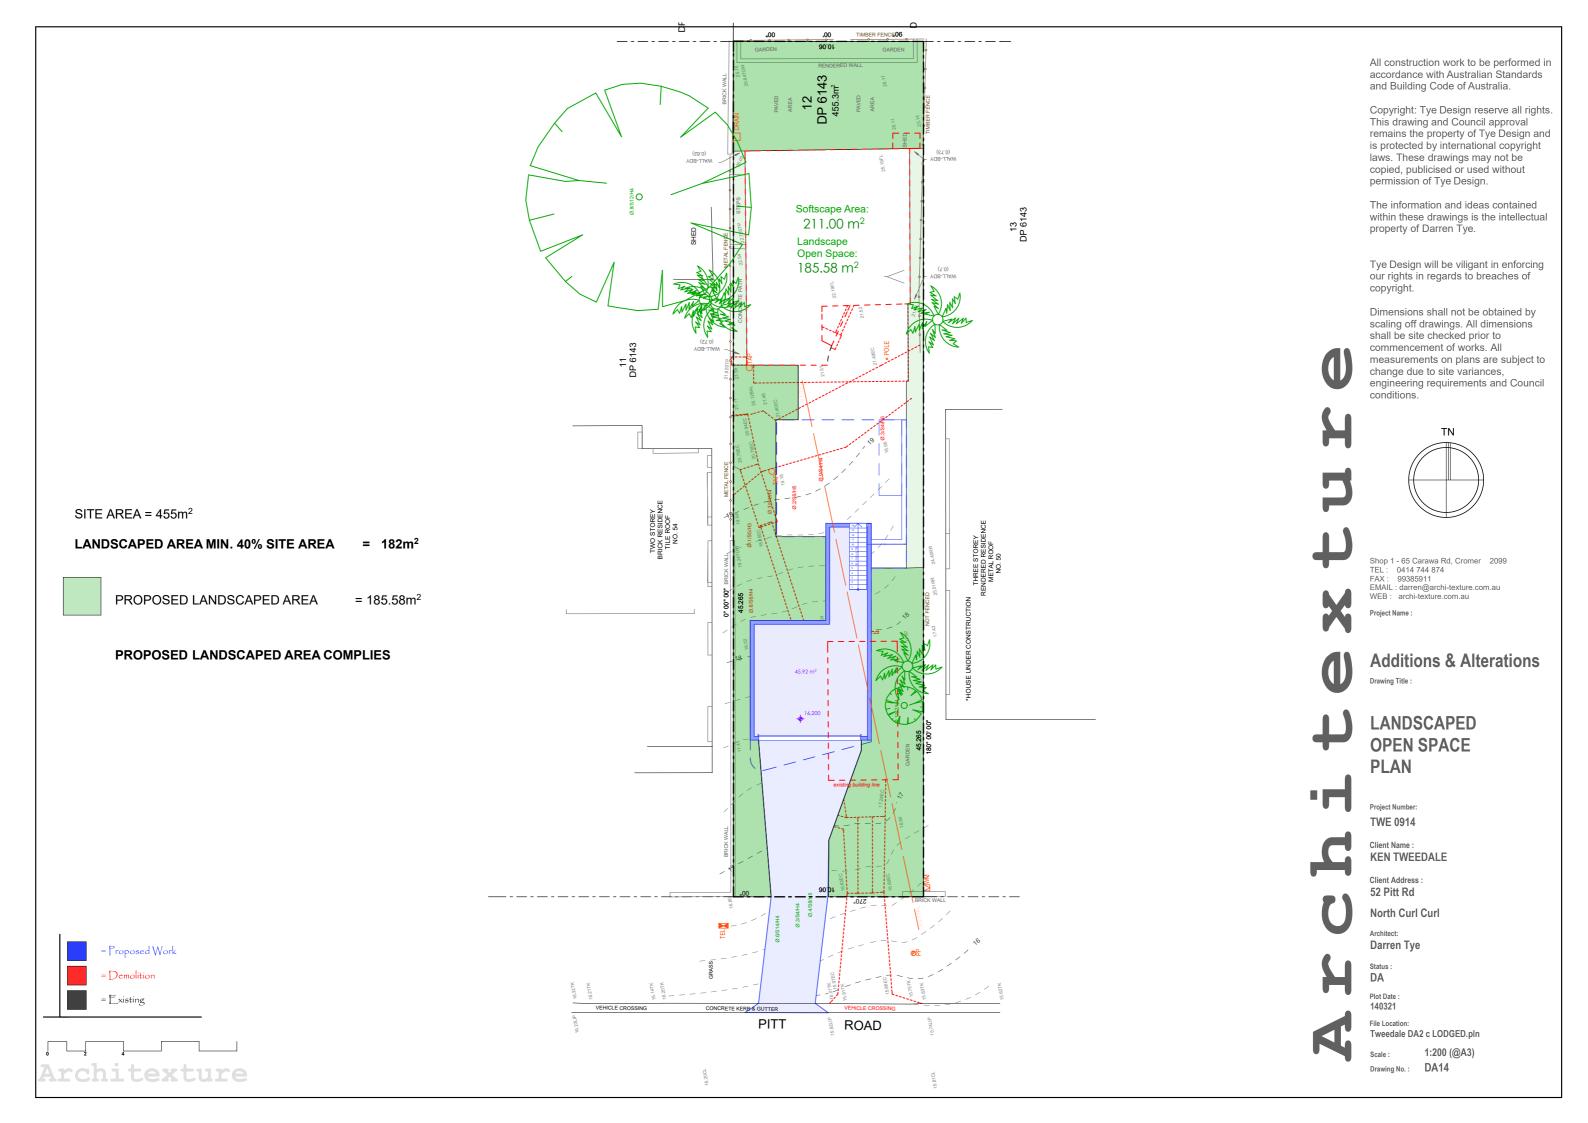
Tweedale DA2 c LODGED.pln


1:100 (@A3) Drawing No. : DA9



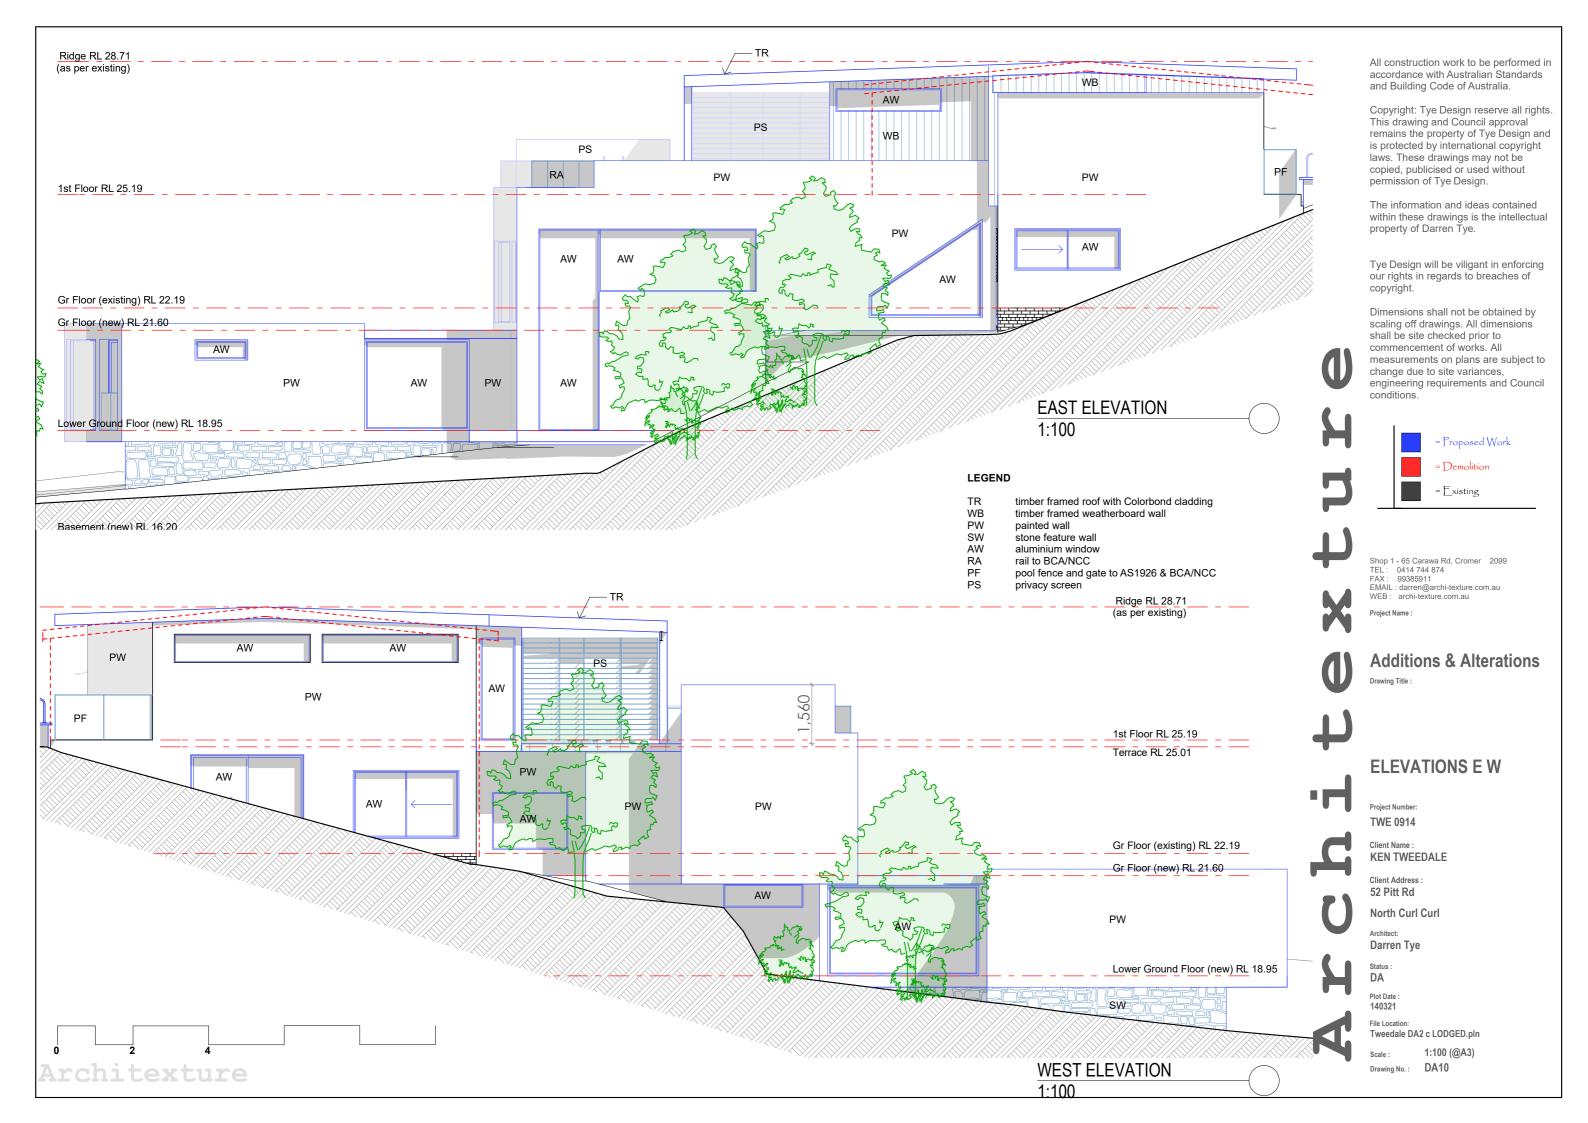

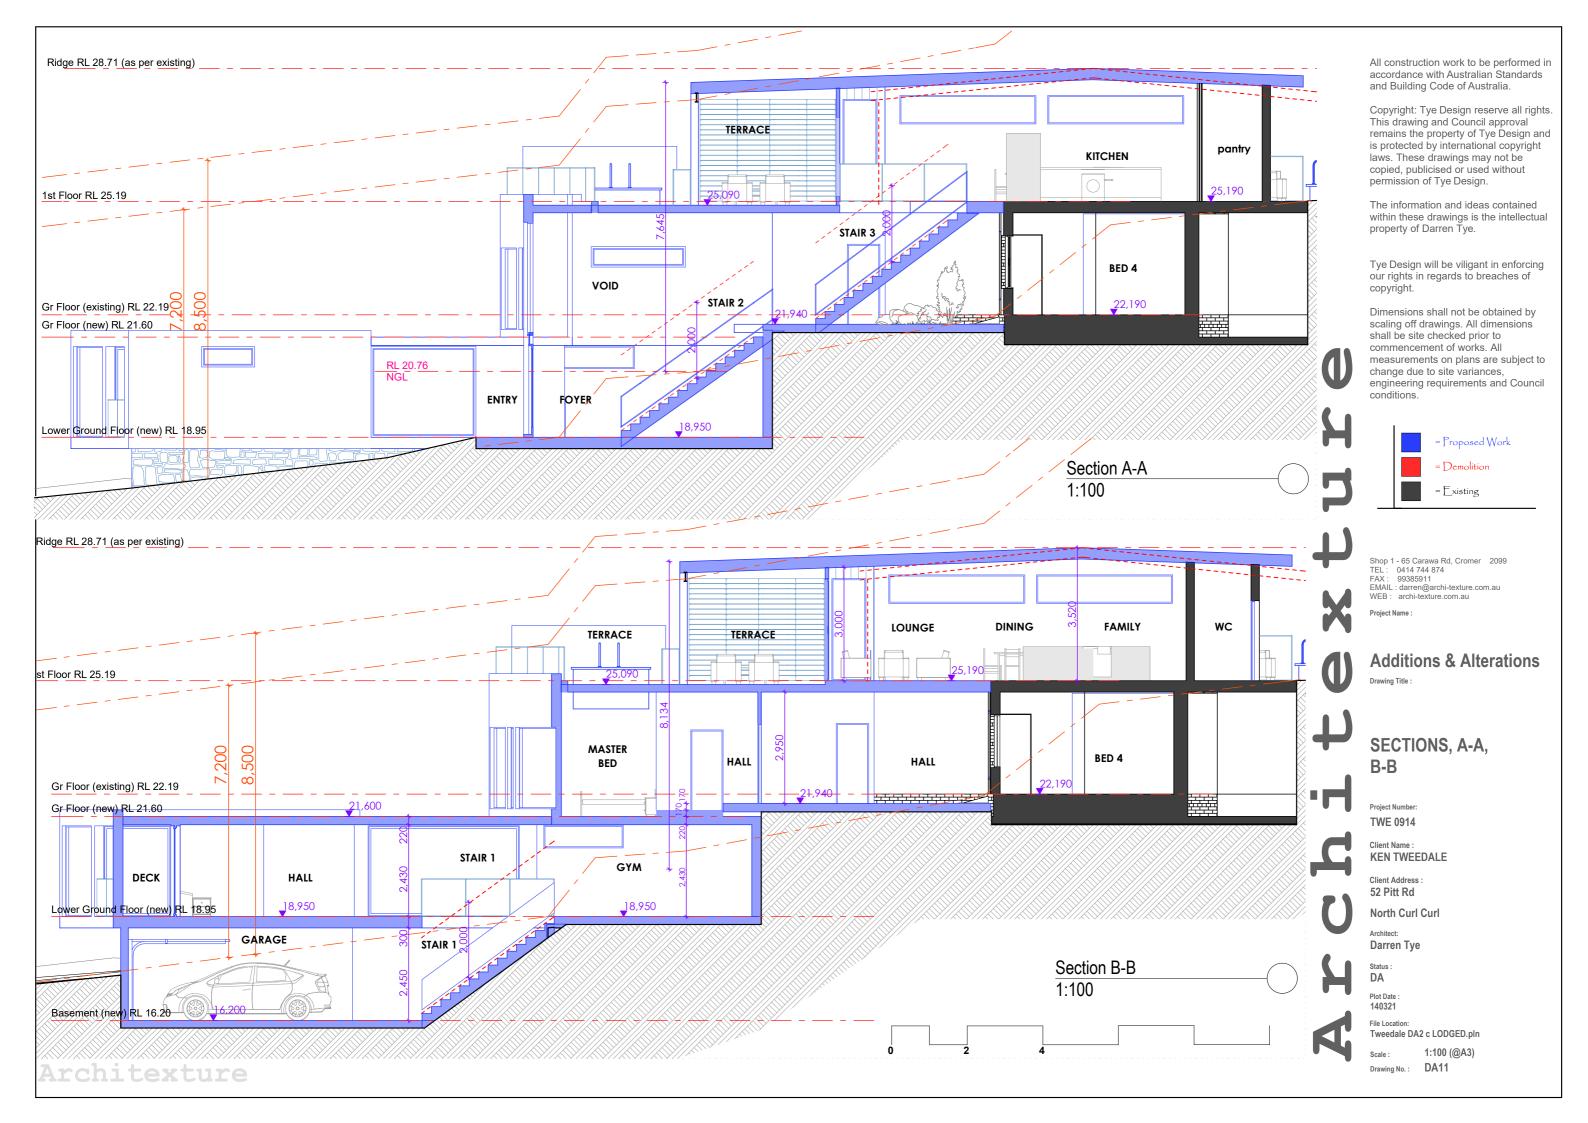

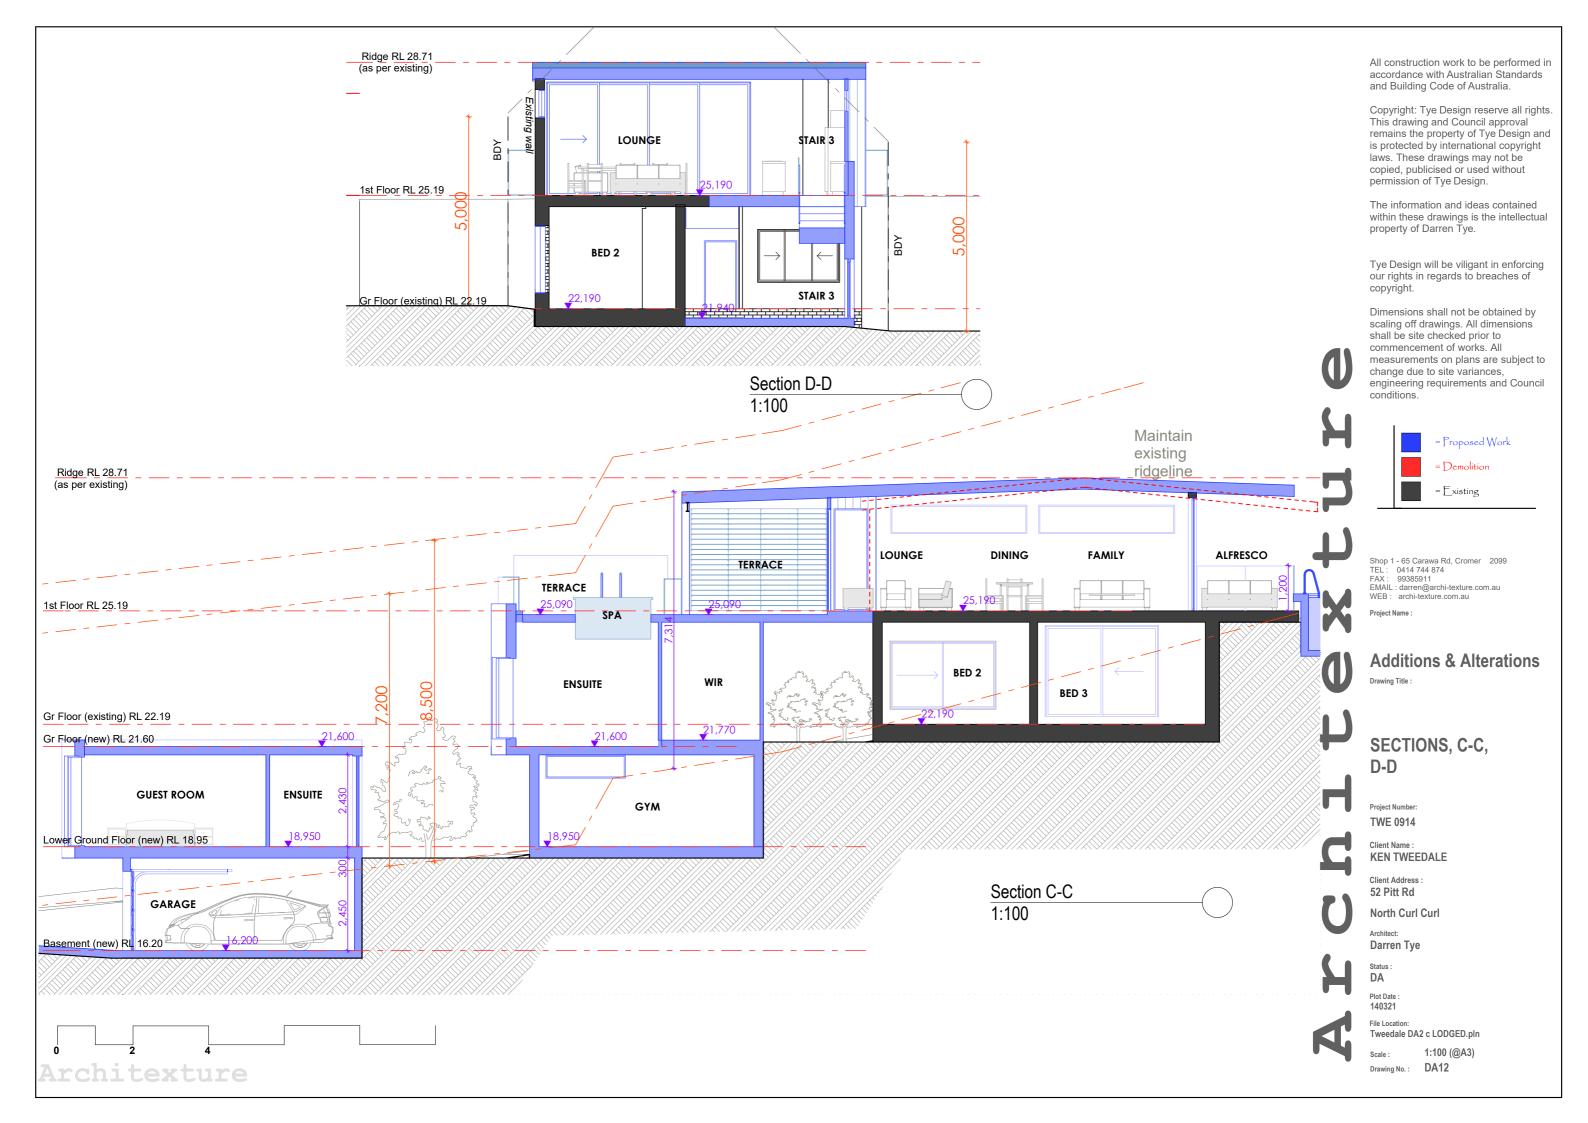

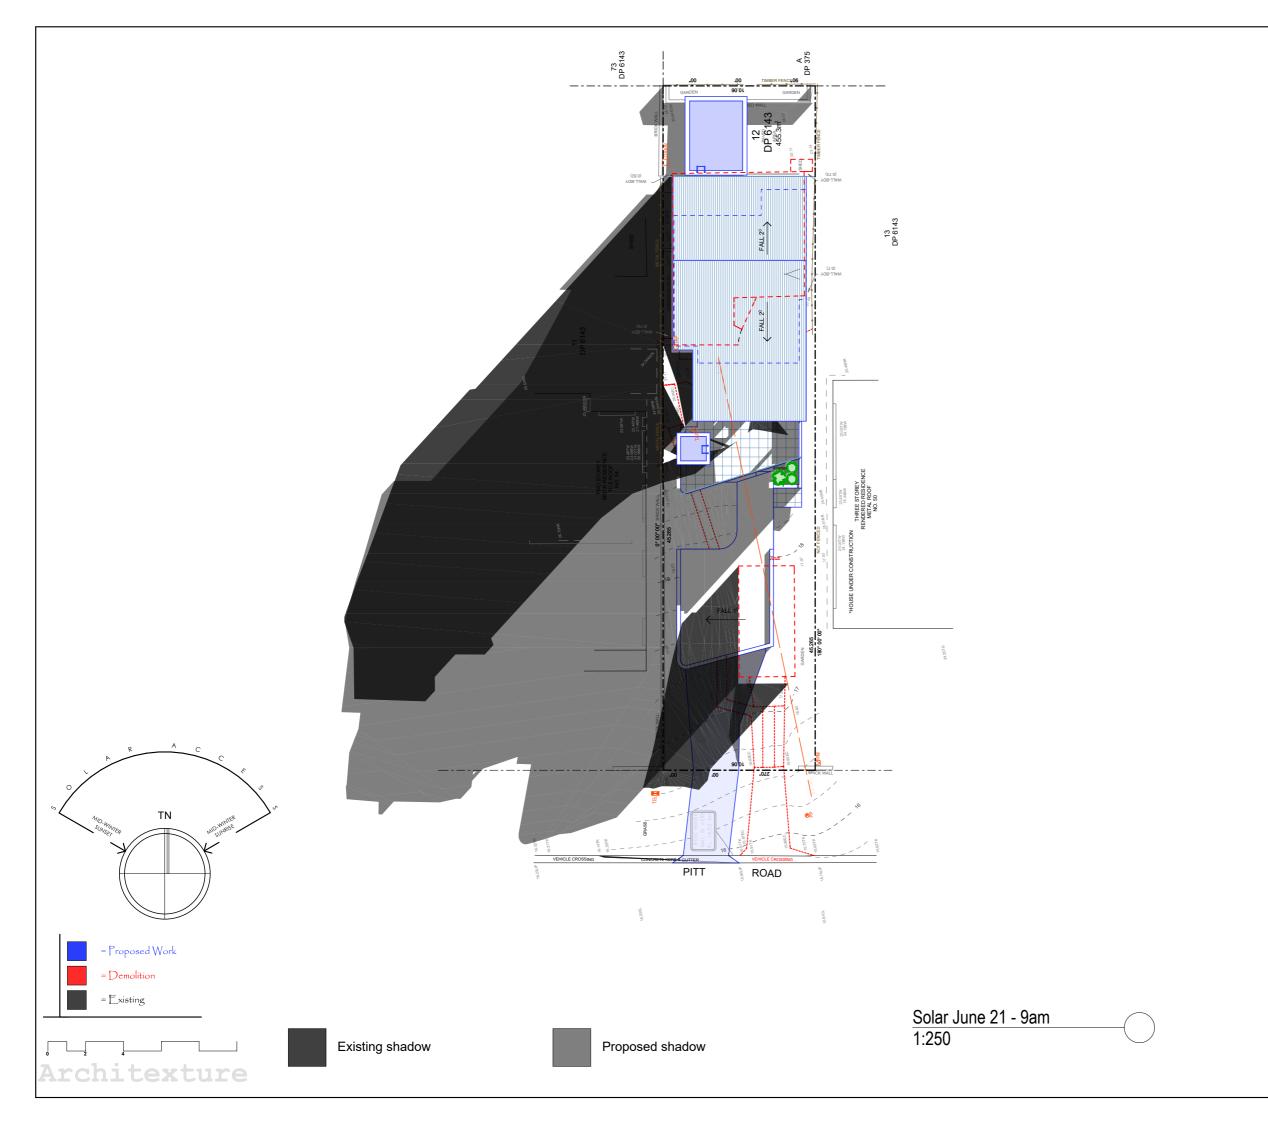

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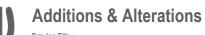
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SOLAR JUNE 21 -9am

Project Number:

TWE 0914

Client Name : KEN TWEEDALE

Client Address 52 Pitt Rd

North Curl Curl


Darren Tye

DA

File Location:

Tweedale DA2 c LODGED.pln

1:200 (@A3) Drawing No. : DA15

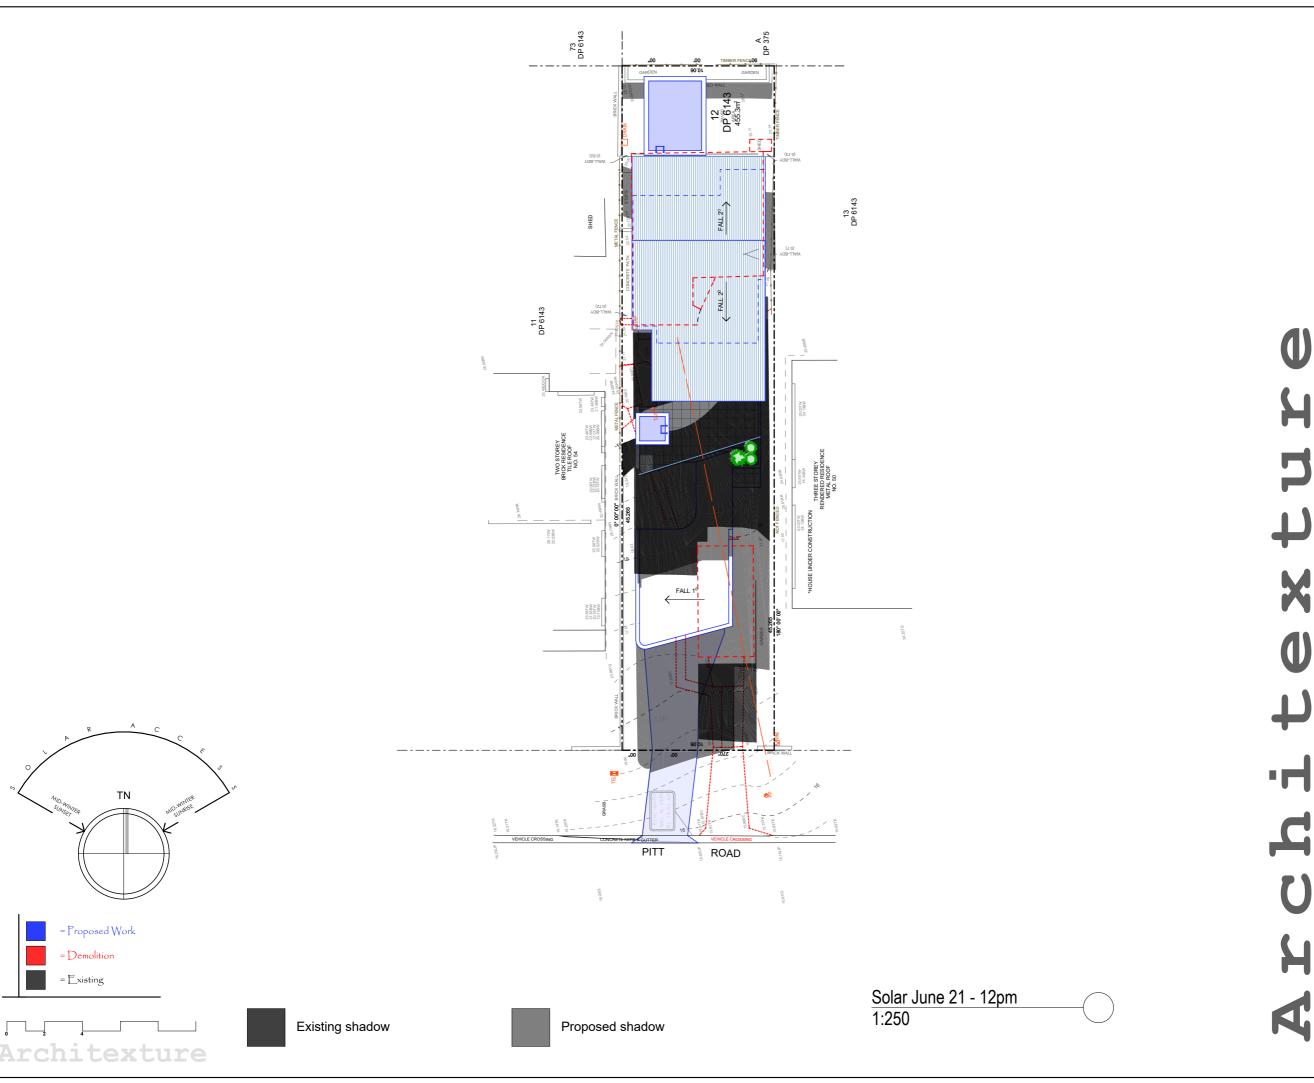


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SOLAR JUNE 21 -12pm

> Project Number: TWE 0914

Client Name : KEN TWEEDALE

Client Address 52 Pitt Rd

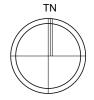
North Curl Curl

Darren Tye

DA

File Location: Tweedale DA2 c LODGED.pln

1:200 (@A3) Drawing No. : DA16

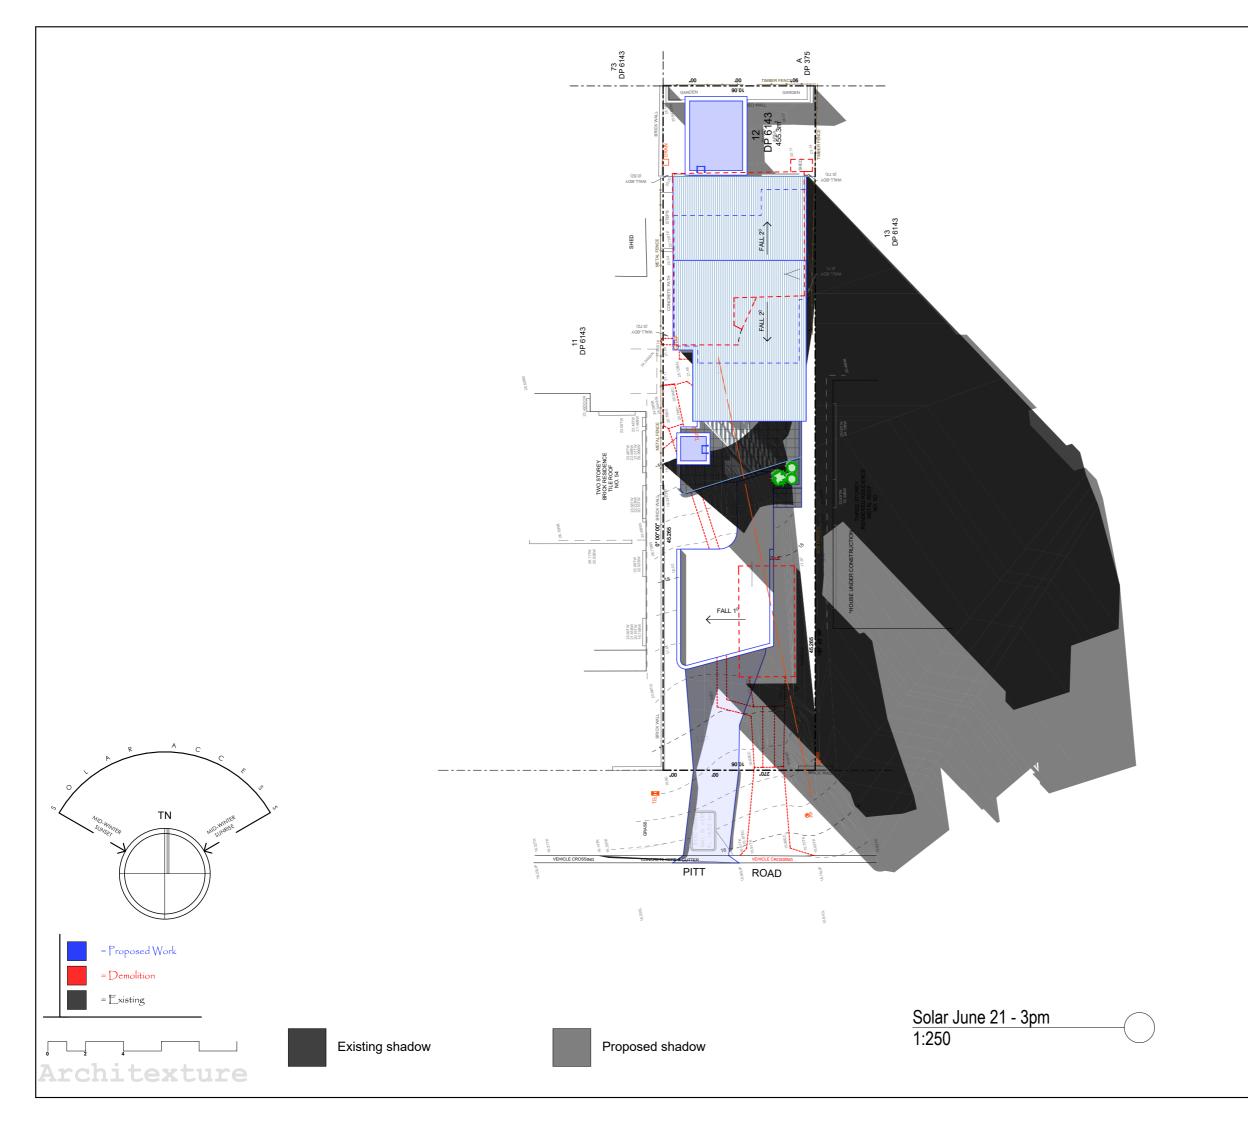

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Additions & Alterations

SOLAR JUNE 21 -3pm

Project Number: TWE 0914

Client Name : KEN TWEEDALE

Client Address 52 Pitt Rd


North Curl Curl

Darren Tye

DA

File Location: Tweedale DA2 c LODGED.pln

1:200 (@A3) Drawing No. : DA17

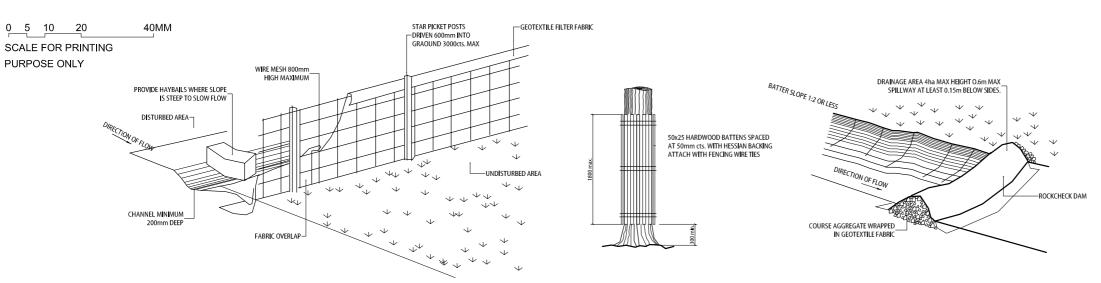

TYPICAL SEDIMENT FENCE

TYPICAL TREE PROTECTION

TYPICAL DIVERSION CHANNEL

Vehicle Movements

TO LIMIT DISTURBANCE TO THE SITE AND TRACKING OF MATERIAL ONTO THE STREET ALL VEHICLES AND PLANT EQUIPMENT ARE TO USE A SINGLE ENTRY/EXIT POINT UNLESS COUMCIL HAS APPROVED ALTERNATIVE

ACCESS POINTS AND APRKING AREAS ARE TO BE STABILISED WITH COMPACTED SUB-GRADE AS SOON AS POSSIBLE AFTER THEIR FORMATION WHERE SPILLAGE DOES OCCUR IT IS TO BE CONTAINED IMMEDIATELY AND CAREFULLY REMOVED. THE APEA ACCEPTED WAS A SECRETARY OF THE APEA ACCEPTED WAS A SECRETARY OF THE APEA ACCEPTED WAS A SECRETARY OF THE APEA ACCEPTED WAS A SEC

CAREFULLY REMOVED. THE AREA AFFECTED IS TO BE RESTORED TO A STANDARD EQUAL TO OR BETTER THAN ITS PREVIOUS CONDITION.

ALL VEHICLES ARE TO BE WASHED PRIOR TO EXISTING THE SITE.
THIS SERVES THE PURPOSE OF REMOVING SITE MATERIAL ON THE VEHICLE
AND PREVENTS I FROM BRING DEPOSITED ON THE BOAD NETWORK
ADJACENT TO THE SITE AND THUS, THE STORWATER SYSTEM, ALL POLLUTED
WATER MUST BE RETAINED ON SITE FOR TREATMENT BEFORE ITS DISCHARGED
INTO THE STORMWATER SYSTEM.

NO VEHICLE ASSOCIATED WITH THE WORK IS TO BE PARKED ON A FOOTPATH OR PUBLIC RESERVE.

ALL VEHILCES VISITING THE SITE DURING DEMOLITION, EXCAVATION AND/OR CONSTRUCTION WORKS, ARE TO COMPLY WITH THE PARKING REQUIREMENTS IN TAHT AREA.

Sediment Traps

WHERE A SEDIMENT FENCE IS NOT USED APPROPRIATE SEDIMENT TRAPS SHOULD BE LOCATED AT ALL POINTS WHERE STORMWATER LEAVES THE CONTSTRUCTION STIE OR LEAVES THE GUTTER AND ENTERS THE DRAIMAGE SYSTEM. A COMMON TECHNIQUE IS THE GRAVEL SAUSAGE.

Diversion Channels

A DIVERSION CHANNEL IS AN EXCAVATED EARTH DITCH OR PATH. THESE STRUCTURES AREE USED TO INTERCEPT AND DIRECT RUN-OFF TO A DESIRED LOCATION WHERE POSSIBLE.

ALL STORMWATER RUN-OFF FLOWING ONTO DISTURBED AREAS, INCLUDING ALL STORMWATER NUM-OFF FLOWING ON IO DISTURBED AREAS, INCLUSION STOCKPILES, MUST BE INTERCEPTED, DIVERTED AND/OR SAFELY DISPOSED OF. THIS CAN BE ACHIVED BY CONSTRUCTING A TEMPORARY EARTH BANK AROUND THE UPSLOPE EXTENT OF THE CONSTRUCTION STE WHEBETHE DIVERSION DOES NOT AFFECT THE NEIGHBOURING PROPERTIES.

Erosion & Sediment Controls

APPROPRIATE EROSION AND SEDIMENT CONTROLS MUST BE IMPLEMENTED ON ALL SITES THAT INVOLVE SOIL DISTURBANCE. THE MEASURES MUST BE IN PLACE PRIOR TO THE COMMENCEMENT OF WORK.

THOSE CONTROLS ARE TO BE MONITORED AND MAINTAINED IN ORDER TO SERVE THEIR INTENDED FUNCTION FOR THE DUBATION OF THEW WORKS OR DUTHIL SUCH THEM AS THE SITE IS EULILY STABLUSED. FAMY CONTROLS ARE DAMAGED OR SECOME MEFFECTIVE DURING THE COURSE OF THE WORKS THEY ARE TO BE REINSTATED OR REPLACED MIMEDIATELY. SUFFICIENT ACCESS TO THESE CONTROLS MUST BE PROVIDED IN CASE OF THE MED

Dust Control

ALL TRUCKS/UTES MUST COVER THEIR LOADS AT ALL TIMES.

APPROPRIATE METHODS ARE TO BE EMPLOYED TO PREVENT BLOWING DUST CREATING AN UNACCEPTABLE HAZARD OR NUISANCE ON THE SITE OR DOWN WIND. PRODUCTION OF DUST CAN BE MINIMISED BY LIMITING AREA OF EARTHWORKS, WATERING AND PROGRESSINE VEGETATION.

WHERE DUST IS CREATED AS A RESULT WORKS AND/OR SOIL EXPOSURE, THE BARE SOIL AREAS MUST BE WATERED, DURING AND/OR AT THE END OF EACH DAY TO LAY THE DUST.

EARTH MOVONG ACTIVITIES SHOULD BE AVOIDED WHERE WINDS ARE SUFFICIENTLY STRONG ENOUGH TO RAISE VISIBLE DUST.

Designated Site Manager/Builder

PRIOR TO COMMENCEMENT OF WORK A SITE MANAGER OR BUILDER MUST BE NOMINATED. THE SITE MANAGER OR BUILDER WILL BE RESPONSIBLE AND LIABLE FOR ALL WORKS CARRIED OUT ON THE SITE. RESPONSIBLE AND LIABLE FOR ALL WORKS CARRIED OUT ON THE SITE. THIS ASSUMES THE RESONSIBILITY FOR THE ACTIONS OF ALL SUBCONTRACTED PARTIES AS WELL AS ADVISING THEM OF COUNCIL'S REQUIREMENTS WHEN CARRYING OUT WORKS.

Topsoil Management

PRIOR TO THE STRIPPING OF TOPSOIL, THE VEGETATIVE COVER MUST BE REDUECED BY EITHER SLASHING OR MOWING.

ALL TOPSOIL IS TO BE RETAINED AND PROTECTED FOR REUSE ON SITE.

SOIL STOCKPILES MUST NOT BE LOCATED ON NATURE STRIPS, FOOTPATHS, ROADWAYS, KERBS, ACCESSWAYS, WITHIN DRAINAGE LINES/FLOWS/PATHS OR AROUND OR AGAINST TREE SHRIBS. SCEDIMENT CONTROL MEASURES MUST BE INCORPORATED WITH ANY RESULTING STOCKPILE. THE STOCKPILE CAN BE PROTECTED FROM BROSION BY COVERING IT WITH AN INFERVIOUS MATERIAL, IN CONJUNCTION WITH THE INSTALLATION OF A SEDIMENT FENCE AROUND IT.

IF STOCKPILES ARE TO REMAIN FOR MORE THAN ONE MONTH THEY ARE TO BE GRASSED IMMEDIATELY AND STABILISED WITHIN FOURTEEN D SURPLUS TOPSOIL MUST BE REASONABLY REMOVED FROM SITE.

Builidng Material Stockpiling

SUFFICIENT AREA MUST BE ALLOCATED WITHIN THE SITE FOR SUCH STORAGE OF BUILDING MATERIALS, DEMOLITION WASTE, WASTE CONTAINERS, ETC. AS WILL BE REQUIRED.

Sediment Fences

A SEDIMENT FENCE SHOULD BE LOCATED ALONG THE DOWNSLOPE BOUNDARY/SJOF THE STIE. ON THE CONSTRUCTION SIDE OF THE TURF FILTER STIPE ON NATIVE VEGETATION , AND AROUND ALL STOCKPILES OF MATERIAL ON THE STIE.

Architexture

All construction work to be performed in accordance with Australian Standards and Building Code of Australia

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EMAIL : darren@archi-texture.com.au

Additions & Alterations

SEIDMENT & EROSION CONTROL PLAN

Project Number: TWE 0914

52 Pitt Rd

Client Name: KEN TWEEDALE Client Address:

North Curl Curl

Darren Tye

DA

140321

Tweedale DA2 c LODGED.pln

1:100 (@ A3)

Drawing No.: DA18

page 1 / 10

BASIX Certificate Building Sustainability Index www.basix.nsw.gov.au

Alterations and Additions

Certificate number: A414587_02

This certificate confirms that the proposed development will meet the NSW government's requirements for sustainability, if it is built in accordance with the commitments set out below. Terms used in this certificate, or in the commitments, have the meaning given by the document entitled "BASIX Alterations and Additions Definitions" dated 06/10/2017 published by the Department. This document is available at www.basix.nsw.gov.au

Secretary
Date of issue: Sunday, 10, April 2022
To be valid, this certificate must be lodged within 3 months of the date of issue.



t	Project address	
Ū	Project name	Tweedale_02
Ö	Street address	52 pitt Road North Curl Curl 2099
ĭ	Local Government Area	Northern Beaches Council
0	Plan type and number	Deposited Plan 6143
4	Lot number	12
0	Section number	
	Project type	
ption	Dwelling type	Separate dwelling house
ri p	Type of alteration and addition	My renovation work is valued at \$50,000 or more, and includes a pool (and/or spa).
Ö		

Certificate Prepared by (please complete before submitting to Council or PCA)
Name / Company Name: Architexture
ABN (if applicable): 132171067

Pool and Spa			Show on DA Plans	Show on CC/CDC Plans & specs	Certifier Check
Rainwater tank					
The applicant must install a rainwater tank of a with, the requirements of all applicable regulator	t least 1771 litres on the site. This rainwater tank bry authorities.	must meet, and be installed in accordance	✓	✓	V
The applicant must configure the rainwater tan	k to collect rainwater runoff from at least 137 squ	uare metres of roof area.		✓	✓
The applicant must connect the rainwater tank	to a tap located within 10 metres of the edge of	the pool and outdoor spa.		✓	✓
Outdoor swimming pool			1		
The swimming pool must be outdoors.			V	✓	✓
The swimming pool must not have a capacity of	reater than 23 kilolitres.		✓	✓	✓
The swimming pool must have a pool cover.				✓	✓
The applicant must install a pool pump timer for	r the swimming pool.			✓	✓
The applicant must install the following heating	system for the swimming pool that is part of this	development: electric heat pump.		✓	✓
Outdoor spa					
The spa must not have a capacity greater than	4 kilolitres.		~	~	✓
The spa must have a spa cover.				✓	✓
The applicant must install a spa pump timer.				✓	✓
The applicant must install the following heating	system for the outdoor spa that is part of this de	evelopment: solar (gas boosted).		✓	✓
Fixtures and systems			Show on DA Plans	Show on CC/CDC Plans & specs	Certifier Check
Lighting					
• •	of new or altered light fixtures are fitted with fluo	rescent, compact fluorescent, or		✓	✓
Fixtures			1		
The applicant must ensure new or altered show	verheads have a flow rate no greater than 9 litre:	s per minute or a 3 star water rating.		✓	✓
The applicant must ensure new or altered toile	ts have a flow rate no greater than 4 litres per av	verage flush or a minimum 3 star water rating.		✓	✓
The applicant must ensure new or altered taps	have a flow rate no greater than 9 litres per min	ute or minimum 3 star water rating.		✓	
					I
Construction			Show on DA Plans	Show on CC/CDC Plans & specs	Certifier Check
Insulation requirements					
	d construction (floor(s), walls, and ceilings/roofs) tition is not required where the area of new const where insulation already exists.		✓	✓	~
Construction	Additional insulation required (R-value)	Other specifications			
concrete slab on ground floor.	nil				
suspended floor with enclosed subfloor: concrete (R0.6).	R0.70 (down) (or R1.30 including construction)				
suspended floor above garage: concrete (R0.6).	nil				
floor above existing dwelling or building.	nil				
external wall: cavity brick	nil				
external wall: external insulated façade system (EIFS)(façade panel: 70 mm)	nil				
external wall: brick veneer	R1.16 (or R1.70 including construction)				
external wall: concrete block/plasterboard	R1.18 (or R1.70 including construction)				
internal wall shared with garage: 200 mm AAC block (R1.31)	nil				
raked ceiling, pitched/skillion roof: framed	ceiling: R1.74 (up), roof: foil backed blanket (75 mm)	medium (solar absorptance 0.475 - 0.70)			
			1	1	1

ceiling: R2.08 (up), roof: foil backed blanket medium (solar absorptance 0.475 - 0.70) (55 mm)

BASIX Certificate number: A414587_02 page 6 / 10

Glazing red	quirements						Show on DA Plans	Show on CC/CDC Plans & specs	Certifier Check
Windows and glazed doors									
The applicant must install the windows, glazed doors and shading devices, in accordance with the specifications listed in the table below. Relevant overshadowing specifications must be satisfied for each window and glazed door.						✓	✓	~	
The following requirements must also be satisfied in relation to each window and glazed door:							~	V	
Each window or glazed door with improved frames, or pyrolytic low-e glass, or clear/lair gap/clear glazing, or toned/air gap/clear glazing must have a U-value and a Solar Heat Gain Coefficient (SHGC) no greater than that listed in the table below. Total system U-values and SHGCs must be calculated in accordance with National Fenestration Rating Council (NFRC) conditions. The description is provided for information only. Alternative systems with complying U-value and SHGC may be substituted.								✓	✓
For projection above the he	ns described in ad of the windo	millimetre w or glaz	es, the lea ed door a	ding edge of nd no more t	each eave, pergola, verandah, baldhan 2400 mm above the sill.	cony or awning must be no more than 500 mm	~	~	✓
	ns described as		ne ratio of	the projection	n from the wall to the height above	the window or glazed door sill must be at	✓	✓	✓
Pergolas with	n polycarbonate	roof or si	imilar tran	slucent mate	rial must have a shading coefficien	t of less than 0.35.		✓	✓
Pergolas with shades a per	n fixed battens r	nust have	battens p	parallel to the	window or glazed door above which is must not be more than 50 mm.	ch they are situated, unless the pergola also		~	✓
Overshadowi		vegetatio	n must be	of the heigh		the base of the window and glazed door, as	✓	✓	~
	and glazed o				nts		-		
	or Orientation		Oversha	dowing	Shading device	Frame and glass type			
		glass inc. frame	Height (m)	Distance (m)					
W1	S	(m2) 7.2	0	0	none	improved aluminium, single pyrolytic low-e,			
						(U-value: 4.48, SHGC: 0.46)			
W2	E	4.2	0	0	eave/verandah/pergola/balcony >=900 mm	improved aluminium, single pyrolytic low-e, (U-value: 4.48, SHGC: 0.46)			
W3	S	5.5	0	0	eave/verandah/pergola/balcony	improved aluminium, single pyrolytic low-e, (U-value: 4.48, SHGC: 0.46)			
W4	E	0.75	4	4.1	>=900 mm none	improved aluminium, single pyrolytic low-e,			
W5	E	6.5	6.5	4.1	none	(U-value: 4.48, SHGC: 0.46) improved aluminium, single pyrolytic low-e,			
						(U-value: 4.48, SHGC: 0.46)			
W6	S	4.1	0	0	none	improved aluminium, single pyrolytic low-e, (U-value: 4.48, SHGC: 0.46)			
W7	W	1.2	0	0	eave/verandah/pergola/balcony >=900 mm	improved aluminium, single pyrolytic low-e, (U-value: 4.48, SHGC: 0.46)			
W8	S	4.5	0	0	none	improved aluminium, single pyrolytic low-e, (U-value: 4.48, SHGC: 0.46)			
W9	w	9.6	6.5	5.8	none	improved aluminium, single pyrolytic low-e,			
W10	N	3.3	6.5	3.4	none	(U-value: 4.48, SHGC: 0.46) improved aluminium, single pyrolytic low-e,			
W11	S	2.9	0	0	none	(U-value: 4.48, SHGC: 0.46) improved aluminium, single pyrolytic low-e,			
						(U-value: 4.48, SHGC: 0.46)			
W12	S	1	0	0	none	improved aluminium, single pyrolytic low-e, (U-value: 4.48, SHGC: 0.46)			
W13	s	7	0	0	none	improved aluminium, single pyrolytic low-e, (U-value: 4.48, SHGC: 0.46)			
W14	S	4.6	0	0	none	improved aluminium, single pyrolytic low-e, (U-value: 4.48, SHGC: 0.46)			
W15	E	8.5	5.9	1.7	none	improved aluminium, single pyrolytic low-e,			
W16	E	6.9	2.8	1.7	none	(U-value: 4.48, SHGC: 0.46) improved aluminium, single pyrolytic low-e,			
	_					(U-value: 4.48, SHGC: 0.46)			
W17	E	4.8	0	0	projection/height above sill ratio >=0.23	improved aluminium, single pyrolytic low-e, (U-value: 4.48, SHGC: 0.46)			
W18	E	3	0	0	projection/height above sill ratio >=0.23	improved aluminium, single pyrolytic low-e, (U-value: 4.48, SHGC: 0.46)			
W19	W	7.2	3.5	1.8	none	improved aluminium, single pyrolytic low-e, (U-value: 4.48, SHGC: 0.46)			
W20	w	5	0	0	projection/height above sill ratio	improved aluminium, single pyrolytic low-e, (U-value: 4.48, SHGC: 0.46)			
W21	S	1.1	0	0	>=0.29 none	improved aluminium, single pyrolytic low-e,			
W22	w	3	0	0	projection/height above sill ratio	(U-value: 4.48, SHGC: 0.46) improved aluminium, single pyrolytic low-e,			
W23	N	2.5	6.5	3.5	>=0.29 none	(U-value: 4.48, SHGC: 0.46) improved aluminium, single pyrolytic low-e,			
						(U-value: 4.48, SHGC: 0.46)			
W24	S	12.7	0	0	eave/verandah/pergola/balcony >=900 mm	improved aluminium, single pyrolytic low-e, (U-value: 4.48, SHGC: 0.46)			
W25	S	1.9	0	0	eave/verandah/pergola/balcony >=900 mm	improved aluminium, single pyrolytic low-e, (U-value: 4.48, SHGC: 0.46)			
W26	E	1.6	0	0	projection/height above sill ratio >=0.23	improved aluminium, single pyrolytic low-e, (U-value: 4.48, SHGC: 0.46)			
W27	N	16.2	0	0	eave/verandah/pergola/balcony	improved aluminium, single pyrolytic low-e,			
W28	W	2.7	0	0	>=900 mm projection/height above sill ratio	(U-value: 4.48, SHGC: 0.46) improved aluminium, single pyrolytic low-e,			
W29	w	2.7	0	0	>=0.29 projection/height above sill ratio	(U-value: 4.48, SHGC: 0.46) improved aluminium, single pyrolytic low-e,			
					>=0.29	(U-value: 4.48, SHGC: 0.46)			
W30	S	2.4	0	0	none	improved aluminium, single pyrolytic low-e, (U-value: 4.48, SHGC: 0.46)			
W31	W	2.4	0	0	projection/height above sill ratio >=0.29	improved aluminium, single pyrolytic low-e, (U-value: 4.48, SHGC: 0.46)			
		1		1	,	1			

BASIX Certificate number: A414587 02

egend	
these commitments, "applicant" means the person carrying out the development.	
ommitments identified with a "\" in the "Show on DA plans" column must be shown on the plans accompanying the development application for the proposed development application is to be lodged for the proposed development).	ent (if a
ommitments identified with a "\" in the "Show on CC/CDC plans & specs" column must be shown in the plans and specifications accompanying the application for a contificate / complying development certificate for the proposed development.	nstruction
ommitments identified with a " " in the "Certifier check" column must be certified by a certifying authority as having been fulfilled, before a final occupation certificate for velopment may be issued.	the

All construction work to be performed in accordance with Australian Standards and Building Code of Australia.

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The information and ideas contained within these drawings is the intellectual property of Darren Tye.

Tye Design will be viligant in enforcing our rights in regards to breaches of copyright.

Dimensions shall not be obtained by scaling off drawings. All dimensions shall be site checked prior to commencement of works. All measurements on plans are subject to change due to site variances, engineering requirements and Council conditions.

Shop 1 - 65 Carawa Rd, Cromer 2099 TEL: 0414 744 874 FAX: 99385911 EMAIL: darren@archi-texture.com.au WEB: archi-texture.com.au

Project Name:

Additions & Alterations

Drawing Title :

BASIX CERTIFICATE

> Project Number: TWE 0914

Client Name :

KEN TWEEDALE Client Address

52 Pitt Rd North Curl Curl

Darren Tye


DA

File Location: Tweedale DA2 c LODGED.pln

1:100 (@A3) Scale: Drawing No. : DA19



flat ceiling, flat roof: framed

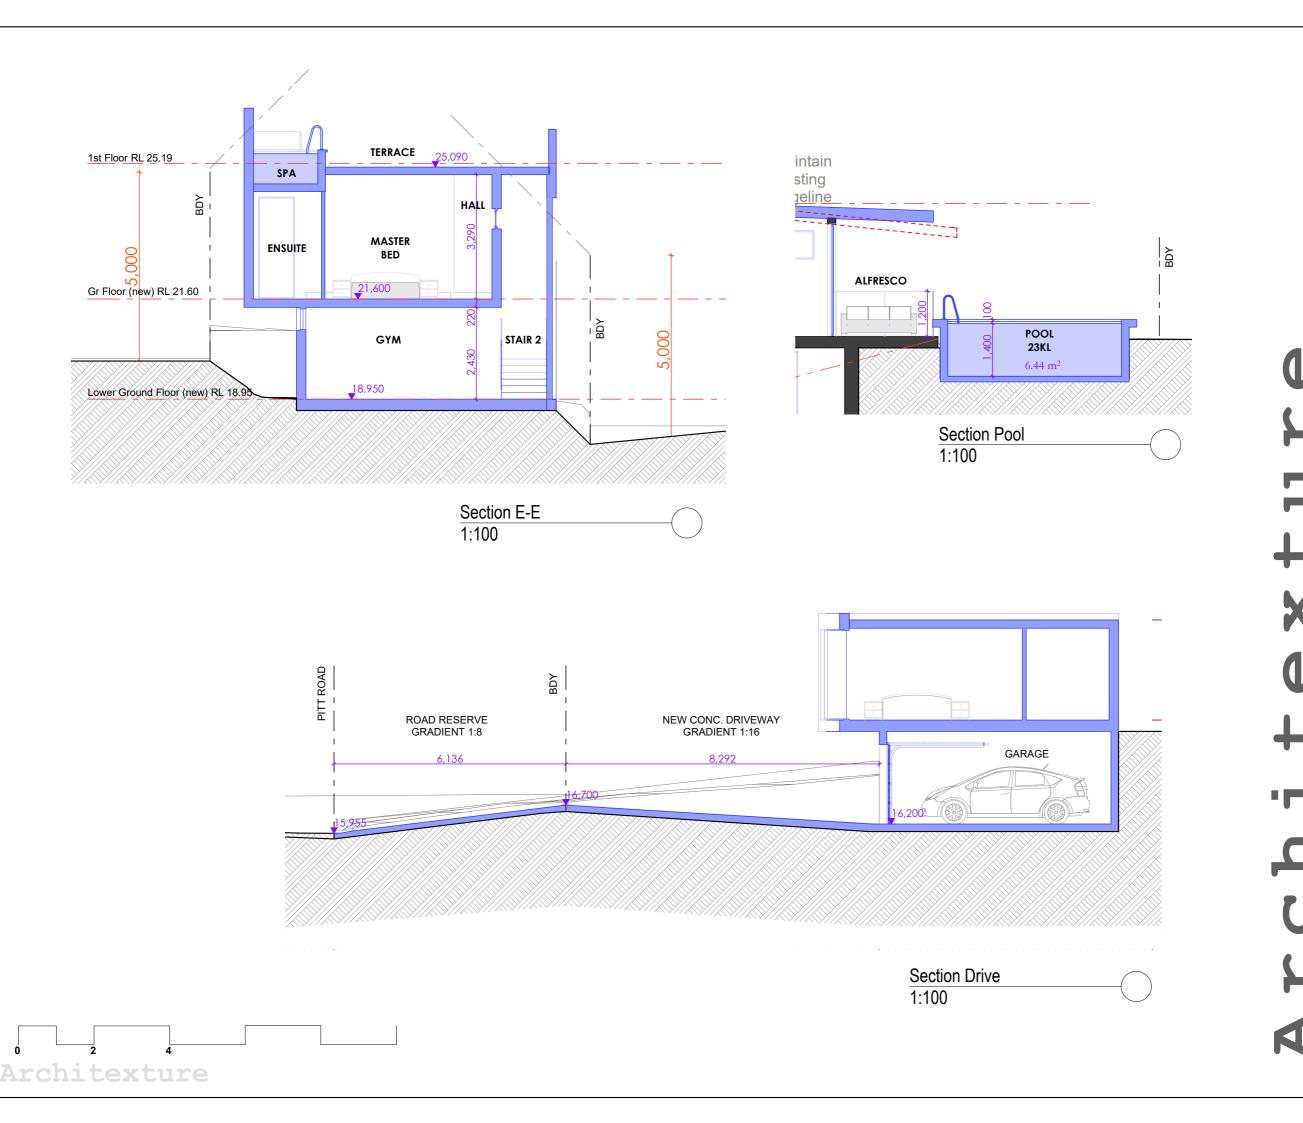

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SECTIONS, E-E, DRIVE

Project Number: TWE 0914

Client Name : KEN TWEEDALE

Client Address 52 Pitt Rd

North Curl Curl


Darren Tye

DA

File Location:

Tweedale DA2 c LODGED.pln 1:100 (@A3)

Drawing No. : DA13

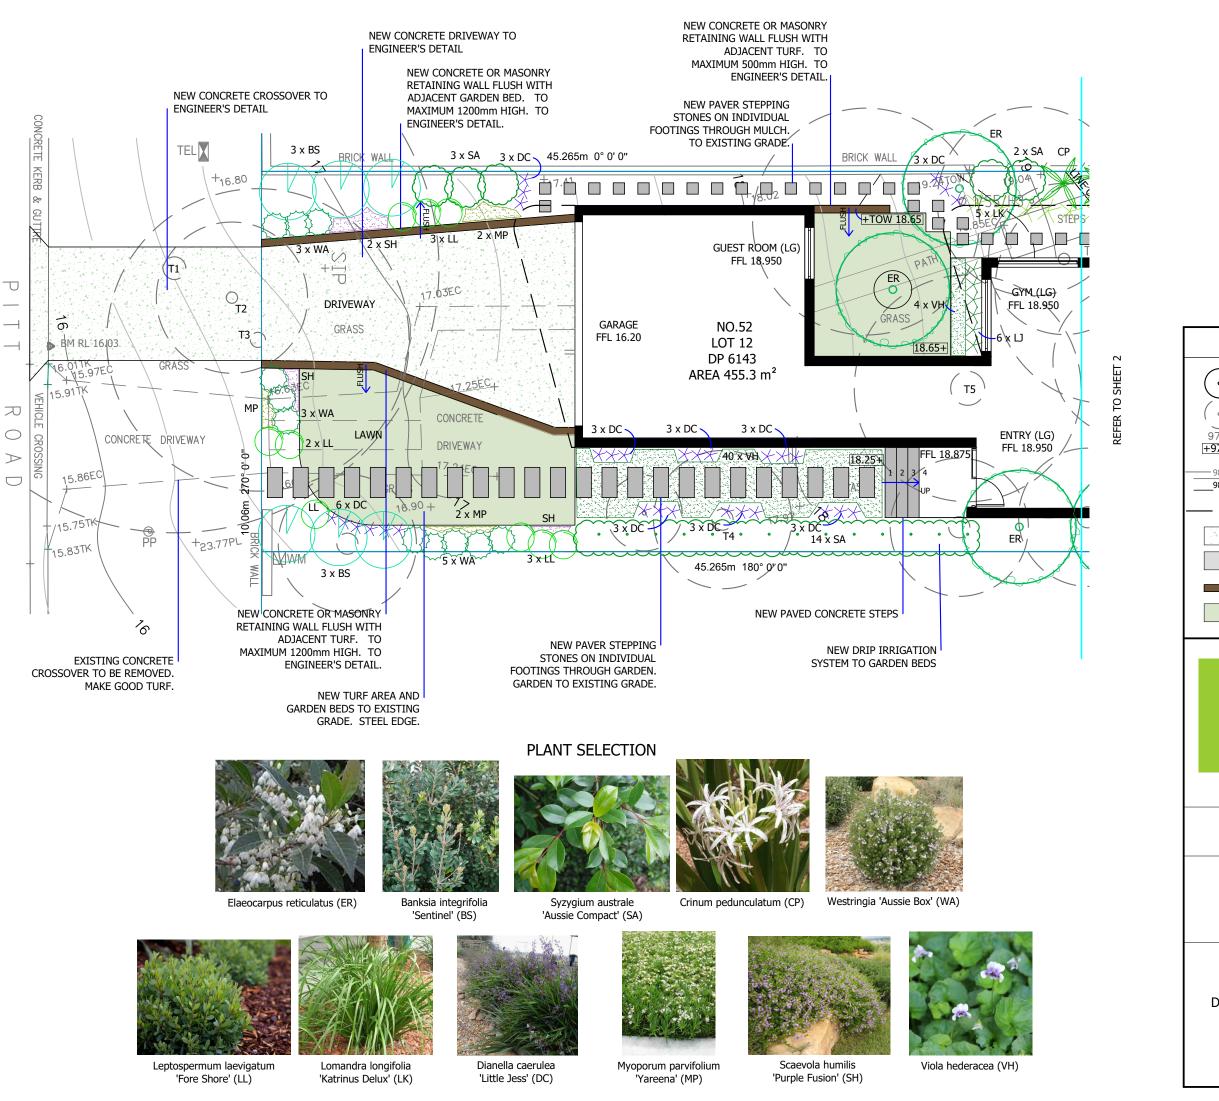





LCA Member No. F401

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LANDSCAPE PLAN

PROJECT: KEN TWEEDLE

52 PITT ROAD

NORTH CURL CURL NSW 2099

LOT 12 IN DP 6143

DRAWN BY: KERRIE POOK

DIP HORTICULTURE (LANDSCAPE DESIGN)


MEMBER AILDM

DRAWING NO: DA.01 (1 OF 4)

ISSUE: 2


DATE: 10/3/2021 SCALE: 1:100 @ A3

(1 OF 4) (21) (2) A3

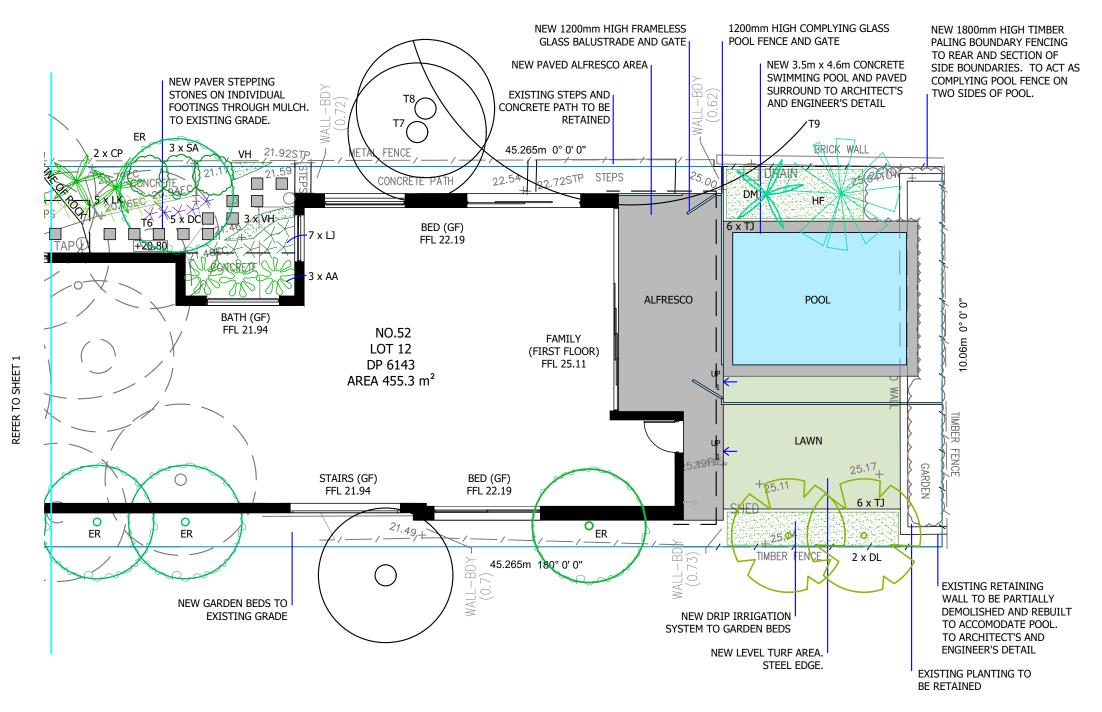

PLANT SELECTION



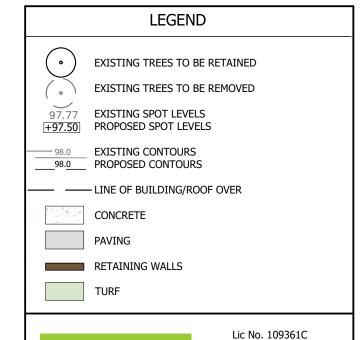



LCA Member No. F401

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LANDSCAPE PLAN

PROJECT: KEN TWEEDLE

52 PITT ROAD

NORTH CURL CURL NSW 2099

NORTH CORL CORL NOW 209

LOT 12 IN DP 6143

DRAWN BY: KERRIE POOK


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DRAWING NO: DA.02 (2 OF 4)

ISSUE: 2

DATE: 10/3/2021 SCALE: 1:100 @ A3



YMBOL	BOTANICAL NAME	COMMON NAME	SIZE AT MATURITY	QTY	POT SIZE	APPROX SPACING
	Howea fosteriana	Kentia Palm	5-15 x 5 m	1	300 mm	-
£-3	Dypsis lutescens	Golden Cane Palm	6 x 3 m	2	300 mm	2 m
\odot	Elaeocarpus reticulatus *	Blueberry Ash	8 x 3 m	7	400 mm	3 m
X	Dracaena marginata	Dracaena	4 x 2 m	1	300 mm	-
$\overline{\mathcal{V}}$	Banksia integrifolia 'Sentinel'	Banksia Sentinel	3 x 1.5 m	6	300 mm	1.2 m
	Syzygium australe 'Aussie Compact'	Aussie Compact Lilly Pilly	3 x 1 m / 2 m hedge	22	300 mm	750 mm
X	Crinum pedunculatum	Swamp Lily	1.5 x 1.5 m	3	200 mm	1.2 m
300	Asplenium australasicum	Bird's Nest Fern	1 x 1 m	3	200 mm	800 mm
4{^}	Westringia 'Aussie Box'	Aussie Box	0.7 x 0.7 m	11	200 mm	600 mm
$\widetilde{\bigcirc}$	Leptospermum laevigatum 'Fore Shore'	Fore Shore Tea Tree	0.5 x 0.75 m	9	200 mm	600 mm
× ×	Lomandra longifolia 'Katrinus Delux'	Mat Rush	0.7 x 0.7 m	10	140 mm	600 mm
X	Liriope muscari 'Just Right'	Lily Turf	0.5 x 0.5	13	140 mm	400 mm
c 🗡	Dianella caerulea 'Little Jess'	Little Jess Flax Lily	0.4 x 0.4 m	35	140 mm	300 mm
MP	Myoporum parvifolium 'Yareena'	Creeping Boobialla	groundcover	5	140 mm	as showr
SH	Scaevola humilis 'Purple Fusion'	Fan Flower	groundcover	4	140 mm	as show
ŢĴ	Trachelospermum jasminoides	Star Jasmine	groundcover	12	200 mm	as show
VH	Viola hederacea	Native Violet	groundcover	48	140 mm	as show

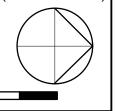
LANDSCAPE DESIGN STATEMENT

THIS SECTION OF PITT ROAD IS CHARACTERISED BY LANDSCAPED FRONT GARDENS. THE PROPOSED TURF AND PLANTINGS INTEGRATE WITH THE EXISTING STREETSCAPE. THE DESIGN ENHANCES THE VISUAL CHARACTER OF THE STREET

THE REAR GARDEN HAS BEEN DESIGNED AT EXISTING GROUND LEVEL. THE PROPOSED PLANTING FEATURES SCREEN PLANTING AT THE REAR AND SIDE BOUNDARIES. THESE MEASURES WILL MAINTAIN THE PRIVACY AND AMENITY OF NEIGHBOURING PROPERTIES.

	TREE SCHEDULE							
#	BOTANICAL NAME	APPR	OXIMATE DIMS	ACTION				
		DBH	HEIGHT	SPREAD				
T1	Banksia integrifolia	0.55	5	12	Remove and replace			
T2	Banksia integrifolia	0.12	6	4	Remove and replace			
T3	Melaleuca quinquenervia	0.3	7	7	Remove and replace			
T4	Howea fosteriana	0.13	6	3	Remove and replace			
T5	Melaleuca quinquenervia	0.32	8	6	Remove and replace			
T6	Archontophoenix cunninghamiana	0.2	9	3	Remove and replace			
T7	Archontophoenix cunninghamiana	0.14	8	3	Retain and protect			
Т8	Archontophoenix cunninghamiana	0.14	9	3	Retain and protect			
Т9	Melaleuca quinquenervia	0.45	9	10	Retain and protect			

NOTE: ALL OTHER TREES TO BE REMOVED ARE NOTED IN SECTION 2.1.3 OF THE ARBORICULTURAL IMPACT ASSESSMENT TO NOT BE LARGE ENOUGH TO BE COVERED BY THE LOCAL DCP AND TREE MANAGEMENT POLICY FOR NORTHERN BREACHES COUNCIL.

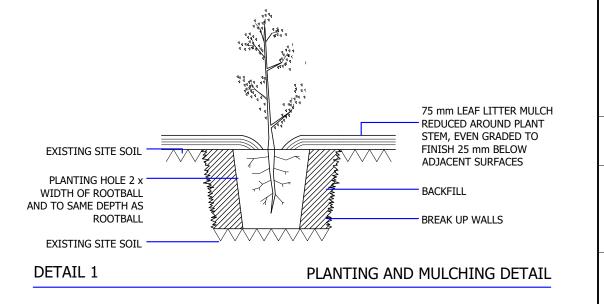

NOTES

PURPOS

- DRAWING ISSUED FOR DEVELOPMENT APPLICATION PURPOSES ONLY.
 SITE WORK
- 2. CONTRACTOR TO VERIFY MEASUREMENTS, LEVELS, SITE CONDITIONS AND LOCATION OF UNDERGROUND SERVICES PRIOR TO CONSTRUCTION.
- 3. ALL EXISTING TREES NOTED AS BEING RETAINED TO BE PROTECTED DURING CONSTRUCTION WORKS.
- ALL STRUCTURAL ELEMENTS TO ENGINEER'S DETAIL.
- 5. ALL CONSTRUCTION TO COMPLY WITH THE BUILDING CODE OF AUSTRALIA AND AUSTRALIAN STANDARDS.
- 6. AGRICULTURAL DRAINAGE LINES WITH FREE DRAINING AGGREGATE AROUND TO BE INSTALLED BEHIND PROPOSED RETAINING WALLS AND CONNECTED TO PROPOSED STORMWATER SYSTEM AS PER HYDRAULIC ENGINEER'S PLANS AND SPECIFICATIONS.
- ALL DRAINAGE AND FALLS TO HYDRAULIC ENGINEER'S PLANS AND DETAILS.
- 8. ALL SWIMMING POOL SAFETY BARRIERS TO COMPLY WITH NSW SWIMMING POOLS ACT, BCA REQUIREMENTS, AUSTRALIAN STANDARDS AND COUNCIL REQUIREMENTS. RELIANCES
- 9. DETAILED SURVEY INFORMATION AS PER PLAN SHOWING DETAILS AND LEVELS, DRAWING #172194-2, DATED 23/10/2017 PREPARED BY TSS TOTAL SURVEYING SOLUTIONS.
- 10. DETAILED ARCHITECTURAL INFORMATION AS PER GARAGE, LOWER GROUND, GROUND AND FIRST FLOOR PLANS, DRAWINGS DA4-7, PREPARED BY ARCHITEXTURE.
- 11. TREE IDENTIFICATION, HEIGHTS, SPREADS AND PROPOSED ACTION AS PER ARBORICULTURAL IMPACT ASSESSMENT, DATED 24/2/2022, PREPARED BY MICHAEL TODD OF ARBORLOGIX. SPREADS ARE DIAGRAMMATIC ONLY AND MAY NOT BE SYMMETRICAL.
- 12. DO NOT SCALE FROM DRAWINGS. USE FIGURED DIMENSIONS ONLY.



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LANDSCAPE PLAN

PROJECT: KEN TWEEDLE

52 PITT ROAD

NORTH CURL CURL NSW 2099

LOT 12 IN DP 6143

DRAWN BY: KERRIE POOK


DIP HORTICULTURE (LANDSCAPE DESIGN)

MEMBER AILDM

DRAWING NO: DA.03 (3 OF 4)

ISSUE: 2

DATE: 10/3/2021 SCALE: AS SHOWN

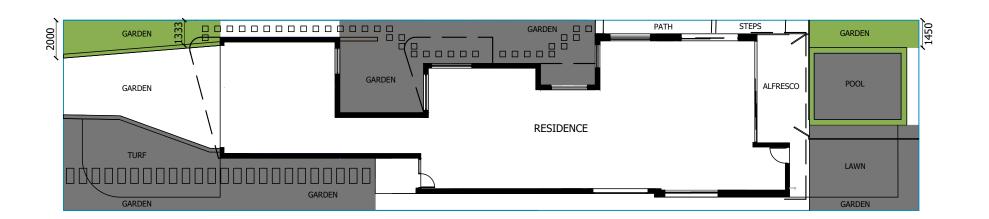

LANDSCAPED OPEN SPACE CALCULATIONS								
PROPOSED		REQUIRED	COMPLYING					
TOTAL SITE AREA	455.3 m²							
LANDSCAPED OPEN SPACE (LOS) BEHIND BUILDING LINE FORWARD OF BUILDING LINE TOTAL LOS	110.4 m ² 36.7 m ² 147.1 m ²							
AS % SITE AREA	32.3%	>=40%	NO					
OTHER SOFT LANDSCAPE AREA POOL COPING TOTAL LOS (SEE ABOVE) GRAND TOTAL	22.2 m ² 5.0 m ² 147.1 m ² 174.3 m ²							
AS % SITE AREA	38.3%							

LEGEND



LANDSCAPE OPEN SPACE

OTHER SOFT LANDSCAPE AREA & POOL COPING

NOTES

PURPOSE

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 SITE WORK
- 2. CONTRACTOR TO VERIFY MEASUREMENTS, LEVELS, SITE CONDITIONS AND LOCATION OF UNDERGROUND SERVICES PRIOR TO CONSTRUCTION.
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LANDSCAPE OPEN SPACE

PROJECT: KEN TWEEDLE

52 PITT ROAD

NORTH CURL CURL NSW 2099

LOT 12 IN DP 6143

DRAWN BY: KERRIE POOK

DIP HORTICULTURE (LANDSCAPE DESIGN)

MEMBER AILDM

DRAWING NO: DA.04 (4 OF 4)

ISSUE: 2

DATE: 10/3/2021

SCALE: 1:200 @ A3

