

SITE CRITERIA

No.19 MORESBY PLACE ALLAMBIE HEIGHTS N.S.W. 2100 19 D.P. 28394

SITE AREA EXISTING HARDSTAND EXISTING SOFT OPEN SPACE	=	313.8	sq, r sq, r sq, r	n.
PROPOSED DRIVEWAY AREA			sq, sq,	
PROPOSED GROUND FLOOR AREA PROPOSED GROUND FLOOR FRONT DECK AREA PROPOSED GROUND FLOOR REAR DECK AREA PROPOSED TOTAL FIRST FLOOR AREA	. = . =	23.6 29.2	sq, sq, sq,	m. m.
DWELLING ROOF AREA	. =	210.9	są,	m.
2 CAR PARKING SPACES PROVIDED IN GARAGE				
POST SOFT OPEN SPACE AREA = 380.1 sq. m. 60.7% POST HARDSTAND OPEN SPACE AREA = 54.0 sq. m. sq. m. POST TOTAL OPEN SPACE = 434.1 sq. m. sq. m. HARDSTAND POST DEVELOPEMENT = 191.7 sq. m. 39.3%				
REQUIRED OSD AREA = SITE AREA x 40% = 250.3 sq.m. POST OSD AREA (ROOF + IMPERVIOUS PERVIOUS) = 249.7 sq. m. 39.9%				



TO BE READ INCONJUCTION WITH THE BASIX CERTICATE NUMBER 1374624M

ROOF AREA TO TANK TO BE USED FOR TOILET FLUSHING, COLD WATER CLOTHS WASHING AND GARDEN CLOTHS WASHING AND GARDEN
TAPS SUPPLY (MINIMUM)______ NEW SHOWER HEAD MINIMUM RATING _ _ _ _ _ _ 3 STAR RATING NEW TOILET MINIMUM RATING _ _ _ _ _ _ _ 4 STAR RATING ALL NEW TAP FITTINGS MINIMUM RATING _ _ _ _ _ 4 STAR RATING GLAZING TO ALUMINIUM FRAMED WINDOWS AND TIMBER DOORS OR OTHERWISE NOTED ARE TO BE IN ACCORDANCE WITH THE NATHERS/BASIX REPORT ROOF COLOUR _ _ _ _ _ _ _ _ _ _ _ _ _ _ _ _ _ MEDIUM - SA < 0.40 < 0.60 FLOOR ABOVE ENCLOSED SUBFLOOR ____ _ R2.0 RATING FLOOR ABOVE GARAGE _____ N.A. ROOF SHEETING ON INSULATION _ _ _ _ _ RI.3 RATING EXTERNAL WALLS INSULATION _ _ _ _ _ R2.5 RATING INTERNAL WALLS INSULATION _ _ _ _ _ _ N.A. (GARAGE, LAUNDRY, POWDER ROOM \$ BATHROOM) CEILING INSULATION _____ R3.5 RATING (EXCLUDES GARAGE CEILING) INDIGENOUS OR LOW WATER USE SPECIES OF VEGETATION THRU-OUT 10 sq.m. OF THE SITE TO BE PLANTED REFER LANDSCAPE PLAN.

HOT WATER SERVICE TO BE ELECTRIC HEAT PUMP AIR SOURCED WITH A PERFORMANCE OF FEWER THAN 15STC's OR BETTER.

COOLING SYSTEM TO BE IN AT LEAST 1 LIVING AREA \$ 1 BEDROOM TO BE A 1-PHASE AIR CONDITIONING WITH AN ENERGY RATING OF EER 3.0-3.5 OR BETTER PLUS A CELING FAN TO BEDROOM ONLY. THE COOLING SYSTEM MUST MUST PROVIDE FOR DAY/NIGHT ZONING BETWEEN LIVING \$ BEDROOM AREAS.

HEATING SYSTEMM IN AT LEAST 1 LIVING AREA \$ 1 BEDROOM TO BE 1-PHASE AIR CONDITIONING WITH AN ENERGY RATING OF EER 3.0 - 3.5 OR BETTER.

FIXED OUTDOORS CLOTHES DRYING LINE TO BE INSTALLED

INDUCTION COOKER WITH ELECTRIC OVEN.

APPLICANT MUST ENSURE THAT THE "PRIMARY TYPE OF ARTIFICAL LIGHTING" IS FLUORESCENT OR LIGHT EMIITING DIODE (LED) LIGHTING IN EACH OF THE FOLLOWING ROOMS, AND WHERE THE "DEDICATED" APPEARS, THE FITTINGS FOR THOSE LIGHTS MUST ONLY BE CAPABLE OF ACCEPTING FLUORESCENT OR LIGHT EMITTING DIODE (LED) LAMPS:

- THE LAUNDRY, AT LEAST 5 OF THE BEDROOMS (DEDICATED)
- STUDY, 4 LIVING/DINING ROOMS (DEDICATED)
- ALL BATHROOMS/TOILETS, KITCHEN, HALLWAYS (DEDICATED)

NOTES:-

- 1. ALL GLAZING TO WINDOWS & DOORS SHALL BE IN ACCORDANCE WITH THE NATHERS REPORT.

 2. EXTERNAL WALL CLADDING SHALL BE SELECTED PLANK CLADDING WITH A SPECIFIED PAINTED COLOUR FINISH.

 3. AN APPROVED RATED INSULATION TO ALL EXTERNAL TIMBER FRAMED WALLS IN ACCORDANCE WITH THE BASIX REPORT.

 4. AN APPROVED RATED INSULATION MATERIAL TO BE PLACED IN THE CEILING SPACE WITHIN THE PERIMETER OF ALL EXTERNAL WALLS IN ACCORDANCE WITH THE BASIX REPORT.
- SHEETING THRU-OUT IN ACCORDANCE WITH THE BASIX REPORT.

 6. ROOF FINISHES TO BE IN ACCORDANCE WITH THE BASIX REPORT.
- EXTERNAL WALL FINISHES TO BE IN ACCORDANCE WITH THE BASIX REPORT.
- 8. ALL WINDOWS AND DOORS TO HAVE WEATHER STRIPPING.
 9. ALL WINDOWS & DOORS AS NOTED ON PLAN WITH SPECIFIED COLOUR FINISH.
- 10. ALL PAINTING TO OWNERS REQUIREMENTS.
- 11. ALL POWER OUTLETS & SWITCHES TO OWNERS REQUIREMENTS.
 12. ALL GLAZING TO CODE AS1288

- 13. ALL PEST TREATMENT TO CODE AS3660.1-2000
 14. SMOKE ALARM DENOTED SA ON PLAN TO BCA 3.7.2 \$ AS3786
 15. ALL WATERPROOFING TO WET AREAS TO CODE AS3740

- 16. ALL TIMBER FRAMING TO CODE AS1684
 17. ALL WORK CARRIED OUT TO BE IN ACCORDANCE WITH THE BCA

GENERAL NOTES AND BCA / NCC COMPLIANCE

- EARTHWORKS METHOD OF EXCAVATION AND FILL TO COMPLY WITH PART 3.1.1. B.C.A. TERMITE RISK MANAGEMENT TO COMLPY WITH PART 3.1.3 OF THE B.C.A. AND AS3660-1 FOOTINGS AND SLABS TO COMPLT WITH PART 3.2 OF THE B.C.A. , AS2870
- AND ENGINEERS DETAILS
- MASONARY CONSTRUCTION TO COMPLY WITH PART 3.3 OF THE B.C.A. AND AS3700
- TIMBER FRAMING TO COMPLY WITH PART 3.4 OF THE B.C.A. AND ASI684
 GLAZING TO COMPLY WITH PART 3.6 OF THE B.C.A. AND ASI684
 GLAZING TO COMPLY WITH PART 3.7.2 OF THE B.C.A. AND ASI3786
 STAIR CONSTRUCTION TO COMPLY WITH PART 3.7.1 OF THE B.C.A.

- BALISTRADES AND OTHER BARRIERS TO COMPLY WITH PART 3.9.2 OF THE B.C.A.

- BALISTRADES AND OTHER BARRIERS TO COMPLY WITH PART 3.9.2 OF THE B.C.A.
 NATURAL LIGHT TO COMPLY WITH PART 3.8.4 OF THE B.C.A.
 VENTILATION TO COMPLY WITH PART 3.8.5 OF THE B.C.A.
 ALL DAMP AND WEATHERPROOFING TO COMPLY WITH PART 3.8 OF THE B.C.A.
 ROOFING TO COMPLY WITH PART 3.5.1 OF THE B.C.A. AND AS/NZI562
 FLOOR SURFACES OF WATER CLOSETS, SHOWER COMPARTMENTS AND THE A LIKE TO BE OF MATERIALS IMPERVIOUS TO MOISTURE AND WALLS FINISHED WITH AN APPROVED IMPERVIOUS FINISH TO COMPLY WITH THE REQUIREMENTS OF
- CLOTHS WASHING, DRYING AND COOKING FACILITIES TO BE PROVIDED TO COMPLY WITH PART 3.8.3 OF THE B.C.A.



OFFICE - 39 GAVENLOCK ROAD TUGGERAH 2259 P.O. BOX 5240 CHITTAWAY BAY N.S.W. 2261 Tel: (02) 4352 1189 Fax: (02) 4352 1198

Builders Lic. 158741C ABN 65 687 862 151 © This drawing and design remains the property of CLASSIC COUNTRY COTTAGES and may not be copied in whole or in part without prior approval of CLASSIC COUNTRY COTTAGES

PROJECT

PROPOSED NEW DWELLING 19 MORESBY PLACE **ALLAMBIE HEIGHTS**

FOR


Mr. R. & Mrs. L. MERRY


DATE DEC. 2022 SCALE 1:200


JOB No

DWG. No 01



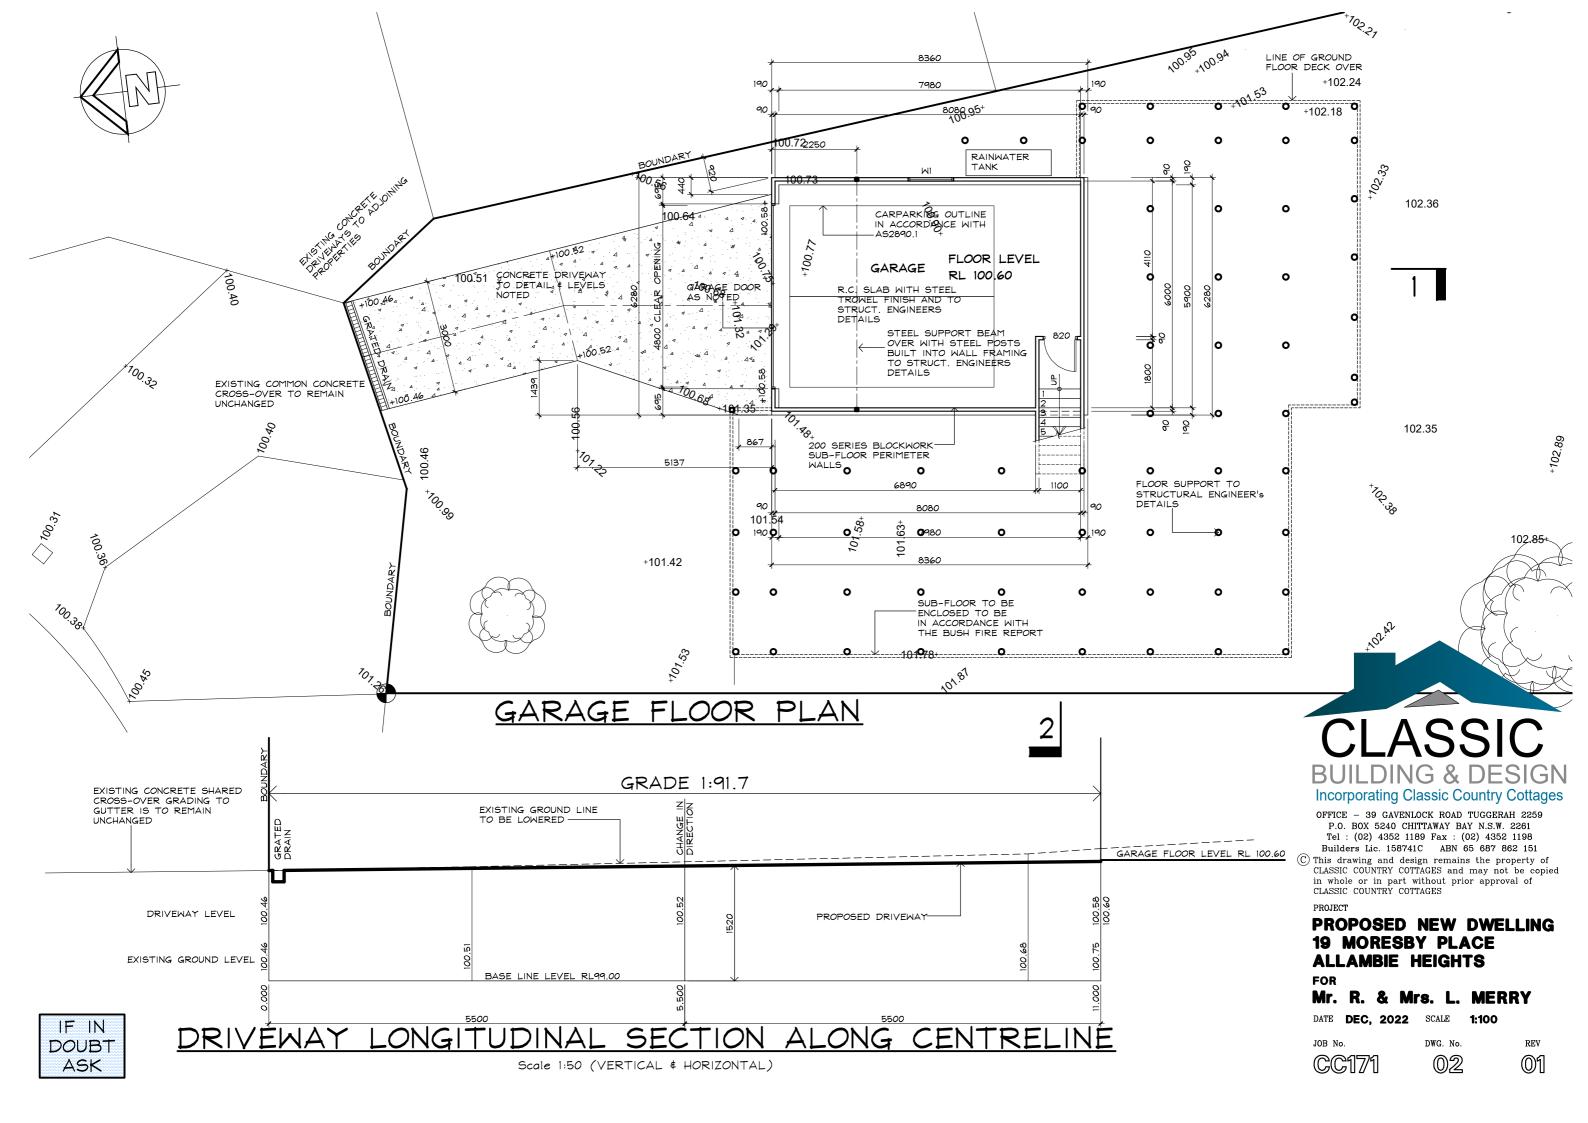

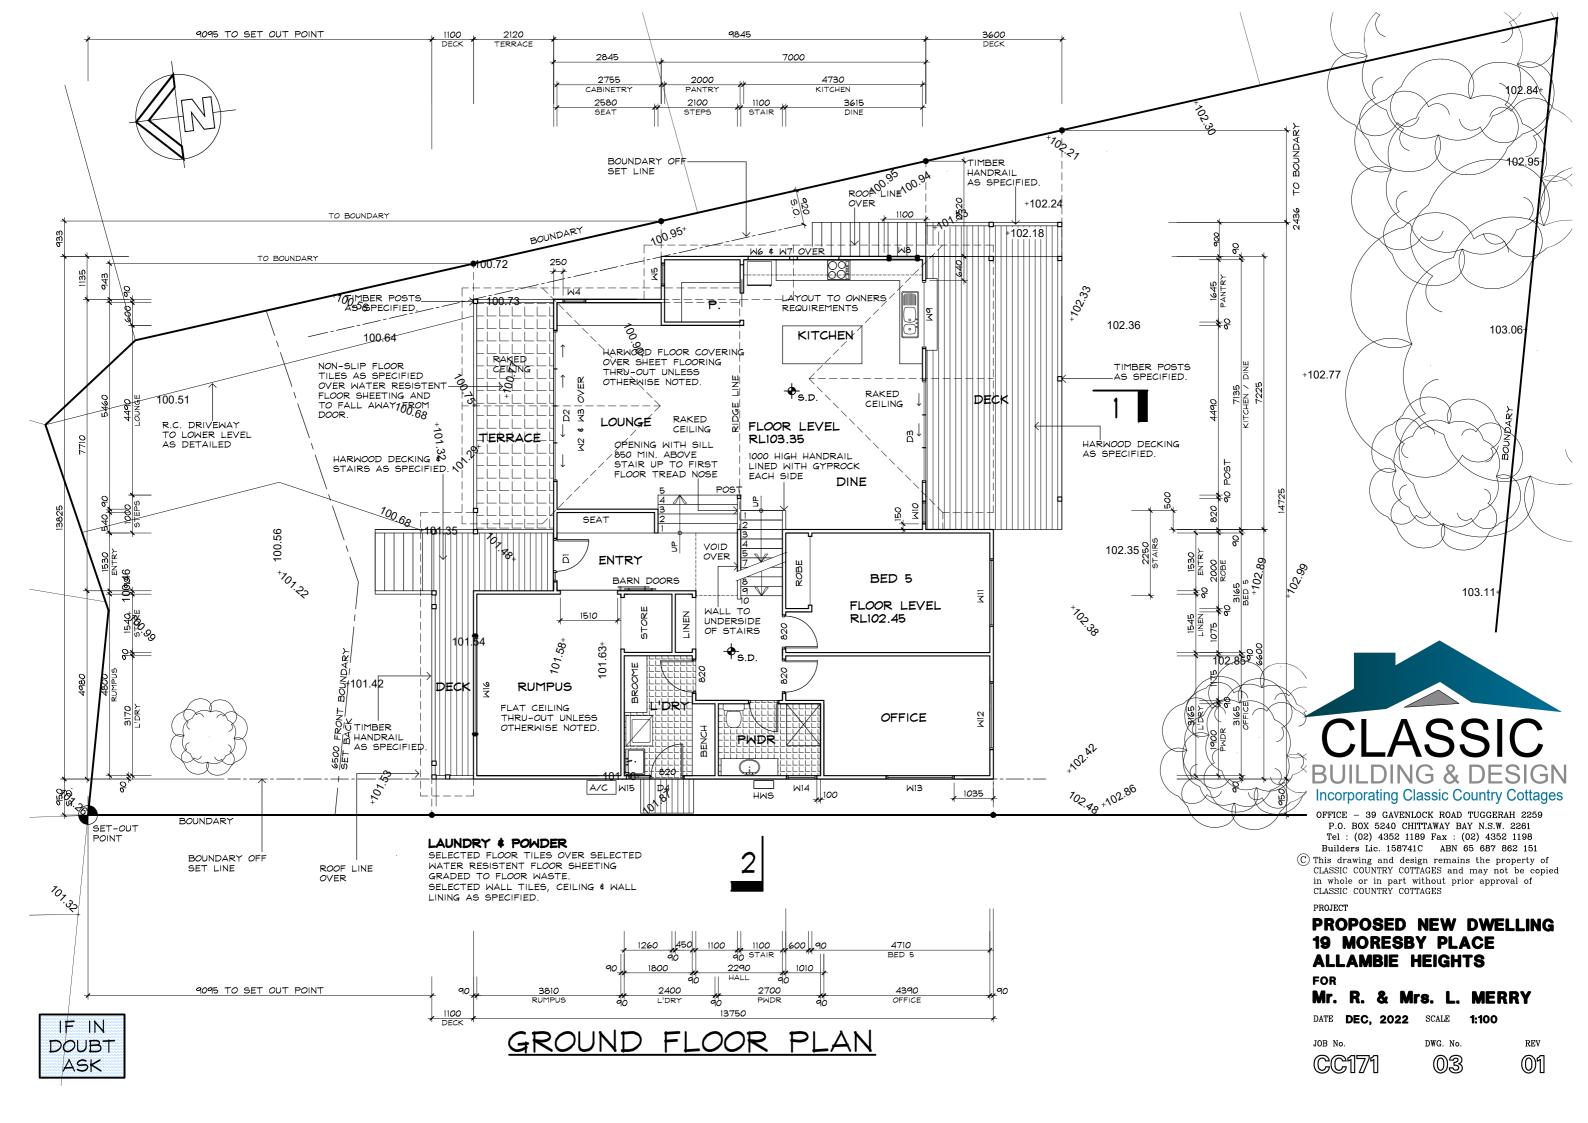


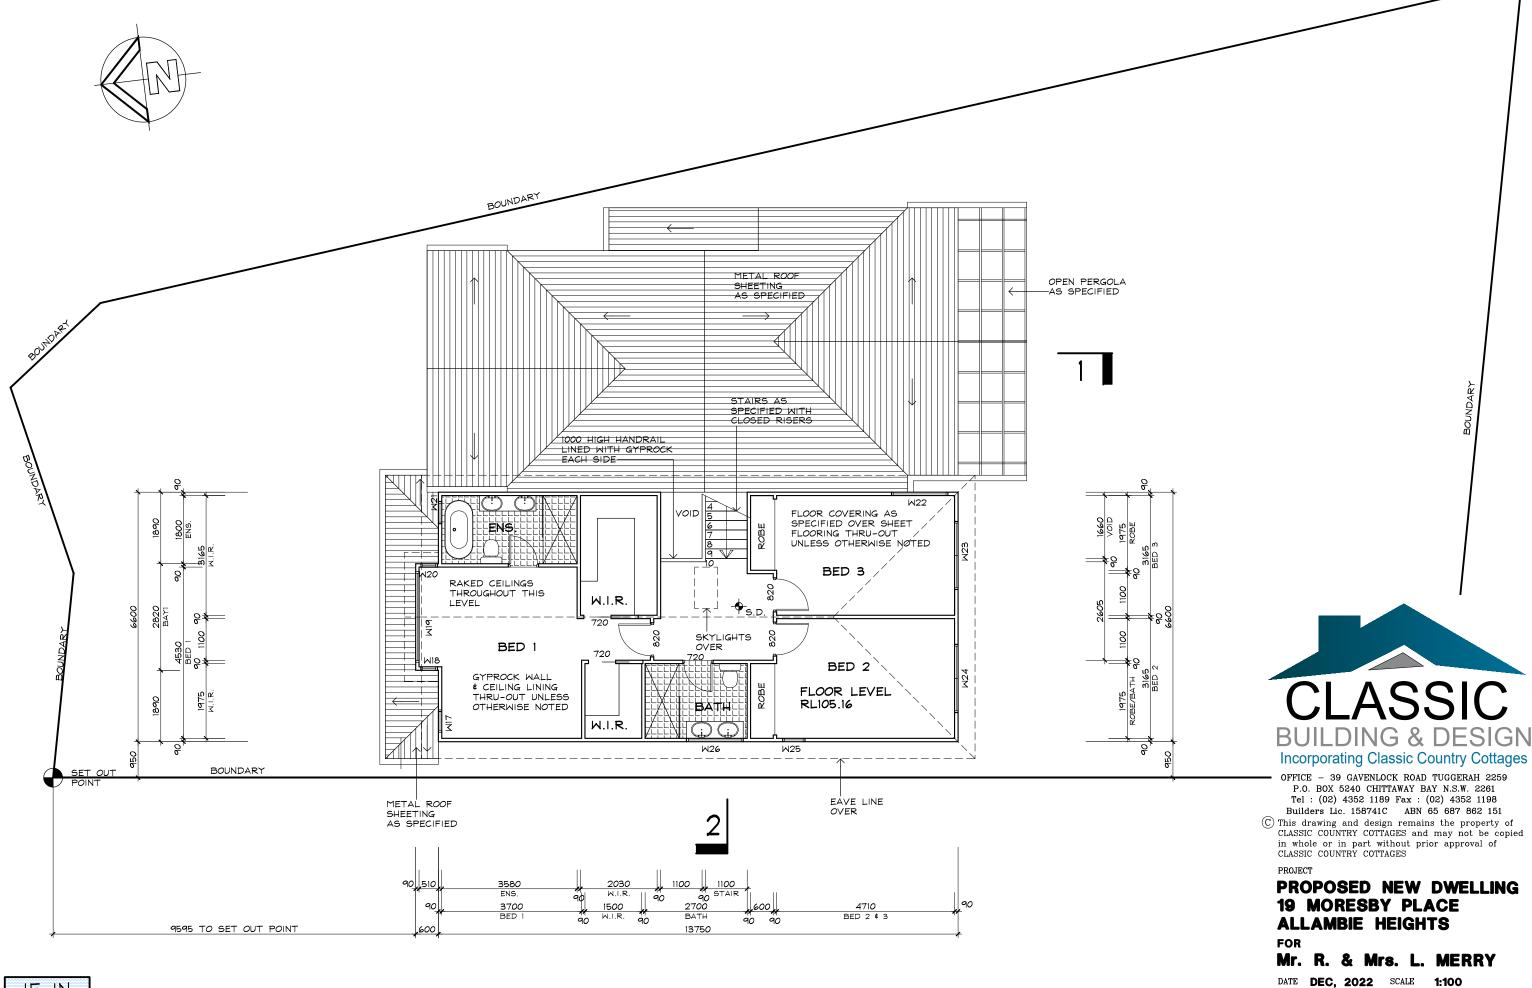




FIRST FLOOR PLAN

JOB No. CC171 DWG. No. 04 REV

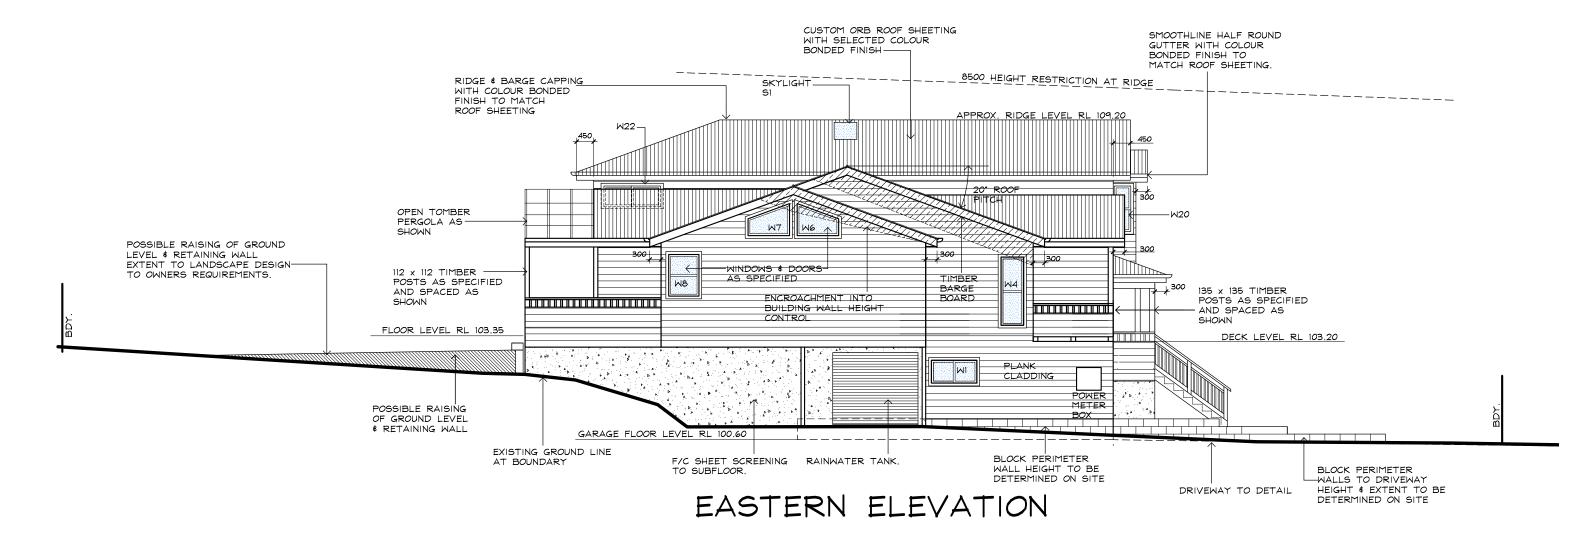

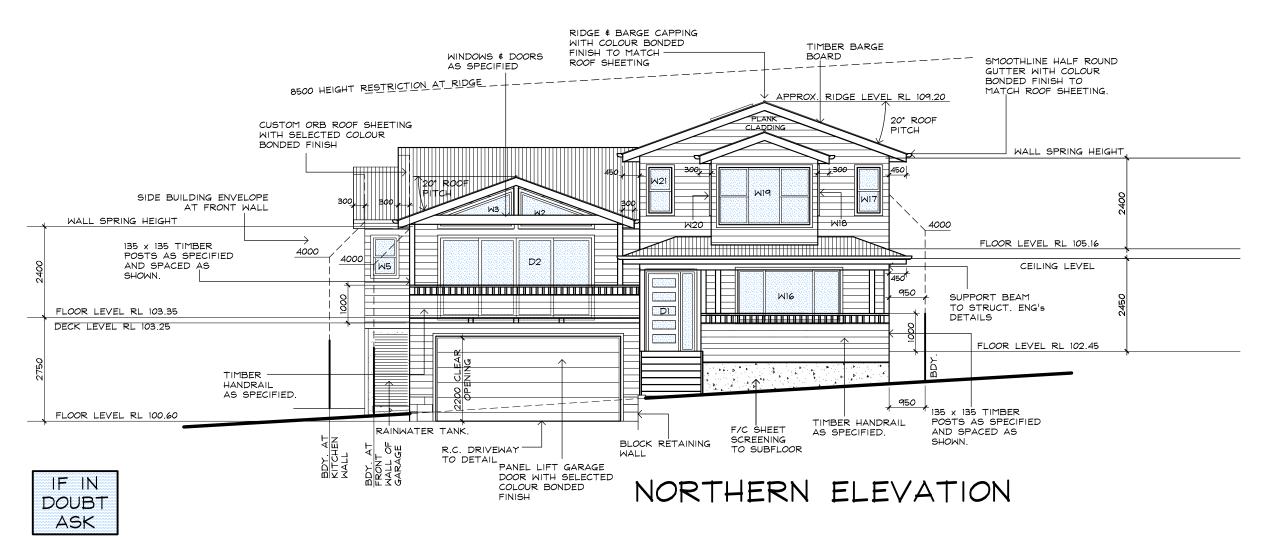



OFFICE - 39 GAVENLOCK ROAD TUGGERAH 2259 P.O. BOX 5240 CHITTAWAY BAY N.S.W. 2261 Tel: (02) 4352 1189 Fax: (02) 4352 1198 Builders Lic. 158741C ABN 65 687 862 151

© This drawing and design remains the property of CLASSIC COUNTRY COTTAGES and may not be copied in whole or in part without prior approval of CLASSIC COUNTRY COTTAGES

PROJECT

PROPOSED NEW DWELLING 19 MORESBY PLACE ALLAMBIE HEIGHTS

FOR


Mr. R. & Mrs. L. MERRY


DATE DEC, 2022 SCALE 1:100

_{ЈОВ No.}

DWG. No.

rev

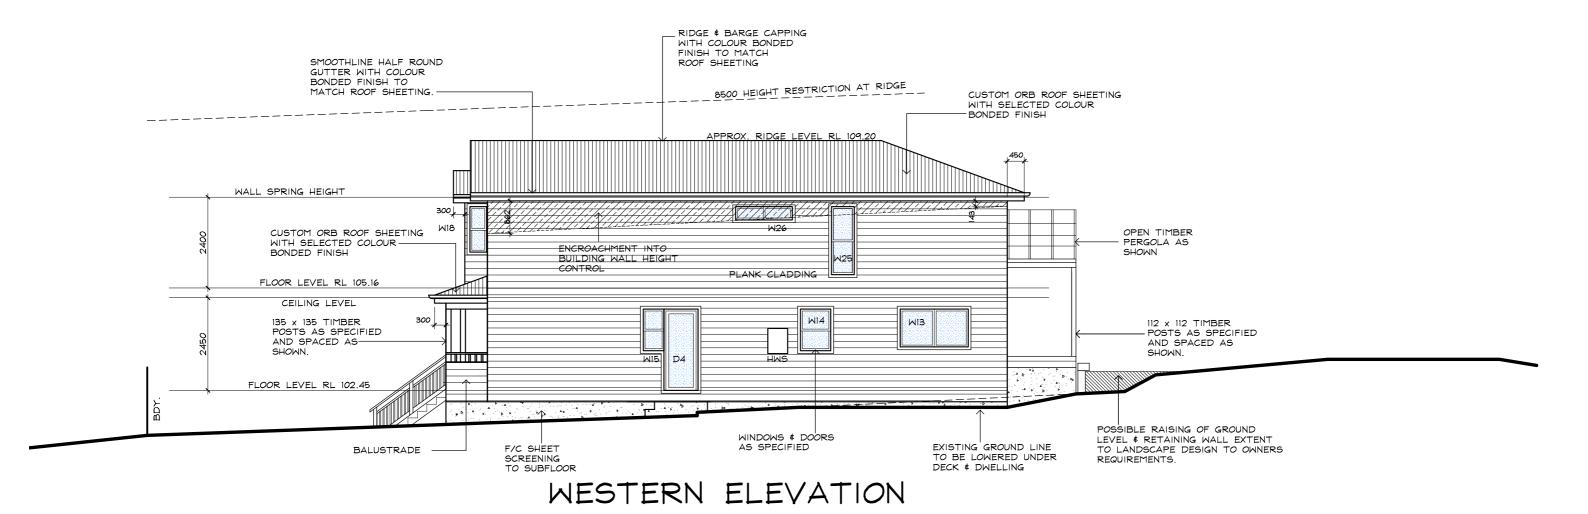

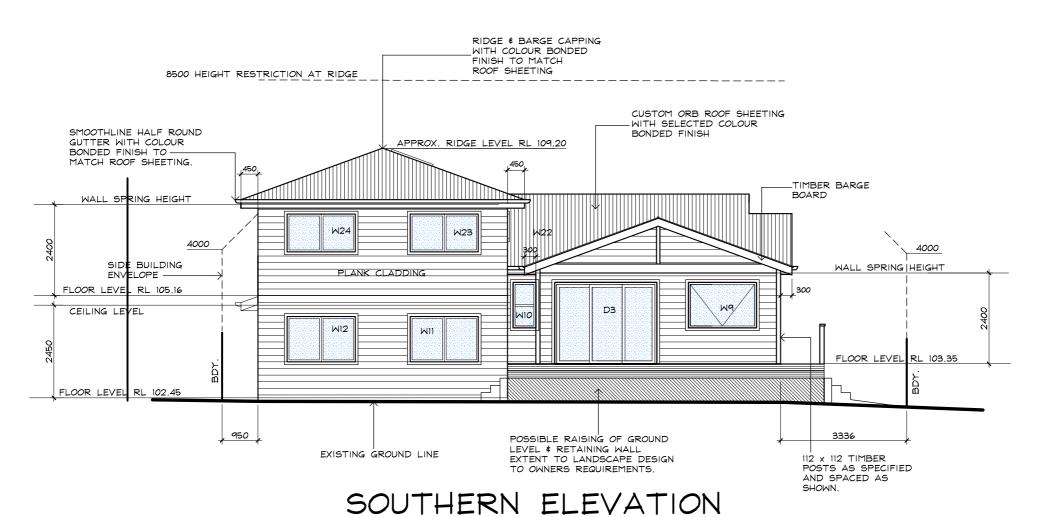



PROJECT PROPOSED NEW DWELLING 19 MORESBY PLACE **ALLAMBIE HEIGHTS**

BUILDING & DESIGN

Incorporating Classic Country Cottages

OFFICE - 39 GAVENLOCK ROAD TUGGERAH 2259 P.O. BOX 5240 CHITTAWAY BAY N.S.W. 2261 Tel: (02) 4352 1189 Fax: (02) 4352 1198

Builders Lic. 158741C ABN 65 687 862 151 © This drawing and design remains the property of CLASSIC COUNTRY COTTAGES and may not be copied

in whole or in part without prior approval of

FOR

CLASSIC COUNTRY COTTAGES


Mr. R. & Mrs. L. MERRY DATE DEC, 2022 SCALE 1:100


JOB No.

DWG. No.

06


REV

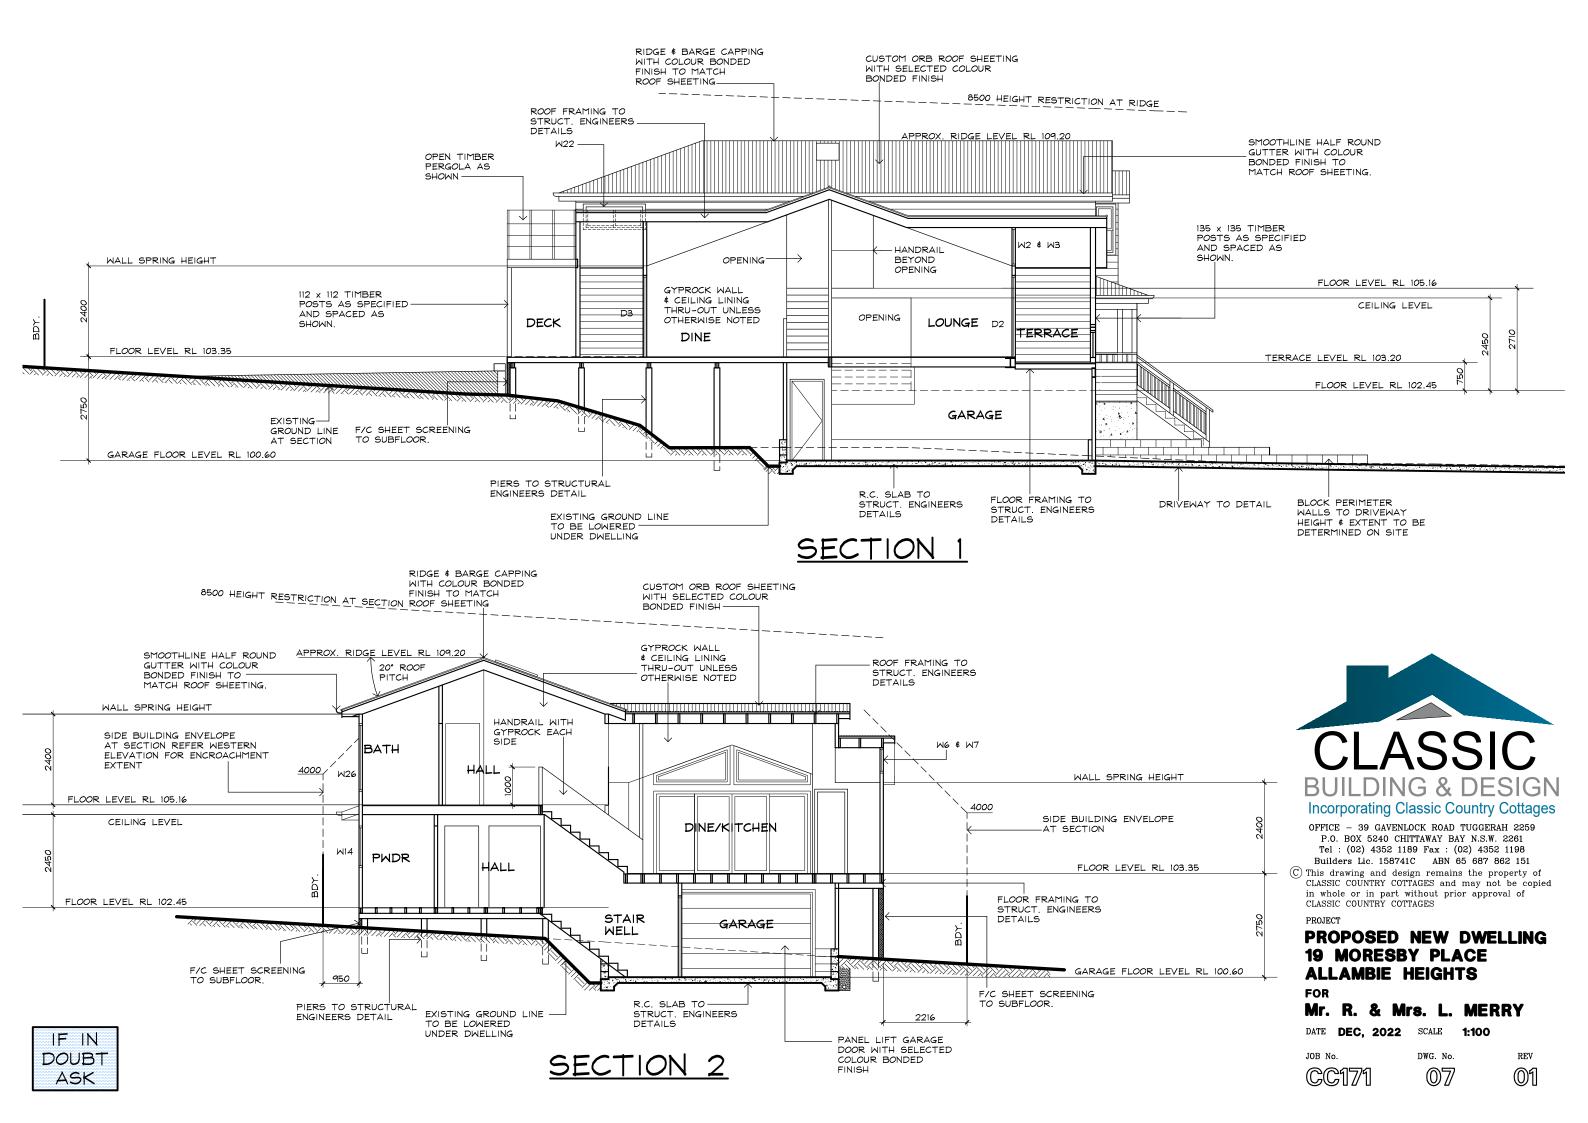

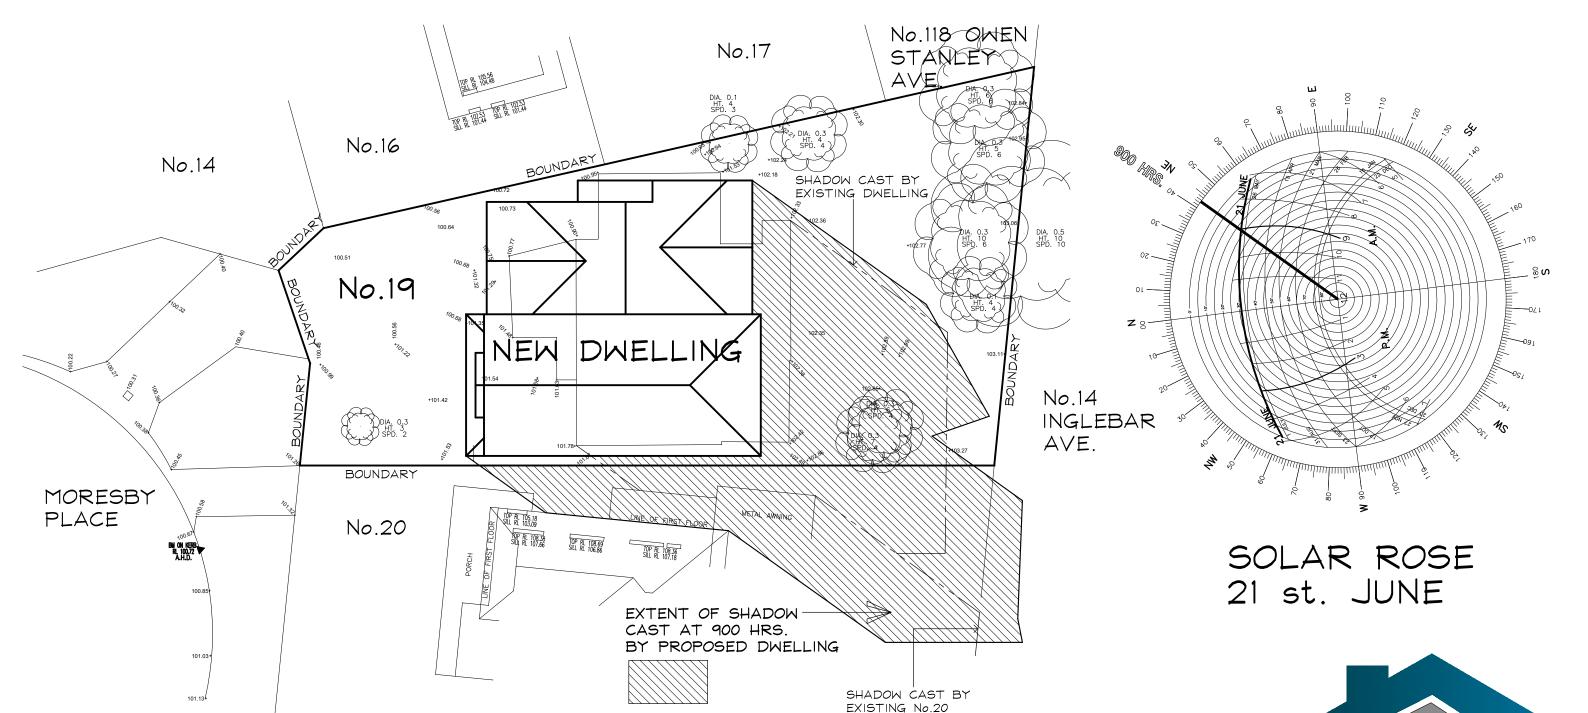

DWELLING

0900 HRS. SOLAR ANALYSIS PLAN

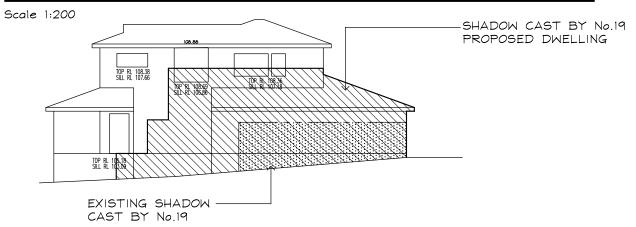

NORTH-EAST ELEVATION No.20

Scale 1:200





PROPOSED NEW DWELLING 19 MORESBY PLACE ALLAMBIE HEIGHTS

FOR


Mr. R. & Mrs. L. MERRY

DATE DEC, 2022 SCALE 1:200

CC171

DWG. No.

(

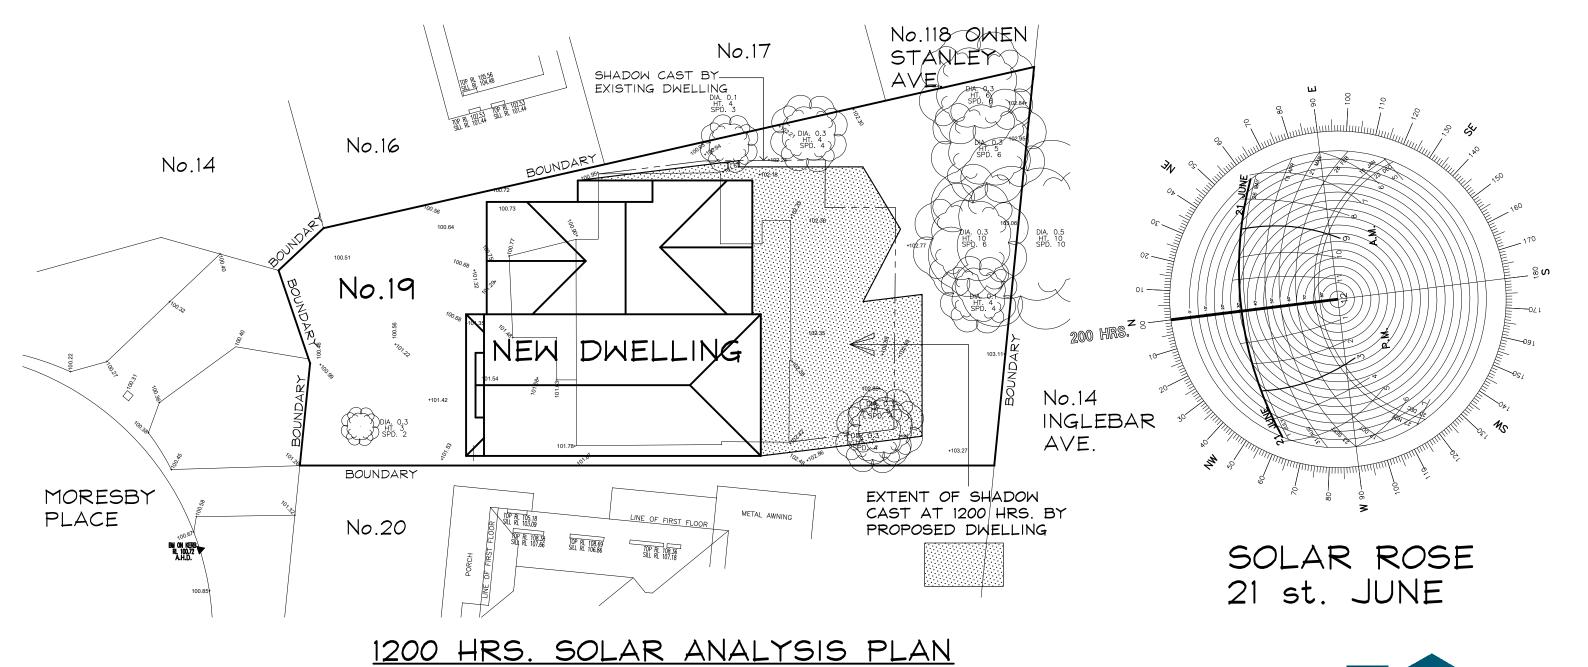

NO ADJOINING PROPERTY RESIDENCE ARE AFFECTED

Scale 1:200





OFFICE - 39 GAVENLOCK ROAD TUGGERAH 2259
P.O. BOX 5240 CHITTAWAY BAY N.S.W. 2261
Tel: (02) 4352 1189 Fax: (02) 4352 1198
Builders Lic. 158741C ABN 65 687 862 151

© This drawing and design remains the property of CLASSIC COUNTRY COTTAGES and may not be copied in whole or in part without prior approval of CLASSIC COUNTRY COTTAGES

PROJECT

PROPOSED NEW DWELLING 19 MORESBY PLACE ALLAMBIE HEIGHTS


FOR

Mr. R. & Mrs. L. MERRY

DATE DEC, 2022 SCALE 1:200

CC171

DWG. No.

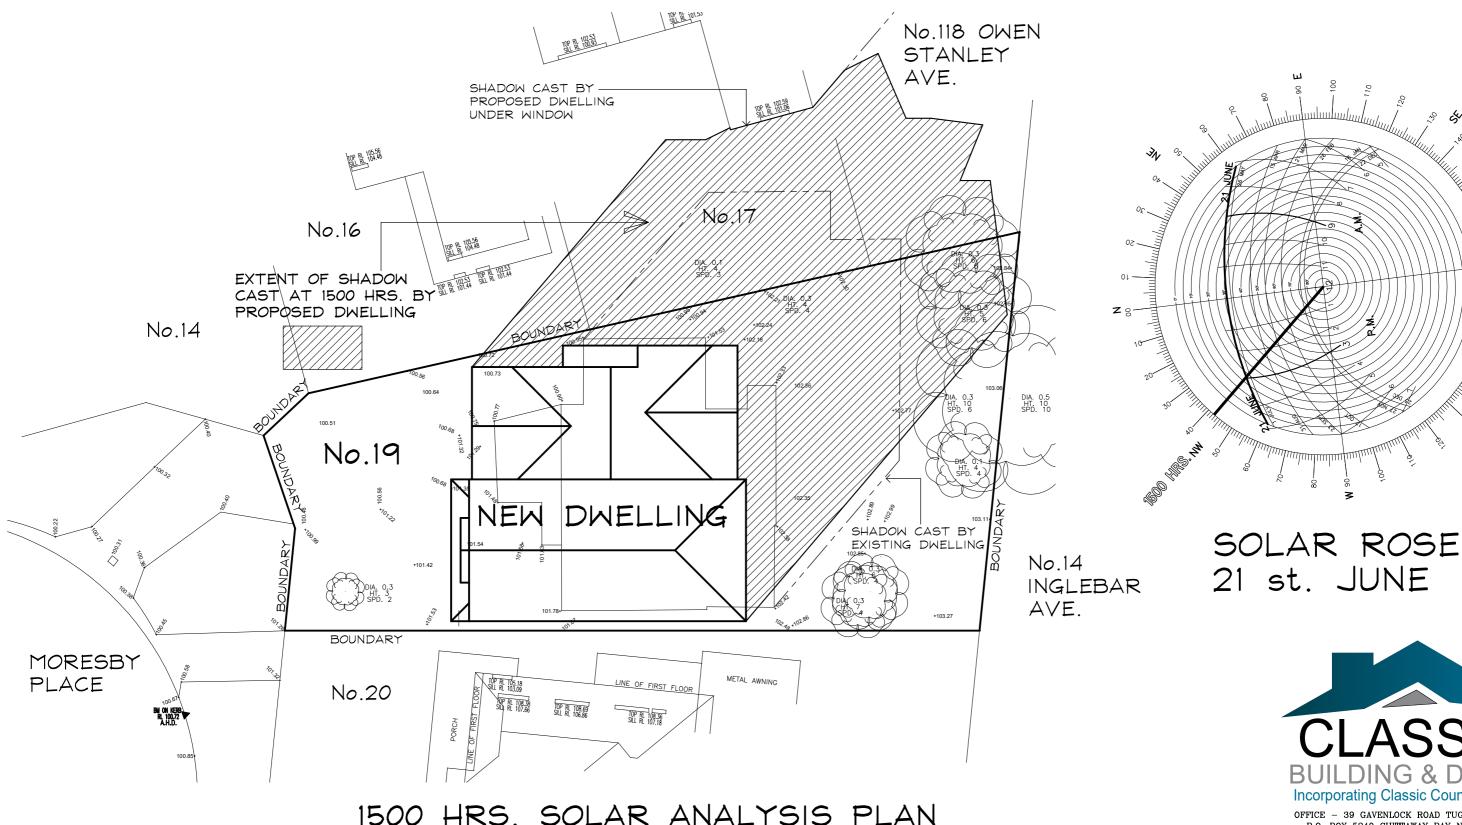

1500 HRS. SOLAR ANALYSIS PLAN Scale 1:200

> NO ADJOINING PROPERTY RESIDENCE ARE AFFECTED



PROPOSED NEW DWELLING 19 MORESBY PLACE **ALLAMBIE HEIGHTS**

BUILDING & DESIGN Incorporating Classic Country Cottages

OFFICE - 39 GAVENLOCK ROAD TUGGERAH 2259
P.O. BOX 5240 CHITTAWAY BAY N.S.W. 2261
Tel: (02) 4352 1189 Fax: (02) 4352 1198
Builders Lic. 158741C ABN 65 687 862 151

© This drawing and design remains the property of CLASSIC COUNTRY COTTAGES and may not be copied in whole or in part without prior approval of CLASSIC COUNTRY COTTAGES

FOR

PROJECT

Mr. R. & Mrs. L. MERRY

DATE DEC, 2022 SCALE 1:200


JOB No.

CC171

DWG. No.

10

REV

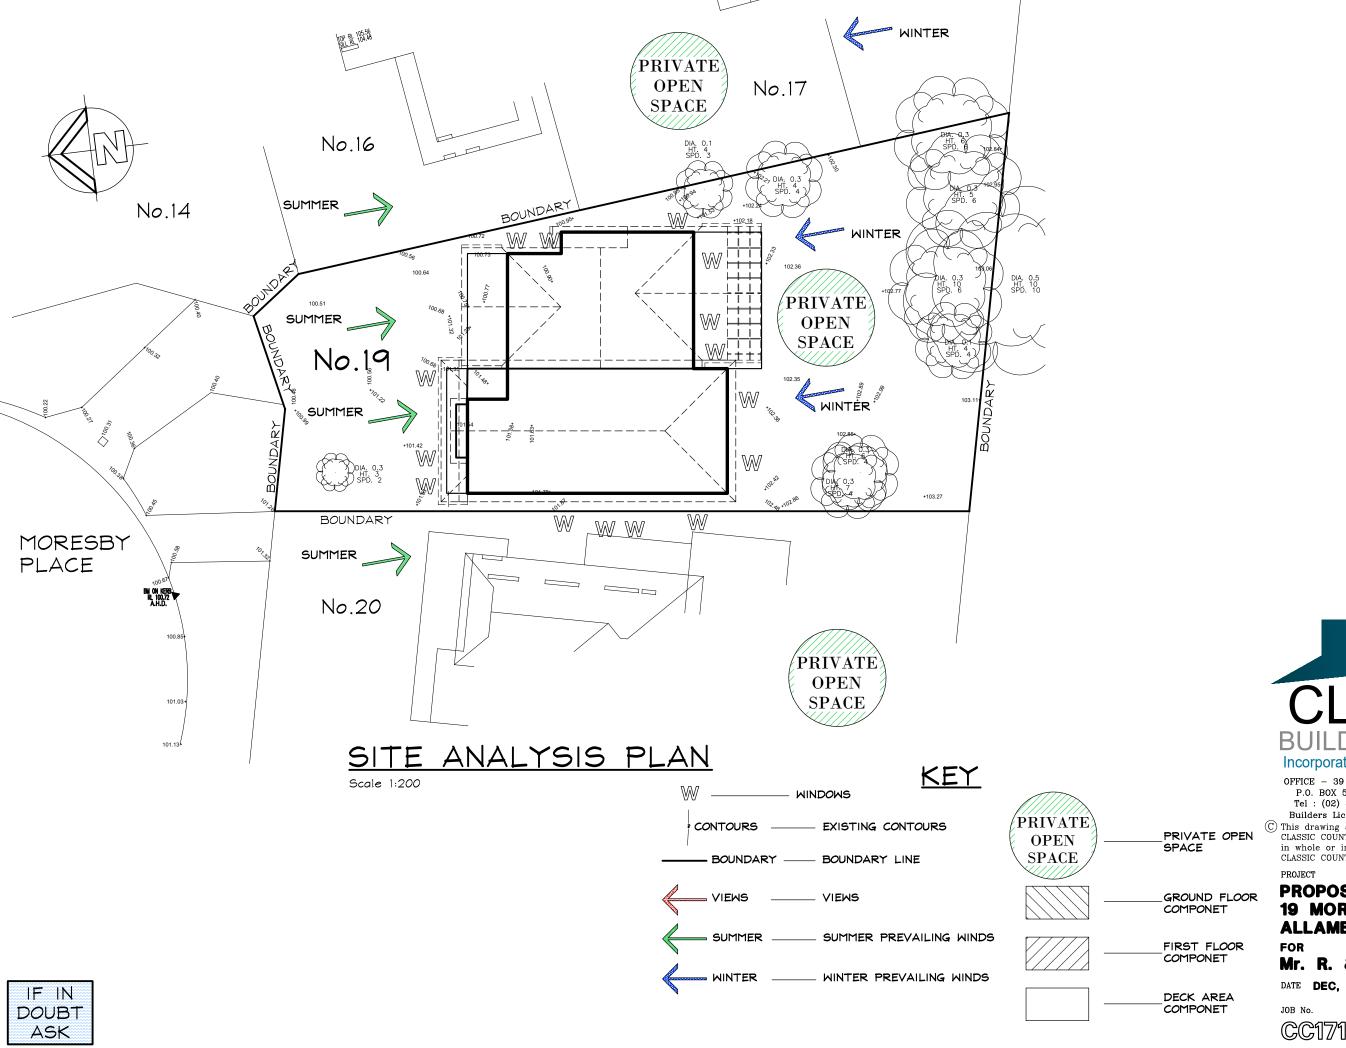



OFFICE - 39 GAVENLOCK ROAD TUGGERAH 2259 P.O. BOX 5240 CHITTAWAY BAY N.S.W. 2261 Tel: (02) 4352 1189 Fax: (02) 4352 1198 Builders Lic. 158741C ABN 65 687 862 151


© This drawing and design remains the property of CLASSIC COUNTRY COTTAGES and may not be copied in whole or in part without prior approval of CLASSIC COUNTRY COTTAGES


PROPOSED NEW DWELLING 19 MORESBY PLACE ALLAMBIE HEIGHTS

Mr. R. & Mrs. L. MERRY

DATE DEC, 2022 SCALE 1:200

job no. dwg. no. rev CC171 11 01

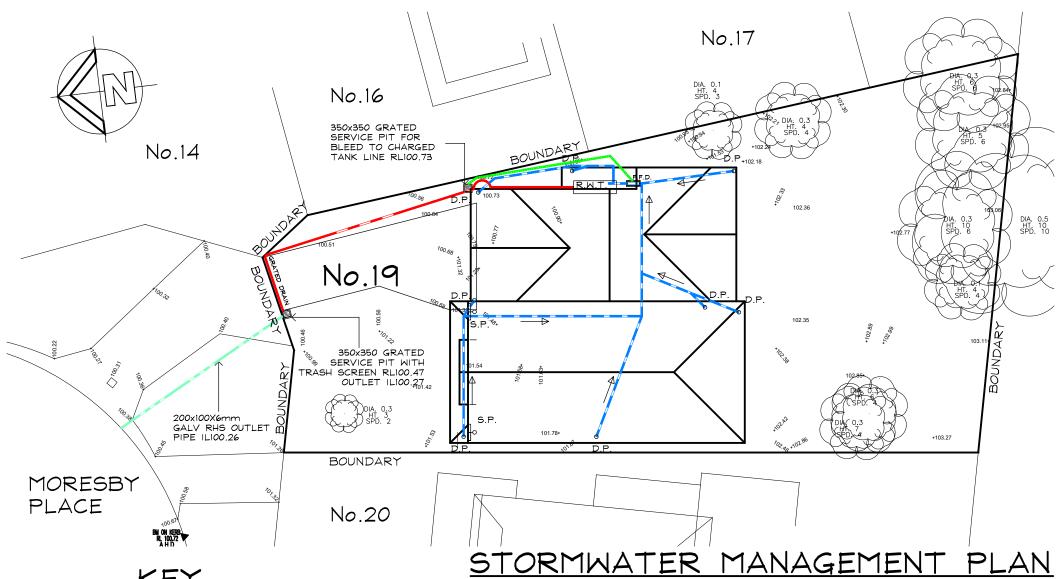

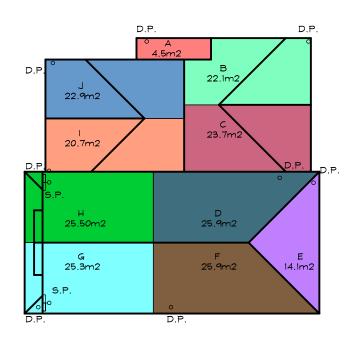

STORMWATER

Scale 1:200

KEY

DOWN PIPE (SPREADER)

DOWN PIPE 90mm

FIRST FLUSH DIVERTER

100mm DIA STORM WATER

PIPE TO STORAGE TANK 90mm DIA STORM WATER

DISCARD PIPE TO SERVICE PIT STORMWATER PIPE

60mm DIA BLEED PIPE

---- EXISTING STORMWATER PIPE

GALVANISED STEEL RHS PIPE TO KERB

DRAINAGE GRATE

GRATED PIT 150mm

RW/T ---- RAIN WATERTANK

- N DOUBT ASK

Scale 1:200

HYDRAULIC NOTES

THE CONTRACTOR SHALL GIVE NOTICE TO COUNCIL'S ENGINEER IN ACCORDANCE WITH COUNCIL'S SPECIFICATIONS WHEN INSPECTIONS ARE

WHERE DEPTH OF STORMWATER DRAINAGE PITS EXCEEDS 1.2m, HOT DIPPED

GALVANISED STEEL STEP IRONS SHALL BE PROVIDED.
ALL PITS SHALL BE PRECAST CONCRETE WITH GRATE OR APPROVED EQUIVALENT UNLESS NOTED OTHERWISE.

STORMWATER CONNECTION TO COUNCIL'S DRAINAGE SYSTEM SHALL BE DONE UNDER THE SUPERVISION OF COUNCIL'S ENGINEER.

ALL STORMWATER PIPES BELOW AND INCLUDING 2250 SHALL BE UPVC OR APPROVED EQUIV. UNLESS NOTED OTHERWISE. ALL PIPES ABOVE 2250 SHALL BE REINFORCED CONCRETE WITH RUBBER RING JOINTS UNLESS NOTED OTHERWISE.

RING JOINTS UNLESS NOTED OTHERWISE.

7. MINIMUM PIPE COVER TO BE 700mm UNLESS NOTED OTHERWISE.

8. ALL PIPES TO BE LAID AND COVERED WITH SAND TO A MINIMUM DEPTH EQUAL TO THE PIPE DIAMETER, BUT NOT LESS THAN 300mm.

9. IN SANDY SOILS THE EXCAVATED SOIL MAY BE REUSED.

10. ALL 1000 SUBSOIL DRAINAGE TO BE PLACED A MINIMUM OF 650mm BELOW EDINGLED SUBSOIL PROVINCES AND COVERED MATERIA.

FINISHED SURFACE LEVELS AND COVERED WITH A MINIMUM OF 500mm GRAVEL.

12. PIPE BEDDING SUPPORT SHALL BE H1 UNLESS NOTED OTHERWISE.
13. STORMWATER GRATES AND MANHOLE CLASSES SHALL BE IN ACCORDANCE

14. WITH AS3996 15. WHERE PIPE GRADES ARE NOT SHOWN ON DRAWINGS, MINIMUM PIPE

GRADES SHALL BE 1% UNO.

16. PIPE GRADES INDICATED ON DRAWINGS ARE MINIMUM GRADES. IF MINIMUM. GRADES CANNOT BE ACHIEVED CONTACT

17. THE DESIGN ENGINEER PRIOR TO PLACEMENT

RAINWATER TANK NOTES

1. ALL WORK TO BE CARRIED OUT IN ACCORDANCE WITH AS. 3500.3.2. 2.THIS PLAN TO BE READ IN CONJUNCTION WITH THE BASIX CERTIFICATE NUMBER LISTED IN BASIX/NATHERS NOTES.

3.A TOTAL RAINWATER TANK STORAGE CAPACITY OF 2,000 LITRES IS PROVIDED VIA ONE SLIMLINE TANK CONSISTING OF AN APPROX SIZE 685mm WIDE X 2,060mm L X 1,905mm H WATER TANK CONNECTED TO THE FOLLOWING:

 ALL TOILETS IN THE DEVELOPEMNT.
 THE COLD WATER TAP THAT SUPPLIES EACH CLOTHES WASHER IN THE DEVELOPMENT. - AT LEAST ONE OUTDOOR TAP IN THE DEVELOPMENT (NOTED: NSW HEALTH DOES NOT

RECOMMEND THAT RAINWATER BE USED FOR HUMAN CONSUMPTION.) 4. ALL PIPE AND DOWN PIPES TO BE PRESUSSURE GRADE PIPES TO 500mm ABOVE MAXIMUM WATER LEVEL OF RAIN WATERTANKS.

GUTTER NOTES

- 1. ALL GUTTERS TO HAVE A MINIMUM CROSS SECTION AS OUTLINED IN TABLE 1.
- 2. ALL GUTTER GRADIENTS TO BE NOT LESS THAN 1:500

3. TOP OF FASCIA TO BE A MINIMUM OF 15mm ABOVE GUTTER SLOTTED OVERFLOW

4. DOWNPIPE SIZES TO BE IN ACCORDANCE WITH TABLE 1.

CATCHMENT AREAS FOR INDIVIDUAL DOWNPIPES AND GUTTERS

	PLAN VIEW AREA m2	AREA INC SLOPE	GUTTER mm2 (CROSS SECTION)	DOWNPIPE SIZE	AVERAGE RECURRENCE INTERVAL 1 IN 20 YEAR
Α	4.5	4.8	7700	90mm	200mm/hr
В	22.1	23.5	7700	90mm	200mm/hr
С	23.7	25.2	7700	90mm	200mm/hr
D	25.9	27.5	7700	90mm	200mm/hr
Ε	14.1	15.0	7700	90mm	200mm/hr
F	25.9	27.5	7700	90mm	200mm/hr
G	25.3	26.9	7700	90mm	200mm/hr
Н	25.5	27.1	7700	90mm	200mm/hr
I	20.7	22.0	7700	90mm	200mm/hr
J	22.9	24.4	7700	90mm	200mm/hr

SITE CALCULATIONS

OR 40% OF SITE AREA.

TOTAL SITE AREA: 625.8 m2 ROOF CATCHMENT AREA 210.9 m2 OTHER PAVED AREAS (Refer to Site Plan) 34.8 m2 TOTAL IMPERVIOUS AREA 245.7 m2 (39.3%) RAIN WATER TANK STORAGE (MINIMUM) 2.000 LITRES ON-SITE DETENTION IS NOT REQUIRED AS 249.7 m2 IS < 250.3 m2

CL	ASSIC
BUILD	ING & DESIGN ag Classic Country Cottages

OFFICE - 39 GAVENLOCK ROAD TUGGERAH 2259 P.O. BOX 5240 CHITTAWAY BAY N.S.W. 2261 Tel: (02) 4352 1189 Fax: (02) 4352 1198 Builders Lic. 158741C ABN 65 687 862 151

(C) This drawing and design remains the property of CLASSIC COUNTRY COTTAGES and may not be copied in whole or in part without prior approval of CLASSIC COUNTRY COTTAGES


PROPOSED NEW DWELLING 19 MORESBY PLACE **ALLAMBIE HEIGHTS**


FOR

Mr. R. & Mrs. L. MERRY

DATE DEC. 2022 SCALE 1:200

JOB No.

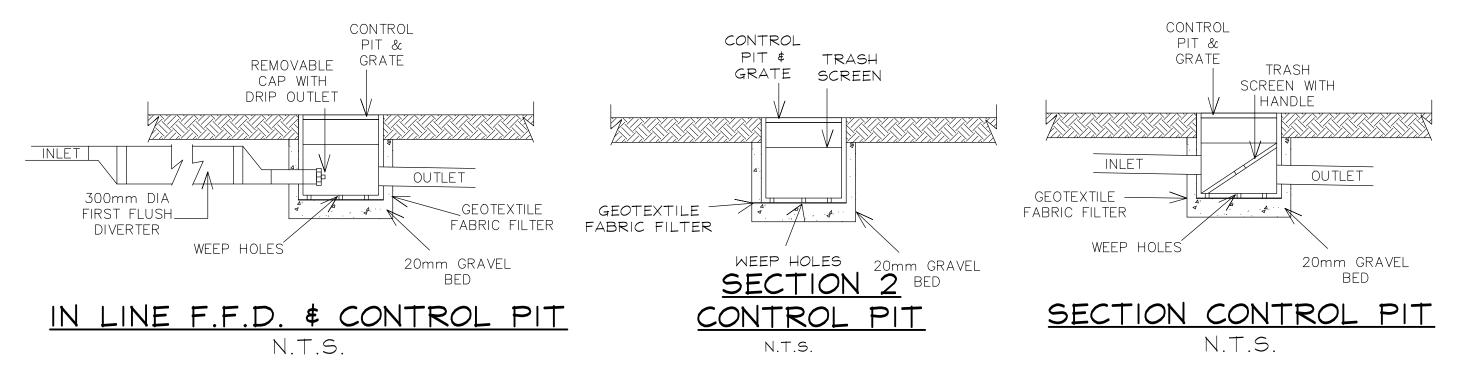

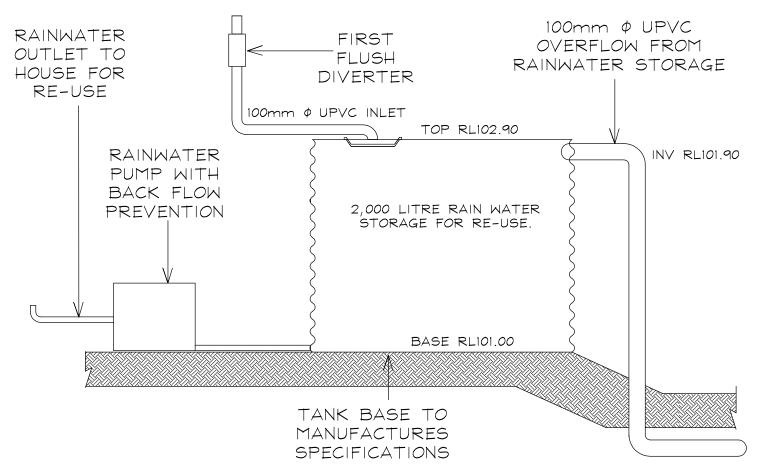



SECTION 1 RAINWATER TANK

N.T.S

HYDRAULIC NOTES

- THE CONTRACTOR SHALL GIVE NOTICE TO COUNCIL'S ENGINEER IN
 ACCORDANCE WITH COUNCIL'S SPECIFICATIONS WHEN INSPECTIONS ARE
 REQUIRED.
- 2. WHERE DEPTH OF STORMWATER DRAINAGE PITS EXCEEDS 1.2m, HOT DIPPED GALVANISED STEEL STEP IRONS SHALL BE PROVIDED.
- ALL PITS SHALL BE PRECAST CONCRETE WITH GRATE OR APPROVED EQUIVALENT UNLESS NOTED OTHERWISE.
- 4. STORMWATER CONNECTION TO COUNCIL'S DRAINAGE SYSTEM SHALL BE DONE UNDER THE SUPERVISION OF COUNCIL'S ENGINEER.
- ALL STORMWATER PIPES BELOW AND INCLUDING 225Ø SHALL BE UPVC OR APPROVED EQUIV. UNLESS NOTED OTHERWISE.
- 6. ALL PIPES ABOVE 2250 SHALL BE REINFORCED CONCRETE WITH RUBBER RING JOINTS UNLESS NOTED OTHERWISE.
- 7. MINIMUM PIPE COVER TO BE 700mm UNLESS NOTED OTHERWISE.
- 8. ALL PIPES TO BE LAID AND COVERED WITH SAND TO A MINIMUM DEPTH EQUAL TO THE PIPE DIAMETER, BUT NOT LESS THAN 300mm.
- 9. IN SANDY SOILS THE EXCAVATED SOIL MAY BE REUSED.
- 10. ALL 100Ø SUBSOIL DRAINAGE TO BE PLACED A MINIMUM OF 650mm BELOW FINISHED SURFACE LEVELS AND COVERED WITH A
- 11. MINIMUM OF 500mm GRAVEL.
- 12. PIPE BEDDING SUPPORT SHALL BE H1 UNLESS NOTED OTHERWISE.
- 13. STORMWATER GRATES AND MANHOLE CLASSES SHALL BE IN ACCORDANCE
- 14. WITH AS3996.
- 15. WHERE PIPE GRADES ARE NOT SHOWN ON DRAWINGS, MINIMUM PIPE GRADES SHALL BE 1% UNO.
- 16. PIPE GRADES INDICATED ON DRAWINGS ARE MINIMUM GRADES. IF MINIMUM. GRADES CANNOT BE ACHIEVED CONTACT
- 17. THE DESIGN ENGINEER PRIOR TO PLACEMENT.

RAINWATER TANK NOTES

- 1. ALL WORK TO BE CARRIED OUT IN ACCORDANCE WITH AS. 3500.3.2.
- 2.THIS PLAN TO BE READ IN CONJUNCTION WITH THE BASIX CERTIFICATE NUMBER LISTED IN BASIX/NATHERS NOTES.
- 3.A TOTAL RAINWATER TANK STORAGE CAPACITY OF 2,000 LITRES IS PROVIDED VIA ONE SLIMLINE TANK CONSISTING OF AN APPROX SIZE 685mm WIDE X 2,060mm L X 1,905mm H WATER TANK CONNECTED TO THE FOLLOWING:
- ALL TOILETS IN THE DEVELOPEMNT.
- THE COLD WATER TAP THAT SUPPLIES EACH CLOTHES WASHER IN THE DEVELOPMENT.
 AT LEAST ONE OUTDOOR TAP IN THE DEVELOPMENT (NOTED: NSW HEALTH DOES NOT
- RECOMMEND THAT RAINWATER BE USED FOR HUMAN CONSUMPTION.)
- 4. ALL PIPE AND DOWN PIPES TO BE PRESUSSURE GRADE PIPES TO 500mm ABOVE MAXIMUM WATER LEVEL OF RAIN WATERTANKS.

GUTTER NOTES

- 1. ALL GUTTERS TO HAVE A MINIMUM CROSS SECTION AS OUTLINED IN TABLE 1.
- 2. ALL GUTTER GRADIENTS TO BE NOT LESS THAN 1:500
- 3. TOP OF FASCIA TO BE A MINIMUM OF 15mm ABOVE GUTTER SLOTTED OVERFLOW
- 4. DOWNPIPE SIZES TO BE IN ACCORDANCE WITH TABLE 1.



OFFICE - 39 GAVENLOCK ROAD TUGGERAH 2259
P.O. BOX 5240 CHITTAWAY BAY N.S.W. 2261
Tel: (02) 4352 1189 Fax: (02) 4352 1198
Builders Lic. 158741C ABN 65 687 862 151

© This drawing and design remains the property of CLASSIC COUNTRY COTTAGES and may not be copied in whole or in part without prior approval of CLASSIC COUNTRY COTTAGES

PROJECT

PROPOSED NEW DWELLING 19 MORESBY PLACE ALLAMBIE HEIGHTS


FOR

Mr. R. & Mrs. L. MERRY

DATE DEC, 2022 SCALE N.T.S.

DWG. No.


13

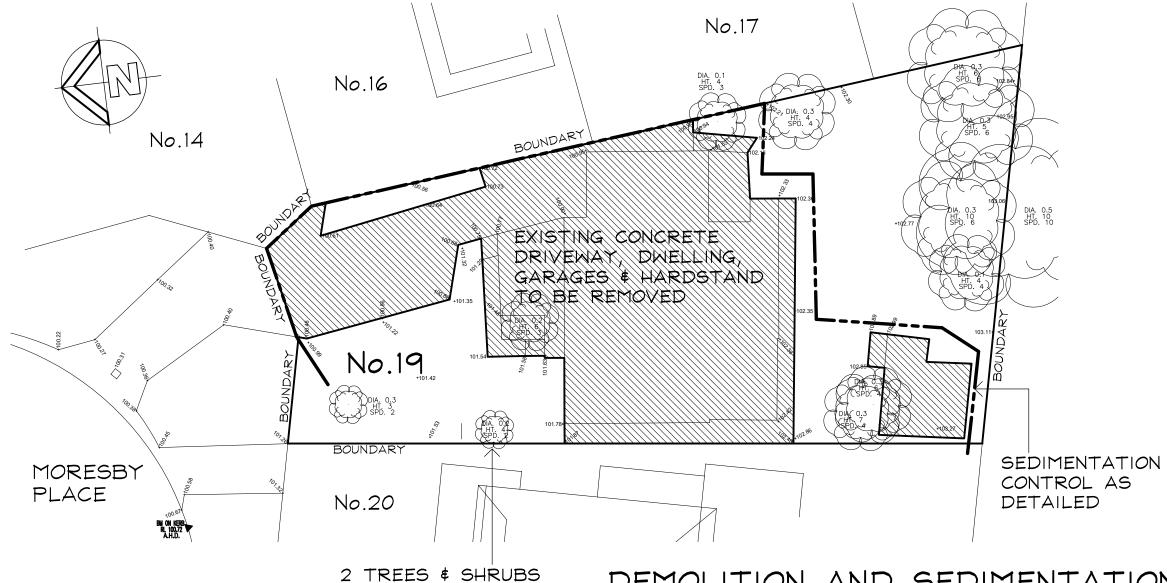

TO BE REMOVED

DEMOLITION AND SEDIMENTATION FENCE PLAN

Scale 1:200

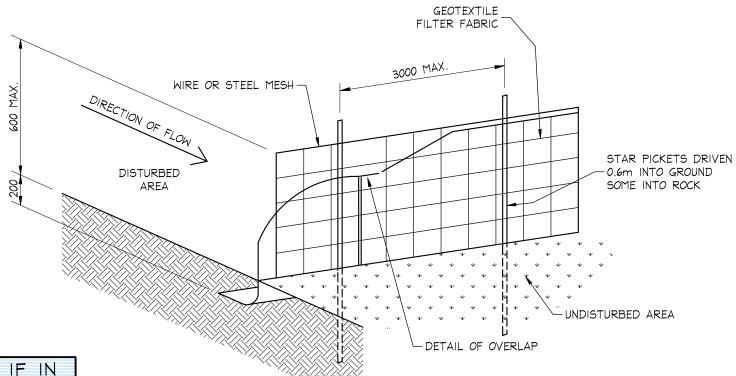

DOUBT ASK

SEDIMENTATION CONTROL FENCE DETAIL

SCALE = N.T.S.

SEDIMENT CONTROL:

- 1. INSTALL SEDIMENT CONTROL STRUCTURES IN LOCATIONS INDICATED ON DRAWINGS AND AS OTHERWISE REQUIRED TO CONTROL SEDIMENT DURING ALL EXCAVATIONS AND WHILST AREAS OF THE SITE ARE EXPOSED TO EROSION.
- 2. CONTROL STRUCTURES TO BE AS DETAILED OR AS OTHERWISE REQUIRED.
- 3. REVIEW CONTROL MEASURES AND MAINTAIN STRUCTURES DURING CONSTRUCTION.
- 4. IF ADDITIONAL MEASURES ARE REQUIRED FOR EROSION CONTROL OR BY COUNCIL REQUIREMENTS REFER TO "URBAN EROSION AND SEDIMENT CONTROL" GUIDELINES PREPARED BY THE DEPARTMENT OF CONSERVATION AND LAND MANAGEMENT.



OFFICE - 39 GAVENLOCK ROAD TUGGERAH 2259 P.O. BOX 5240 CHITTAWAY BAY N.S.W. 2261 Tel: (02) 4352 1189 Fax: (02) 4352 1198 Builders Lic. 158741C ABN 65 687 862 151

(C) This drawing and design remains the property of CLASSIC COUNTRY COTTAGES and may not be copied

in whole or in part without prior approval of CLASSIC COUNTRY COTTAGES

PROPOSED NEW DWELLING 19 MORESBY PLACE **ALLAMBIE HEIGHTS**

FOR

Mr. R. & Mrs. L. MERRY

DATE DEC, 2022 SCALE 1:200

Colour & Material Schedule

for

15-12-2022 **19 Moresby Place, Allambie Heights NSW 2100**

The owners have expressed a desire for the design and character of the home to be apathetic to the locality and to improve the visual quality and identity of the streetscape, the colours and materials chosen are warm earthy tones and natural timber to help the home harmonise with the natural surrounding environment and ensure minimum visual eminence.

Roof	Colorbond Steel	Basalt	Product Control to busin The Control of the Control
Cladding	Dulux Silkwort		
Decks	Natural Timber	Natural Timber stain	