

TRUE NORTH:



- including amendments of the National Construction Code, relevant Australian Standards & loca council requirements.

  New materials are to be used throughout unless otherwise noted.

  Concrete footings, slab, structural beams or any other structural members are to be designed.

26/90 Mona Vale Road, Mona Vale, NSW, 2103 PO Box 687, Dee Why, NSW, 2099 Mob. 0414 717 541 | Email. jjdraft@tpg.com.au www.jjdrafting.com.au

ACN 651 693 346

REV:	DATE:	DESCRIPTION:	
Α	10/12/2021	PROPOSED STUDIO	
AB	17/12/2021	MINOR CHANGES	
AC	24/01/2022	MINOR CHANGES	
AD	03/02/2022	ROOF CHANGES	
AE	14/03/2022	AMENDMENTS TO PRELIM DRAWINGS	
AF	24/03/2022	DA DRAWINGS	

PROPOSED ALTERATIONS AND ADDITIONS 133 UPPER CLONTARF ST. SEAFORTH	DATE: NOW/21
CLIENT: RICHARD AND REBECCA	JOB No:
DRAWING TITLE: SITE ANALYSIS PLAN	970/21

SCALE:


DRAWING No:

CHECKED BY:

JJ

1:200 @ A3

**DA.01** 

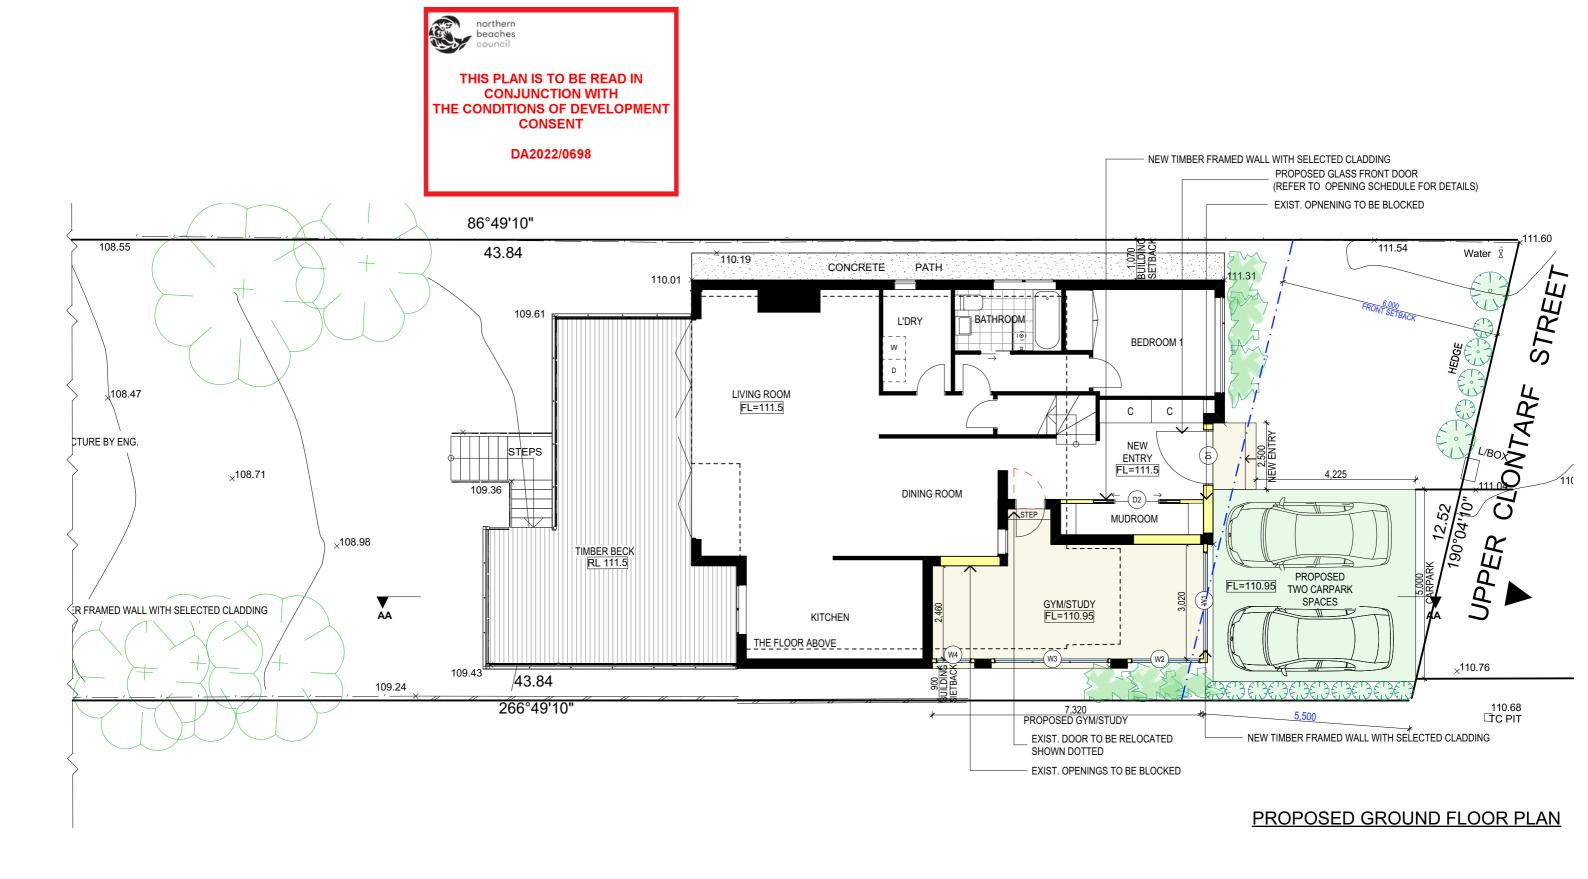

### **GROUND FL. AREA CALCULATIONS**

APPROX. EXISTING GROSS FLOOR AREA 101.21m<sup>2</sup> PROPOSED NEW GROSS FLOOR AREA 21.82m<sup>2</sup>

(EXCLUDING STUDIO) APPROX. STUDIO FLOOR AREA 18.41m<sup>2</sup>

TRUE NORTH:

TOTAL GROSS FLOOR AREA

NOTES (E & OE) All structures including stormwater & drainage to engineer's details
 Do not obtain dimensions by scaling drawings.
 All dimensions are to be checked on site prior to starting work.

185.37m<sup>2</sup>

- These drawings are to be read in conjunction with all other consultant's drawings and specifications.

  • All workmanship & materials shall be in accordance with the requirements of current editions
- New materials are to be used throughout unless otherwise noted.
   Concrete footings, slab, structural beams or any other structural members are to be designed. by a practicing engineer.


## JJ Drafting

26/90 Mona Vale Road, Mona Vale, NSW, 2103 PO Box 687, Dee Why, NSW, 2099 Mob. 0414 717 541 | Email. jjdraft@tpg.com.au www.jjdrafting.com.au ACN 651 693 346

1	REV:	DATE:	DESCRIPTION:	PR
ı	Α	10/12/2021	PROPOSED STUDIO	133
ı	AB	17/12/2021	MINOR CHANGES	. • .
ı	AC	24/01/2022	MINOR CHANGES	CLI
ı	AD	03/02/2022	ROOF CHANGES	RIC
ıl	AE	14/03/2022	AMENDMENTS TO PRELIM DRAWINGS	DRA
ı	AF	24/03/2022	DA DRAWINGS	
-1				GF

PROPOSED ALTERATIONS AND ADDITIONS 133 UPPER CLONTARF ST. SEAFORTH CLIENT:	DATE: NOW/21	DRAWN BY:	SCALE: 1:100 @ A3
RICHARD AND REBECCA	JOB No:	CHECKED BY:	DRAWING No:
DRAWING TITLE: GROUND FLOOR PLAN	970/21	JJ	DA.06



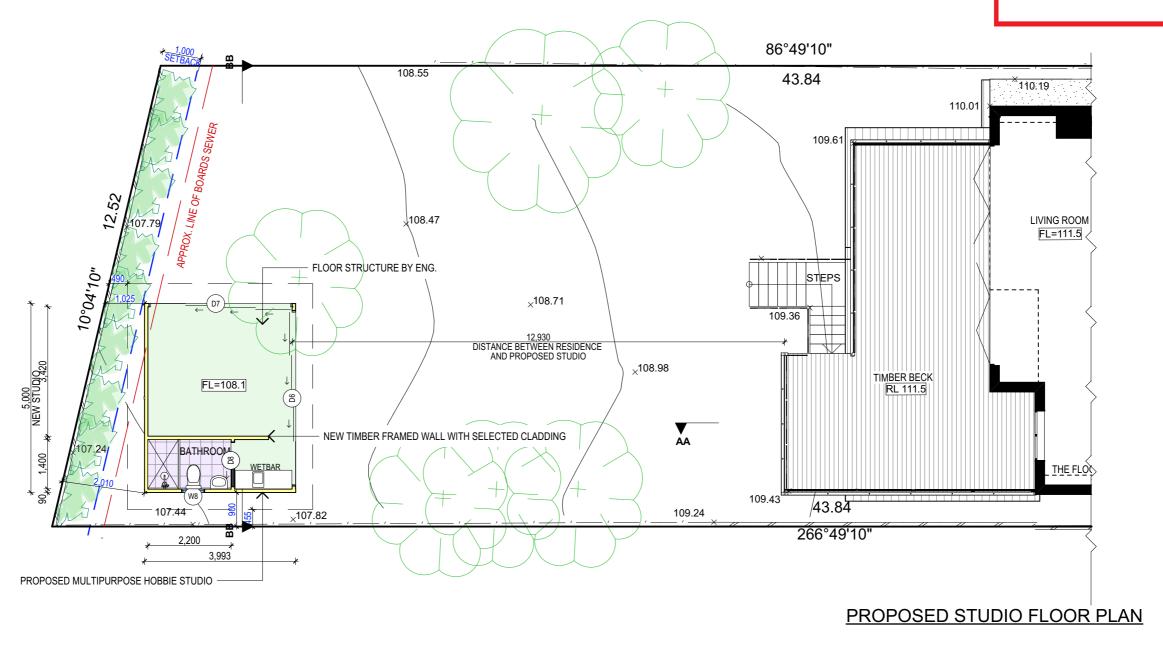

TRUE NORTH:



NOTES (E & OE)

• All structures including stormwater & drainage to engineer's details.

• Do not obtain dimensions by scaling drawings.

• All dimensions are to be checked on site prior to starting work.

• These drawings are to be read in conjunction with all other consultant's drawings and

Specifications.
 All workmanship & materials shall be in accordance with the requirements of current editions.

 All working amendments of the National Construction Code, relevant Australian Standards & local council requirements.
 New materials are to be used throughout unless otherwise noted.
 Concrete footings, slab, structural beams or any other structural members are to be designed by a precision construction construction. by a practicing engineer.


# Division of JJ DRAFTING AUSTRALIA PTY LTD

26/90 Mona Vale Road, Mona Vale, NSW, 2103 PO Box 687, Dee Why, NSW, 2099 Mob. 0414 717 541 | Email. jjdraft@tpg.com.au www.jjdrafting.com.au ACN 651 693 346

	REV:	DATE:	DESCRIPTION:	
	Α	10/12/2021	PROPOSED STUDIO	
	AB	17/12/2021	MINOR CHANGES	
3	AC	24/01/2022	MINOR CHANGES	119
	AD	03/02/2022	ROOF CHANGES	L
u	AE	14/03/2022	AMENDMENTS TO PRELIM DRAWINGS	Ι.
	AF	24/03/2022	DA DRAWINGS	ı i
- 1				ш

PROPOSED ALTERATIONS AND ADDITIONS 133 UPPER CLONTARF ST. SEAFORTH	DA
CLIENT: RICHARD AND REBECCA	JC
DRAWING TITLE: STUDIO FLOOR PLAN	

DATE:	DRAWN BY:	SCALE:
NOW/21	EV	1:100 @ A3
JOB No:	CHECKED BY:	DRAWING No:
970/21	JJ	DA.07

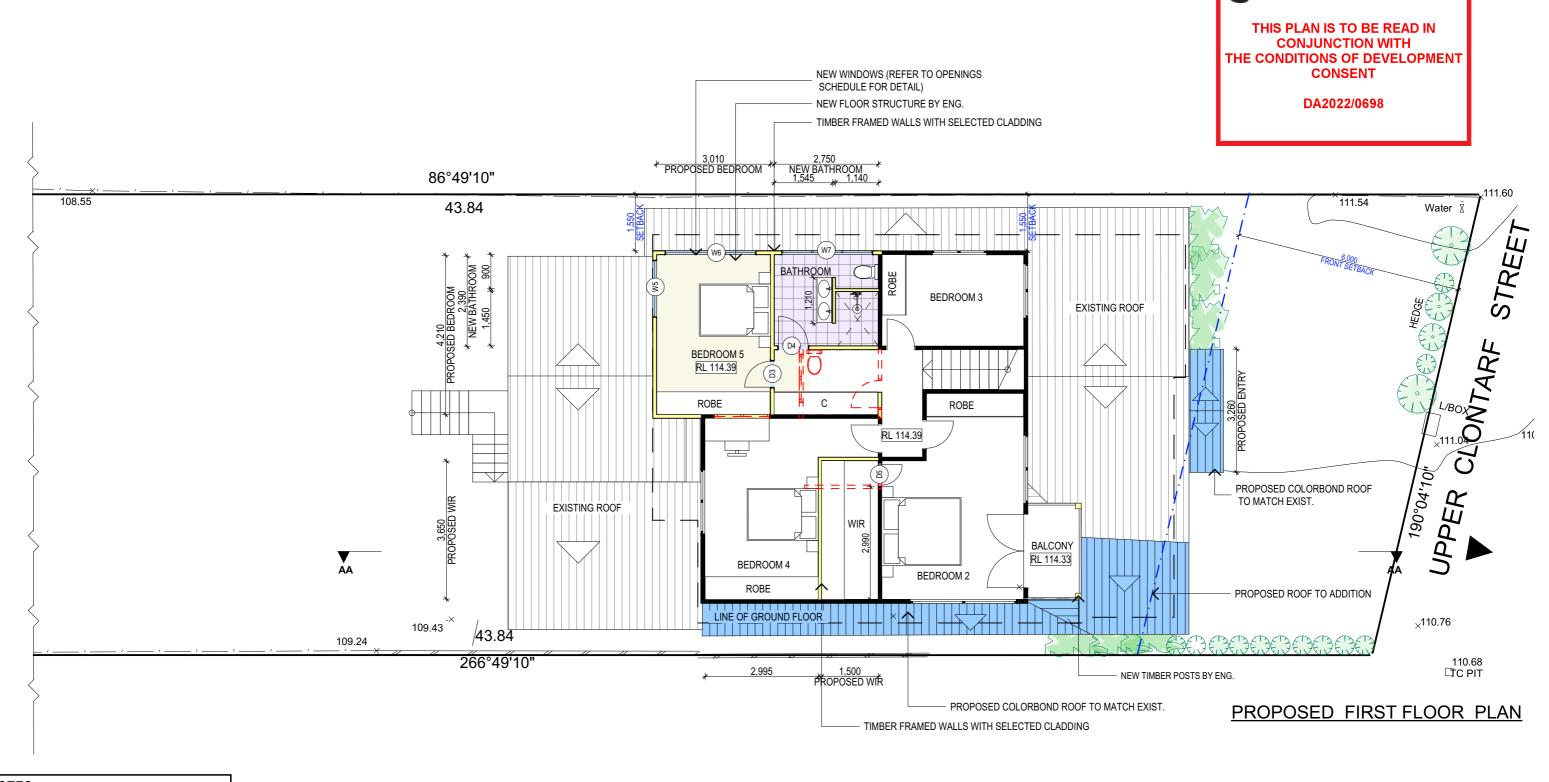

### <u>NOTES</u>

ALL DEMOLITION WORK TO COMPLY WITH AS 2601 & SAFE WORK AUSTRALIA CODE OF PRACTICE.

### FIRST FL. AREA CALCULATIONS

APPROX. EXISTING GROSS FLOOR AREA 57.66m<sup>2</sup> PROPOSED NEW GROSS FLOOR AREA 21.51 m<sup>2</sup> TOTAL GROSS FLOOR AREA 79.17m<sup>2</sup>

TRUE NORTH:



### NOTES (E & OE)

- All structures including stormwater & drainage to engineer's details
   Do not obtain dimensions by scaling drawings.
   All dimensions are to be checked on site prior to starting work. . These drawings are to be read in conjunction with all other consultant's drawings and

- New materials are to be used throughout unless otherwise noted.
   Concrete footings, slab, structural beams or any other structural members are to be designed. by a practicing engineer.


## JJ Drafting

26/90 Mona Vale Road, Mona Vale, NSW, 2103 PO Box 687, Dee Why, NSW, 2099 Mob. 0414 717 541 | Email. jjdraft@tpg.com.au www.jjdrafting.com.au ACN 651 693 346

REV:	DATE:	DESCRIPTION:
Α	10/12/2021	PROPOSED STUDIO
AB	17/12/2021	MINOR CHANGES
AC	24/01/2022	MINOR CHANGES
AD	03/02/2022	ROOF CHANGES
AE	14/03/2022	AMENDMENTS TO PRELIM DRAWINGS
AF	24/03/2022	DA DRAWINGS


PROPOSED ALTERATIONS AND ADDITIONS 133 UPPER CLONTARF ST. SEAFORTH CLIENT:	DATE: NOW/21	DRAWN BY:	SCALE: 1:100 @ A3
RICHARD AND REBECCA	JOB No:	CHECKED BY:	DRAWING No:
DRAWING TITLE: PROPOSED FIRST FLOOR	970/21	JJ	DA.08

northern beaches

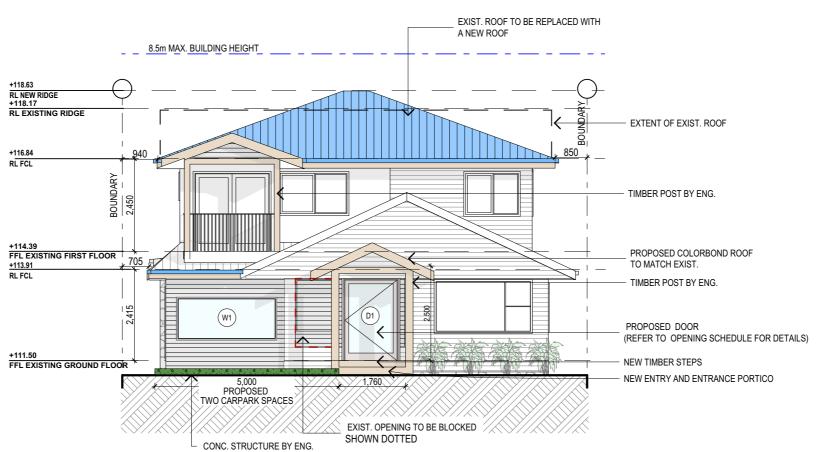



## PROPOSED EAST ELEVATION

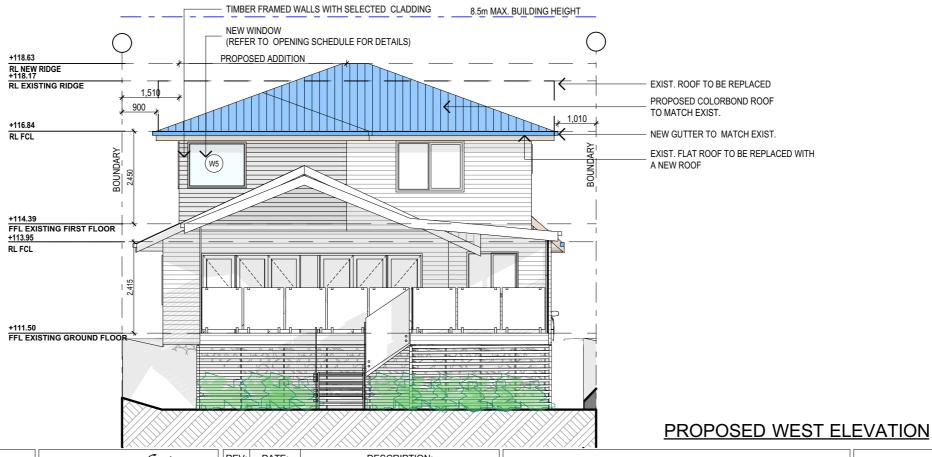

### NOTES (E & OE)

- All structures including stormwater & drainage to engineer's details.
   Do not obtain dimensions by scaling drawings.
   All dimensions are to be checked on site prior to starting work.
- specifications. 
   All workmanship & materials shall be in accordance with the requirements of current editions

- New materials are to be used throughout unless otherwise noted.
   Concrete footings, slab, structural beams or any other structural members are to be designed. by a practicing engineer.


# JJ Drafting


Division of JJ DRAFTING AUSTRALIA PTY LTD 26/90 Mona Vale Road, Mona Vale, NSW, 2103 PO Box 687, Dee Why, NSW, 2099 Mob. 0414 717 541 | Email. jjdraft@tpg.com.au www.jjdrafting.com.au ACN 651 693 346

	RE\	<b>/</b> :	DATE:	DESCRIPTION:
	Α		10/12/2021	PROPOSED STUDIO
	AB	}	17/12/2021	MINOR CHANGES
,	AC	,	24/01/2022	MINOR CHANGES
	AD	)	03/02/2022	ROOF CHANGES
u l	AE		14/03/2022	AMENDMENTS TO PRELIM DRAWINGS
	AF		24/03/2022	DA DRAWINGS

-	~ · · · · · · · · · · · · · · · · · · ·	
	PROPOSED ALTERATIONS AND ADDITIONS 133 UPPER CLONTARF ST. SEAFORTH	D
	CLIENT: RICHARD AND REBECCA	
	DRAWING TITLE: ELEVATIONS SHEET 1	

DATE:	DRAWN BY:	SCALE:
NOW/21	EV	1:100 @ A3
JOB No:	CHECKED BY:	DRAWING No:
970/21	JJ	DA.09

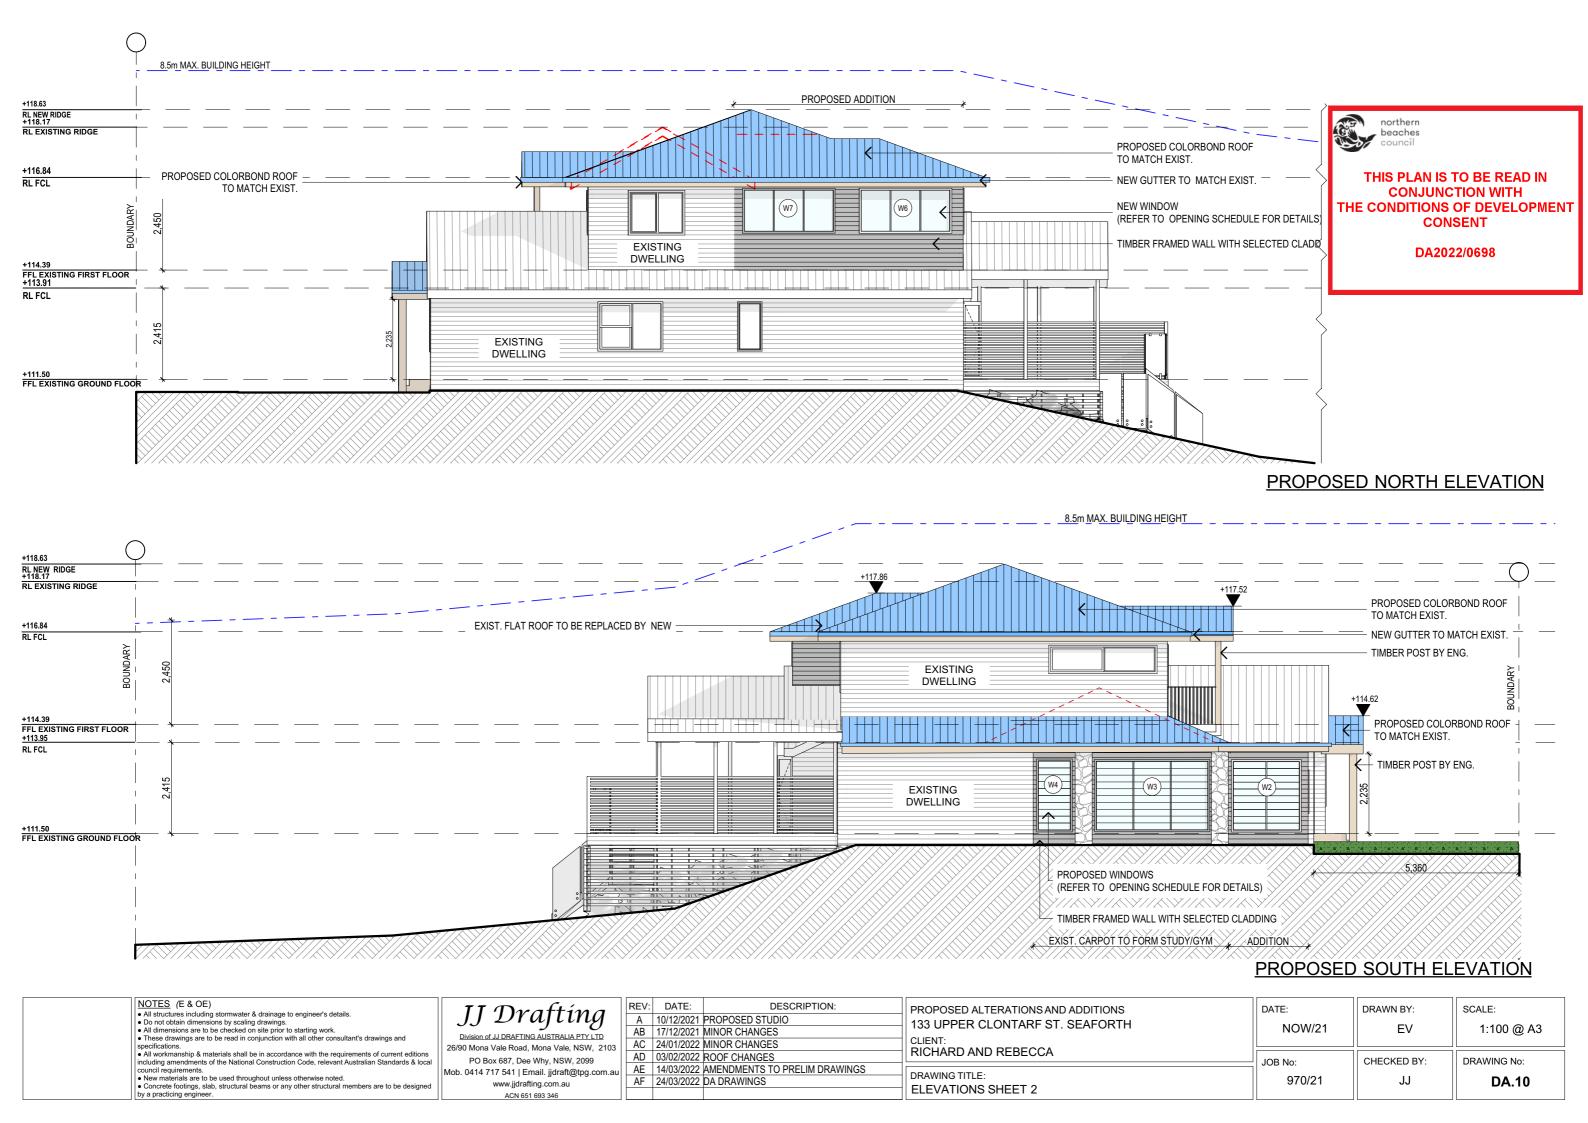

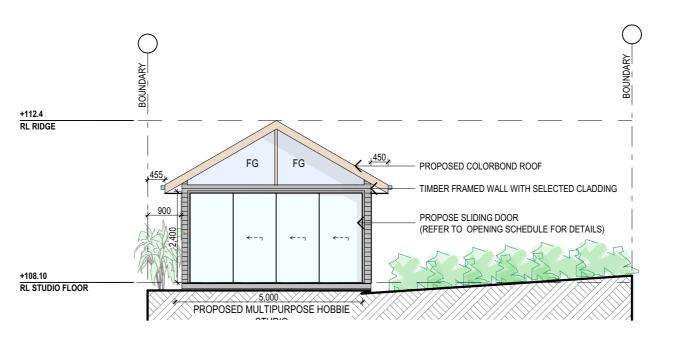




SCALE:

1:100 @ A3

**DA.11** 

DRAWING No:

## PROPOSED STUDIO EAST ELEVATION

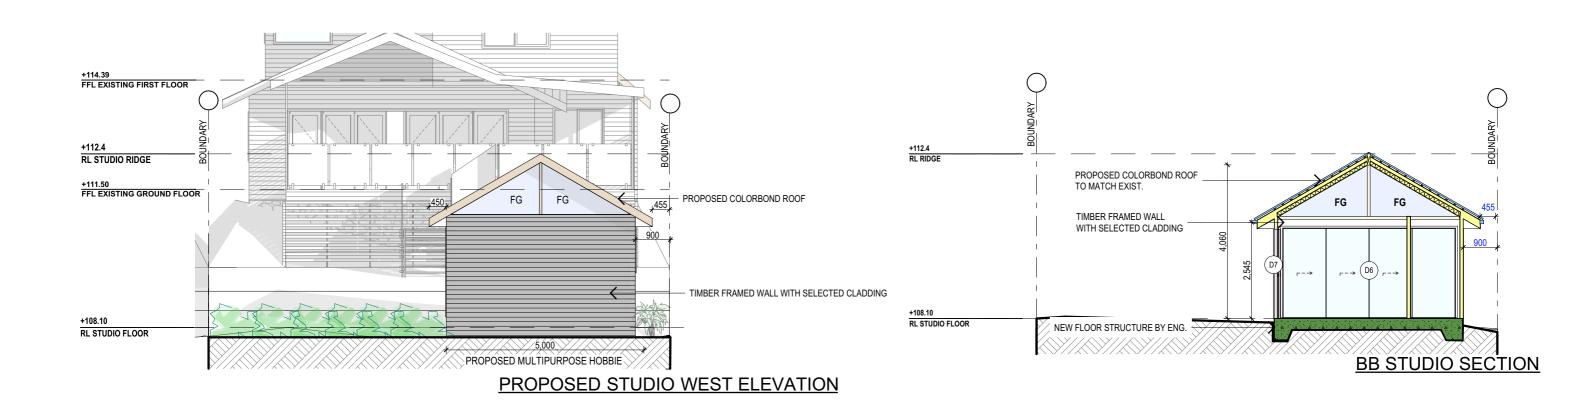

- NOTES (E & OE)

  All structures including stormwater & drainage to engineer's details.

  Do not obtain dimensions by scaling drawings.
  All dimensions are to be checked on site prior to starting work.


- by a practicing engineer.

### 26/90 Mona Vale Road, Mona Vale, NSW, 2103 PO Box 687, Dee Why, NSW, 2099 New materials are to be used throughout unless otherwise noted. Concrete footings, slab, structural beams or any other structural members are to be designed. Mob. 0414 717 541 | Email. jjdraft@tpg.com.au www.jjdrafting.com.au

ACN 651 693 346

	REV:	DATE:	DESCRIPTION:	Ш
	Α	10/12/2021	PROPOSED STUDIO	
	AB	17/12/2021	MINOR CHANGES	]
3	AC	24/01/2022	MINOR CHANGES	11 9
	AD	03/02/2022	ROOF CHANGES	]['
u	AE	14/03/2022	AMENDMENTS TO PRELIM DRAWINGS	][,
	AF	24/03/2022	DA DRAWINGS	]['
- 1				Ш

PROPOSED ALTERATIONS AND ADDITIONS 133 UPPER CLONTARF ST. SEAFORTH	DATE: NOW/21	DRAWN BY:	
CLIENT: RICHARD AND REBECCA	JOB No:	CHECKED BY:	
	JOB NO:	CHLCKLD BT.	
DRAWING TITLE: ELEVATIONS SHEET 3	970/21	JJ	

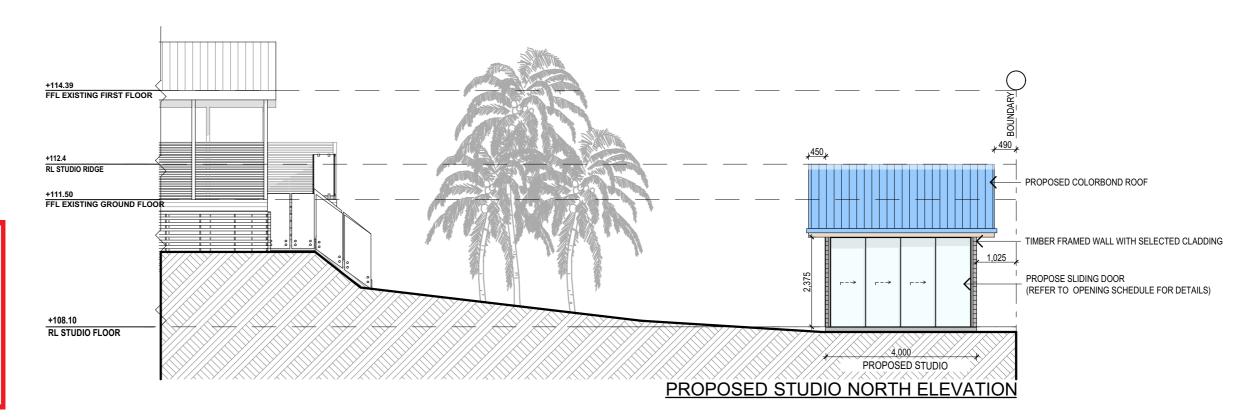



### TRUE NORTH:



northern

beaches

THIS PLAN IS TO BE READ IN **CONJUNCTION WITH** 

THE CONDITIONS OF DEVELOPMENT

CONSENT

DA2022/0698

- NOTES (E & OE)

  All structures including stormwater & drainage to engineer's details.

  Do not obtain dimensions by scaling drawings.
  All dimensions are to be checked on site prior to starting work.
- All working an indering strain be in accordance with the requirements of content editions including amendments of the National Construction Code, relevant Australian Standards & local council requirements.


   New materials are to be used throughout unless otherwise noted.

   Concrete footings, slab, structural beams or any other structural members are to be designed by a contribition analysis.

	JJ Drafting				
	Division of JJ DRAFTING AUSTRALIA PTY LTD				
	26/90 Mona Vale Road, Mona Vale, NSW, 2103				
	PO Box 687, Dee Why, NSW, 2099				
	Mob. 0414 717 541   Email. jjdraft@tpg.com.au				
1	www.jjdrafting.com.au				
╛	ACN 651 693 346				

	REV:	DATE:	DESCRIPTION:
	Α	10/12/2021	PROPOSED STUDIO
	AB	17/12/2021	MINOR CHANGES
:	AC	24/01/2022	MINOR CHANGES
	AD	03/02/2022	ROOF CHANGES
u l	AE	14/03/2022	AMENDMENTS TO PRELIM DRAWINGS
	AF	24/03/2022	DA DRAWINGS
- 1			

$\dashv$	PROPOSED ALTERATIONS AND ADDITIONS 133 UPPER CLONTARF ST. SEAFORTH CLIENT:	DATE: NOW/21	DRAWN BY:	SCALE: 1:100 @ A3
	RICHARD AND REBECCA	JOB No:	CHECKED BY:	DRAWING No:
- 1	DRAWING TITLE: ELEVATIONS SHEET 4	970/21	JJ	DA.12

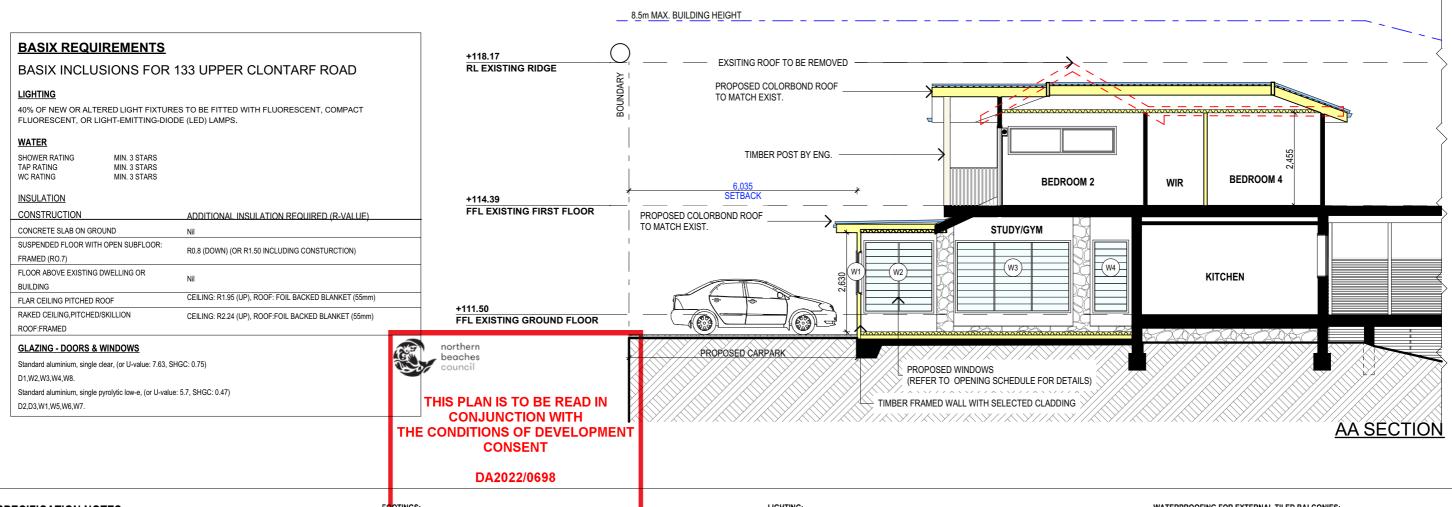

### **SPECIFICATION NOTES**

PROVIDE PLASTERBOARD LINING

INSTALL TO MANUFACTURERS SPECIFICATIONS & AS 2589

LIGHTWEIGHT TIMBER OR COMPOSITE WALL CLADDING IN ACCORDANCE WITH NCC VOL 2 PART 3.5.4.

- GROUND FLOOR TO BE REINFORCED CONCRETE SLAB IN ACCORDANCE WITH AS2870. FIRST FLOOR TO BE TIMBER FRAMED FINISHED WITH T&G HARDWOOD FLOORING.

- ALL WATERPROOFING TO AS 3740
- PROVIDE A GUARANTEED FLEXIBLE WATERPROOF MEMBRANE TO ALL WET AREA FLOORS & SHOWERS WALLS TO MANUFACTURES INSTRUCTIONS

SHALL BE INSTALLED TO COMPLY WITH AS1684 AS AMENDED FOR TIMBER COMPONENTS OR AS3620. FOR LIGHTWEIGHT STEEL FRAMING SECTIONS OR AS PER THE NASH ALTERNATIVES TO AS 3623.

ANT CAPS:
- SHALL BE INSTALLED IN ACCORDANCE WITH AS3660.

### PROFILED STEEL ROOF:

- COLORBOND ROOF CLADDING
- NCC VOL.2 PART 3.5.1.
- DESIGN AND INSTALLATION SHALL BE IN ACCORDANCE WITH AS/NZS 1562.

- SHALL BE IN ACCORDANCE WITH NCC VOL.1 PART B1.4 OR VOL.2 PART 3.2.3.
- ALL WORKMANSHIP AND MATERIALS SHALL BE IN ACCORDANCE WITH CURRENT EDITIONS OF THE

### FOOTINGS:

- FOOTINGS TO BE IN ACCORDANCE WITH NCC VOL.2 PARTS 3.2.3, 3.2.4 AND 3.2.5
- ALL REINFORCEMENTS SHALL CONFORM TO AS1302, AS1303 AND AS1304

### CARPENTRY:

- TIMBER TO COMPLY WITH AS1170.2 OR AS4055.
- ALL WORKMANSHIP AND MATERIALS SHALL BE IN ACCORDANCE WITH AS1684 AND 1720 AS APPLICABLE.

- TIMBER FRAMING:
   TO COMPLY WITH NCC VOL.2 PART 3.4
- GROUND FLOOR TIMBERS SHALL BE ONLY OF HARDWOOD, CYPRESS PINE OR PRESSURE TREATED RADIATA OR CANADA PINE BELOW A HEIGHT OF 300mm ABOVE FINISHED GROUND LEVEL AND MUST NOT BE BUILT INTO BRICKWORK.
- SUBFLOOR VENTILATION SHALL CONFORM TO NCC VOL.2 PART 3.4.1.
- IN BUSHFIRE PRONE AREAS SPECIAL CONDITIONS APPLY.
   WHERE TERMITE BARRIERS NEED TO BE INSPECTED, 400mm CLEARANCE IS REQUIRED BETWEEN THE UNDERSIDE OF BEARER AND GROUND SURFACE.
- USE TREATED TIMBER WHERE REQUIRED FOR DURABILITY.
   DO NOT USE TIMBER UNSUITABLE FOR EXPOSURE TO MOISTURE IN EXPOSED LOCATION.
- PROVIDE STRUCTURE BRACING IN ACCORDANCE WITH AS1684
- PROVIDE STRUCTURE TIEDOWN IN ACCORDANCE WITH AS1684 - USE GALVANISED FIXINGS WHERE EXPOSED TO WEATHER.

- TERMITE CONTROL:
   TO BE IN ACCORDANCE WITH TO AS3660.1
- SHALL BE IN ACCORDANCE WITH NCC VOL.2 PART 3.1.4 OR VOL.1 PART B1.4.

### FLASHING AND CAPPINGS:

- SELECTION AND INSTALLATION OF METAL RAINWATER GOODS REFER TO AS2180.
- FLASH PROJECTIONS ABOVE THE ROOF WITH TWO PART FLASHINGS CONSISTING OF AN APRON
- FLASHING AND OVER FLASHING, WITH AT LEAST 100mm OVERLAP. - PROVIDE FOR INDEPENDENT MOVEMENT BETWEEN ROOF AND PROJECTION

### CONCRETE BLOCKS OR BRICKS:

TO COMPLY WITH TO AS4455 MASONRY BUILDING BLOCKS/PAVER.

- 40% OF NEW OR ALTERED LIGHT FIXTURES TO BE FITTED WITH FLUORESCENT, COMPACT FLUORESCENT, OR LIGHT-EMITTING-DIODE (LED) LAMPS

### DOORS & WINDOWS:

- ALL FRAMED WINDOWS SHALL BE INSTALLED IN ACCORDANCE WITH AS2047-48 FOR ALUMINIUM WINDOWS AND AS2047 FOR TIMBER WINDOWS. ALUMINIUM FRAMED WINDOWS AND DOORS
- WEATHER STRIPPING IS TO BE PROVIDED TO ALL EXTERNAL WINDOWS AND DOORS.

### STAIRS, HANDRAILS AND BALUSTRADES:

- NCC VOL.2 PARTS 3.9.1 AND 3.9.2
- RELATIONSHIP OF RISER TO GOING SHALL BE BETWEEN 1:2 AND 1:1.35 UNLESS OTHERWISE DIRECTED TO GOING SHALL BE BETWEEN 1:2 AND 1:1.35 UNLESS OTHERWISE DIRECTED OR AS PERMITTED IN
- BALUSTRADES SHALL BE PROVIDED TO ALL LANDINGS, RAMPS, DECKS, ROOFS AND OTHER ELEVATED PLATFORMS WHERE THE VERTICAL DISTANCE FROM THAT LEVEL IS MORE THAN 1m ABOVE THE ADJOINING FLOOR OR FINISHED GROUND LEVEL.
- THE HEIGHT OF BALUSTRADE MUST BE A MINIMUM OF 1m HIGH ABOVE LANDING AND NOT LESS THAN 865mm ABOVE THE NOSINGS OF ANY STAIR TREADS OR FLOOR RAMP AND HAVE NO OPENING GREATER THAN 125mm
- THE HEIGHT OF BALUSTRADE TO THE NEW STAIRCASES IS TO BE MEASURED A MINIMUM 865mm ABOVE THE NOSING LINE AND HAVE NO OPENING GREATER NO OPENING GREATER THAN 125mm

- MATERIALS TO BE USED FOR SURFACES OF FLOORS, STAIR LANDING, STEPS AND NOSINGS SHALL BE IN ACCORDANCE WITH THE CLASSIFICATIONS FOR SLIP RESISTANCE AS APPLY IN AS4586 AND HB198.

### STORMWATER:

### EAVES GUTTERS, VALLEY GUTTERS AND DOWPIPES

- TO COMPLY WITH AS/NZS 2179 FOR METAL AND AS1273 FOR UPVC COMPONENTS.
- IN ACCORDANCE WITH NCC VOL 2 PART 3.5.3
- NEW DOWNPIPES TO BE CONNECTED INTO EXISTING STORMWATER LINE
- COLORBOND GUTTERS AND DOWNPIPES
- MINIMUM SLOPE OF EAVES AND GUTTERS 1:200

### WATERPROOFING FOR EXTERNAL TILED BALCONIES:

- WATERPROOFING TO COMPLY WITH AS4654

-NCC VOL.1 PARTS B 1.4, D 3.12, F1.13 OR NCC VOL.2 PART 3.6

### SMOKE DETECTORS/ALARMS:

- NCC VOL 2 PART 3.7.5. FIRE/SMOKE DETECTORS COMPLYING WITH THE REQUIREMENTS OF THE LOCAL GOVERNMENT ACT AND/OR STATE OR TERRITORY REGULATIONS MUST BE FITTED IN THE LOCATIONS REQUIRED AND APPROVED BY THE AUTHORITY AND SHALL BE INSTALLED IN ACCORDANCE WITH AS3786. - INSTALLATIONS IN BUILDINGS OTHER THAN CLASS 1 AND 10 MUST BE INSTALLED AND MANAGED TO COMPLY WITH NCC SPEC. E2.2a.
- MULTIPLE ALARMS WITHIN HOUSES AND SOLE OCCUPANCY UNITS MUST BE HARD WIRED AND INTERCONNECTED.

### WASTE MANAGEMENT:

- ALL WASTE SHALL BE TAKEN AWAY BY TRUCKS TO A SUITABLE LANDFILL OR RECYCLE DEPOT.
- ALL WASTE SHALL BE COVERED DURING TRANSPORTATION.
- WASTE GENERATED DURING CONSTRUCTION SHALL BE PLACED IN STEEL BINS AND TAKEN AWAY BY AN APPROVED CONTRACTOR TO A APPROVED LANDFILL SITE.

### SEDIMENT CONTROL:

- A FILTER CLOTH SYSTEM SHALL BE INSTALLED TO STOP ANY SEDIMENT ENTERING COUNCILS STORMWATER SYSTEM.

ALL PLANS ARE TO BE READ IN CONJUNCTION AND COMPLY WITH THE BASIX CERTIFICATE, BUSHFIRE AND GEOTECH REPORTS.

NOTES (E & OE)

- All structures including stormwater & drainage to engineer's de
  Do not obtain dimensions by scaling drawings.
  All dimensions are to be checked on site prior to starting work
- All workmanship & materials shall be in accordance with the requirements of current editions

These drawings are to be read in conjunction with all other consultant's drawings and

- cluding amendments of the National Construction Code, relevant Australian Sta New materials are to be used throughout unless otherwise noted.
   Concrete footings, slab, structural beams or any other structural members are to be designed.
- by a practicing engineer.

26/90 Mona Vale Road PO Box 687, De Mob. 0414 717 541 | E www.iidra

Docaftina	REV:	DATE:	DESCRIPTION:
Drafting	Α	10/12/2021	PROPOSED STUDIO
J DRAFTING AUSTRALIA PTY LTD	AB	17/12/2021	MINOR CHANGES
ale Road, Mona Vale, NSW, 2103	AC	24/01/2022	MINOR CHANGES
687, Dee Why, NSW, 2099	AD	03/02/2022	ROOF CHANGES
7 541   Email. jjdraft@tpg.com.au	AE	14/03/2022	AMENDMENTS TO PRELIM DRAWINGS
ww.jjdrafting.com.au	AF	24/03/2022	DA DRAWINGS
ACN 651 693 346			

PROPOSED ALTERATIONS AND ADDITIONS 133 UPPER CLONTARF ST. SEAFORTH
CLIENT: RICHARD AND REBECCA
DRAWING TITLE: SECTION / BASIX

DATE: NOW/21	DRAWN BY:	SCALE: 1:100 @ A3
JOB No: 970/21	CHECKED BY:	DRAWING No: DA.13