

# EXISTING GROUND FLOOR PLAN

## GROSS FLOOR AREA - GROUND FLOOR

EXISTING GFO (EXCL GARAGE)

140.30m<sup>2</sup>

TRUE NORTH:

- NOTES (E & OE)

  All structures including stormwater & drainage to engineer's details.

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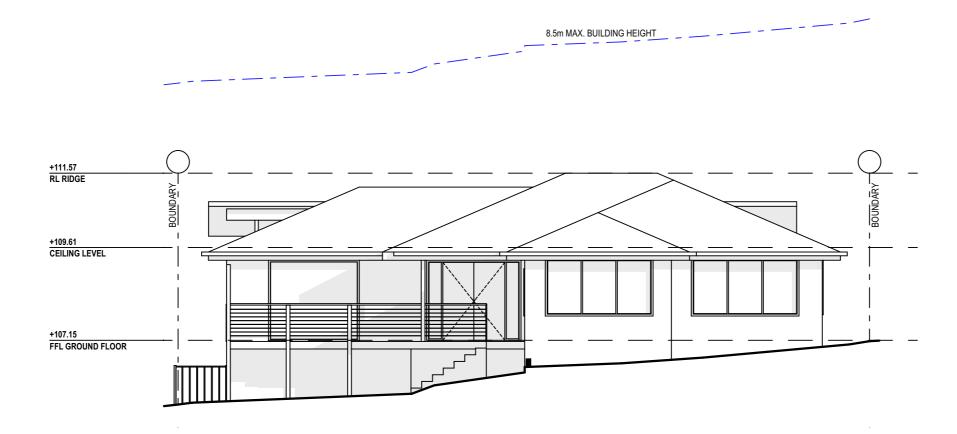
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┪	PROJECT DETAILS: PROPOSED ALTERATIONS AND ADDITIONS 18 EBOR ROAD PALM BEACH	DATE: 09/21	DRAWN BY:	SCALE: 1:100 @ A3
	DRAWING TITLE: EXISTING GROUND FLOOR PLAN	JOB No: 850A/20	CHECKED BY:	DRAWING No: DA.02



# **EXISTING NORTH ELEVATION**



# **EXISTING EAST ELEVATION**

	<u>NOTES</u>	(E & OE)
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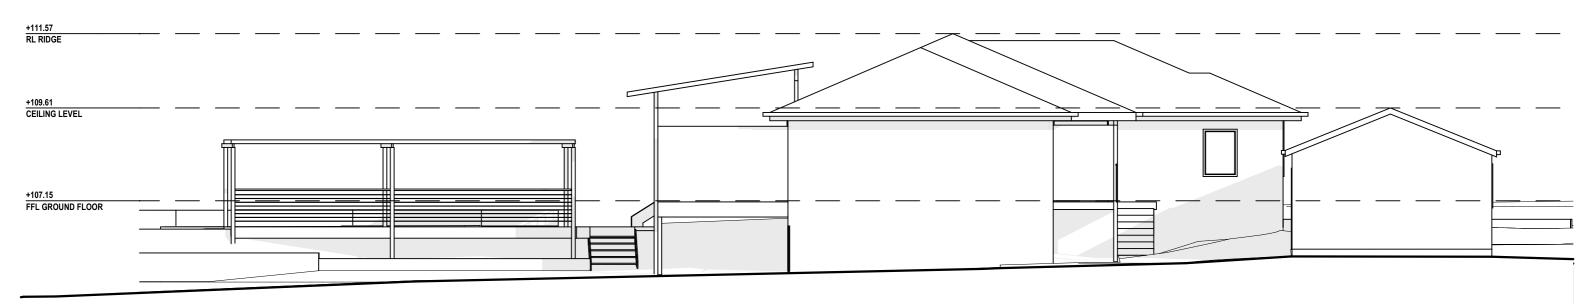
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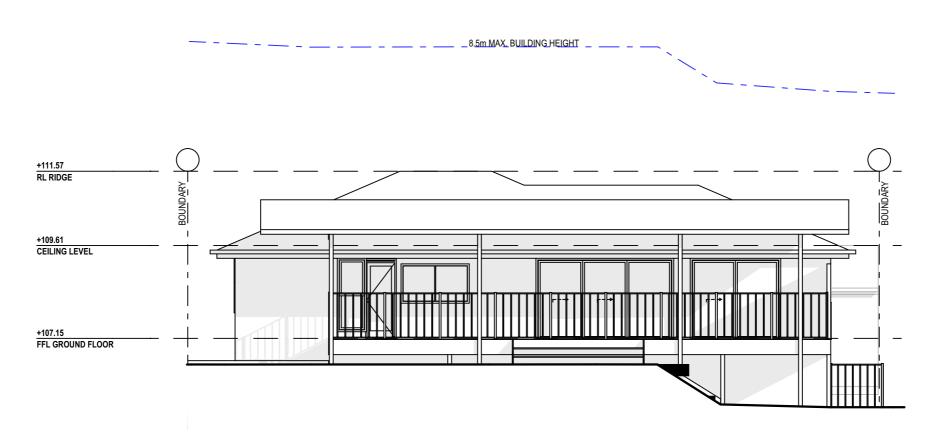
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DRAWING TITLE: EXISTING ELEVATIONS SHEET 1	JOB No: 850A/20	CHECKED BY:	DRAWING No:  DA.03





## **EXISTING WEST ELEVATION**

**EXISTING SOUTH ELEVATION** 

NOTES	(E & OE)
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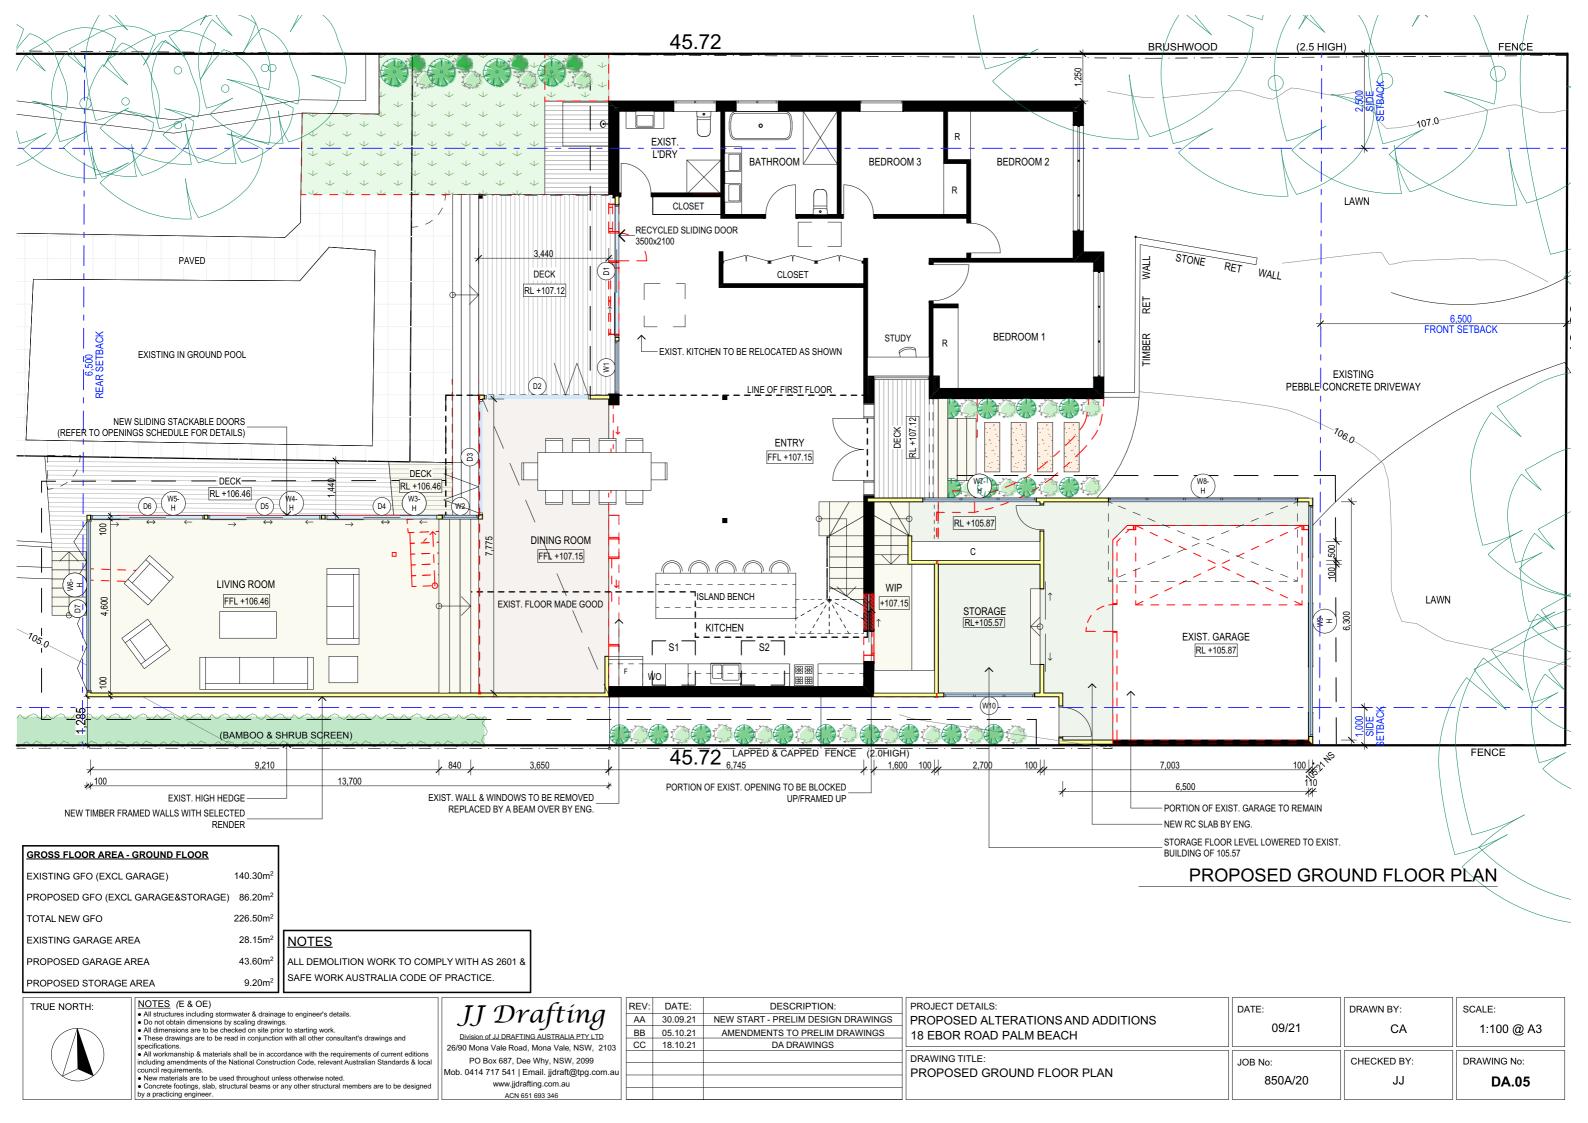
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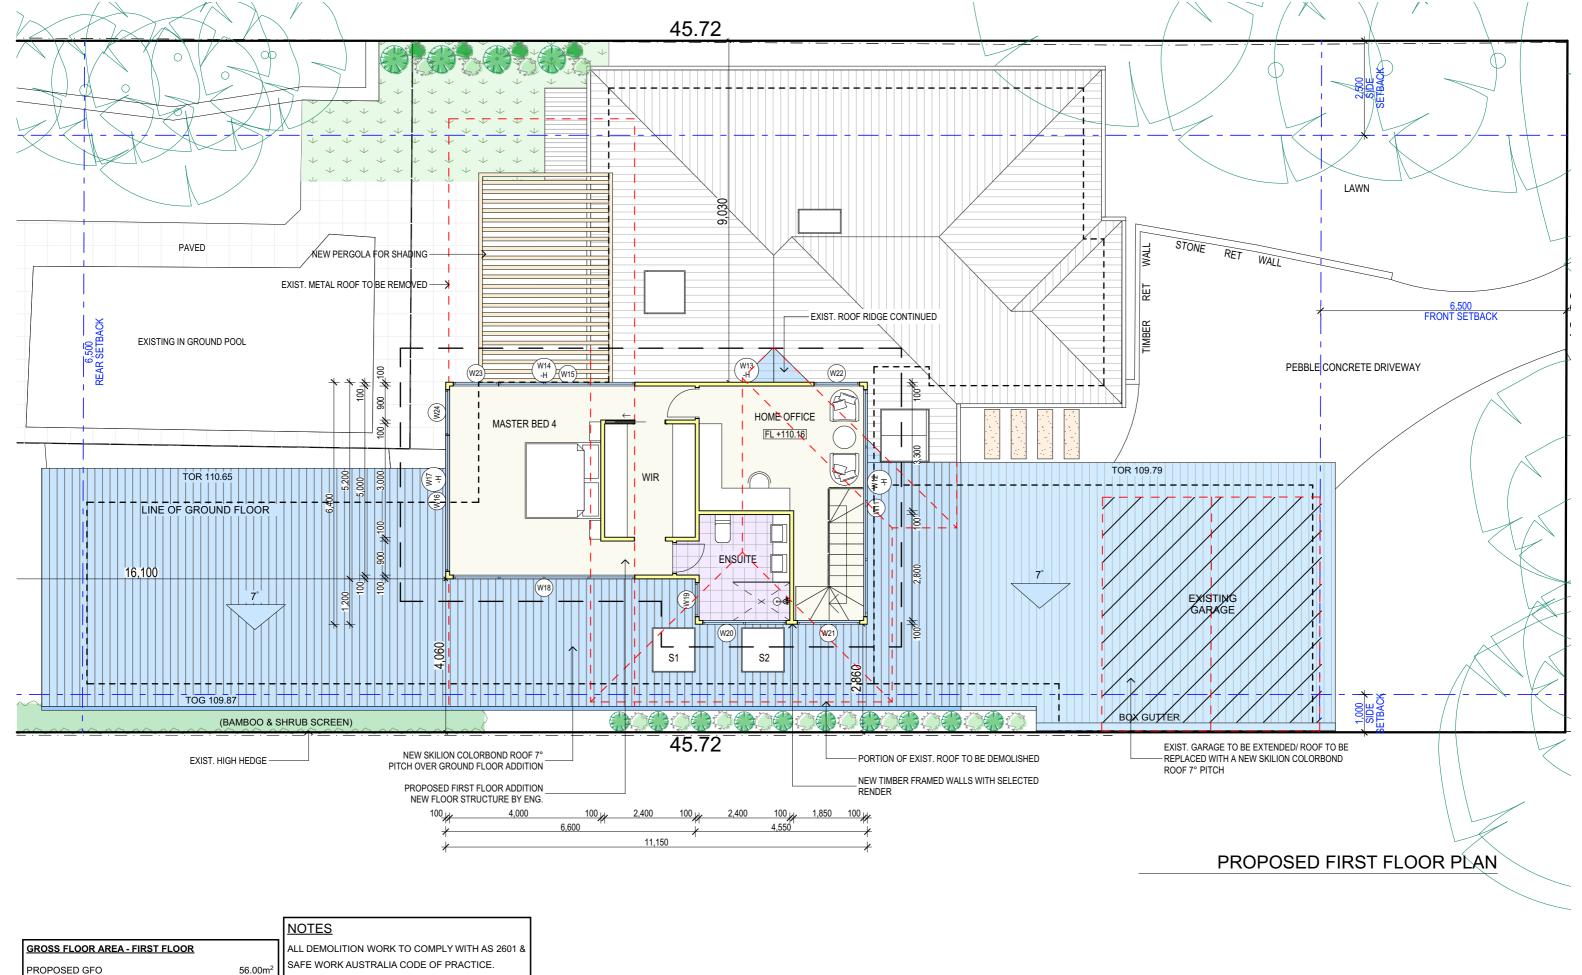
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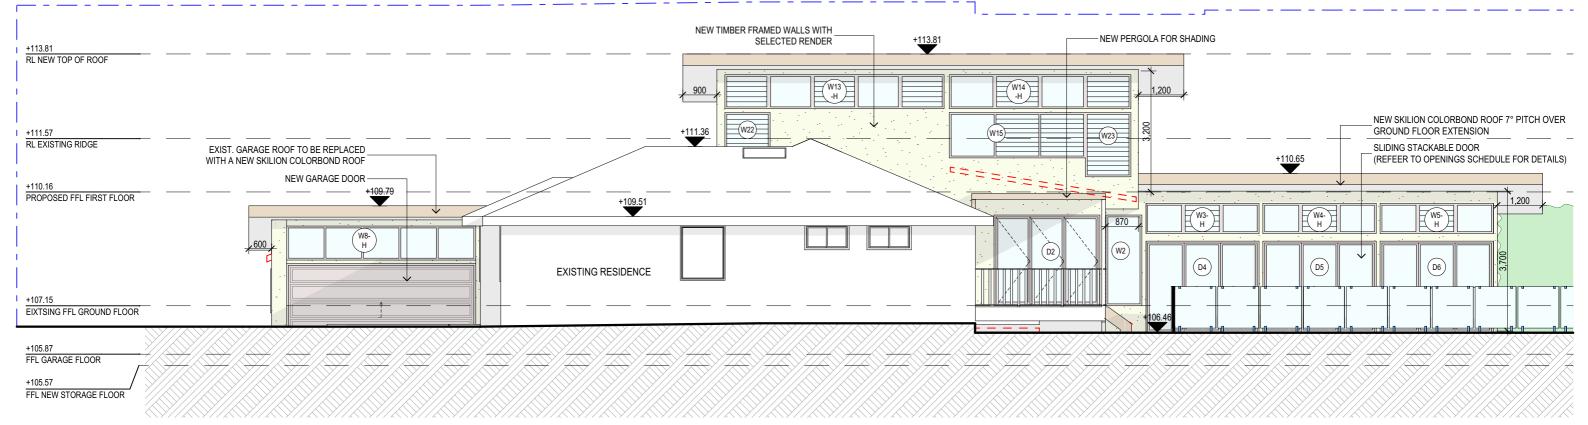
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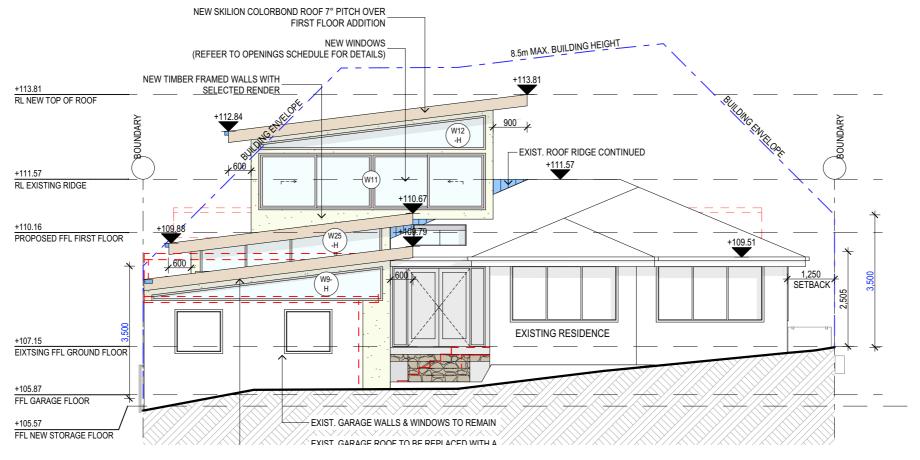
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DRAWING TITLE: PROPOSED FIRST FLOOR PLAN	JOB No: 850A/20	CHECKED BY:	DRAWING No: DA.06







- NOTES (E & OE)

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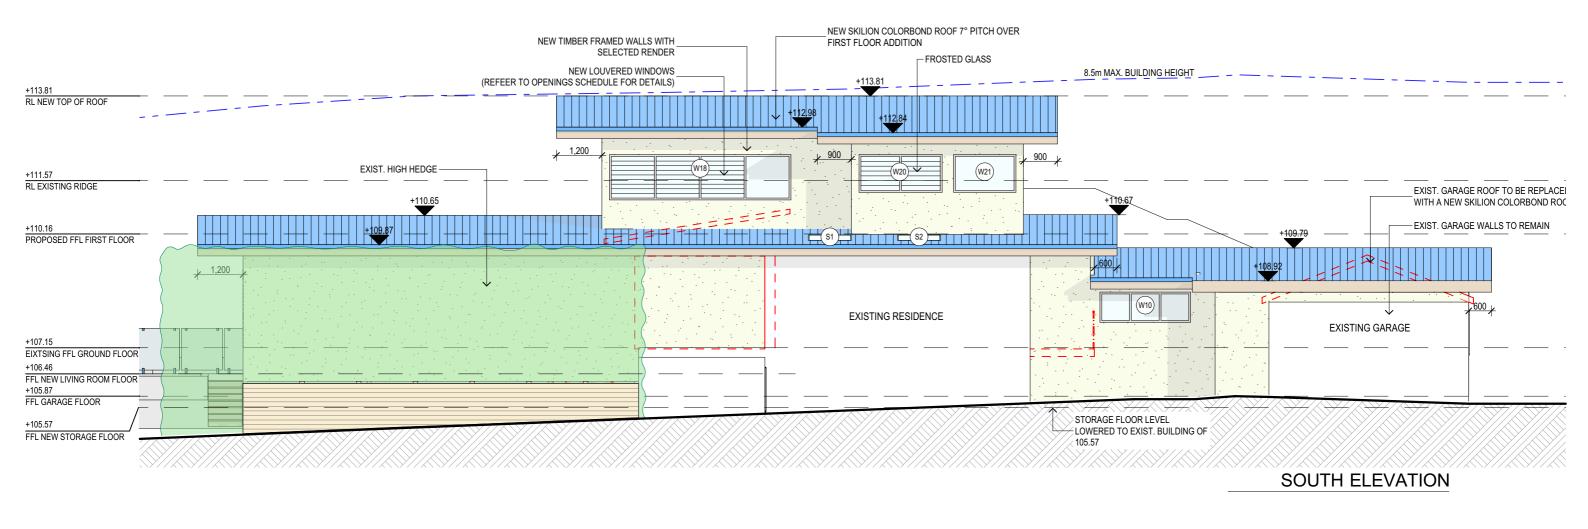
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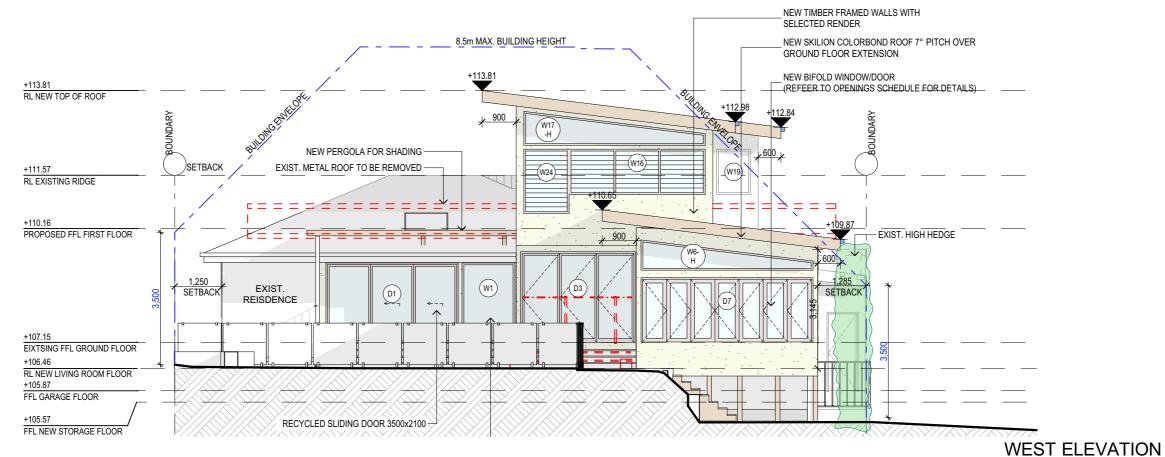
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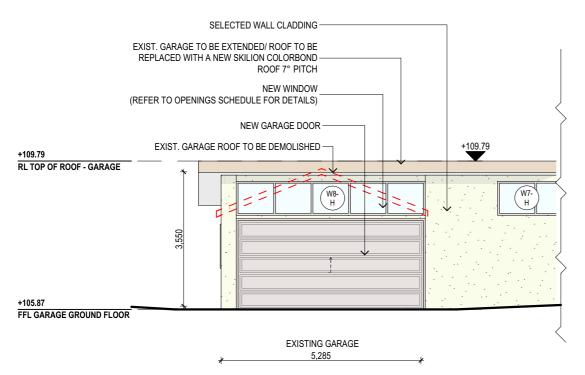
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#### NOTES (E & OE) JJ Drafting PROJECT DETAILS: REV: DATE: DESCRIPTION: DATE: DRAWN BY: SCALE: All structures including stormwater & drainage to engineer's details Do not obtain dimensions by scaling drawings. All dimensions are to be checked on site prior to starting work. AA 30.09.21 NEW START - PRELIM DESIGN DRAWINGS PROPOSED ALTERATIONS AND ADDITIONS 09/21 CA 1:100 @ A3 BB 05.10.21 AMENDMENTS TO PRELIM DRAWINGS 18 EBOR ROAD PALM BEACH . These drawings are to be read in conjunction with all other consultant's drawings and CC 18.10.21 DA DRAWINGS 26/90 Mona Vale Road, Mona Vale, NSW, 2103 DRAWING TITLE: PO Box 687, Dee Why, NSW, 2099 DRAWING No: Naw monthlainship a finaterials start bethin accordance with one requirements or current evident including amendments of the National Construction Code, relevant Australian Standards & loca council requirements. New materials are to be used throughout unless otherwise noted. Concrete footings, slab, structural beams or any other structural members are to be designed. CHECKED BY: JOB No: Mob. 0414 717 541 | Email. jjdraft@tpg.com.au PROPOSED ELEVATIONS SHEET 2 850A/20 **DA.08** www.jjdrafting.com.au by a practicing engineer. ACN 651 693 346

8.5m MAX. BUILDING HEIGHT 8.5m MAX. BUILDING HEIGHT



## GARAGE NORTH ELEVATION

SELECTED WALL CLADDING EXIST. GARAGE TO BE EXTENDED/ ROOF TO BE REPLACED WITH A NEW SKILION COLORBOND ROOF 7° PITCH EXIST. GARAGE ROOF TO BE DEMOLISHED EXIST. GARAGE WALLTO REMAIN +109 79 +109.79 RL TOP OF ROOF - GARAGE EXISTING GARAGE STORAGE +105.87 FFL GARAGE GROUND FLOOR EXISTING GARAGE

8.5m MAX. BUILDING HEIGHT

## TRUE NORTH:



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**GARAGE SOUTH ELEVATION** 

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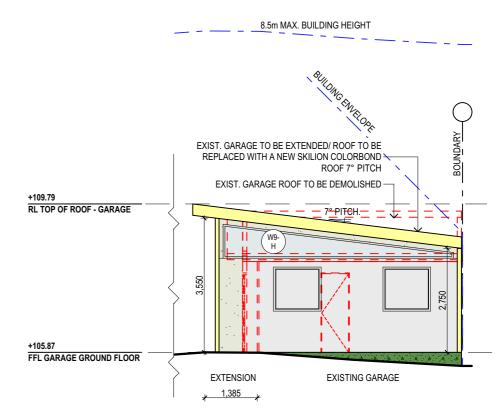
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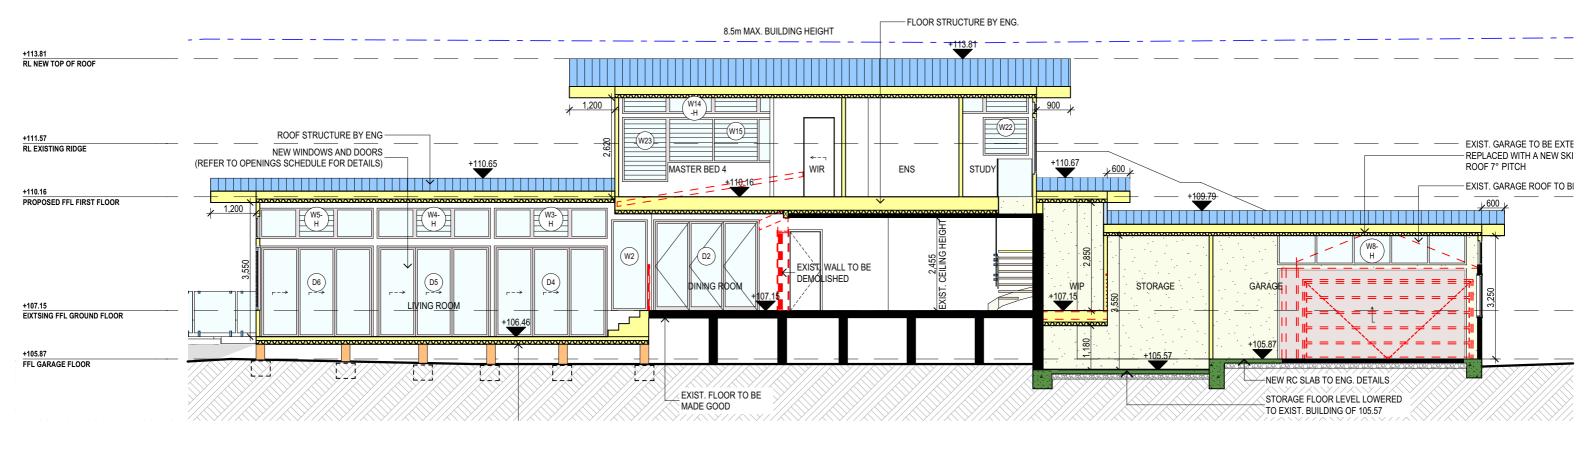
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## **GARAGE EAST ELEVATION**



## **GARAGE WEST ELEVATION**

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DRAWING TITLE:	JOB No:	CHECKED BY:	DRAWING No:
GARAGE ELEVATIONS	850A/20	JJ	DA.09



## **SECTION**

NOTES (E & OE)

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by a practicing engineer.

# $\overline{JJ}$ Drafting

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DRAWING TITLE: SECTION	JOB No: 850A/20	CHECKED BY:	DRAWING No: DA.10

### **BASIX REQUIREMENTS**

BASIX INCLUSIONS FOR 18 EBOR ROAD, PALM BEACH 2108.

40% OF NEW OR ALTERED LIGHT FIXTURES TO BE FITTED WITH FLUORESCENT, COMPACT FLUORESCENT, OR LIGHT-EMITTING-DIODE (LED) LAMPS.

SHOWER RATING MIN. 3 STARS TAP RATING MIN. 3 STARS WC RATING MIN 3 STARS

### INSULATION

ADDITIONAL INSULATION REQUIRED (R-VALUE)
R0.8 (DOWN) (OR R1.50 INCLUDING CONSTRUCTION)
R1.30 (OR R1.70 INCLUDING CONSTRUCTION)
NIL
CEILING: R2.24 (UP), ROOF: FOIL BACKED BLANKET (55mm) MEDIUM (SOLAR ABSORPTANCE 0.475-0.70)
NIL

#### **GLAZING - DOORS & WINDOWS**

STANDARD ALUMINIUM, SINGLE CLEAR, (OR U-VALUE: 7.63, SHGC: 0.75)

W1, W2, W3-H, W4-H, W5-H, W6-H, W7-H, W10, W11, W12-H, W13-H, W14-H, W15, W16, W17-H, W18, W19, W20, W21, W22, W23, W24, W25-H, D1, D2, D3, D4, D5, D6, D7.

STANDARD ALUMINIUM, SINGLE PYROLYTIC LOW-E, (OR U-VALUE: 5.7, SHGC: 0.47)

W8-H, W9-H

TIMBER, LOW-E INTERNAL/ARGON FILL/CLEAR EXTERNAL, (OR U-VALUE: 2.5, SHGC: 0.456)

S1, S2.

### **SPECIFICATION NOTES**

PROVIDE PLASTERBOARD LINING.

- INSTALL TO MANUFACTURERS SPECIFICATIONS & AS 2589

#### EXTERNAL WALLS:

- LIGHTWEIGHT TIMBER CLADDING OR SIMILAR.

- FIRST FLOOR TO BE TIMBER FRAMED FINISHED WITH T&G HARDWOOD FLOORING.

### WET AREAS:

- ALL WATERPROOFING TO AS 3740

- PROVIDE A GUARANTEED FLEXIBLE WATERPROOF MEMBRANE TO ALL WET AREA FLOORS & SHOWERS WALLS TO MANUFACTURES INSTRUCTIONS

- SHALL BE INSTALLED TO COMPLY WITH AS1684 AS AMENDED FOR TIMBER COMPONENTS OR AS3620 FOR LIGTHWEIGHT STEEL FRAMING SECTIONS OR AS PER THE NASH ALTERNATIVES TO AS 3623.

- SHALL BE INSTALLED IN ACCORDANCE WITH AS3660.

#### PROFILED STEEL ROOF:

- DESIGN AND INSTALLATION SHALL BE IN ACCORDANCE WITH AS/NZS 1562.

COLORBOND ROOF CLADDING

- SHALL BE IN ACCORDANCE WITH NCC VOL.1 PART B1.4 OR VOL.2 PART 3.2.3. - ALL WORKMANSHIP AND MATERIALS SHALL BE IN ACCORDANCE WITH CURRENT EDITIONS OF THE

- -FOOTINGS TO BE IN ACCORDANCE WITH AS1480.
   FOOTINGS TO BE IN ACCORDANCE WITH NCC VOL.2 PARTS 3.2.3, 3.2.4 AND 3.2.5
- ALL REINFORCEMENTS SHALL CONFORM TO AS1302, AS1303 AND AS1304

BRICK AND BLOCKWORK:
- CONSTRUCTION OF MASONRY BUILDINGS SHALL BE AS PER AS3700 OR AS4773.

- TIMBER TO COMPLY WITH AS1170.2 OR AS4055.
- ALL WORKMANSHIP AND MATERIALS SHALL BE IN ACCORDANCE WITH AS1684 AND 1720 AS APPLICABLE.

- TO COMPLY WITH NCC VOL 2 PART 3 4
- GROUND FLOOR TIMBERS SHALL BE ONLY OF HARDWOOD, CYPRESS PINE OR PRESSURE TREATED RADIATA OR CANADA PINE BELOW A HEIGHT OF 300mm ABOVE FINISHED GROUND LEVEL AND MUST NOT BE BUILT INTO BRICKWORK.
- SUBFLOOR VENTILATION SHALL CONFORM TO NCC VOL.2 PART 3.4.1.
- IN BUSHFIRE PRONE AREAS SPECIAL CONDITIONS APPLY.
- WHERE TERMITE BARRIERS NEED TO BE INSPECTED, 400mm CLEARANCE IS REQUIRED BETWEEN THE UNDERSIDE OF BEARER AND GROUND SURFACE.
- USE TREATED TIMBER WHERE REQUIRED FOR DURABILITY.
- DO NOT USE TIMBER UNSUITABLE FOR EXPOSURE TO MOISTURE IN EXPOSED LOCATION.
- PROVIDE STRUCTURE BRACING IN ACCORDANCE WITH AS1684 - PROVIDE STRUCTURE TIEDOWN IN ACCORDANCE WITH AS1684
- USE GALVANISED FIXINGS WHERE EXPOSED TO WEATHER.

### TERMITE CONTROL:

- TO BE IN ACCORDANCE WITH TO AS3660 1
- SHALL BE IN ACCORDANCE WITH NCC VOL.2 PART 3.1.3 OR VOL.1 PART B1.4.

- SELECTION AND INSTALLATION OF METAL RAINWATER GOODS REFER TO AS2180
- FLASH PROJECTIONS ABOVE THE ROOF WITH TWO PART FLASHINGS CONSISTING OF AN APRON FLASHING AND OVER FLASHING, WITH AT LEAST 100mm OVERLAP.
- PROVIDE FOR INDEPENDENT MOVEMENT BETWEEN ROOF AND PROJECTION.

### CONCRETE BLOCKS OR BRICKS:

TO COMPLY WITH TO AS4455 MANSORY BUILDING BLOCKS/PAVER.

- 40% OF NEW OR ALTERED LIGHT FIXTURES TO BE FITTED WITH FLUORESCENT, COMPACT

- ALL FRAMED WINDOWS SHALL BE INSTALLED IN ACCORDANCE WITH AS2047-48 FOR ALUMINIUM WINDOWS AND AS2047 FOR TIMBER WINDOWS.
- ALUMINIUM FRAMED WINDOWS AND DOORS
- WEATHER STRIPPING IS TO BE PROVIDED TO ALL EXTERNAL WINDOWS AND DOORS.

#### STAIRS, HANDRAILS AND BALUSTRADES:

- NCC VOL.2 PARTS 3.9.1 AND 3.9.2
- RELATIONSHIP OF RISER TO GOING SHALL BE BETWEEN 1:2 AND 1:1.35 UNLESS OTHERWISE DIRECTED TO GOING SHALL BE BETWEEN 1:2 AND 1:1.35 UNLESS OTHERWISE DIRECTED OR AS PERMITTED IN
- BALUSTRADES SHALL BE PROVIDED TO ALL LANDINGS, RAMPS, DECKS, ROOFS AND OTHER ELEVATED PLATFORMS WHERE THE VERTICAL DISTANCE FROM THAT LEVEL IS MORE THAN 1m ABOVE THE ADJOINING FLOOR OR FINISHED GROUND LEVEL.
- THE HEIGHT OF BALUSTRADE MUST BE A MINIMUM OF 1m HIGH ABOVE LANDING AND NOT LESS THAN 865mm ABOVE THE NOSINGS OF ANY STAIR TREADS OR FLOOR RAMP AND HAVE NO OPENING GREATER THAN 125mm
- THE HEIGHT OF BALUSTRADE TO THE NEW STAIR CASES IS TO BE MEASURED A MINIMUM 865mm ABOVE THE NOSING LINE AND HAVE NO OPENING GREATER NO OPENING GREATER THAN 125mm.

- MATERIALS TO BE USED FOR SURFACES OF FLOORS, STAIR LANDING, STEPS AND NOSINGS SHALL BE IN ACCORDANCE WITH THE CLASSIFICATIONS FOR SLIP RESISTANCE AS APPLY IN AS4586 AND HB198

#### STORMWATER:

## EAVES GUTTERS. VALLEY GUTTERS AND DOWPIPES

- TO COMPLY WITH AS/NZS 2179 FOR METAL AND AS1273 FOR UPVC COMPONENTS.
- NEW DOWNPIPES TO BE CONNECTED INTO EXISTING STORMWATER LINE
- COLORBOND GUTTERS AND DOWNPIPES
- MINIMUM SLOPE OF FAVES AND GUTTERS 1:200

- NCC VOL.1 PARTS B 1.4, D 3.12, F1.13 OR NCC VOL.2 PART 3.6

#### SMOKE DETECTORS/ALARMS:

- ONCE VOL 2 PART 3.7.2, FIRE/SMOKE DETECTORS COMPLYING WITH THE REQUIREMENTS OF THE LOCAL GOVERNMENT ACT AND/OR STATE OR TERRITORY REGULATIONS MUST BE FITTED IN THE LOCATIONS REQUIRED AND APPROVED BY THE AUTHORITY AND SHALL BE INSTALLED IN ACCORDANCE WITH AS3786. - INSTALLATIONS IN BUILDINGS OTHER THAN CLASS 1 AND 10 MUST BE INSTALLED AND MANAGED TO COMPLY WITH NCC SPEC. E2.2a.
- MULTIPLE ALARMS WITHIN HOUSES AND SOLE OCCUPANCY UNITS MUST BE HARD WIRED AND INTERCONNECTED.

## WASTE MANAGEMENT:

SEDIMENT CONTROL:

STORMWATER SYSTEM

- ALL WASTE SHALL BE TAKEN AWAY BY TRUCKS TO A SUITABLE LANDFILL OR RECYCLE DEPOT. - ALL WASTE SHALL BE COVERED DURING TRANSPORTATION.
- WASTE GENERATED DURING CONSTRUCTION SHALL BE PLACED IN STEEL BINS AND TAKEN AWAY BY AN APPROVED CONTRACTOR TO A APPROVED LANDFILL SITE.

- A FILTER CLOTH SYSTEM SHALL BE INSTALLED TO STOP ANY SEDIMENT ENTERING COUNCILS

#### NOTE:

ALL PLANS ARE TO BE READ IN CONJUNCTION AND COMPLY WITH THE BASIX CERTIFICATE. BUSHFIRE AND GEOTECH REPORTS.

NOTES (E & OE)

by a practicing engineer.


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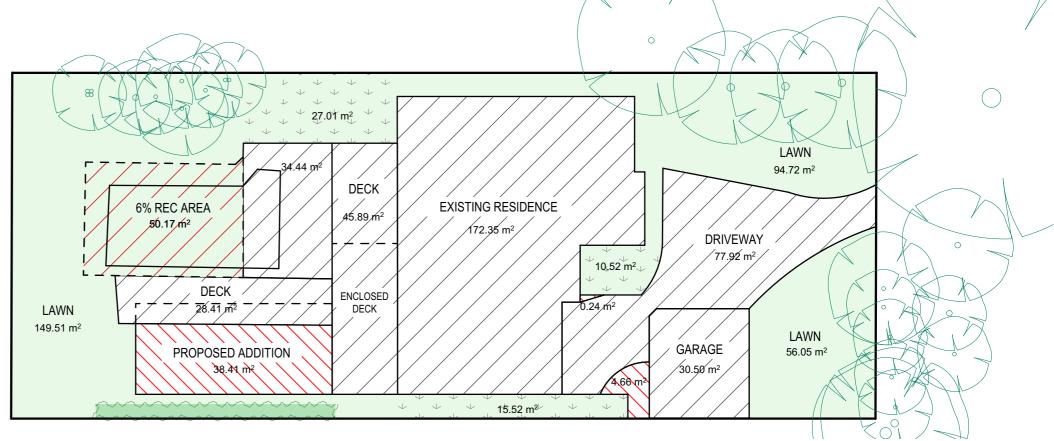
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## **EXISTING LANDSCAPED AREA CALCULATIONS**



# PROPOSED LANDSCAPED AREA CALCULATIONS

SITE AREA		836.1m <sup>2</sup>	
LANDSCAPE CONTROL	60%	501.66m <sup>2</sup>	
6% OUTDOOR RECREATIONAL AREA	6 OUTDOOR RECREATIONAL AREA		50.17m <sup>2</sup>
EXISTING LANDSCAPED AREA		48.26%	403.52m <sup>2</sup>
TOTAL LANDSCAPE AREA			53.05m <sup>2</sup>
		48.26%	403.52m <sup>2</sup>
EXISTING HARD SURFACE AREA		51.74%	432.58m²
HARD SURFACE AREA TO BE RETAINED			389.51m <sup>2</sup>
NEW HARD SURFACE AREA			43.07m <sup>2</sup>
TOTAL HARD SURFACE AREA		51.74%	432.58m²

## TRUE NORTH:

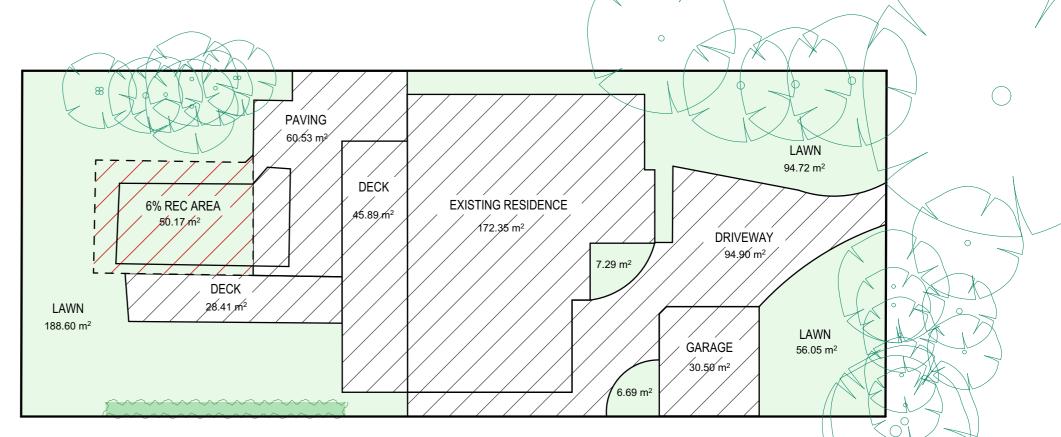**CALCULATIONS** 

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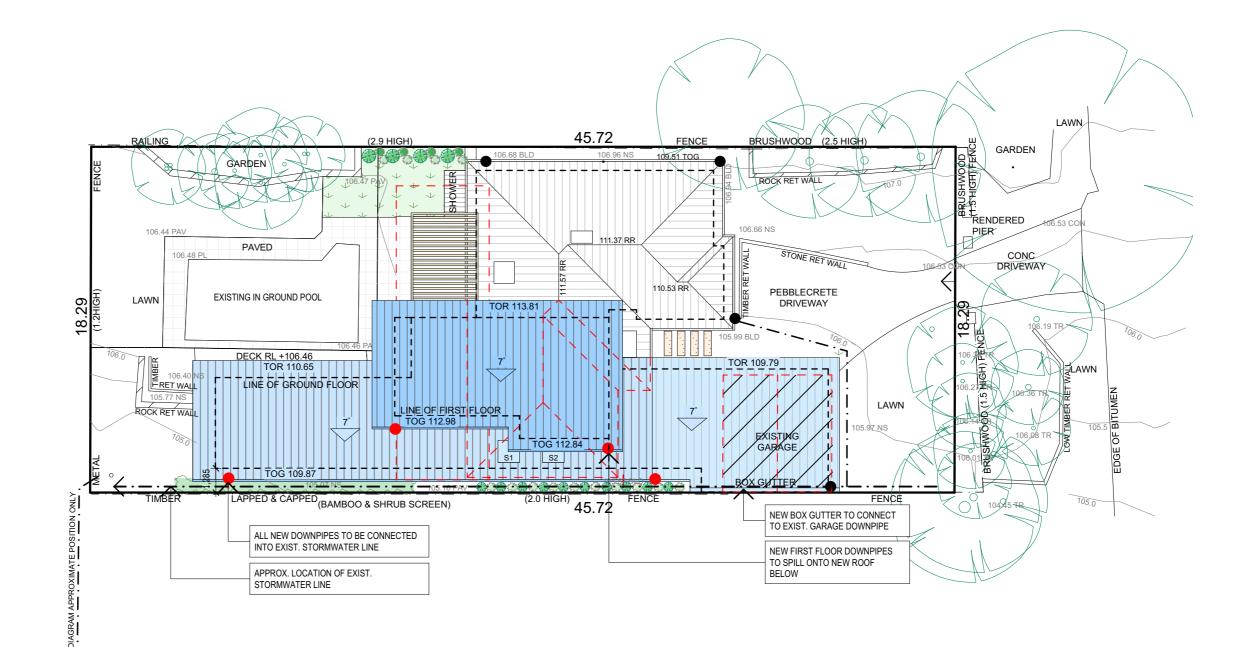
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## STORMWATER CONCEPT LEGEND

EXISTING DOWNPIPES

**NEW DOWNPIPES** 

EXISTING STORWATER LINE

NEW STORMWATER LINE

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   Concrete footings, slab, structural beams or any other structural members are to be designed.
- by a practicing engineer.

# JJ Drafting

26/90 Mona Vale Road, Mona Vale, NSW, 2103 PO Box 687, Dee Why, NSW, 2099 Mob. 0414 717 541 | Email. jjdraft@tpg.com.au www.jjdrafting.com.au ACN 651 693 346

	REV:	DATE:	DESCRIPTION:
	AA	30.09.21	NEW START - PRELIM DESIGN DRAWINGS
	BB	05.10.21	AMENDMENTS TO PRELIM DRAWINGS
3	CC	18.10.21	DA DRAWINGS
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PROJECT DETAILS: PROPOSED ALTERATIONS AND ADDITIONS 18 EBOR ROAD PALM BEACH	DATE: 09/21	DRAWN BY:	SCALE: 1:200 @ A3
DRAWING TITLE: ROOF & STORMWATER CONCEPT PLAN	JOB No: 850A/20	CHECKED BY:	DRAWING No:  DA.13

**ROOF & STORMWATER CONCEPT PLAN** 

### **NOTES**

#### DESIGNATED SITE MANAGER/BUILDER

PRIOR TO COMMENCEMENT OF WORK A SITE MANAGER OR BUILDER MUST BE NOMINATED. THE SITE MANAGER OR BUILDER WILL BE RESPONSIBLE AND LIABLE FOR ALL WORKS CARRIED OUT ON THE SITE. THIS ASSUMES THE RESPONSIBILITY FOR THE ACTIONS OF ALL SUBCONTRACTED PARTIES AS WELL AS ADVISING THEM OF COUNCIL'S REQUIREMENTS WHEN CARRYING OUT WORKS.

#### TOPSOIL MANAGEMENT

PRIOR TO THE STRIPPING OF TOPSOIL, THE VEGETATIVE COVER MUST BE REDUCED BY EITHER SLASHING OR MOWING. ALL TOPSOIL IS TO BE RETAINED AND PROTECTED FOR REUSE ON SITE. SOIL STOCKPILES MUST NOT BE LOCATED ON NATURE STRIPS, FOOTPATHS, ROADWAYS, KERBS, ACCESSWAYS, WITHIN DRAINAGE LINES/FLOWS/PATHS OR AROUND OR AGAINST TREE SHRUBS. SEDIMENT CONTROL MEASURES MUST BE INCORPORATED WITH ANY RESULTING STOCKPILE. THE STOCKPILE CAN BE PROTECTED FROM EROSION BY COVERING IT WITH AN MPERVIOUS MATERIAL, IN CONJUNCTION WITH THE INSTALLATION OF A SEDIMENT FENCE AROUND IT. IF STOCKPILES ARE TO REMAIN FOR MORE THAN ONE MONTH THEY ARE TO BE GRASSED IMMEDIATELY AND STABILISED WITHIN FOURTEEN DAYS. SURPLUS TOPSOIL MUST BE REASONABLY REMOVED FROM SITE.

#### **BUILDING MATERIAL STOCKPILING**

SUFFICIENT AREA MUST BE ALLOCATED WITHIN THE SITE FOR SUCH STORAGE OF BUILDING MATERIALS, DEMOLITION WASTE, WASTE CONTAINERS, ETC. AS WILL BE REQUIRED.

A SEDIMENT FENCE SHOULD BE LOCATED ALONG THE DOWNSLOPE BOUNDARY(S) OF THE SITE. ON THE CONSTRUCTION SIDE OF THE TURF FILTER STRIP OR NATIVE VEGETATION, AND AROUND ALL STOCKPILES OF MATERIAL ON THE SITE.

#### DUST CONTROL

ALL TRUCKS/UTES MUST COVER THEIR LOADS AT ALL TIMES. APPROPRIATE METHODS ARE TO BE EMPLOYED TO PREVENT BLOWING DUST CREATING AN UNACCEPTABLE HAZARD OR NUISANCE ON THE SITE OR DOWN WIND. PRODUCTION OF DUST CAN BE MINIMISED BY LIMITING AREA OF EARTHWORKS, WATERING AND PROGRESSIVE VEGETATION. WHERE DUST IS CREATED AS A RESULT WORKS AND/OR SOIL EXPOSURE, THE BARE SOIL AREAS MUST BE WATERED, DURING AND/OR AT THE END OF EACH DAY TO LAY THE DUST. EARTH MOVING ACTIVITIES SHOULD BE AVOIDED WHERE WINDS ARE SUFFICIENTLY STRONG ENOUGH TO RAISE VISIBLE

#### **EROSION & SEDIMENT CONTROLS**

APPROPRIATE EROSION AND SEDIMENT CONTROLS MUST BE IMPLEMENTED ON ALL SITES THAT INVOLVE SOIL DISTURBANCE. THE MEASURES MUST BE IN PLACE PRIOR TO THE COMMENCEMENT OF WORK. THOSE CONTROLS ARE TO BE MONITORED AND MAINTAINED IN ORDER TO SERVE THEIR INTENDED FUNCTION FOR THE DURATION OF THE WORKS OR UNTIL SUCH TIME AS THE SITE IS FULLY STABILISED. IF ANY CONTROLS ARE DAMAGED OR BECOME INEFFECTIVE DURING THE COURSE OF THE WORKS THEY ARE TO BE REINSTATED OR REPLACED IMMEDIATELY. SUFFICIENT ACCESS TO THESE CONTROLS MUST BE PROVIDED IN CASE OF THE NEED TO REPAIR.

## SEDIMENT TRAPS


WHERE A SEDIMENT FENCE IS NOT USED APPROPRIATE SEDIMENT TRAPS SHOULD BE LOCATED AT ALL POINTS WHERE STORMWATER LEAVES THE CONSTRUCTION SITE OR LEAVES THE GUTTER AND ENTERS THE DRAINAGE SYSTEM. A COMMON TECHNIQUE IS THE GRAVEL SAUSAGE.


#### **DIVERSION CHANNELS**

A DIVERSION CHANNEL IS AN EXCAVATED EARTH DITCH OR PATH. THESE STRUCTURES ARE USED TO INTERCEPT AND DIRECT RUN-OFF TO A DESIRED LOCATION WHERE POSSIBLE. ALL STORMWATER RUN-OFF FLOWING ONTO DISTURBED AREAS, INCLUDING STOCKPILES, MUST BE INTERCEPTED, DIVERTED AND/OR SAFELY DISPOSED OF. THIS CAN BE ACHIEVED BY CONSTRUCTING A TEMPORARY EARTH BANK AROUND THE UPSLOPE EXTENT OF THE CONSTRUCTION SITE WHERE THE DIVERSION DOES NOT AFFECT THE NEIGHBOURING

#### VEHICLE MOVEMENTS

TO LIMIT DISTURBANCE TO THE SITE AND TRACKING OF MATERIAL ONTO THE STREET ALL VEHICLES AND PLANT EQUIPMENT ARE TO USE A SINGLE ENTRY/EXIT POINT UNLESS COUNCIL HAS APPROVED ALTERNATIVE ARRANGEMENTS. ACCESS POINTS AND PARKING AREAS ARE TO BE STABILISED WITH COMPACTED SUB-GRADE ASAP AFTER THEIR FORMATION. IF SPILLAGE DOES OCCUR IT IS TO BE CONTAINED IMMEDIATELY AND CAREFULLY REMOVED. THE AREA AFFECTED IS TO BE RESTORED TO A STANDARD EQUAL TO OR BETTER THAN ITS PREVIOUS CONDITION. ALL VEHICLES ARE TO BE WASHED PRIOR TO EXISTING THE SITE. THIS SERVES THE PURPOSE OF REMOVING SITE MATERIAL ON THE VEHICLE AND PREVENTS IT FROM BEING DEPOSITED ON THE ROAD NETWORK ADJACENT TO THE SITE AND THUS, THE STORMWATER SYSTEM. NO VEHICLE ASSOCIATED WITH THE WORK IS TO BE PARKED ON A FOOTPATH OR PUBLIC RESERVE. ALL VEHICLES VISITING THE SITE DURING DEMOLITION, EXCAVATION AND/OR CONSTRUCTION WORKS, ARE TO COMPLY WITH THE PARKING REQUIREMENTS IN THAT AREA.

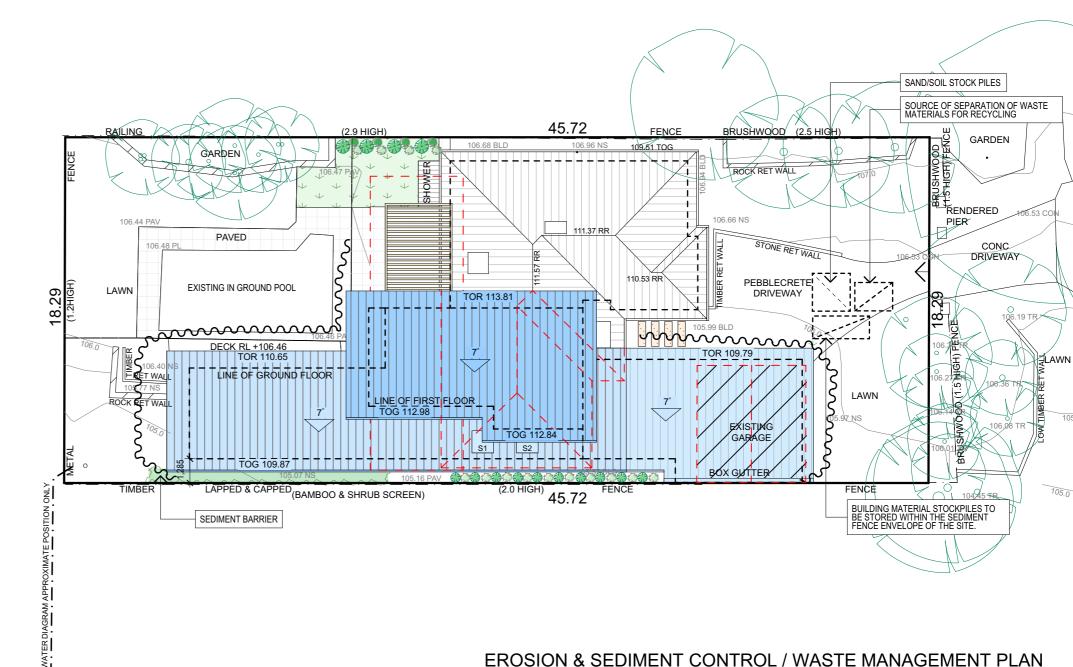


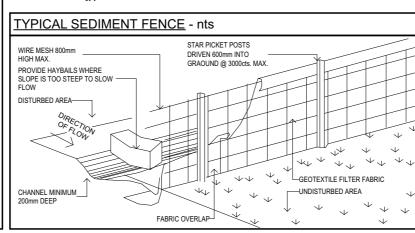

REV:

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#### TRUE NORTH:

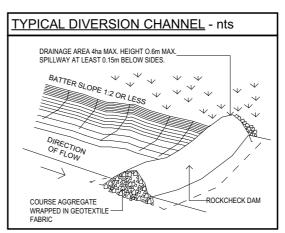


#### NOTES (E & OE)

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ı	www.jjdrafting.com.au
1	ACNI 054 000 040

<b>/</b> :	DATE:	DESCRIPTION:	PROJECT DETAILS: PROPOSED ALTERATIONS AND ADDITIONS 18 EBOR ROAD PALM BEACH	DATE:	DRAWN BY:	SCALE:
	30.09.21	NEW START - PRELIM DESIGN DRAWINGS		00/04		
	05.10.21	AMENDMENTS TO PRELIM DRAWINGS		09/21	CA	1:200 @ A3
	18.10.21	DA DRAWINGS				
			DRAWING TITLE:	JOB No:	CHECKED BY:	DRAWING No:
			EROSION & SEDIMENT CONTROL / WASTE	002110.		
				850A/20	JJ	DA.14
			MANAGEMENT PLAN			



SHADOW DIAGRAM JUNE 21 9:00 am

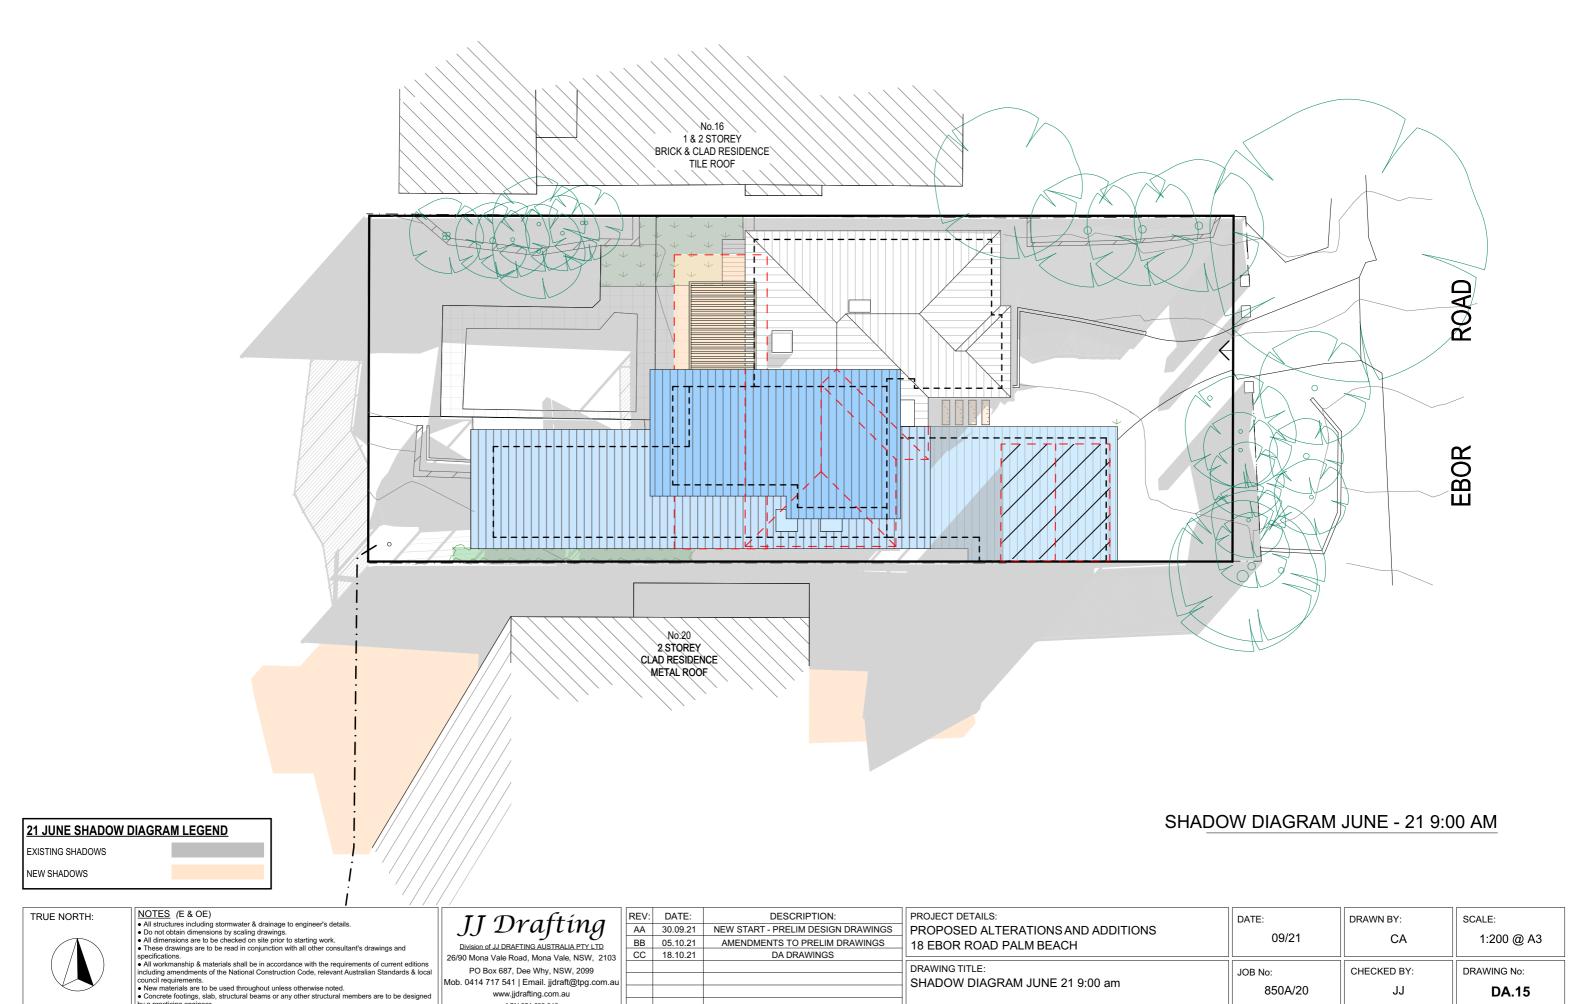850A/20


**DA.15** 

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ACN 651 693 346

by a practicing engineer.



## 21 JUNE SHADOW DIAGRAM LEGEND

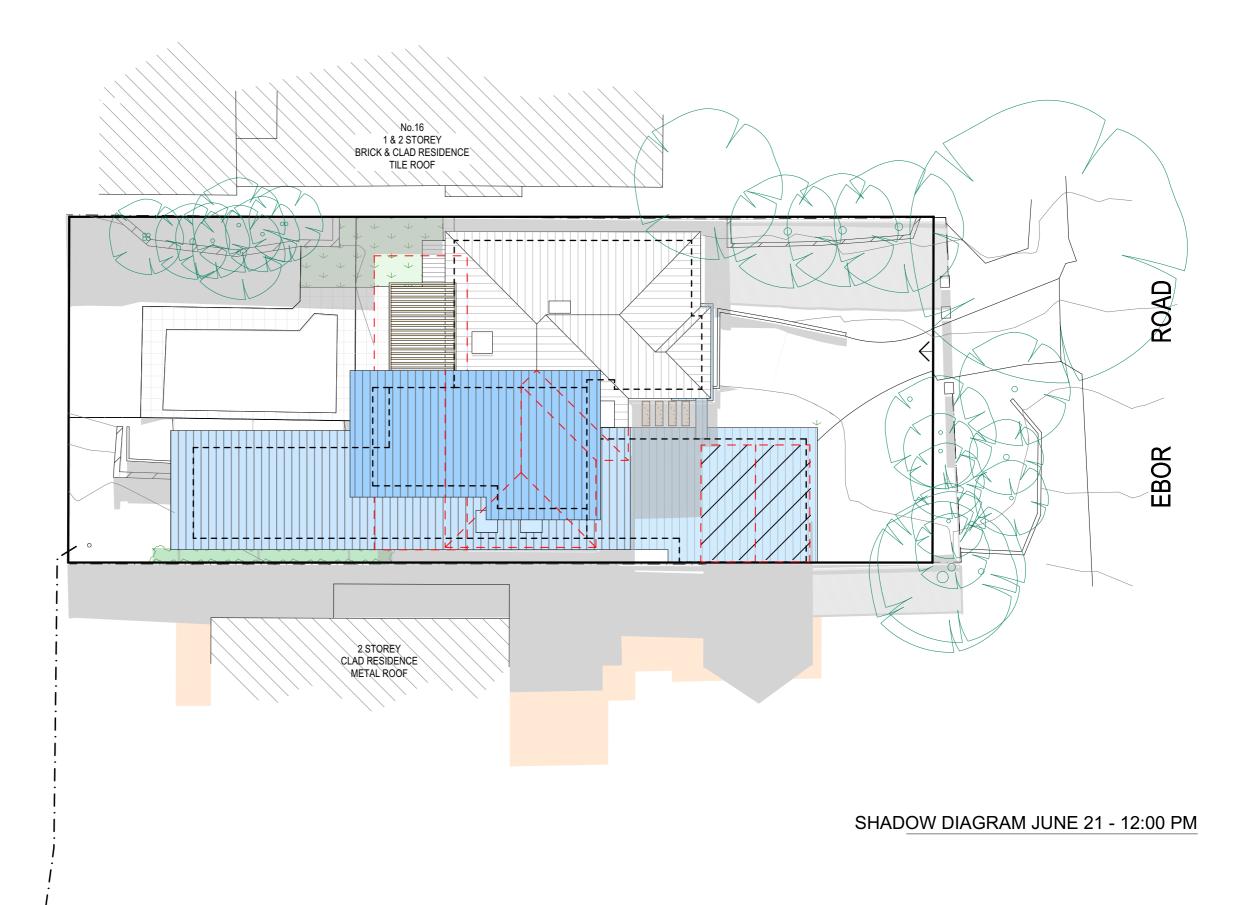EXISTING SHADOWS

NEW SHADOWS

TRUE NORTH:



- NOTES (E & OE)

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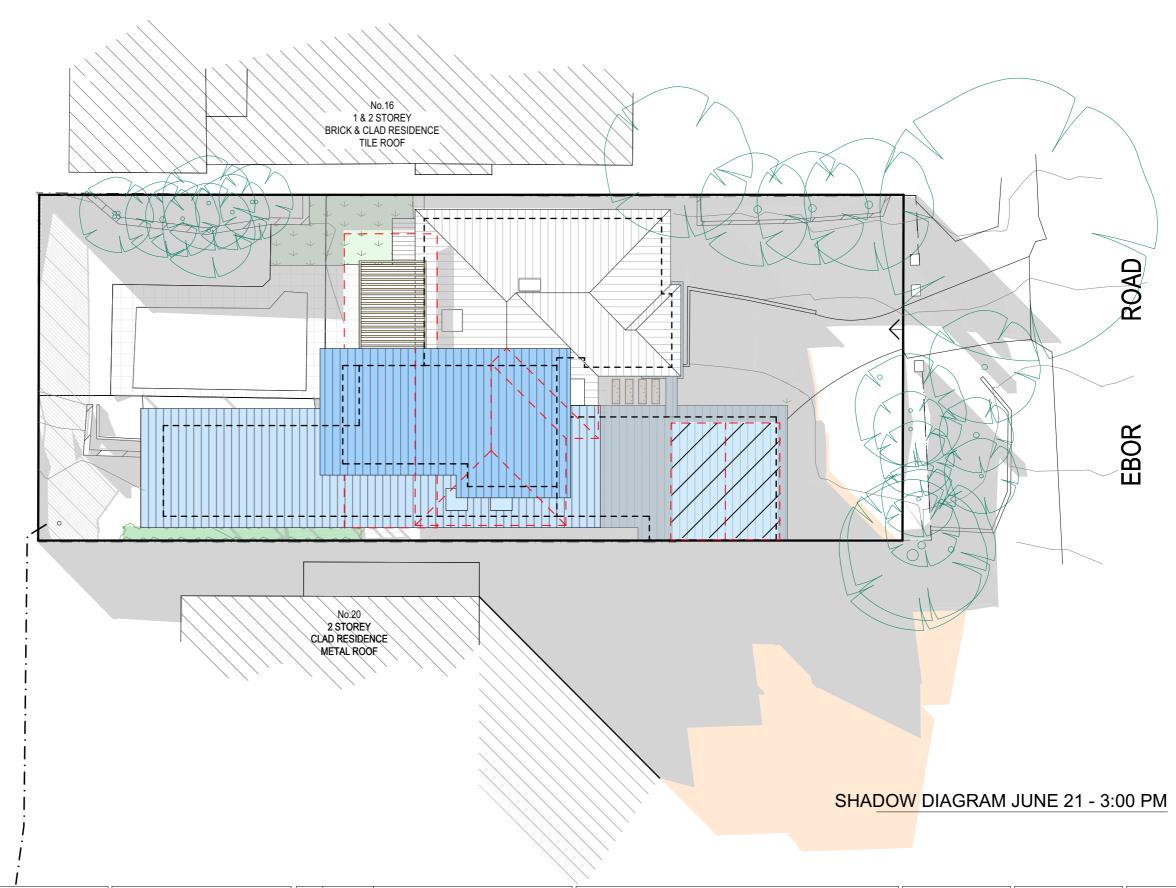
  All workmanship & materials shall be in accordance with the requirements of current editions including amendments of the National Construction Code relevant Australian Standards & local All workmanship & materials shall be in accordance with the requirements of current editions including amendments of the National Construction Code, relevant Australian Standards & local council requirements.

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3	CC	18.10.21	DA DRAWINGS
au			

PROJECT DETAILS: PROPOSED ALTERATIONS AND ADDITIONS 18 EBOR ROAD PALM BEACH	DATE: 09/21	DRAWN BY:	SCALE: 1:200 @ A3
DRAWING TITLE: SHADOW DIAGRAM JUNE 21 12 noon	JOB No: 850A/20	CHECKED BY:	DRAWING No:  DA.16



## 21 JUNE SHADOW DIAGRAM LEGEND

EXISTING SHADOWS

NEW SHADOWS

TRUE NORTH:



- NOTES (E & OE)

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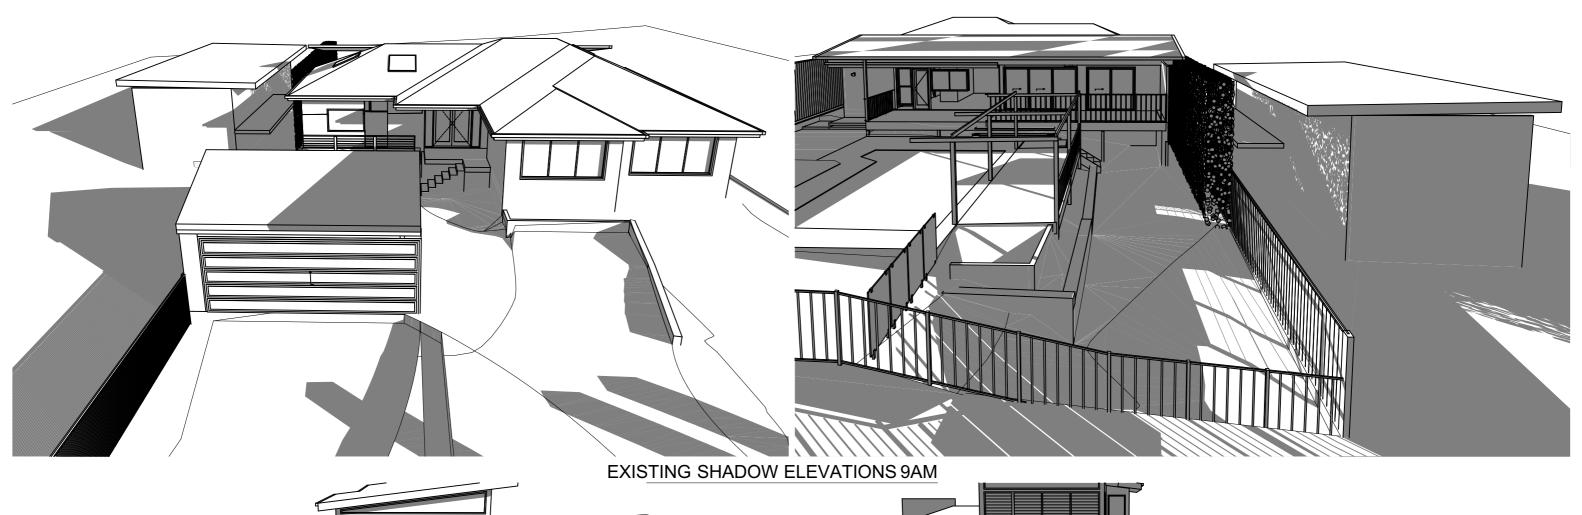
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	BB	05.10.21	AMENDMENTS TO PRELIM DRAWINGS
3	CC	18.10.21	DA DRAWINGS
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╛	PROJECT DETAILS: PROPOSED ALTERATIONS AND ADDITIONS 18 EBOR ROAD PALM BEACH	DATE: 09/21	DRAWN BY:	SCALE: 1:200 @ A3
	DRAWING TITLE: SHADOW DIAGRAM JUNE 21 3:00 pm	JOB No: 850A/20	CHECKED BY:	DRAWING No: DA.17





## PROPOSED SHADOW ELEVATIONS 9AM

- NOTES (E & OE)

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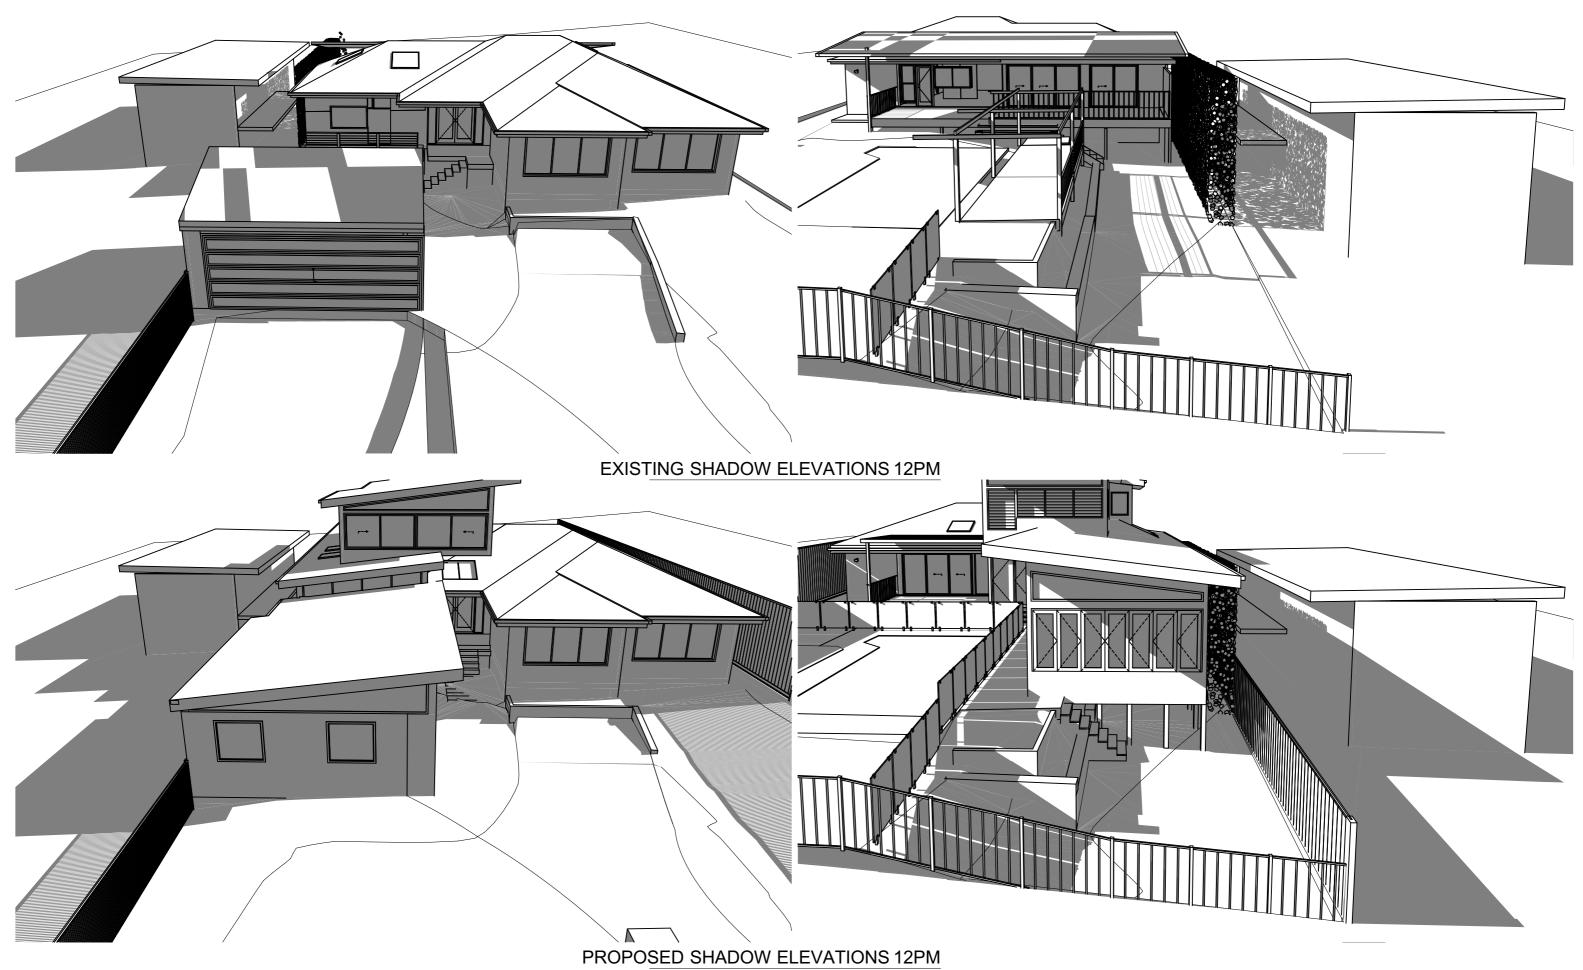
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3	CC	18.10.21	DA DRAWINGS	ı
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PROJECT DETAILS: PROPOSED ALTERATIONS AND ADDITIONS 18 EBOR ROAD PALM BEACH	DATE: 09/21	DRAWN BY:	SCALE: 1:200 @ A3
DRAWING TITLE: SHADOW ELEVATIONS 9:00 am	JOB No: 850A/20	CHECKED BY:	DRAWING No: DA.18



NOTES (E & OE)

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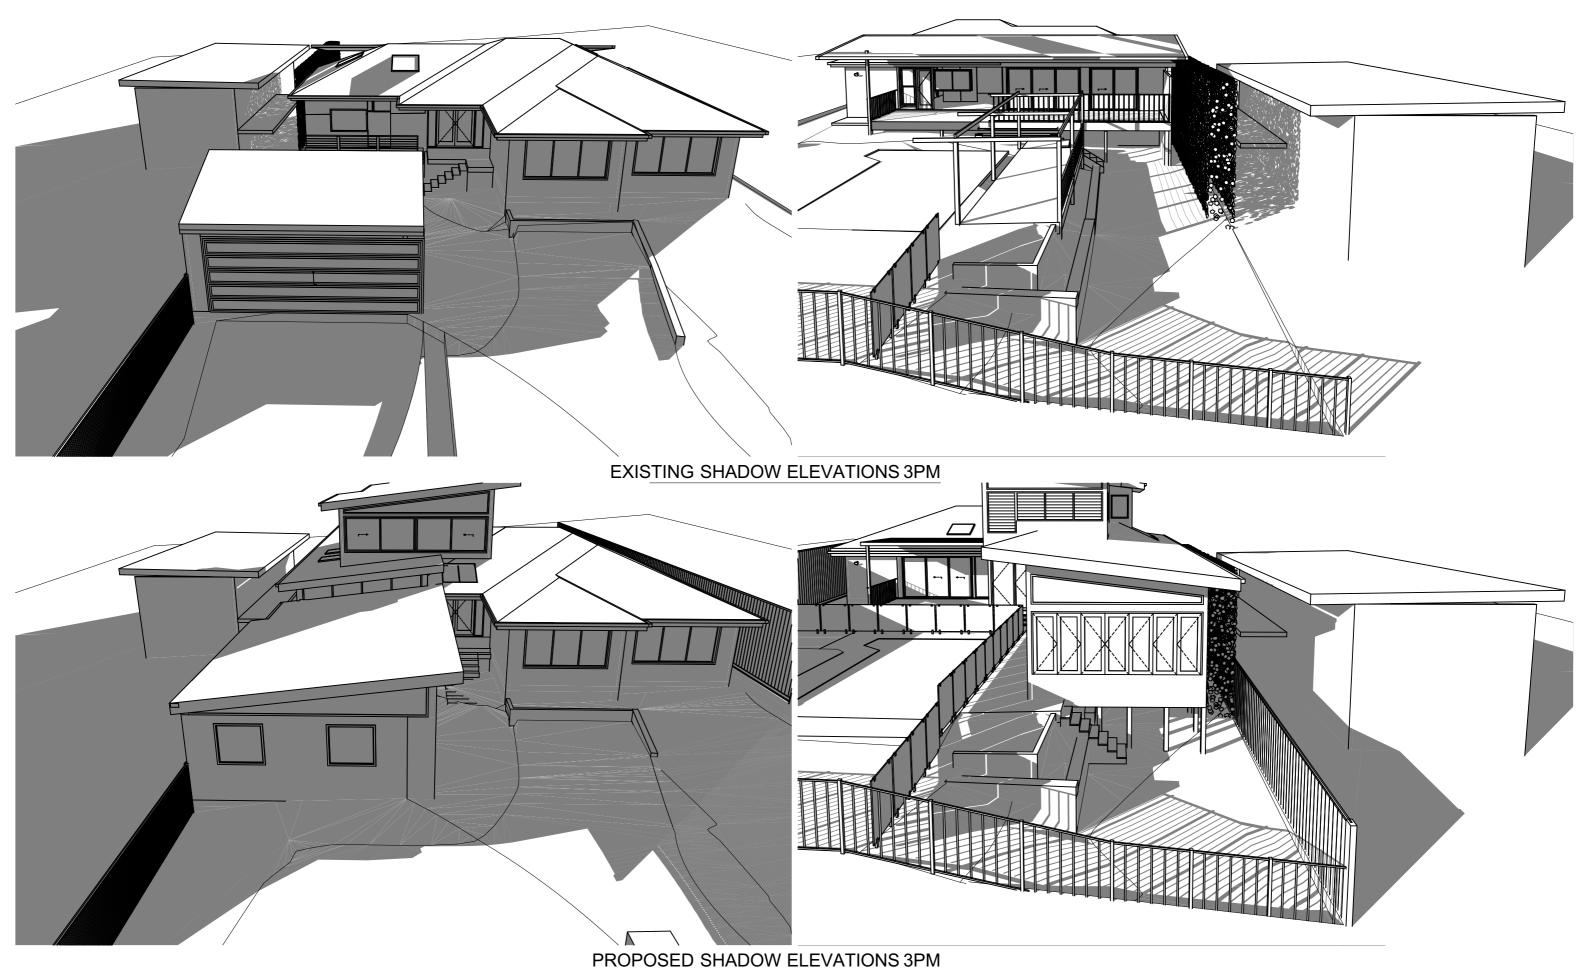
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PROJECT DETAILS: PROPOSED ALTERATIONS AND ADDITIONS 18 EBOR ROAD PALM BEACH	DATE: 09/21	DRAWN BY:	SCALE: 1:200 @ A3
DRAWING TITLE: SHADOW ELEVATIONS 12:00 pm	JOB No: 850A/20	CHECKED BY:	DRAWING No: DA.19



NOTES (E & OE)

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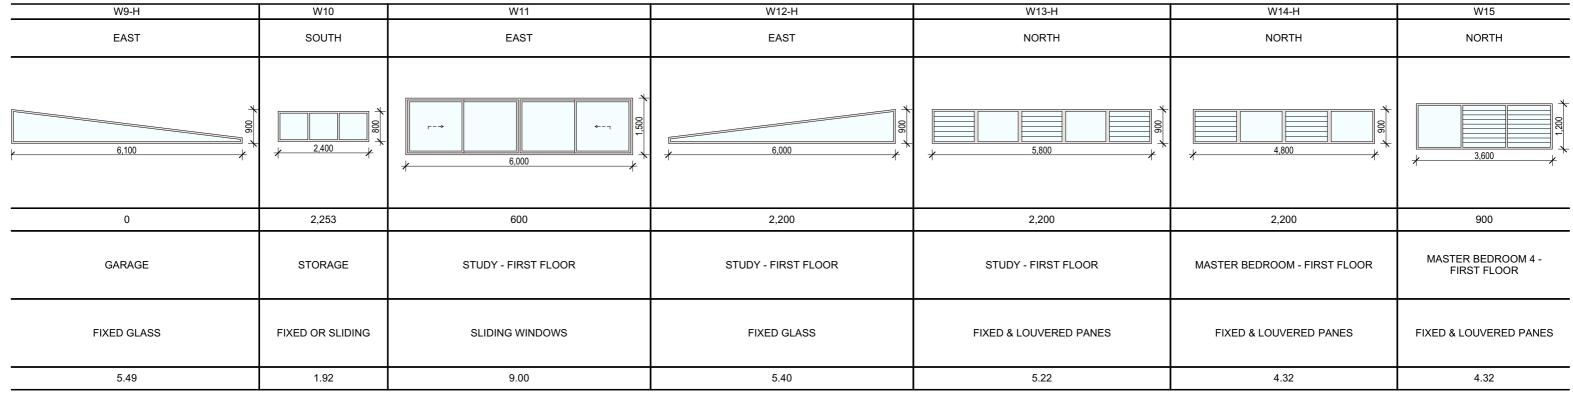
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PROJECT DETAILS: PROPOSED ALTERATIONS AND ADDITIONS 18 EBOR ROAD PALM BEACH	DATE: 09/21	DRAWN BY:	SCALE: 1:200 @ A3
DRAWING TITLE: SHADOW ELEVATIONS 3:00 pm	JOB No: 850A/20	CHECKED BY:	DRAWING No: DA.20

LABEL ID	W1	W2	W3-H	W4-H	W5-H	W6-H	W7-H	W8-H
ORIENTATION	WEST	NORTH	NORTH	NORTH	NORTH	WEST	NORTH	NORTH
ELEVATION	7,400	7 950	3,000	3,000	3,000	4,550	3,000	5,000
SILL HEIGHT	0	690	2,600	2,600	2,600	2,600	2,489	2,489
LOCATION	ENTRY HALL NEAR DINING - GROUND FLOOR	STAIRS TO NEW LIVING ROOM - GROUND FLOOR	LIVING ROOM - GROUND FLOOR	LIVING ROOM - GROUND FLOOR	H LIVING ROOM - GROUND FLOOR	LIVING ROOM - GROUND FLOOR	STORAGE CORRIDOR	GARAGE
TYPE	RECYCLED - FIXED GLASS	FIXED GLASS	FIXED & LOUVERED PANES	FIXED & LOUVERED PANES	FIXED & LOUVERED PANES	FIXED GLASS	SLIDING OR FIXED PANES	SLIDING OR FIXED PANES
AREA FOR BASIX	2.94	2.28	2.40	2.40	2.40	3.64	2.70	4.50



## WINDOW SCHEDULE

## <u>NOTES</u>

FRAME OPENING DIMENSIONS FOR WINDOWS & DOORS TO BE CONFIRMED ON SITE PRIOR TO ORDERING.

- NOTES (E & OE)

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- Indeed crawings are to be read in Conjunication which are constanting a constanting state in specifications.
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au			

1	PROJECT DETAILS: PROPOSED ALTERATIONS AND ADDITIONS 18 EBOR ROAD PALM BEACH	DATE: 09/21	DRAWN BY:	SCALE: 1:1 @ A3
	DRAWING TITLE: OPENINGS SCHEDULE	JOB No: 850A/20	CHECKED BY:	DRAWING No: 1 of 2

LABEL ID	W16	W17-H	W18	W19	W20	W21	W22	W23	W24	W25-H
ORIENTATION	WEST	WEST	SOUTH	WEST	SOUTH	SOUTH	NORTH	NORTH	WEST	EAST
ELEVATION	3,600	4,800	4,800	* 9000 * 1200 *	2,200	1,650	1,200	1,200	1,200	4,800
SILL HEIGHT	900	2,200	900	900	1,100	1,100	1,100	400	400	0
LOCATION	MASTER BEDROOM 4 - FIRST FLOOR	MASTER BEDROOM 4 - FIRST FLOOR	MASTER BEDROOM 4 - FIRST FLOOR	ENSUITE BATH - FIRST FLOOR	ENSUITE BATH - FIRST FLOOR	OVER STAIRS - FIRST FLOOR	STUDY - FIRST FLOOR	MASTER BEDROOM 4 - FIRST FLOOR	MASTER BEDROOM 4 - FIRST FLOOR	OVER PANTRY - GROUND FLOOR
TYPE	LOUVERED WINDOWS	FIXED GLASS	LOUVERED WINDOWS	FIXED GLASS	LOUVERED WINDOWS - FROSTED	FIXED GLASS	LOUVERED WINDOW	LOUVERED WINDOW	LOUVERED WINDOW	FIXED GLASS
AREA FOR BASIX	4.32	4.32	5.76	1.08	2.20	1.65	1.20	2.04	2.04	2.40

ORIENTATION WEST NORTH WEST NORTH NORTH NORTH NORTH WEST  LOCATION EXISTING KITCHEN/DECK- GROUND FLOOR SLIDING BIFOLD DOOR SLIDING BIFOLD DOOR SLIDING BOOR - MULTI DIRECTIONAL - STACKABLE DIRECTIONAL -	LABEL ID	D1	D2	D3	D4	D5	D6	D7
LOCATION  EXISTING KITCHEN/DECK - GROUND FLOOR  DINING ROOM - GROUND FLOOR  EXISTING KITCHEN/DECK - GROUND FLOOR  DINING ROOM - GROUND FLOOR  LIVING ROOM - GROUND FLOOR  LIVING ROOM - GROUND FLOOR  LIVING ROOM - GROUND FLOOR  SLIDING DOOR - MULTI DIRECTIONAL - STACKABLE	ORIENTATION	WEST	NORTH	WEST	NORTH	NORTH	NORTH	WEST
TYPE RECYCLED - SLIDING DOOR SLIDING BIFOLD DOOR DIRECTIONAL - STACKABLE SLIDING DOOR - MULTI DIRECTIONAL - STACKABLE SLIDING DOOR - MULTI DIRECTIONAL - STACKABLE SLIDING BIFOLD WINDOW	ELEVATION							4,550
TYPE RECYCLED - SLIDING BIFOLD DOOR SLIDING BIFOLD DOOR DIRECTIONAL - STACKABLE DIRECTIONAL - STACKABL	LOCATION				LIVING ROOM - GROUND FLOOR			LIVING ROOM - GROUND FLOOR
AREA FOR BASIX 7.35 6.72 7.32 7.20 7.20 7.20 7.74	TYPE	RECYCLED - SLIDING DOOR	SLIDING BIFOLD DOOR	SLIDING BIFOLD DOOR				SLIDING BIFOLD WINDOW
	AREA FOR BASIX	7.35	6.72	7.32	7.20	7.20	7.20	7.74

# DOOR SCHEDULE

## TRUE NORTH:

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ACN 651 693 346

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PROJECT DETAILS: PROPOSED ALTERATIONS AND ADDITIONS 18 EBOR ROAD PALM BEACH	DATE: 09/21	DRAWN BY:	SCALE: 1:1 @ A3
DRAWING TITLE: OPENINGS SCHEDULE	JOB No: 850A/20	CHECKED BY:	DRAWING No: 2 of 2