
166 Pittwater Road, Manly

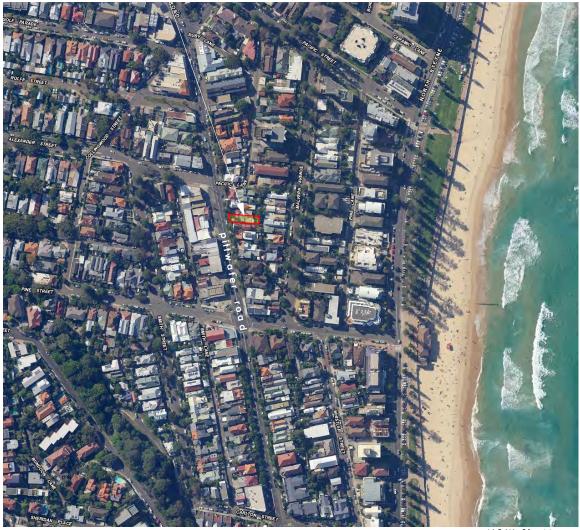

source: NSW Six Maps

site location plan

nts



drawing register

			Issue Date:
		Day	20
		Month	12
		Year	22
DA//00	Site Location & Drawing Register		Α
DA//01	Perspective Views // Exg & Prop.		Α
DA//02	Area & Compliance Table		Α
DA//03	Area Calculation Plans		Α
DA//04	Site Analysis Plan		Α
DA//05	Site // Entry Level Plan // Exg.		Α
DA//06	Site // Entry Level Plan // Prop.		Α
DA//07	First Floor Plan // Proposed		Α
DA//08	Roof Plan // Proposed		Α
DA//09	Sections // Proposed		Α
DA//10	Elevations N // Exg. & Prop.		Α
DA//11	Elevations S // Exg & Prop.		Α
DA//12	Elevations E // Exg. & Prop.		Α
DA//13	Elevations W // Exg. & Prop.		Α
DA//14	Ex. Door & Win Sched. Sht 1 of 2		Α
DA//15	Ex. Door & Win Sched. Sht 2 of 2		Α
DA//16	Finishes Schedule		Α
DA//17	Shadow Diagram June 21st 9am		Α
DA//18	Shadow Diagram June 21st 12pm		Α
DA//19	Shadow Diagram June 21st 3pm		Α
DA//20	Shadow Diagrams Elevations		Α
DA//21	Sed. & Erosion // Site Setup Plan		Α
DA//22	Sed & Erosion Control Details Sht 1		Α
DA//23	Sed & Erosion Control Details Sht 2		Α
DA//24	Sed & Erosion Control Details Sht 3		Α
DA//AA	Notification Plans		Α

Issue:	Recipients:	
(DA)	Clients : B. & C. Laws	•
(DA)	Council: Northern Beaches Council	•



existing dwelling birdseye view

nt

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address:
166 Pittwater Rd, Manly, NSW 2095
LOT 107 IN DP1176623

B. & C. Laws

Alterations & additions

ISW 2095. Sit

JOB

Site Location & Drawing Register

@ VIEW//THRI
drawn by: scale:

date: Rev. no.: 20/12/2022 **A**dwg. no.: issue:

(DA)

DA//00

RIAI

rchitectural Jim
echnologist Princip
(RIAI
2022 (Affi

Jim O'Brien
Principal Designer //
Director
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BALGOWLAH, NSW 2093.

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street view // existing





rear view // existing

nts



street view // proposed

nts



rear view // proposed

nt

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address:		title:					
166 Pittwater Rd, Manly, NSW 2095. LOT 107 IN DP1176623							
client: B. & C. Laws							
project:	Alterations & additions	JOB					

drawn by:	scale:
Perspective Views ,	// Exg & Prop.
title:	

	D A // 0 1	(DA)
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© VIEW//THRU		
rop.	20/12/2022	Α
	date:	Rev. no.:



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Development Application (DA) planning approval pathway

'alterations & additions'

COMPLIANCE TABLE - AREA CALCULATIONS FOR DA (m2)

Manly Local Environmental Plan (LEP) 2013 & Manly Development Control Plan 2013

Local Goverment Area: Northern Beaches Council - Manly

	AREAS:	AS: CONTROLS:				Manly Local Environmental Plan 2013								Manly Development Control Plan - 2013								
	Site	Ground	First	LAND	MIN	ACID	BIO	ACTIVE	LANDSLIDE	FLOOD	FORESHORE	FORESHORE	GEO	HERITAGE or	MAX.	FLOOR	BUSHFIRE	WALL	LANDSLIDE	OPEN	LANDSCAPED	PARKING
	Area	Floor	Floor	ZONE		SULPHTE	DIVER.		RISK	RISK	SCENIC	BUILDING	TECH	CONSERV.	BUILDING	SPACE	PRONE	HEIGHT	RISK	SPACE	AREA	
					SIZE	SOILS		FRONT.	LAND		PROTECT.	LINE	HAZARD	AREA	HEIGHTS	RATIO	LAND		LAND	REQ.		4
CONTROL					Area 'C'		-			-		-	-	Pittwater Rd	Area 'I'	Area 'F'		4.1.2.1	Area 'G3'	DCP Area 'OS3'	DCP Area 'OS3'	
				LZN	LSZ				refer to					Conservation	НОВ Мар_003	FSR Map_003	-	(a)	DCP	55%	35%	
				Мар_003	Мар_003				DCP					Area	= 8.5 M	0.6 : 1		= 6.5 M	Geo Мар	of Site Area	of Open Space	
					250 sqm				Section					Significance	MAX.	146.7 sgm		MAX.		MIN	MIN	
					MIN									Local		MAX.				= 134 sgm	= 47 sqm	
					71									2000.		777 0 4				92.9 sqm	., 04	
EXISTING	244.5 sqm	103.6 sqm	-	R 3	-	Class	-	-	-	-	YES	-	-	YES	-	103.6 sqm GFA	-	-	-	= 38%	32 sqm	
						4										0.42 : 1				inclds pool	= 24%	0
																				21sqm (<30%)		+
PROPOSED	244.5 sqm	103.6 sqm	43.4 sqm	R 3	-	Class	_	-	-	-		-	-	YES	YES	147 sqm GFA	-	YES	YES	92.9 sqm	32 sqm	
						4					YES					0.6 : 1				= 38%	= 24%	0
																				inclds pool		
																				21sqm (<30%)		
																				2134111 (100/6)		
COMPLIANCE	-	✓	✓	✓	✓	✓	N/A	N/A	-	N/A	REFER SEE	N/A	N/A	REFER SEE	✓	✓	N/A	✓	REFER SEE	REFER SEE	REFER SEE	N/A

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address:	water Rd, Manly, NSW 2095.						
LOT 107 IN DP1176623							
client:	B. & C. Laws						

project: Alterations & additions

JOB




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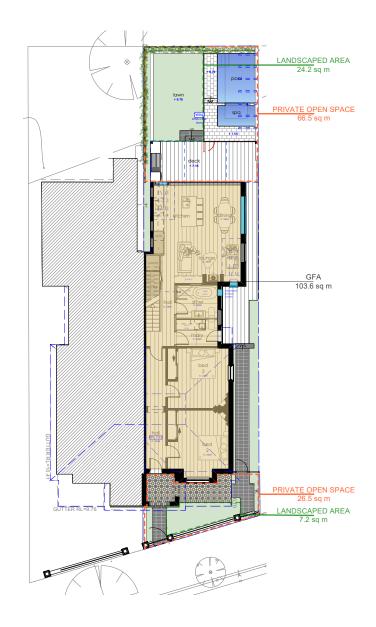
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site // entry level plan - existing



site // entry level plan - proposed

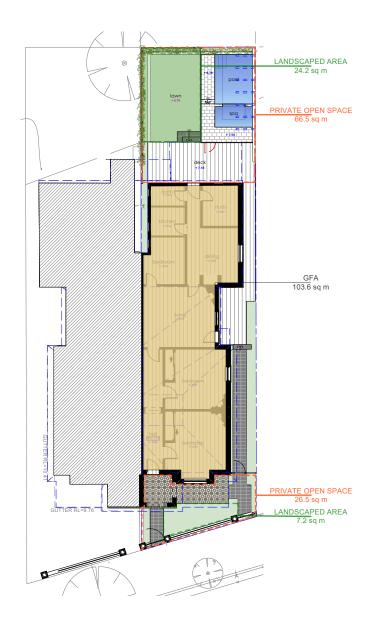

first floor plan - proposed

plan reference key:

gross floor area existing

landscaped area

proposed extended gross floor area

open space

entry

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	aaaress:	
		ttwater Rd, Manly, NSW 2095. 07 IN DP1176623
\int	client:	B. & C. Laws

project: Alterations & additions

	title:			C			
Area Calculation Plans							
	drawn by:	scale:	- W VILW//IHRO	C			
	JOB	nts					

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	date:	Rev. no.:
IRU.	20/12/2022	A
	dwg. no.:	issue:
	DA//03	(DA)




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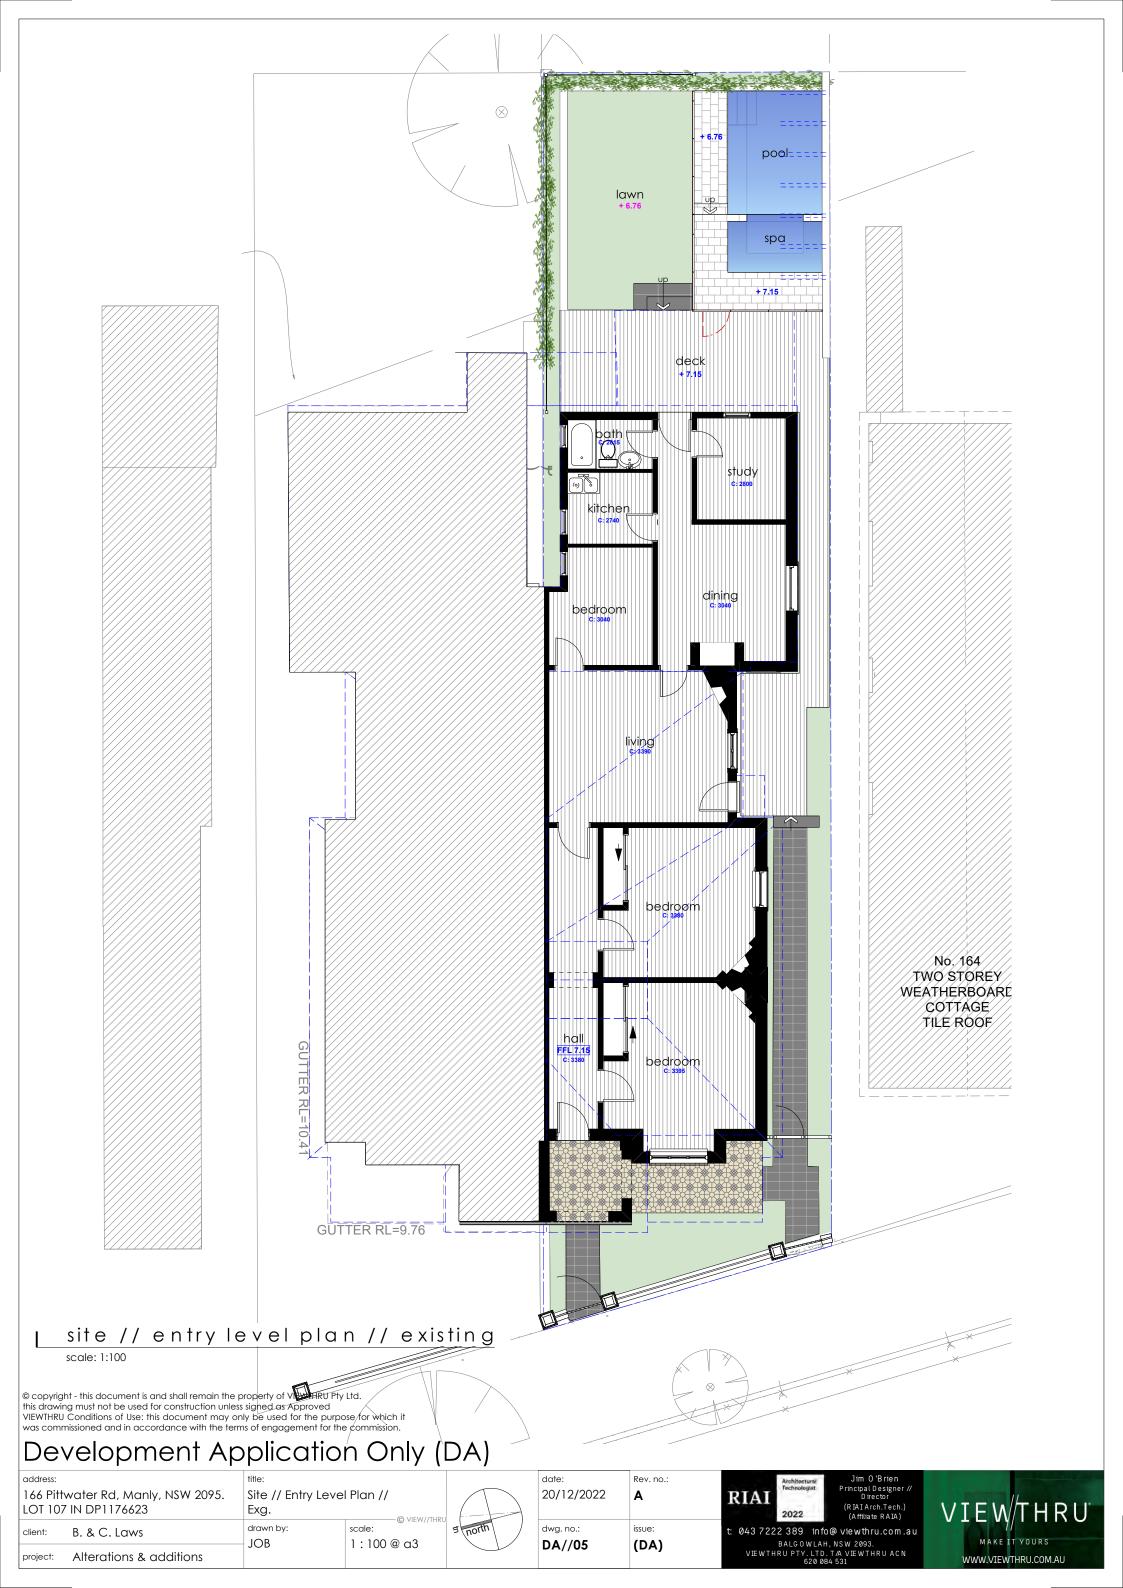
Jim O'Brien Principal Designer // Director (RIAI Arch.Tech.) (Affiliate RAIA) info@viewthru.com.au







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address:		title:			date:	Rev. no.:	Architectural Jim O'Brien	
166 Pittwater Rd, Manly, NSW 2095. LOT 107 IN DP1176623		Site Analysis Plan			20/12/2022	A	Principal Designer // Director (RIAI Arch.Tech.) (Affiliate RAIA)	VIEW/THRU
client:	B. & C. Laws	drawn by: JOB	scale: 1:100@a3	# north	dwg. no.:		t: 043 7222 389 info@ viewthru.com.au	MAKE IT YOURS
project:	Alterations & additions	JOR	1.100 @ 03		DA//04	(DA)	VIEWTHRU PTY. LTD. T/A VIEWTHRU ACN 620 084 531	WWW.VIEWTHRU.COM.AU

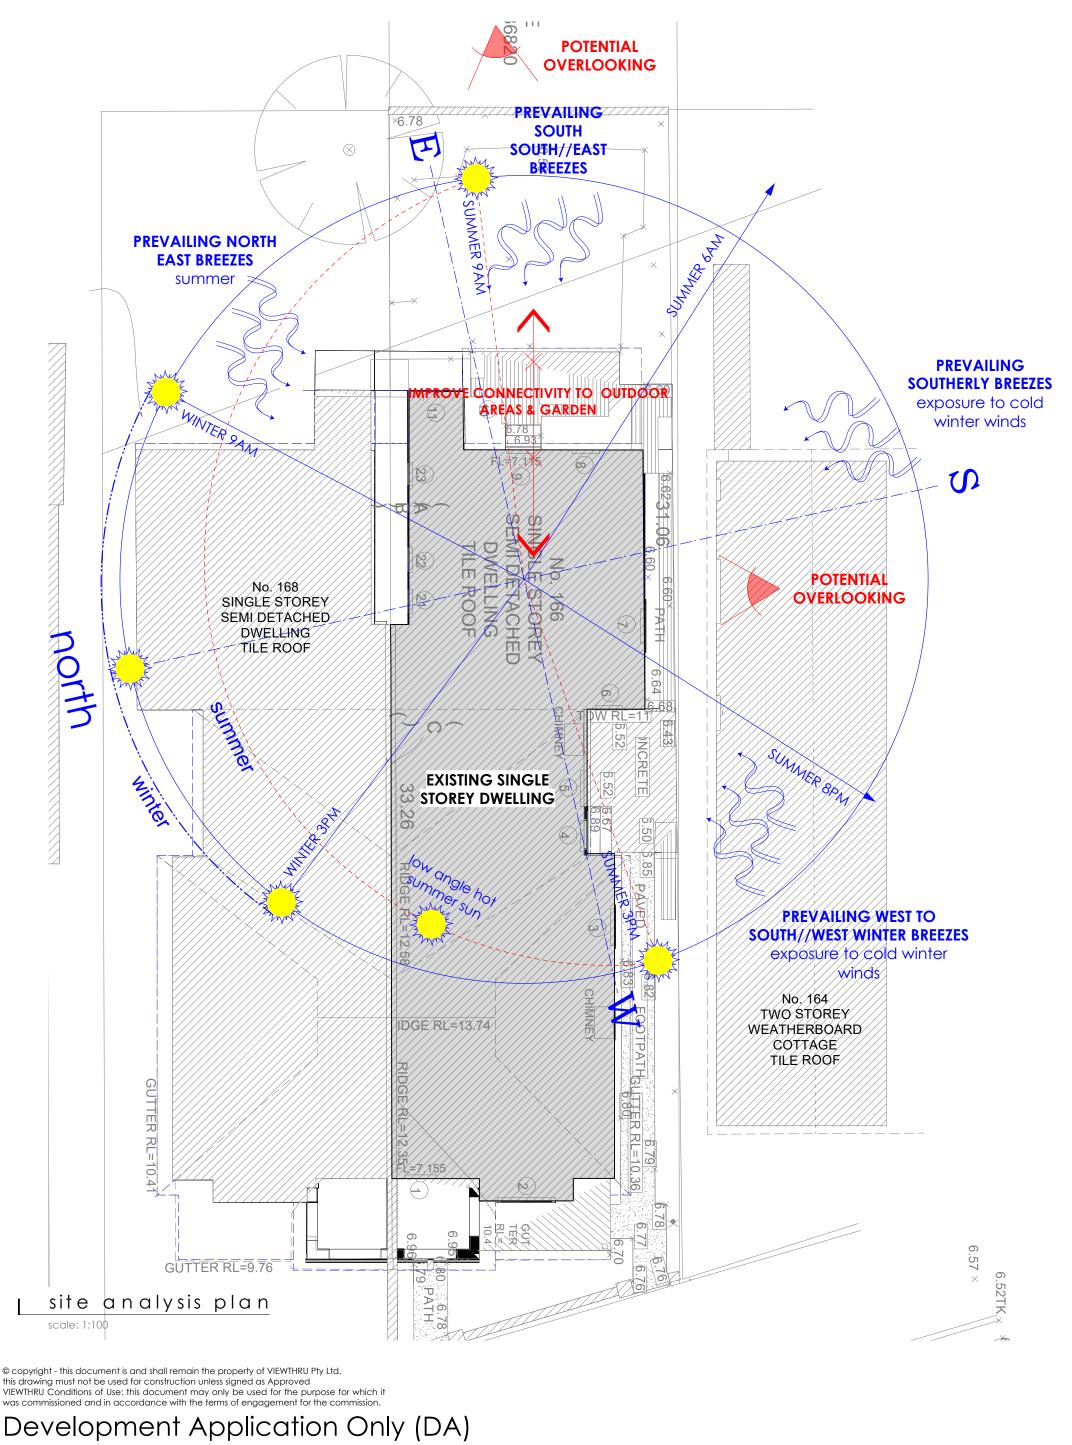



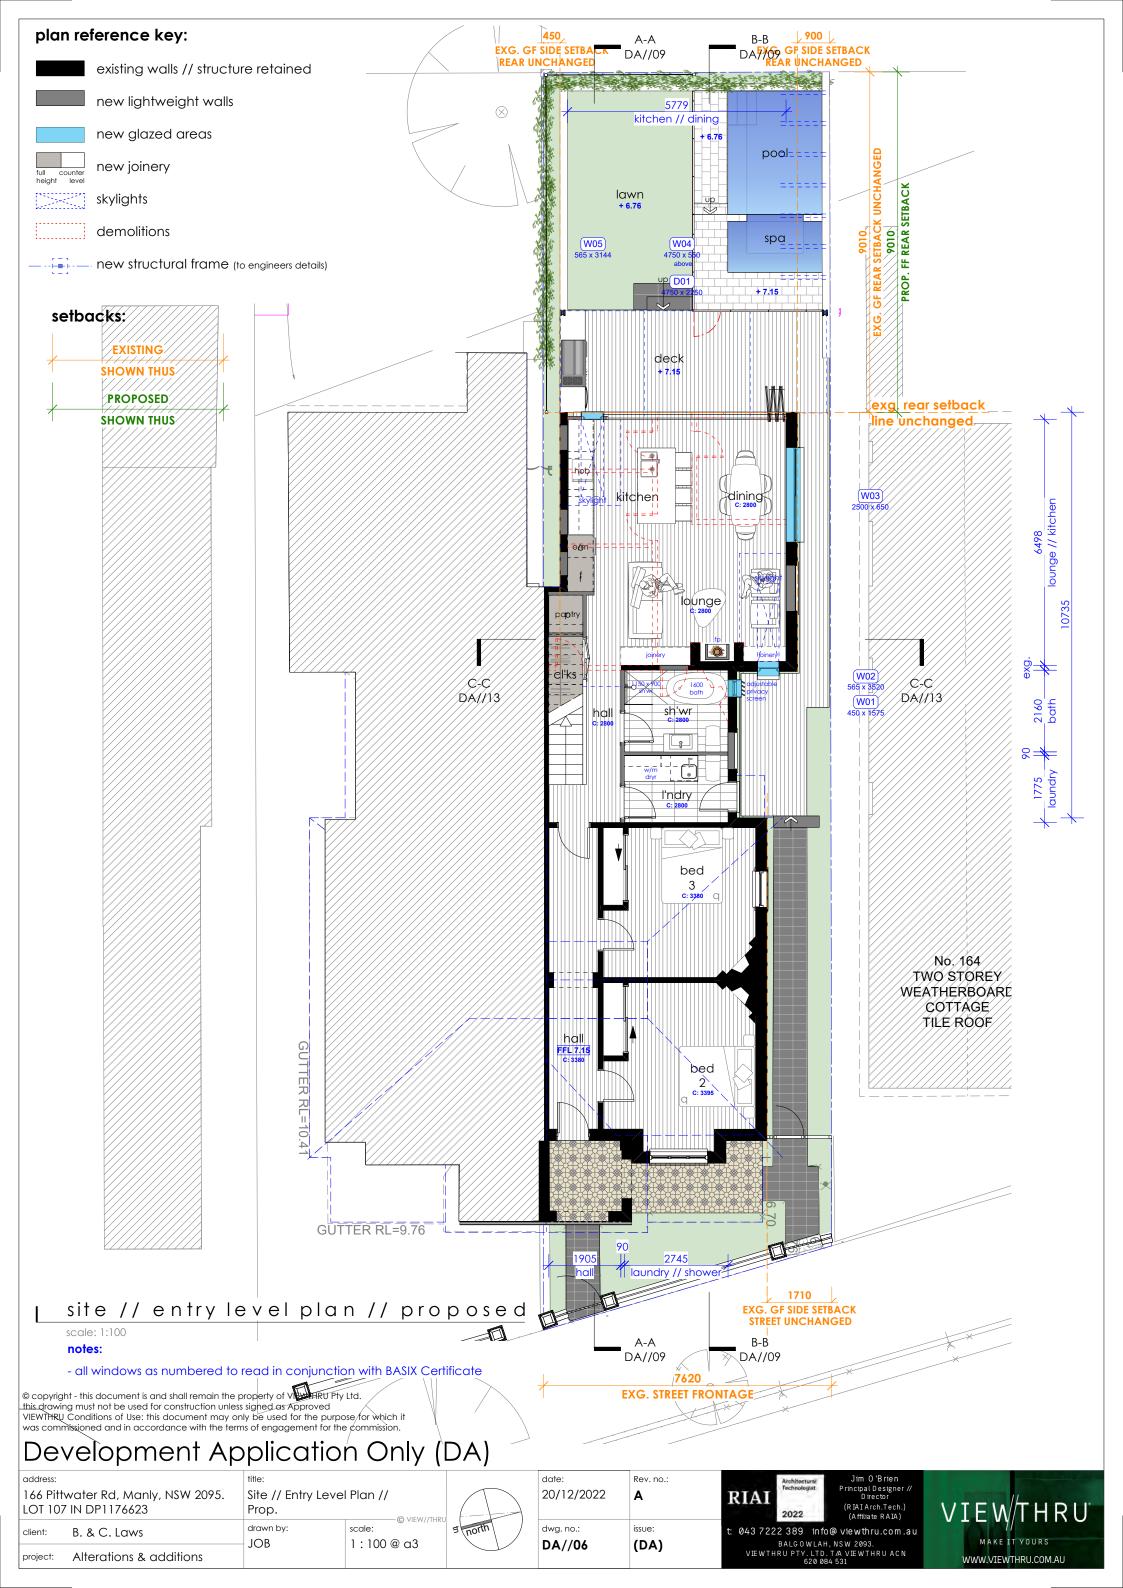



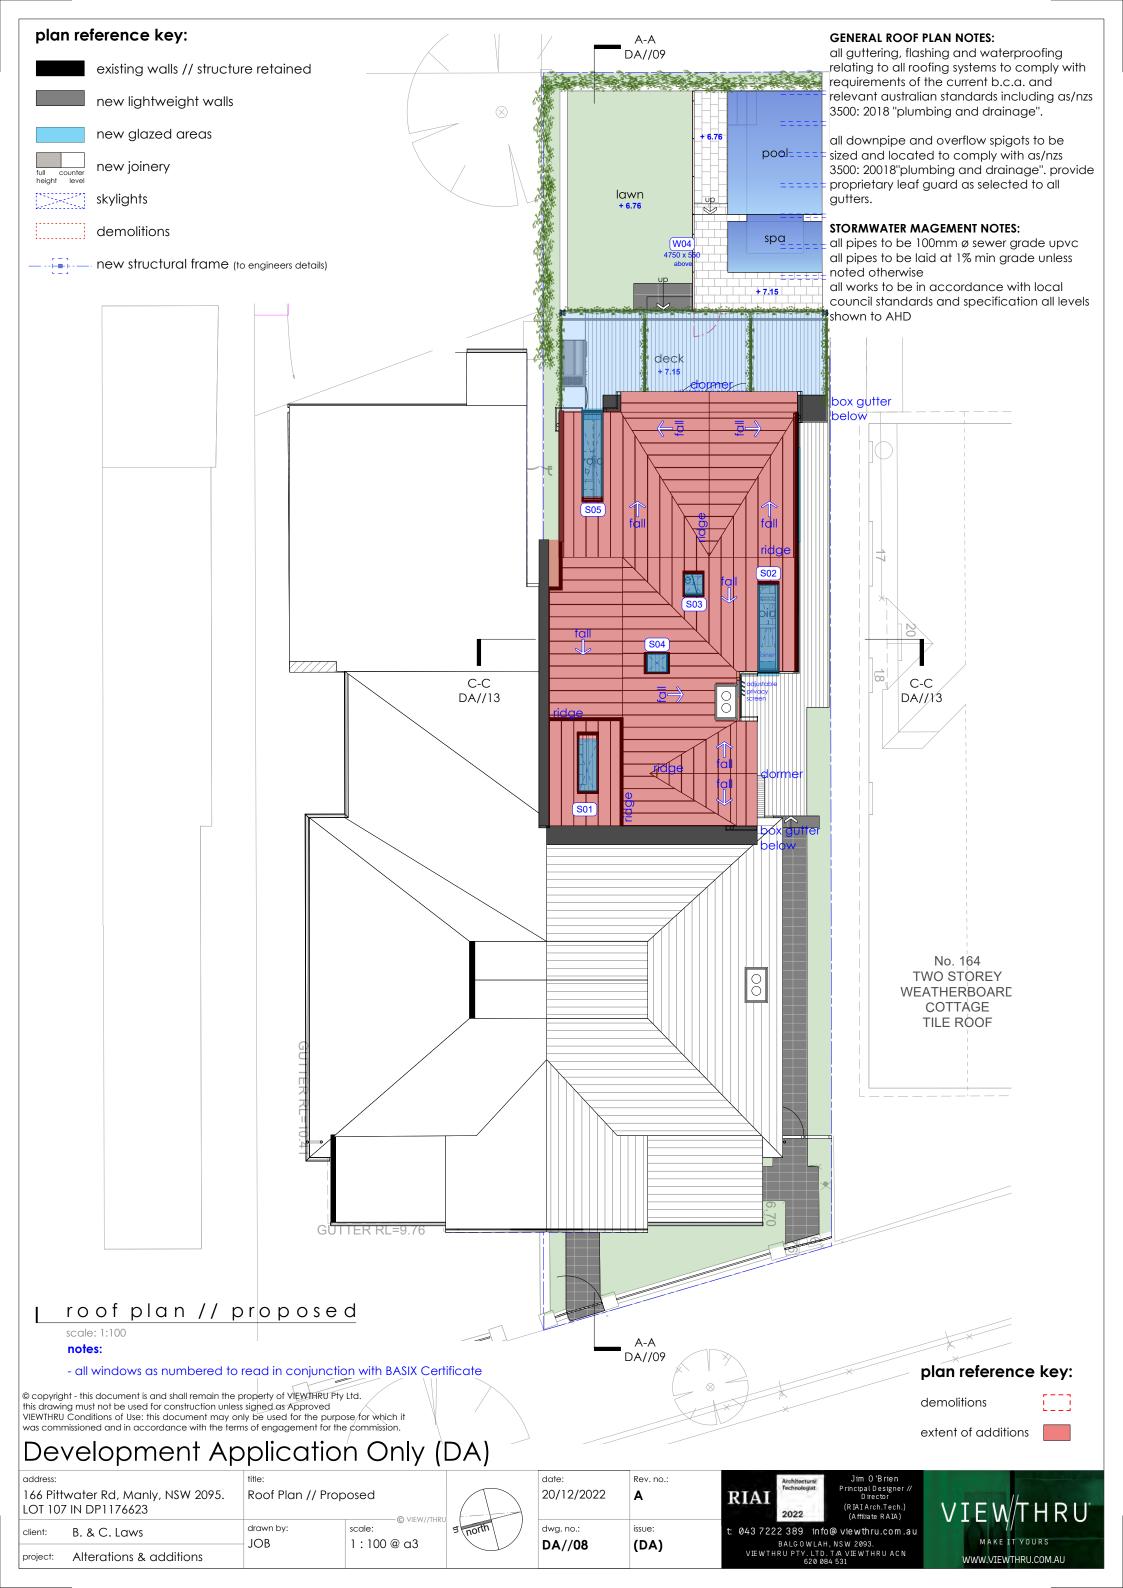

section a - a // proposed

scale: 1:100



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scale: 1:100

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Sections // Proposed drawn by: scale: JOB

20/12/2022 dwg. no.:

Rev. no.: Α issue:

RIAI 043 7222 389

BALGOWLAH, NSW 2093.

Jim O'Brien Principal Designer // Director (RIAI Arch.Tech.) (Affiliate RAIA)

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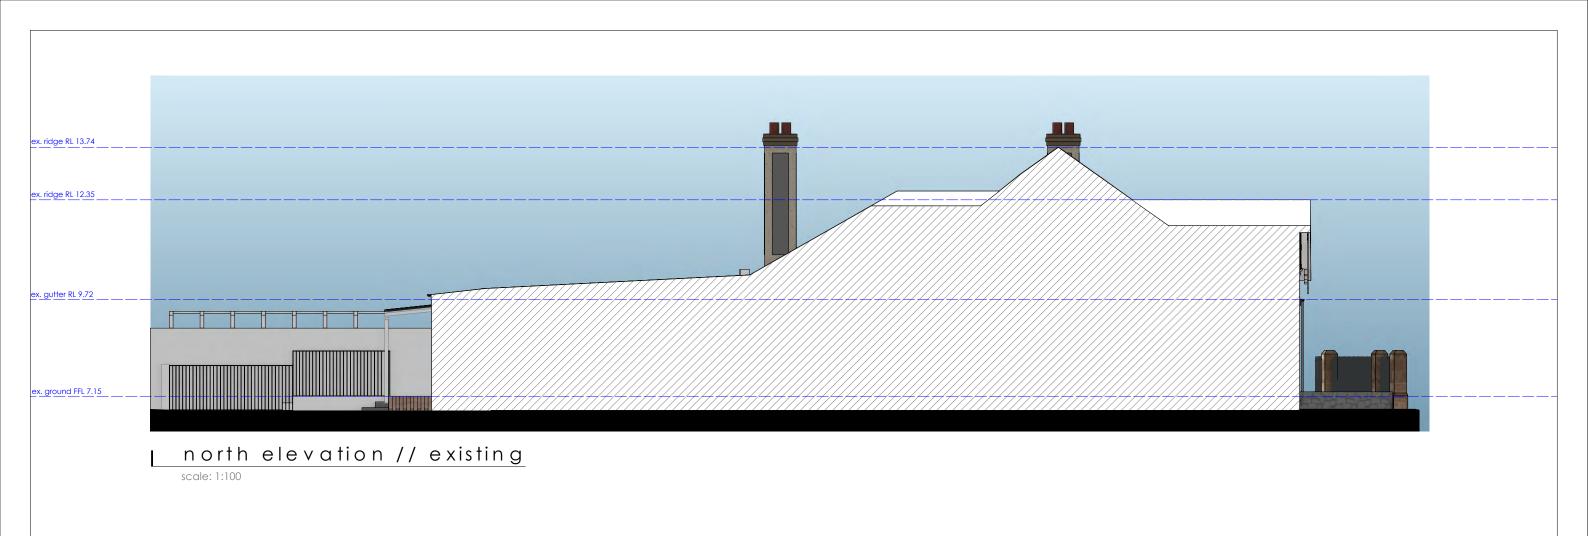
demolitions


extent of additions

B. & C. Laws Alterations & additions

1:100@a3

(DA) DA//09



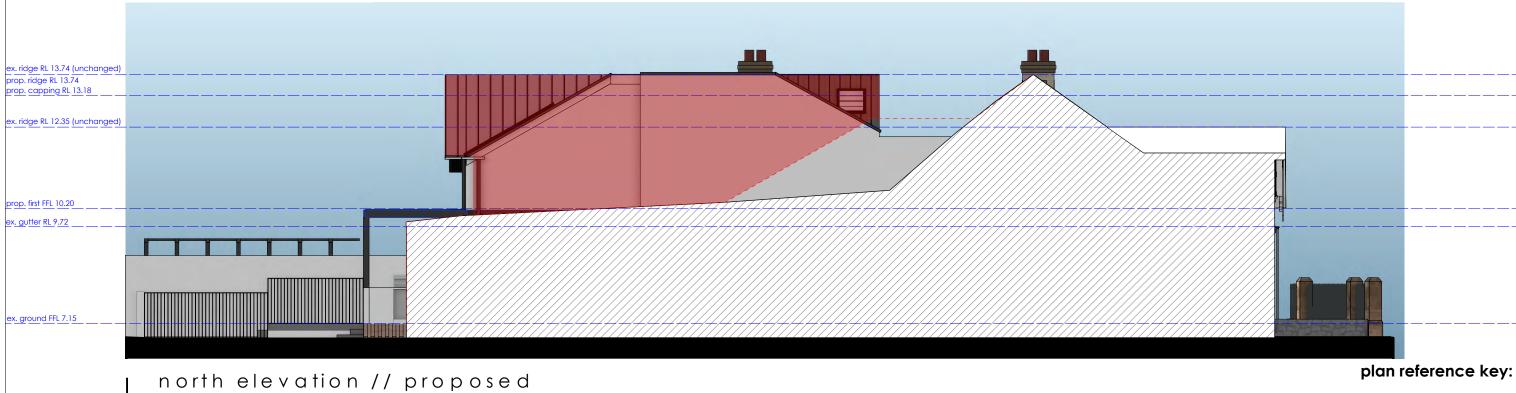

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address:	
166 Pit LOT 10	twater Rd, Manly, NSW 2095. 7 IN DP1176623
client:	B. & C. Laws

project: Alterations & additions

Elevations N // Exg. & Prop.

drawn by: scale:

JOB

& Prop. 20/12/2022 scale: dwg. no.: 1:100 @ a3 D A // 10

Rev. no.:

issue:

(DA)

RIAI
Architectural Technologist
2022

Jim O'Brien Principal Designer // Director (RIAI Arch.Tech.) (Affiliate RAIA)

2022 (Affiliate RAIA)

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demolitions

extent of additions



south elevation // existing

scale: 1:100



south elevation // proposed

scale: 1:100

plan reference key:

demolitions

litions

extent of additions

ons

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LOT 107	water Rd, Manly, NSW 2095. 7 IN DP1176623
client:	B & C Laws

Alterations & additions

Elevations S // Exg	& Prop
drawn bv:	scale:

1:100@a3

JOB

a3	DA//11	(DA)
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© VIEW//THRU	20/12/2022	Α
	date:	Rev. no.:




Jim O'Brien Principal Designer // Director (RIAI Arch.Tech.) (Affiliate RAIA)

2022 (A ffiliate R A IA)

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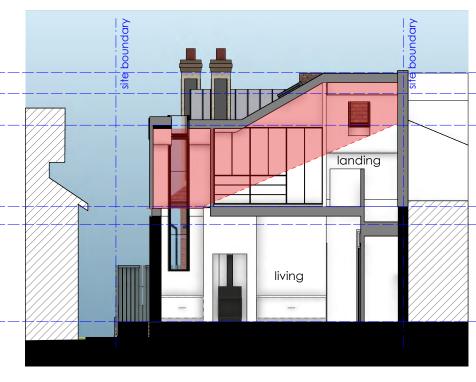






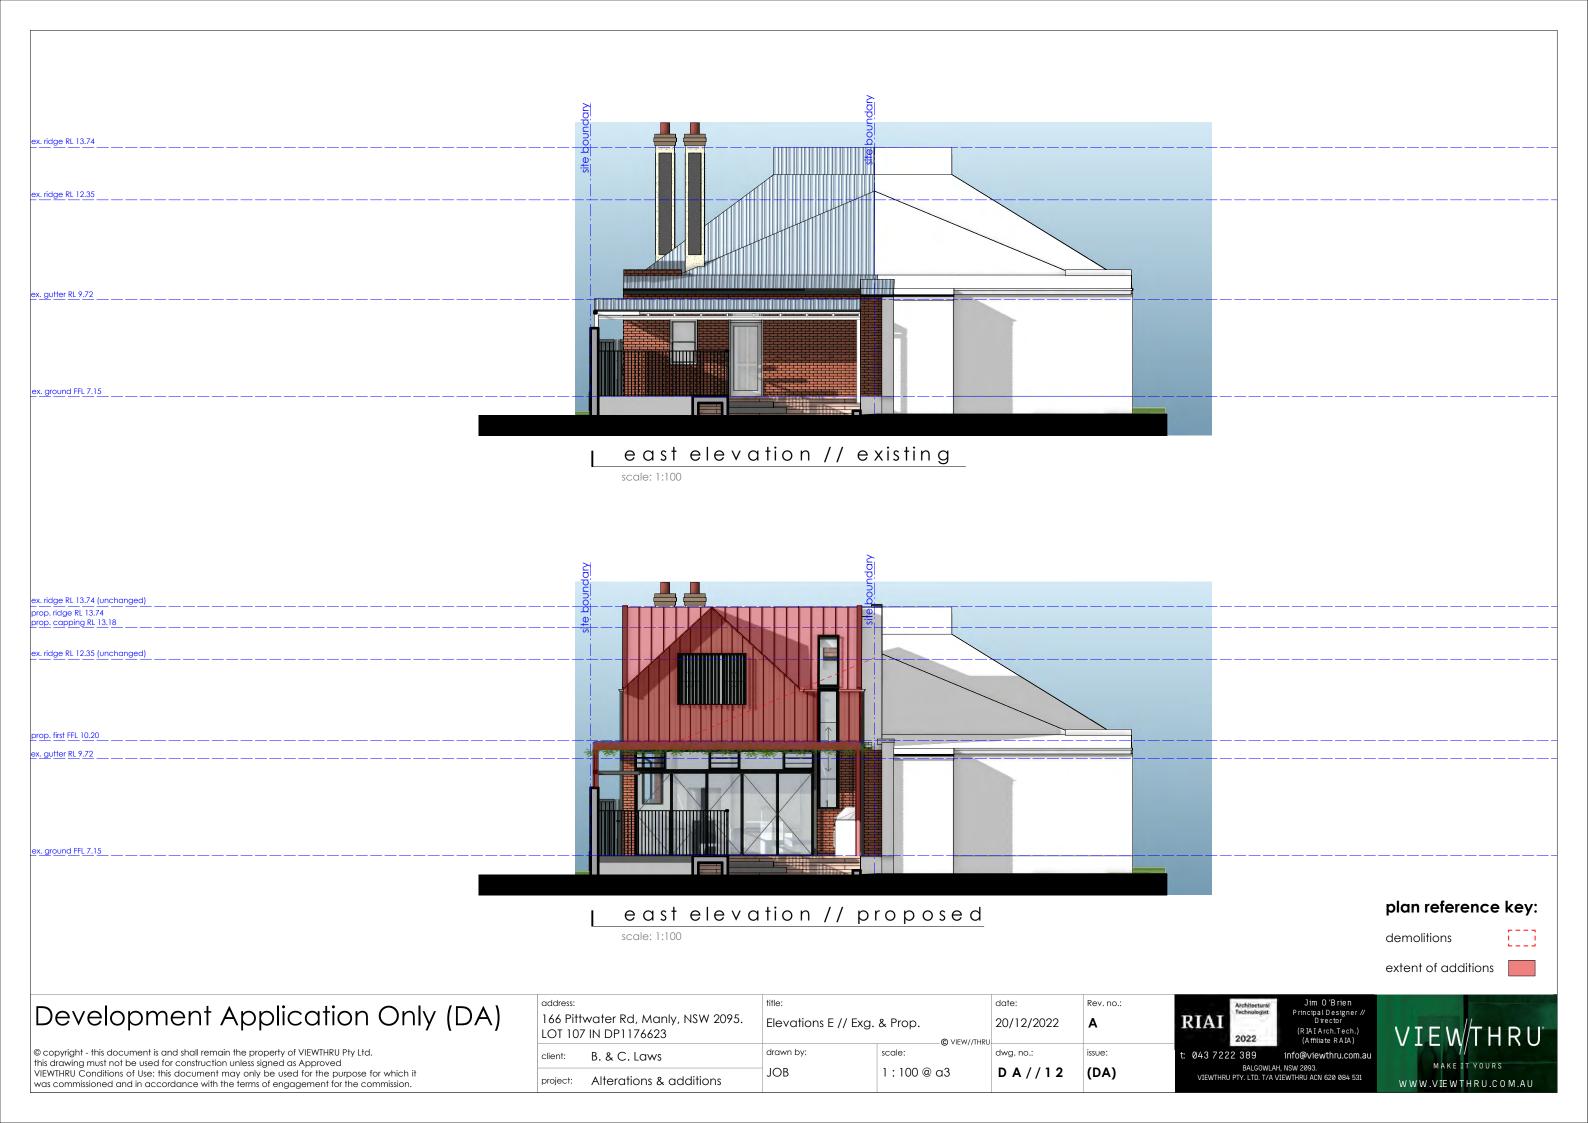





section c - c // proposed

scale: 1:100

issue:

(DA)

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client:	B & C	Laws		
LOT 107	IN DP11	76623		
166 Pittv	vater Ro	d, Manly,	NSW	2095.
addicss.				

Alterations & additions

drawn by:

JOB

Elevations W // Exg. & Prop. scale:

1:100@a3

20/12/2022 dwg. no.:

DA//13

Rev. no.: Α

RIAI

043 7222 389

Jim O'Brien Principal Designer // Director (RIAI Arch.Tech.) (Affiliate RAIA)

info@viewthru.com.au BALGOWLAH, NSW 2093.

VIEWTHRU PTY. LTD. T/A VIEWTHRU ACN 620 084 531



plan reference key:

DOOR SCHEDULE								
IMAGE	ID	Туре	Opening Height	Opening Width	Unit Area	Glazing Type	No. Doors	Comments
	D01	Stacking Door	2250 mm	4750 mm	10.688 m2	REFER TO BASIX		

WINDOWS SCHEDULE							
IMAGE	ID	Туре	Opening Height	Opening Width	Unit Area	Glazing Type	Comments
<u>↓</u>	W01	Sashless DH Window	1575 mm	450 mm	0.709 m2	REFER TO BASIX	
<u>↑</u>	W02	Sashless DH Window	3520 mm	565 mm	1.989 m2	REFER TO BASIX	
$\begin{array}{ c c c c c c c c c c c c c c c c c c c$	W03	Sashless Sliding Window	650 mm	2500 mm	1.625 m2	REFER TO BASIX	
	W04	Louvre Window	550 mm	4750 mm	2.612 m2	REFER TO BASIX	louvre // fixed
↑ ↓	W05	Sashless DH Window	3144 mm	565 mm	1.776 m2	REFER TO BASIX	

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address:	
166 Pittv LOT 107	vater Rd, Manly, NSW 2095. IN DP1176623
client:	B. & C. Laws

project: Alterations & additions



BALGOWLAH, NSW 2093. VIEWTHRU PTY. LTD. T/A VIEWTHRU ACN 620 084 531





WINDOWS SCHEDULE							
IMAGE	ID	Type	Opening Height	Opening Width	Unit Area	Glazing Type	Comments
	W06	Sashless DH Window	1500 mm	750 mm	1.125 m2	REFER TO BASIX	
	W07	Sashless DH Window	1350 mm	1800 mm	2.43 m2	REFER TO BASIX	
	W08	Louvre Window	650 mm	750 mm	0.487 m2	REFER TO BASIX	

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LOT 107	N DP1176623 B. & C. Laws
LOT 107	N DP1176623
166 Pitty	ater Rd, Manly, NSW 2095.
address:	

Alterations & additions

title:			
Ex. Door & Win Sch	ed. Sht 2 o	f 2	
		© VIEW//THRU	
drawn by:	scale:	,, ,	•
JOB			

Rev. no.: 20/12/2022 Α dwg. no.: issue: DA//15 (DA)



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ROOF TILES & RIDGE TILES

existing retained



BRICKWORK existing retained



WINDOWS painted timber existing retained





METAL ROOFING

Eg. Lysaght Enseam 'Basalt' or similar



EXTERNAL CLADDING

timber contemporary profile painted eg. 'Basalt' or similar



ALUMINIUM WINDOW AND EXTERNAL **DOOR FRAMES**

Color - eg. Domino or similar to new works as denoted

external finishes schedule

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address:	
	water Rd, Manly, NSW 2095. IN DP1176623
client:	B. & C. Laws

project: Alterations & additions

(DA)



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043 7222 389




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drawn by: scale: JOB

DA//16



existing // proposed shadow diagrams
June 21st 9am
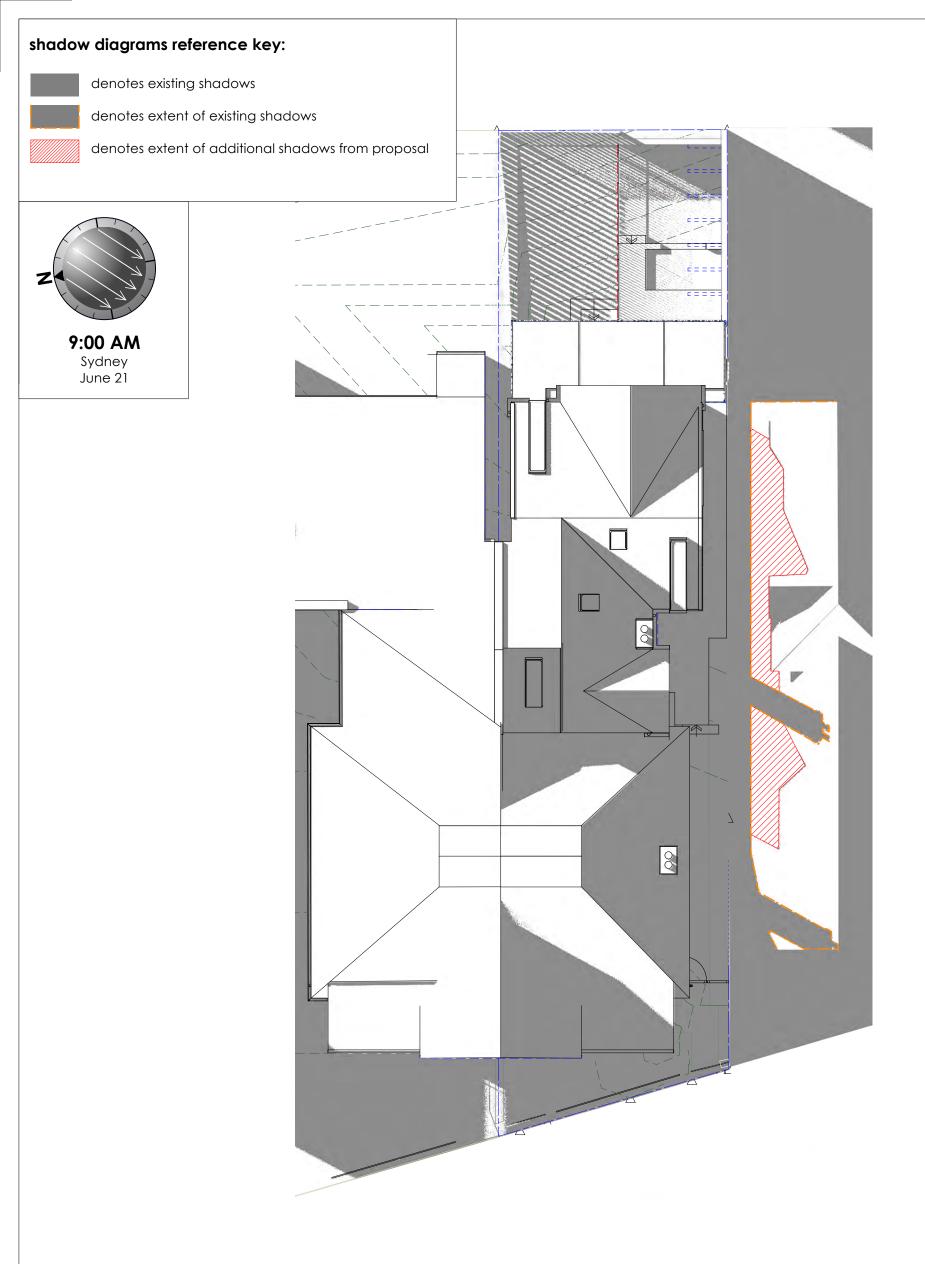
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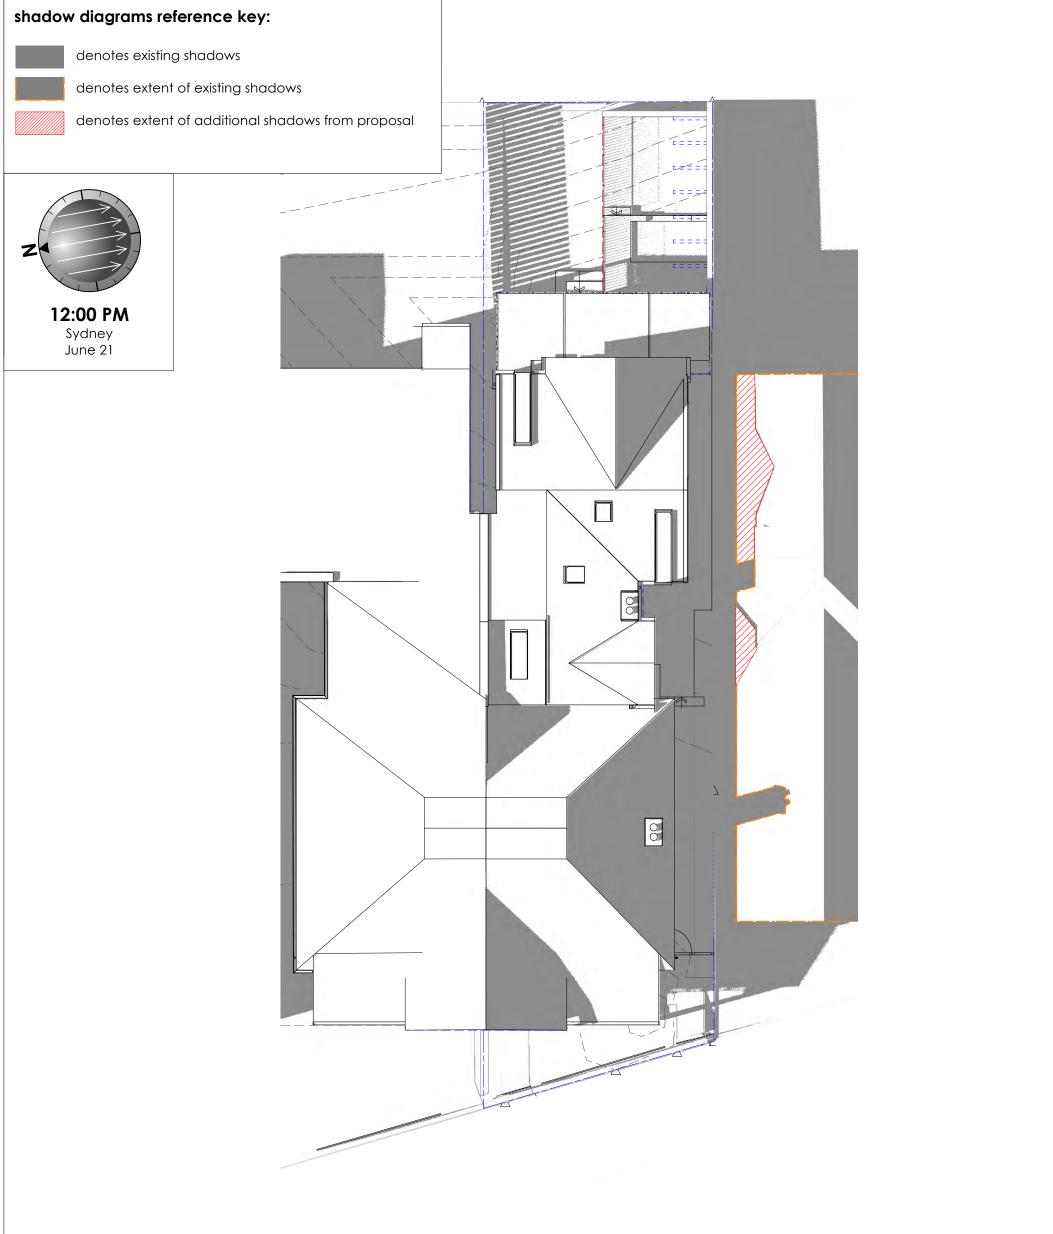
			10 0		
	address:		title:		
166 Pittwater Rd, Manly, NSW 2095. LOT 107 IN DP1176623		, ,	Shadow Diagram June 21st 9am		1
	client:	B. & C. Laws	drawn by: JOB	scale: 1:125@a3	3
	project:	Alterations & additions	306	1.123 @ 03	











existing // proposed shadow diagrams June 21st 12pm

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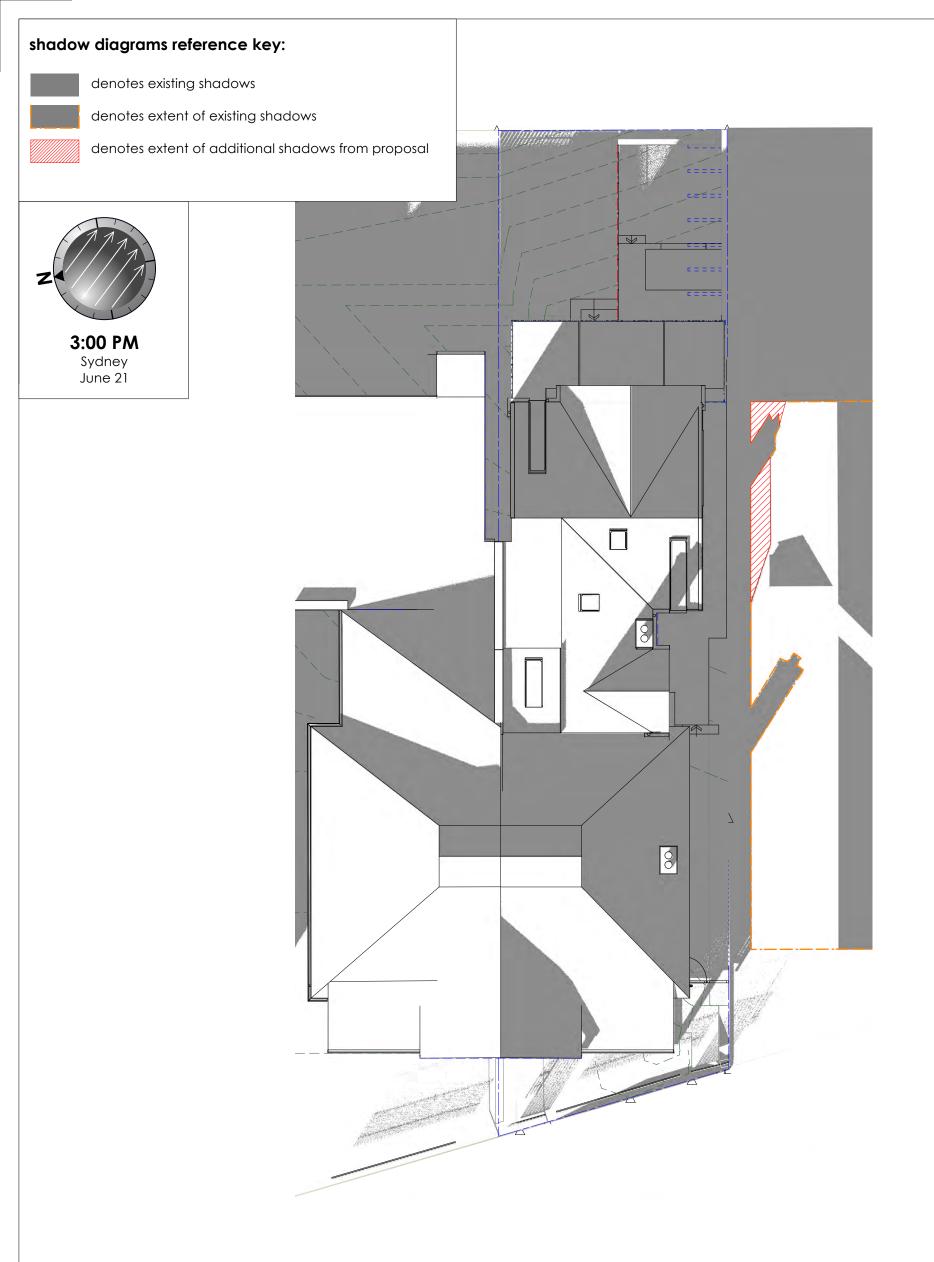
- •			•, (.	
address:		title:		
166 Pittwater Rd, Manly, NSW 2095. LOT 107 IN DP1176623		Shadow Diagram June 21st 12pm		
client:	B. & C. Laws	drawn by: JOB	© VIEW//THRU scale: 1:125@ a3	5
project:	Alterations & additions	JOB	1.125 @ 03	



date: 20/12/2022	Rev. no.:
dwg. no.:	issue:
DA//18	(DA)







existing // proposed shadow diagrams
June 21st 3pm

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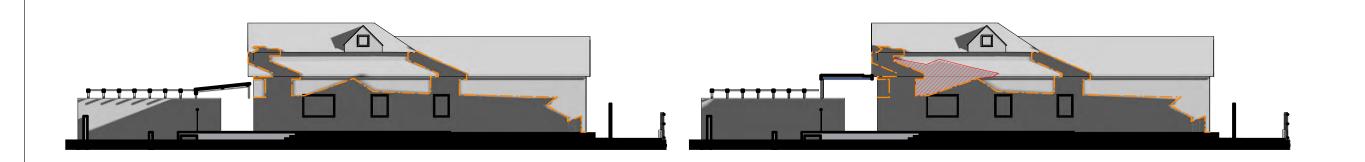
		- - - - - - - - - - - - -		
address:		title:		
166 Pittwater Rd, Manly, NSW 2095. LOT 107 IN DP1176623		Shadow Diagram June 21st 3pm		
client:	B. & C. Laws	drawn by: JOB	scale: 1:125 @ a3	3
project:	Alterations & additions	100	1.123 @ 03	
















3:00 PM Sydney June 21

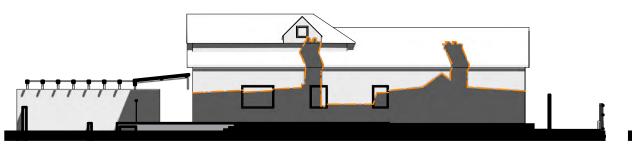




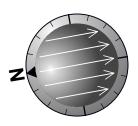

12:00 PM Sydney June 21

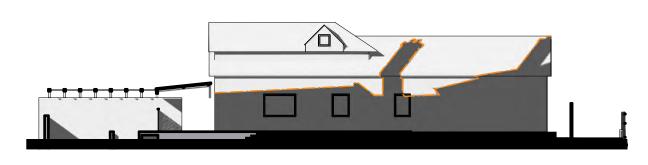



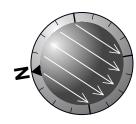

9:00 AM Sydney June 21

existing // proposed shadow diagrams // south neighbour at no. 164 June 21st

shadow diagrams reference key:



denotes existing shadows



denotes extent of existing shadows



denotes extent of additional shadows from proposal

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address:			
166 Pittwater F	Rd, Manly,	NSW	2095
LOT 107 IN DP	1176623		
client: B & C	· Laws		

LOT 107 IN DP1176623		
client:	B. & C. Laws	draw
project:	Alterations & additions	JOE

adow Diagrams Elevations				
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)B	1:200 @ a3			

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1	dwg. no.:	issue:
	20/12/2022	A
	date:	Rev. no.:




hitectural Jim O'Brier Principal Design Director (RIAI Arch.Tec (Affiliate RAIA

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erosion&sediment control plan//site setup plan

scale: 1:200

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		ı	, ,		
address:		title:	title:		
166 Pittwater Rd, Manly, NSW 2095. LOT 107 IN DP1176623		Sed. & Erosion // Site Setup Plan			
client:	B. & C. Laws	drawn by: JOB	scale: 1:100@a3	ち	
project:	Alterations & additions	טטט	1.100@03		

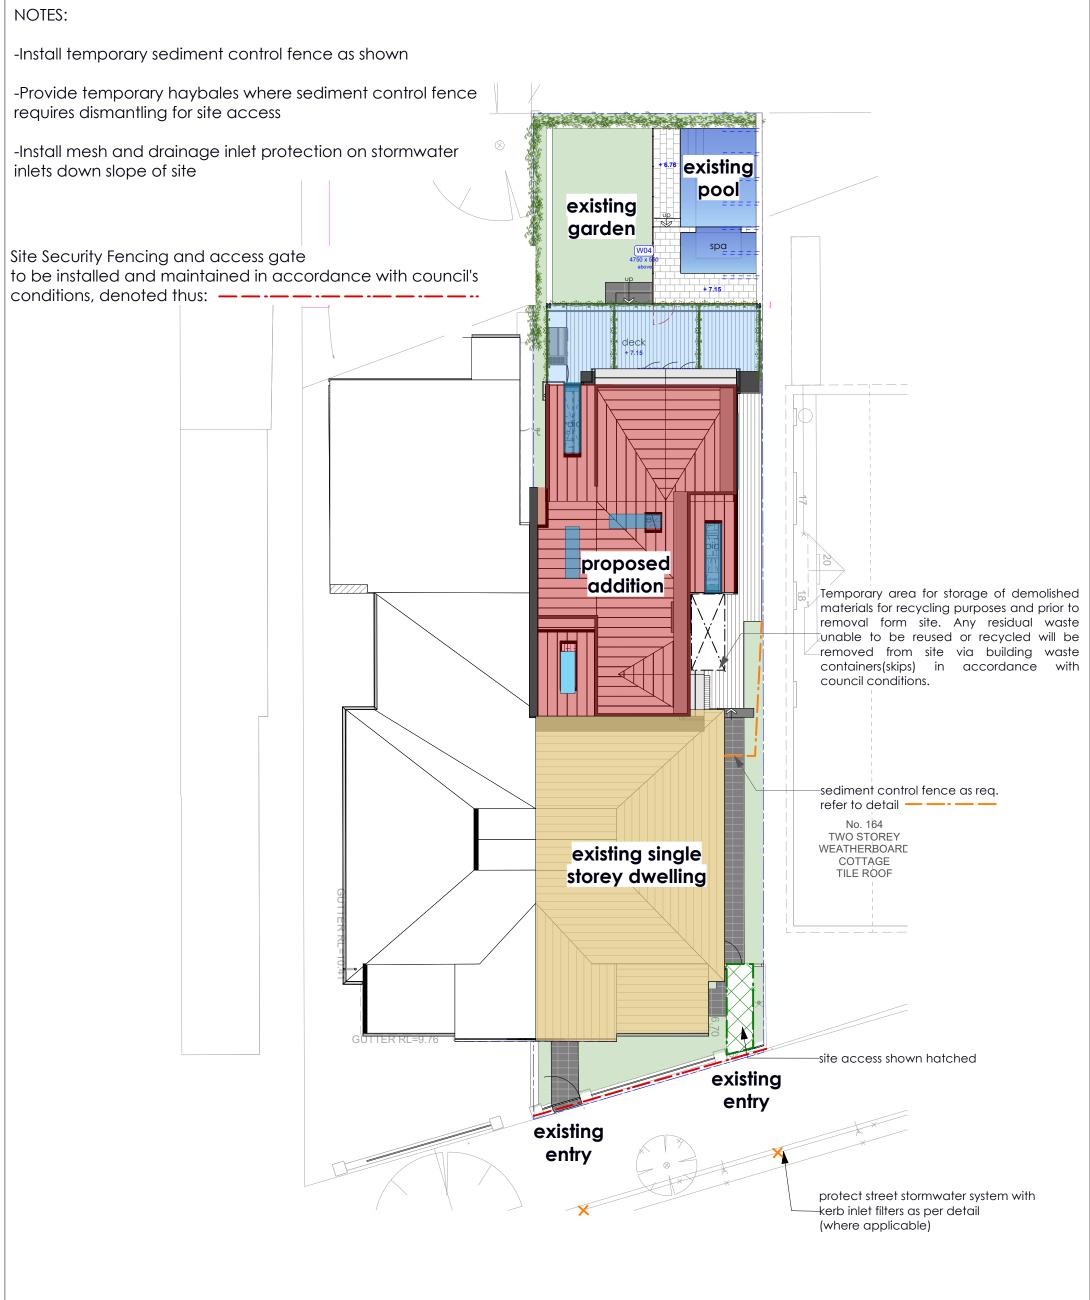

DA//21	(DA)
dwg. no.:	issue:
20/12/2022	A
date:	Rev. no.:





SEDIMENT & EROSION CONTROL - DETAILS TO BE FOLLOWED BY SITE MANAGER / CONSTRUCTION WORKERS

controling contamination on site

avoid contamination of stormwater with sediment, use diversion devices to reduce the volume of stormwater reaching the disturbed area, on compact urban sites avoid overland flow through the work area by installing the final stormwater drainage system as early as possible in the construction process. before installation of the final stormwater system, install an up-slope perimeter bank and catch drain connected to a temporary drop pipe, to take uncontaminated stormwater directly to the stormwater system, on steep sites, line catch drains with turf or geotextile fabric.

uncontaminated stormwater from the channel should discharge to the stormwater system. in some cases discharge onto non-erodable areas of land is permissible. check with your local council. do not allow discharge into neighbouring properties, roof drainage must discharge to the stormwater system, unless rainwater is being harvested. complete the final stormwater drainage system before the roof is installed, connect using either temporary or permanent downpipes

designated site manager/builder

prior to commencement of work a site manager or builder must be nominated. the site manager or builder will be responsible and liable for all works carried out on the site, this assumes the resonsibility for the actions of all subcontracted parties as well as advising them of council's requirements when carrying out works.

topsoil management

prior to the stripping of topsoil, the vegetative cover must be reduced by either slashing or mowing.

all topsoil is to be retained and protected for reuse on site.

soil stockpiles must not be located on nature strips, footpaths, roadways, kerbs, accessways, within drainage lines/flows/paths or around or against tree shrubs. sediment control measures must be incorporated with any resulting stockpile. the stockpile can be protected from erosion by covering it with an impervious material, in conjunction with the installation of a sediment fence around it.

if stockpiles are to remain for more than one month they are to be grassed immediately and stabilised within fourteen days. surplus topsoil must be reasonably removed from site.

builiding material stockpiling

sufficient area must be allocated within the site for such storage of building materials, demolition waste, waste containers, etc. as will be required.

sediment fences

a sediment fence should be located along the downslope boundary(s) of the site, on the construction side of the turf filter strip or native vegetation, and around all stockpiles of material on the site.

vehicle movements

to limit disturbance to the site and tracking of material onto the street all vehicles and plant equipment are to use a single entry/exit point unless coumcil has approved alternative

access points and aprking areas are to be stabilised with compacted sub-grade as soon as possible after their formation.

where spillage does occur it is to be contained immediately and carefully removed. the area affected is to be restored to a standard equal to or better than its previous condition.

all vehicles are to be washed prior to existing the site. this serves the purpose of removing site material on the vehicle and prevents it from being deposited on the road network adjacent to the site and thus, the storwater system, all polluted water must be retained on site for treatment before it is discharged into the stormwater system.

no vehicle associated with the work is to be parked on a footpath or public reserve.

all vehilces visiting the site during demolition, excavation and/or construction works, are to comply with the parking requirements in that area.

sediment traps

where a sediment fence is not used appropriate sediment traps should be located at all points where stormwater leaves the construction site or leaves the gutter and enters the drainage system, a common technique is the gravel sausage.

diversion channels

a diversion channel is an excavated earth ditch or path. these structures aree used to intercept and direct run-off to a desired location where possible.

all stormwater run-off flowing onto disturbed areas, including stockpiles, must be intercepted, diverted and/or safely disposed of, this can be achived by constructing a temporary earth bank around the upslope extent of the construction site where the diversion does not affect the neighbouring properties.

dust control

all trucks/utes must cover their loads at all times.

appropriate methods are to be employed to prevent blowing dust creating an unacceptable hazard or nuisance on the site or down wind, production of dust can be minimised by limiting area of earthworks, watering and progressive vegetation.

where dust is created as a result works and/or soil exposure. the bare soil areas must be watered, during and/or at the end of each day to lay the dust.

earth movong activities should be avoided where winds are sufficiently strong enough to raise visible dust.

drawn by

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erosion & sediment controls

appropriate erosion and sediment controls must be implemented on all sites that involve soil disturbance, the measures must be in place prior to the commencement of work.

those controls are to be monitored and maintained in order to serve their intended function for the duration of thw works or until such time as the site is fully stabilised, if any controls are damaged or become ineffective during the course of the works they are to be reinstated or replaced immediately, sufficient access to these controls must be provided in case of the need

post-construction and erosion control

stabilise the site as soon as possible after construction, or while the last trades are finishing, to minimise the potential for ongoing soil erosion. turf lawns are commonly used to stabilise soil but their high water consumption can be an environmental burden. native ground cover plants do the same thing with considerably lower water use. avoid replacing native vegetation with turf.

mulch (straw or other material) can be used on open garden beds to protect soil and support plant growth. mulch spread to a depth of 75-100mm minimises soil and water loss and controls weed growth, mulch may be less suitable on steep sites and in high wind areas.

temporary, quick germinating grasses such as rye and oats can be used to stabilise soil until slower growing plants can be established. this method is only effective after the grass seeds have germinated and established a root structure.

semi permeable paving can be used to stabilise areas of the site. avoid excessive use of hard surfaces that prevent stormwater being absorbed. biodegradable erosion control mats are useful when revegetating steep slopes.

integrate landscaping strategy with sediment control. for example, diversion channels and trenches that filter sediment can be used with rubble in the base to create a deep root planting opportunity.

Development Application Only (DA)

Alterations & additions

B. & C. Laws

scale:

Rev. no. 20/12/2022 Α

issue:

(DA)

dwg. no.:


DA//22





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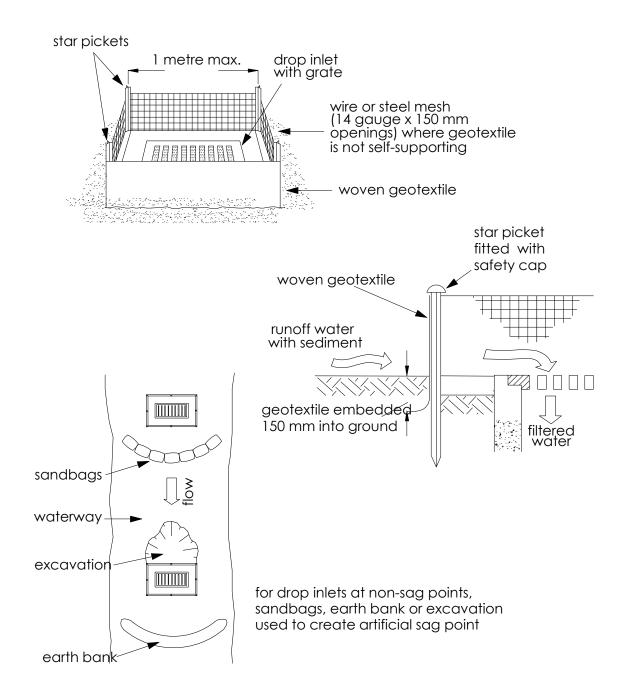
construction notes

- 1. construct sediment fences as close as possible to being parallel to the contours of the site, but with small returns as shown in the drawing to limit the catchment area of any one section. the catchment area should be small enough to limit water flow if concentrated at one point to 50 litres per second in the design storm event, usually the 10-year event.
- 2. cut a 150-mm deep trench along the upslope line of the fence for the bottom of the fabric to be entrenched.
- 3. drive 1.5 metre long star pickets into ground at 2.5 metre intervals (max) at the downslope edge of the trench. ensure any star pickets are fitted with safety caps.
- 4. fix self-supporting geotextile to the upslope side of the posts ensuring it goes to the base of the trench. fix the geotextile with wire ties or as recommended by the manufacturer. only use geotextile specifically produced for sediment fencing. the use of shade cloth for this purpose is not satisfactory.
- 5. join sections of fabric at a support post with a 150-mm overlap.
- 6. backfill the trench over the base of the fabric and compact it thoroughly over the geotextile.

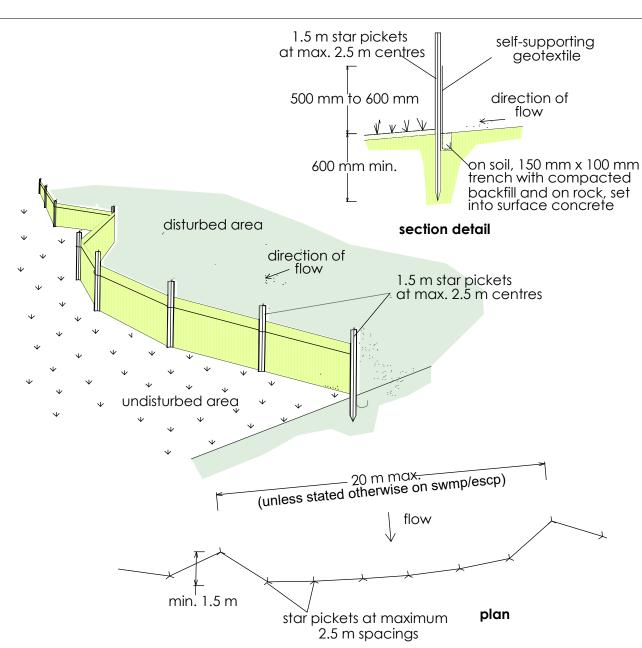sediment fence

sd 6-8

Alterations & additions



construction notes

- 1. fabricate a sediment barrier made from geotextile or straw bales.
- 2. follow standard drawing 6-7 and standard drawing 6-8 for installation procedures for the straw bales or geofabric. reduce the picket spacing to 1 metre centres.
- 3. in waterways, artificial sag points can be created with sandbags or earth banks as shown in the drawing.
- 4. do not cover the inlet with geotextile unless the design is adequate to allow for all waters to bypass it.

geotextile inlet filter

sd 6-12

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client:	B. & C. L	.aws		
LOT 107	IN DP117	76623		
166 Pittw	vater Rd.	Manly.	NSW	2095
address:				

Sed & Erosion Control Details Sht 2

drawn by:

JOB

date:

20/12/2022

A

dwg. no.:

D A / / 2 3 (DA)

RIAI
Architectural Technologist
2022

Jim O'Brien
Principal Designer //
Director
(RIAI Arch.Tech.)
(Affiliate RAIA)


t: 043 7222 389 info@viewthru.com.au


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SEDIMENT & EROSION CONTROL - DETAILS TO BE FOLLOWED BY SITE MANAGER / CONSTRUCTION WORKERS





stakes driven 500min - 700mm aggregate wrapped in fibre into ground cloth or geotextile direction of flow spacing and drain lining subject to drain grade and water velocity

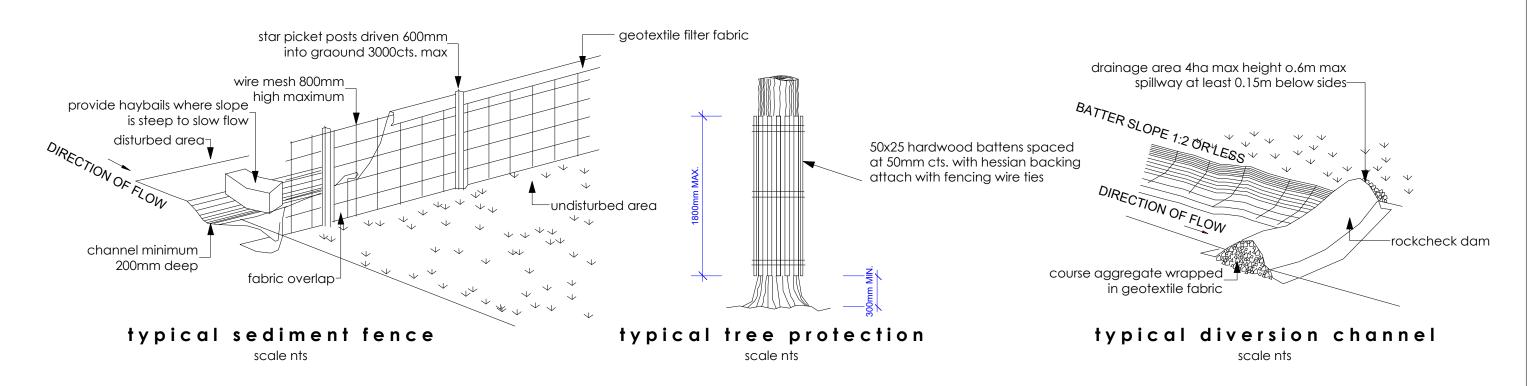stabilised site access

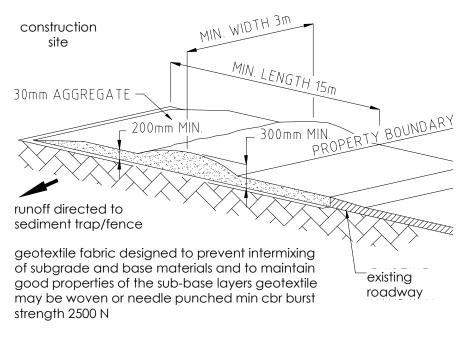scale nts

Sed & Erosion Control Details Sht 3 drawn by: scale:

Rev. no.: Α

(DA)

gravel sock check

scale nts

RIAI

(RIAI Arch.Tech.

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166 Pittwater Rd, Manly, NSW 2095. LOT 107 IN DP1176623 B. & C. Laws


Alterations & additions

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20/12/2022

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6-Elaeocarpus eumundi

21-Gardenia augusta 'Florida'

Plant List Mature Height | Mature Spread | Remarks Qty **Common Name Botanical Name** Scheduled Size Trees Smoothed leaved Quandong 100 Ltr 5 - 10m 2.0 - 3.5m Native (Existing) Elaeocarpus eumundi Southern Magnolia 75 Ltr 15 - 20m 15 - 20m Magnolia grandiflora Shrubs Gardenia augusta 'Florida' 600 mm 21 Gardenia 300mm 600 mm 58 Total

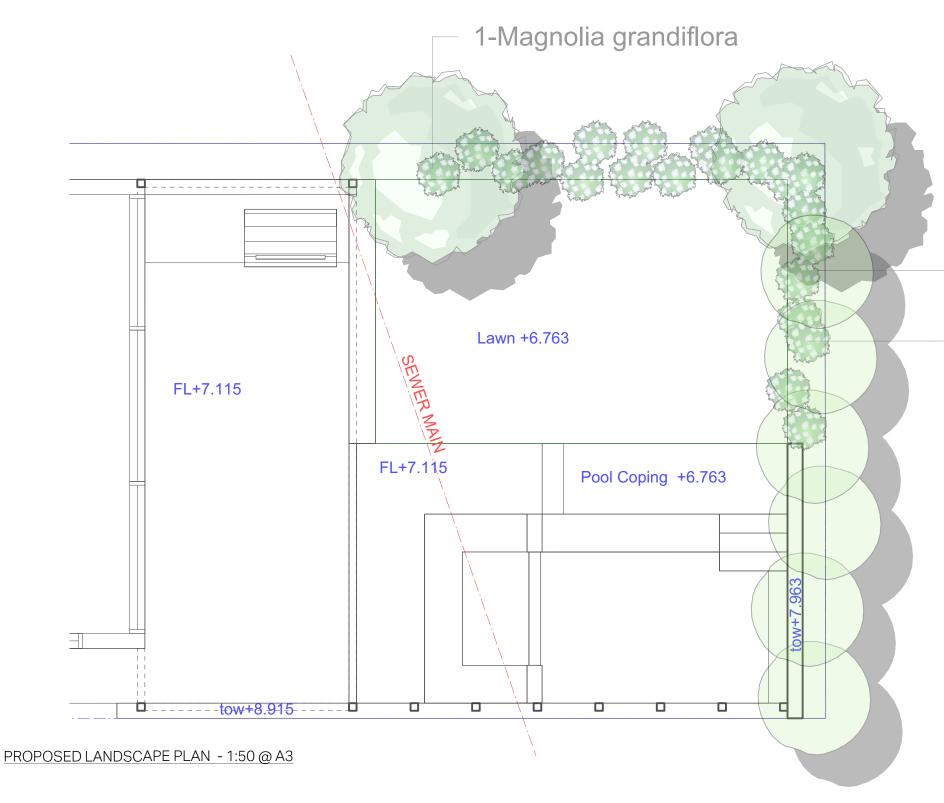PREV. APPROVED DA CONSENT: DA2020/0482

Notes:

This drawing is for design guidance only. final details must meet site conditions, relevant authorities and applicable building standards. verify all dimensions on site and with detailed site survey prior to off site fabrications.

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02 9818 3377 goodmanors.com.au

Laws Residence 166 Pittwater Road Manly NSW 2095.

1

Drawn	Scale	Date	Dwg No	Rev
Drawn By PP	1:50 @ A3	10.04.20	I PP 01	
Drawing Title		LPPUI	A	
Landscape Plan Proposed plant list				