SYDNEY
BUILDING
APPROVALS
CENTRE

- · Principle Certifying Authority
- Building Regulation Consultation
- NatHERS Certifications
- Town Planning
- Building Approvals
- Inspections

SYDNEY BUILDING APPROVALS CENTRE PTY LTD

ABN 96 081 945 904

Unit 18 Christies Homemaker Centre

173-185 Canterbury Road, Bankstown NSW 2200

Phone: 9790 4741

• Fax: 9796 4792 DX 11215 BANKSTOWN www.sbac.com.au

RESIDENTIAL • INDUSTRIAL • COMMERCIAL

Date:11 August 2003

Pittwater Council DX 9018, MONA VALE

PREMISES:Lot 13, 12 North Avalon St. North Avalon CONSTRUCTION CERTIFICATE: CC280/03

Dear Sir/Madam,

Please find enclosed a Construction Certificate, Notification of work to commence (Form 7), Plans, Engineers details & specification for the above premises.

Should you require any further assistance to the matter please do not hesitate to contact Sydney Building Approvals Centre on Tel: 9790 4741.

Yours Faithfully

Peter Ruck

Building Surveyor

SCANNED

2 8 AUG 2003

PITTWATER COUNCIL



Our ref: 114-03

25 July 2002

Mr and Mrs Johnson 12 North Avalon Road North Avalon NSW 2107

RE: ALTERATIONS AND ADDITIONS
12 NORTH AVALON ROAD, NORTH AVALON
STORMWATER DRAINAGE CERTIFICATE

We certify that we have inspected the existing stormwater drainage system on the site and advise that subject to the augmentation shown on drawing 114-03/C1 it complies with:

- 1. Australian Rainfall and Runoff published by The Institution of Engineers, Australia.
- 2. The following Australian Standard: AS3500.3.2.
- 3. Accepted Engineering Practice and Principles.

No standards or practices other than the relevant Australian Standards have been relied upon for this certification.

Yours faithfully,

WOOLACOTTS

Stephen Branch

BE(Hons) MEngSc FIEAust CPEng


NPER Structural and Civil - Membership No. 312987

OMATING WELL

N0012/03

- 7 SEP 2003



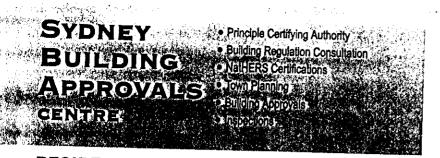

RESIDENTIAL • INDUSTRIAL • COMMERCIAL

SYDNEY BUILDING APPROVALS CENTRE PTY LTD

ABN 96 081 945 904

Unit 18 Christies Homemaker Centre

173-185 Canterbury Road, Bankstown NSW 2200

Phone: 9790 4741

Fax: 9796 4792

DX 11215 BANKSTOWN www.sbac.com.au

CONSTRUCTION CERTIFICATE No.CC280/03

Environmental Planning and Assessment Act 1979 (as amended)

Date of determination:

11 August 2003

Attachments:

Development address:

Lot 13, DP 8394, 12 North Avalon Rd

NORTH AVALON NSW 2107

Applicant:

Mr. Daryl Johnson 12 North Avalon Rd

NORTH AVALON NSW 2107

Plans and specifications

approved

Plans drawings & Specifications

Alterations & Additions to existing dwelling Class la

Certificate

I certify that the work if completed in accordance with these plans and specifications will comply with the requirements of s 8 1 A(5) of the Environmental Planning and Assessment Act 1979

Signature:

Date of endorsement:

11 August 2003

Certificate no:

CC280/03

Certifying Authority

Name of certifying authority:

Peter Ruck

Accreditation no.: B.S.A.P.

2603

Development consent

Number and date of

N0022/03

Determination:

2 May 2003

Sydney Building Approvals Centre Application for a construction certificate

Date received: 4 / 6 / 03 DA no:	N0022	৩ও						
If you want to carry out some building wo work. You can use this form to apply to u	ork, you need a dis for a construc	construction certificate be tion certificate.	fore you can start					
If you propose to submit this application application please talk to us first. Phone	for a constructio our Sydney Bull	n certificate with your ded ding Approvals Centre of	velopment n (02)9790 4741.					
To complete the form, please place a cro appropriate. To minimise delay in rece you submit all relevant information.	oss in the boxes iving a decision	and fill out the white a about your application	sections as n, please ensure					
1. Details of the applicant	Details of the applicant							
NAME Mr ☑ Ms ☐ Mrs ☐ Dr ☐	Other							
First name	Fan	nily name						
Daryl		Johnson						
Company/organisation			ABN					
STREET ADDRESS Unit/street no. Street name 12 North	tua(on	ROAD						
Suburb or town		State	Postcode					
North Avalon		NSW	2107					
POSTAL ADDRESS (or mark 'as above	"							
CONTACT DETAILS								
Daytime telephone Fax		Mobile						
02 - 9918 3733								
Email								
daryldi@dodo.	com, au							
2. Identify the land								
Unit/street no.		Street or property name						
12 ·		North Auglor	v Rona					
Suburb, town or locality		Postcode Lo	cal government area					
North Avalua		2107						
Lot/DP or Lot/Section/DP or Lot/Strata in Please ensure that you put a slash (/) more than one piece of land, you will not Lot 13 / bp 8394.	between lot, sec	tion, DP and strata numb hem with a comma eg 12	pers. If you have 23/579, 162/2.					
(1) Note: You can find the lot, section, I documents for the land, if title was prov this, you will need to contact Land and	ided after 30 Oc	tober 1983. If you have c	locuments older than					

124	Estimated cost of the development
がが	\$ IIO, 000 including GST is a set in the set
	Describe the development
される はなか	What type of work do you propose to carry out? Building work Subdivision work Describe the work
	Alterations and additions to house.
18	
	For building work, what is the class of the building under the Building Code of Australia?
ははいい	class I A and IOA.
を は ない は できる とうない	This can be found on the development consent Has development consent been granted for the development?
の 一日	This can be found on the development consent Has development consent been granted for the development? No Yes What is the development application no.?
がある。 では、 では、 では、 では、 では、 では、 では、 では、	This can be found on the development consent Has development consent been granted for the development?

5.	Signatures	
	The owner(s)* of the land to be developed must if you are not the owner* of the land, you must have Crown land, an authorised officer of the Department application. As the owner(s)* of the above property, I/we conser	all the owners sign the application. If the land is of Land and Water Conservation must sign the it to this application:
		Signature 4 do
	Daryl Johnson	Name Johnson
	Date 4 6 03	Date 4 6 03
	The applicant, or the applicant's agent, must sign	
	Signature Signature	the application.
	Name, if you are not the applicant	In what capacity are you signing if you are not the applicant?
	Dary I Dhron	
	Date 4 6 23	

Privacy policy

The information you provide in this application will enable us to assess your application under the *Environmental Planning and Assessment Act 1979*. If the information is not provided, your application may not be accepted. You have the right to access and have corrected information provided in your application. Please ensure that the information is accurate and advise us of any changes.

Sc	hedi	ule to	о ар	plication fo	ra co	onsi	ruction	certifica	te		•	
Ple	ase coi	mplete	this	schedule. The ir	ıformat	ion w	ill be sent to	the Austra	lian Bureau	of Static	tice	11.
All	new b	uildi	ngs			rist.				S. Claus S. Claus S. F. Gas	iics.	
Plea	ise cor	nplete	the f	ollowing:		ile.						经证据
die gest	Nu	mber	of sto	reys (including u	ındergr	ound	floors)	土	wo	North St.		
	Gro	oss flo	or are	ea of new buildin	ıg (m²)	en au			72 m ²			
	Gro	es sit	e area	a (m²)					26.31	n ²		
Res Plea	identi se com	al bu plete	ilding the fo	gs only blowing details o								
	Nun	nber o	if dwe	ollings to be cons	ni resid	ential	structures:) , —
				部门图 第三型 第二团					ne]
	Nun	nber o	f pre-	existing dwelling	js on si	te		0	ne			
	Num	ber o	f dwe	llings to be dem	olished			По	ne		M-Branco II Salesana	_
	Will build	the ne lings?	w dw	elling(s) be attac	ched to	othe	r new	Yes	□ No [v	7		
	Will	the ne lings?	w bui	ilding(s) be attac	hed to	existi	ng	Yes	_ ✓ No [-]		
• Mate	(IVD)	uai o	ccupa	ontain a dual occ ancy = two dwell al buildings	upancy lings on	/?) the s	same site)	Yes	□ No 🔽	r		
Please	indica	ite the	mate	erials to be used	in the	const	fliction of th	o now hadd				
		·	Code	Roof		Code	Floor	Code	rame		Code	1
Brick (doub Brick	le)		11	Tiles		10	Concrete or slate	20	Timber		40	
(vene			12	Concrete or slate		20	Timber	40	Steel		6 0	
Concr stone Fibre	ete or		20	Fibre cement		30	Other	B0	Aluminium		70	
cemer	it		30	Steel	V	60	Not specified	90	Other		80	
Timbe	r	Ø	40	Aluminium		70	-pecined		Not			٠
Curtair glass	1		50	Other		80			specified		90	
Steel			60	Not specified		90				Arr Ja		
Alumin Other	ium		70		ing # (LA) Ngjarja							
Not specifie	id (90									



OFFICE OF FAIR TRADING

NSW Consumer Protection Agency

Department of Commerce HOME BUILDING ACT 1989

OWNER BUILDER PERMIT

DARYL JOHNSON 12 NORTH AVALON ROAD NORTH AVALON 2107

> Permit :261190P Receipt:AA1760984

Issued: 02/07/2003 Amount: \$126.00

Building Site:

LOT 13, 12 NORTH AVALON ROAD, NORTH AVALON 2107

Authorised Building Work:

N022/03-ADD FL/2BD/LOUNGE/KIT/LAUNDRY/SHED/110SQ BUILDING WORK AS PER BA NO. ISSUED BY PITTWATER COUNCIL


Should the property be sold within 6 years of completion of the work it will be necessary to obtain home warranty building insurance from approved insurers if the value of the work was greater than \$12,000. A certificate of insurance must be attached to any contract for sale.


You should obtain professional advice from general insurers regarding public liability and property damage cover, etc.

Note: This permit is only valid when an official receipt has been imprinted.

If payment is made by cheque, the permit is conditional on the cheque being met at presentation.

Issuing Officer

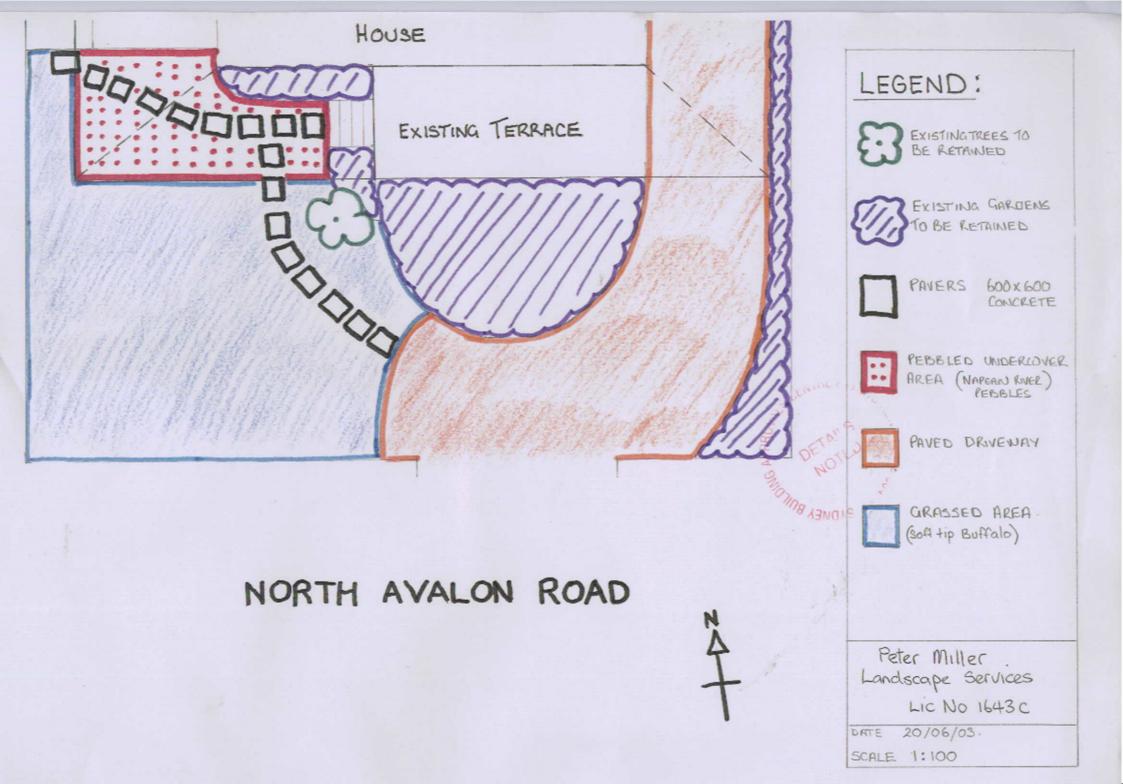


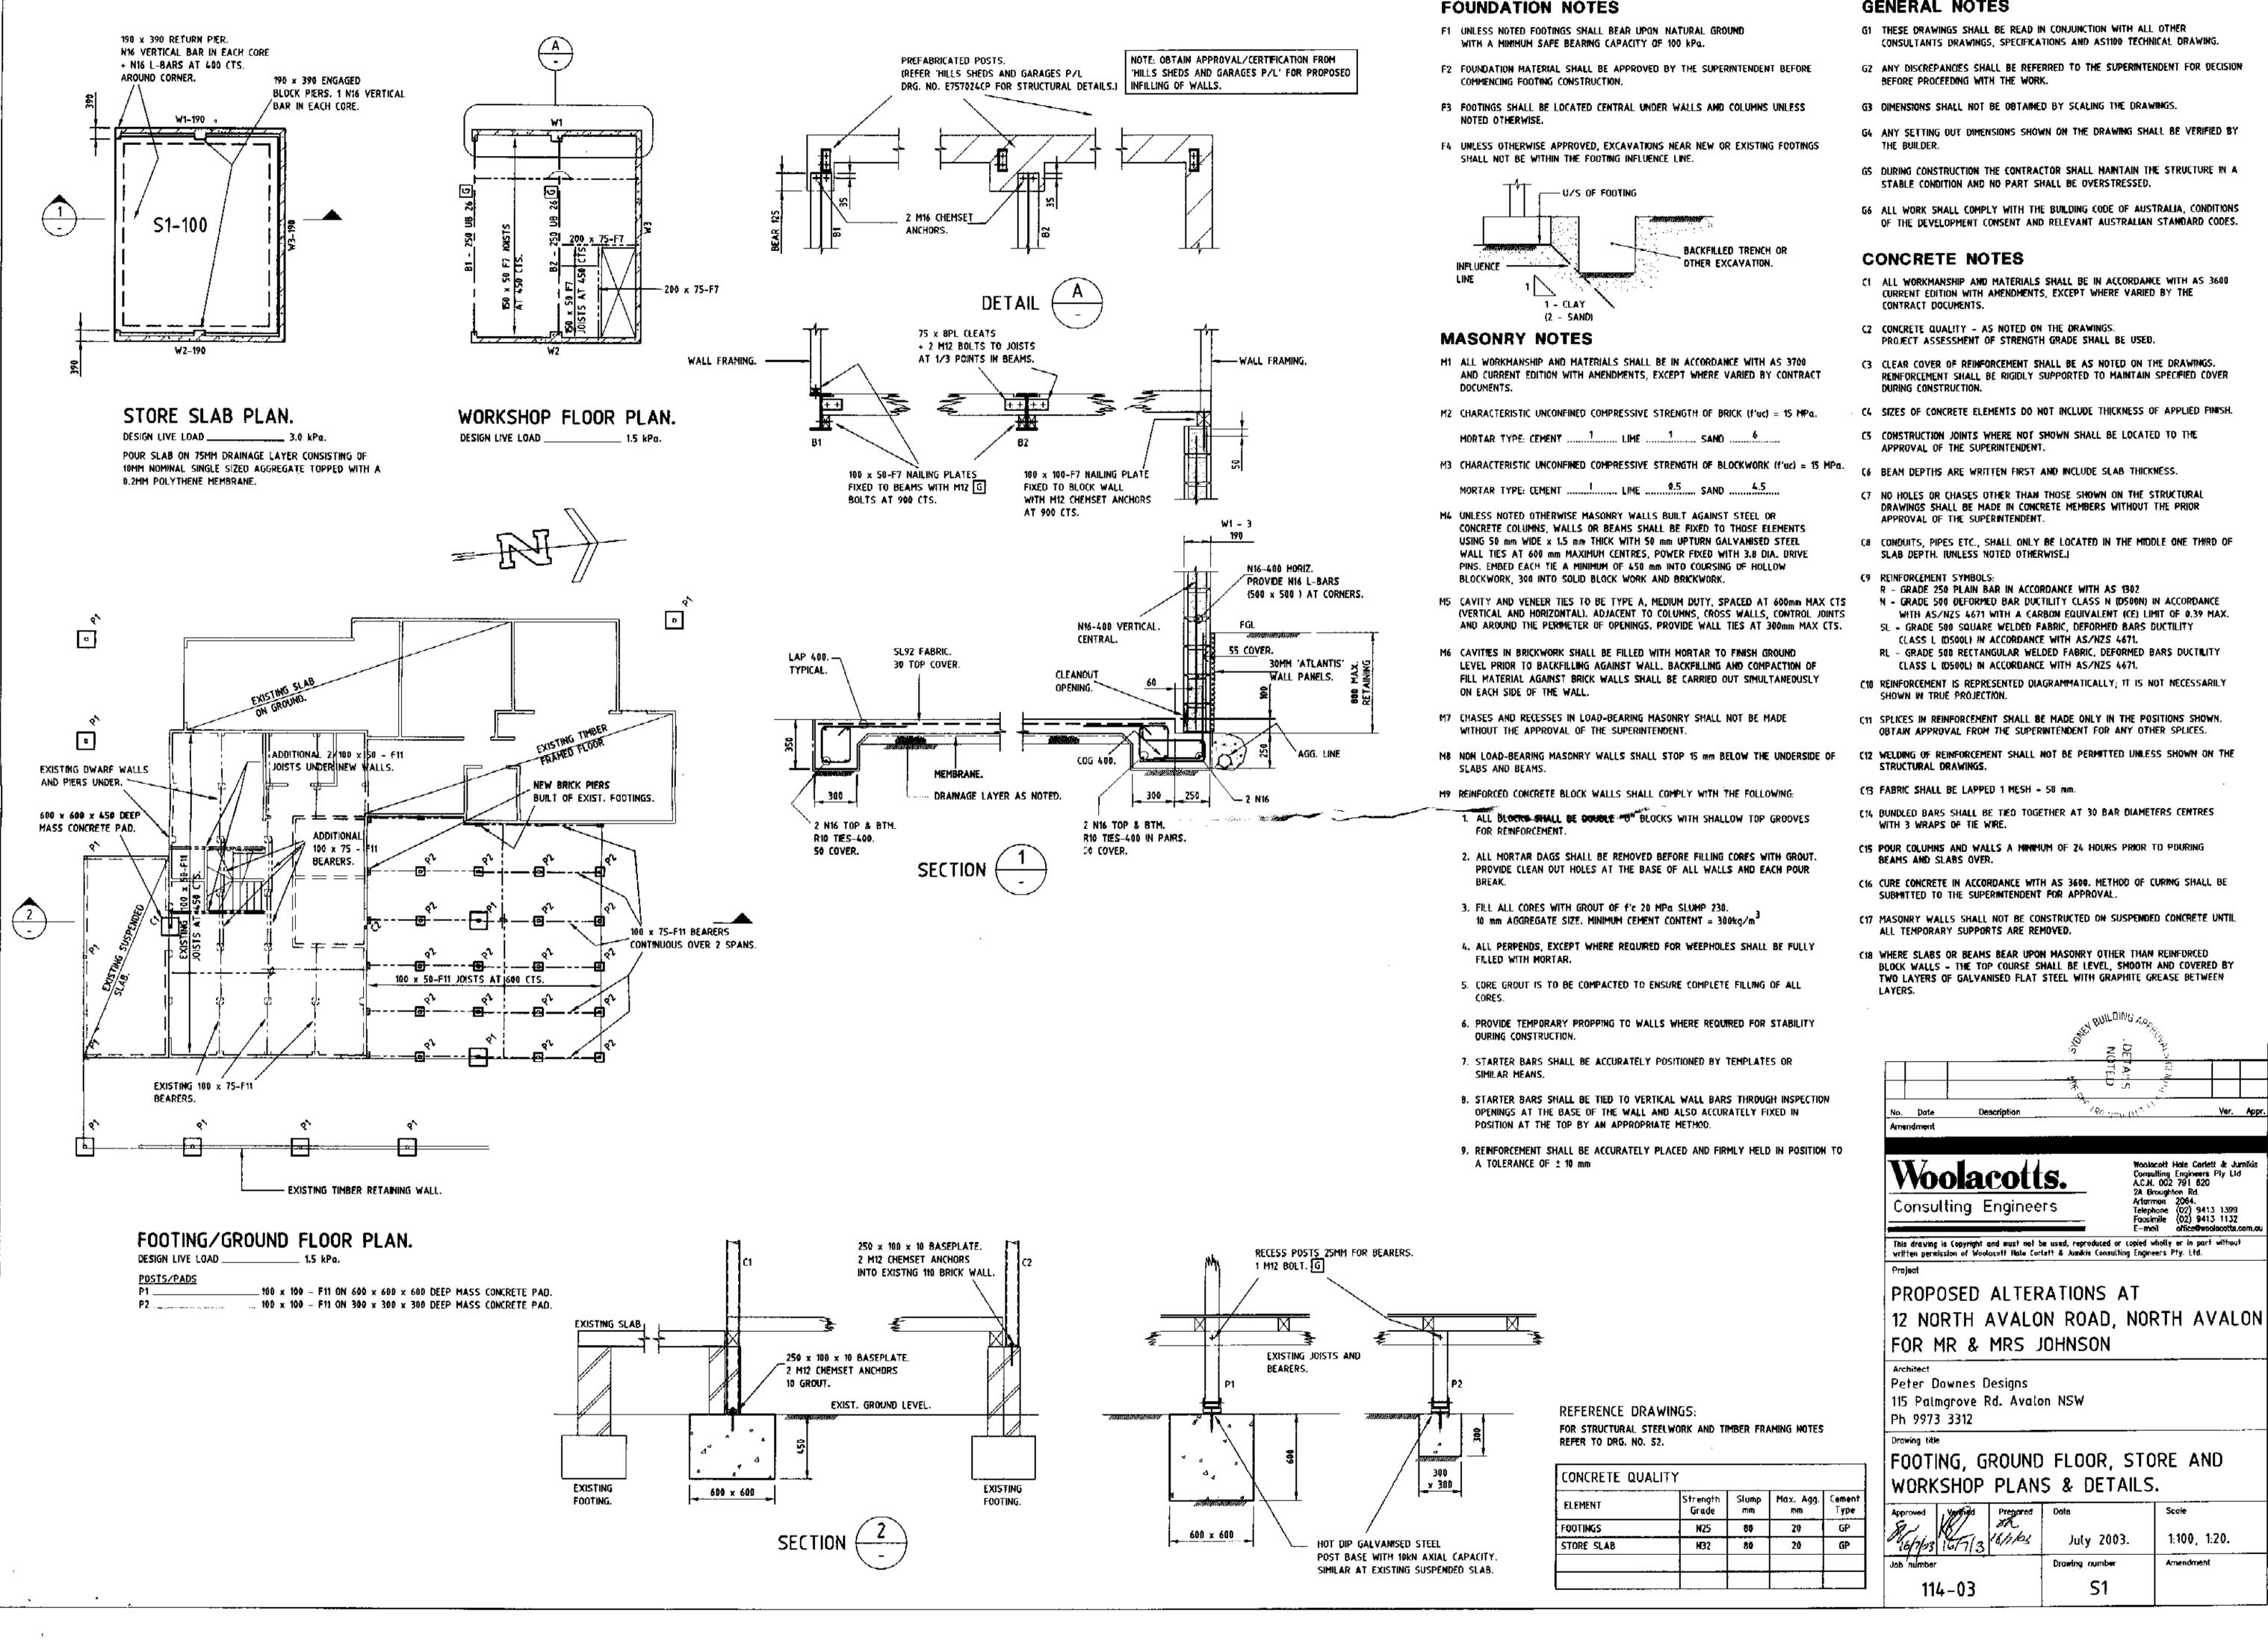


GENERAL NOTES

- G1 THESE DRAWINGS SHALL BE READ IN CONJUNCTION WITH ALL OTHER
- G2 ANY DISCREPANCIES SHALL BE REFERRED TO THE SUPERINTENDENT FOR DECISION
- G4 ANY SETTING OUT DIMENSIONS SHOWN ON THE DRAWING SHALL BE VERIFIED BY
- GS DURING CONSTRUCTION THE CONTRACTOR SHALL MAINTAIN THE STRUCTURE IN A
- G6 ALL WORK SHALL COMPLY WITH THE BUILDING CODE OF AUSTRALIA, CONDITIONS OF THE DEVELOPMENT CONSENT AND RELEVANT AUSTRALIAN STANDARD CODES.
- C1 ALL WORKMANSHIP AND MATERIALS SHALL BE IN ACCORDANCE WITH AS 3600 CURRENT EDITION WITH AMENDMENTS, EXCEPT WHERE VARIED BY THE
- C3 CLEAR COVER OF REINFORCEMENT SHALL BE AS NOTED ON THE DRAWINGS. REINFORCEMENT SHALL BE RIGIDLY SUPPORTED TO MAINTAIN SPECIFIED COVER
- CS CONSTRUCTION JOINTS WHERE NOT SHOWN SHALL BE LOCATED TO THE
- DRAWINGS SHALL BE MADE IN CONCRETE MEMBERS WITHOUT THE PRIOR
- CB CONDUITS, PIPES ETC., SHALL ONLY BE LOCATED IN THE MIDDLE ONE THIRD OF

 - WITH AS/NZS 4671 WITH A CARBON EQUIVALENT (CE) LIMIT OF 0.39 MAX.
- RL GRADE 500 RECTANGULAR WELDED FABRIC, DEFORMED BARS DUCTALITY
- C10 REINFORCEMENT IS REPRESENTED DIAGRAMMATICALLY; IT IS NOT NECESSARILY
- OBTAIN APPROVAL FROM THE SUPERINTENDENT FOR ANY OTHER SPLICES.
- C12 WELDING OF REINFORCEMENT SHALL NOT BE PERMITTED UNLESS SHOWN ON THE
- C14 BUNDLED BARS SHALL BE TEO TOGETHER AT 30 BAR DIAMETERS CENTRES
- C15 POUR COLUMNS AND WALLS A MINIMUM OF 24 HOURS PRIOR TO POURING
- C16 CURE CONCRETE IN ACCORDANCE WITH AS 3600. METHOD OF CURING SHALL BE
- C17 MASONRY WALLS SHALL NOT BE CONSTRUCTED ON SUSPENDED CONCRETE UNTIL
- BLOCK WALLS THE TOP COURSE SHALL BE LEVEL, SMOOTH AND COVERED BY TWO LAYERS OF GALVANISED FLAT STEEL WITH GRAPHITE GREASE BETWEEN

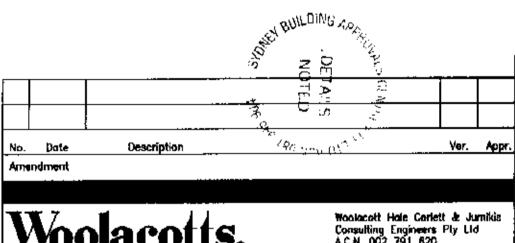

Approved Vertical Prepared	. Vate	Score
86/1/03 16/1/3 16/1/03	July 2003.	1:100, 1:20.
Jab number	Drawing number	Amendment
114-03	S 1	

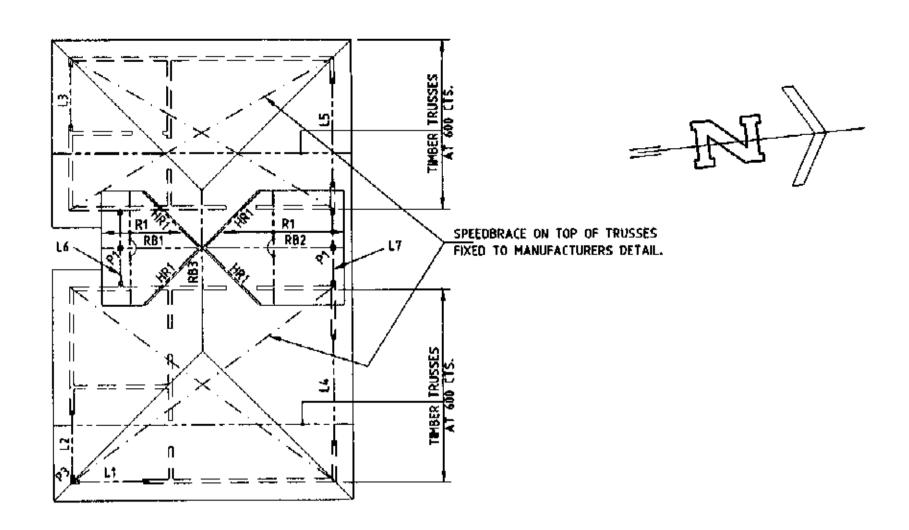

UPPER ROOF PLAN.

PREFIX ALL MARKS 'UR' FOR LEVEL IDENTIFICATION EG. 'URL1' ETC.

<u>MEMBER SIZES</u>	
POSTS P1 TO P3	. 100 x 100 - F7
BEAMS RB1 TO 3	. 175 × 75 - F7
RAFTERS R1	100x 50 - F7 AT 600 CTS.
HIP RAFTERS HR1	. 150 × 38 - F7
LINTELS L1 TO 3,6,7	. 150 x 50 - F7
L4, 5	. 250 x 50 - F7

FIRST FLOOR/LOWER ROOF PLAN.

PREFIX ALL MARKS "I" FOR LEVEL "DENTIFICATION EG. "ITB2" ETC.

TB2, 4, 6 TO 16, 18 _____ 250 x 50 - F7

_ 90 x 90 x 4 SHS [G]

_ 250 UB 31

200 x 75 - F7

150 x 50 - F7

_ 250 x 50 - F7

300 x 75 - F7 _ 200 × 50 - F7 ^{TT}

250 x 50 - F7 _

. 175 x 50 ~ F7

150 × 50 - F7

150 x 50 - F7 - AT 450 CTS.

STEEL MEMBERS

COLUMNS C1, 2

POSTS P1.


RAFTERS R2.


HIP RAFTERS HR2.

TIMBER BEAMS TB1

LINTELS L1, L2 _

STEEL BEAM SB1 TIMBER MEMBERS

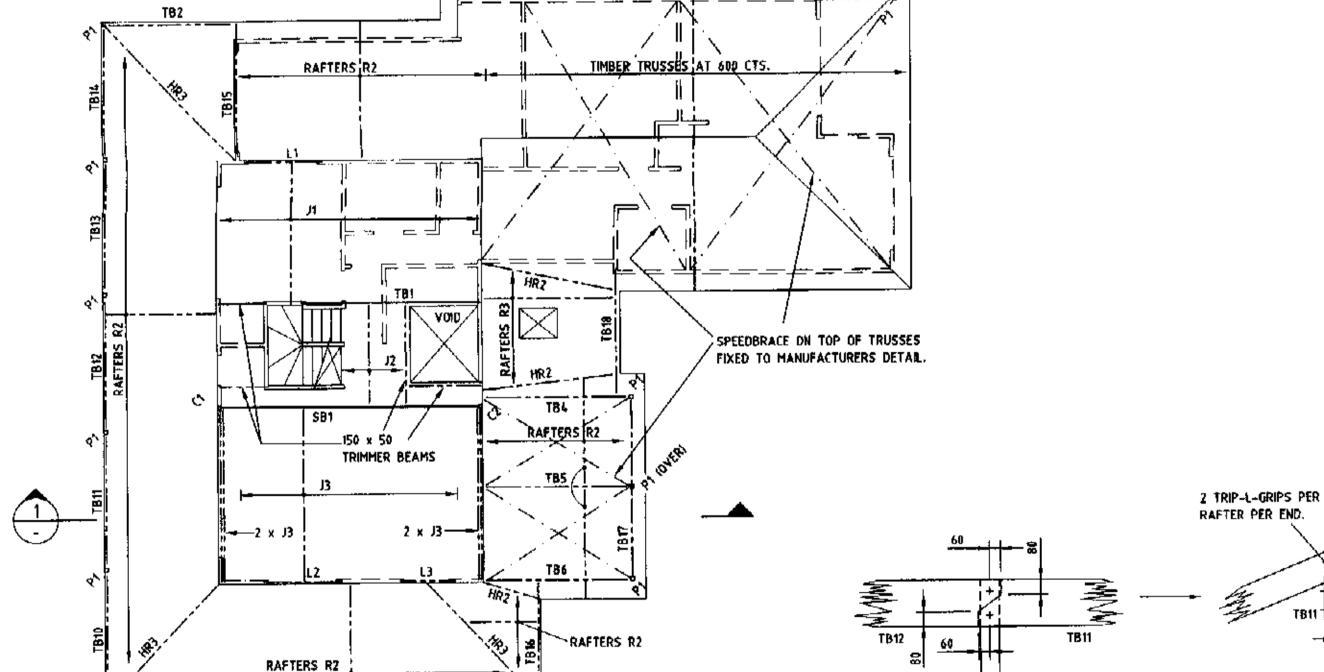

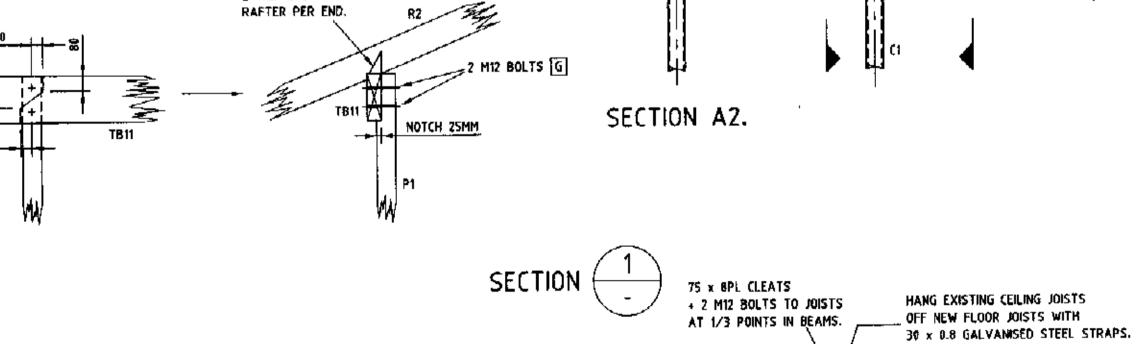

SECTION A1.

100 x SD - F7 CONTINUOUS

MIZ BOLTS AT 450 CTS.

NAILING PLATE.

2 M12 BOLTS.

100 x 50 - F7 BLOCKING

M12 BOLTS AT 450 CTS.

BETWEEN JOISTS.

REFERENCE DRAWINGS:

RAFTERS R2

2 M12 BOLTS G

P1 OVER.

FOR GENERAL NOTES REFER TO DRG. No.

STRUCTURAL STEELWORK NOTES

TIMBER FRAMING NOTES

VARIED BY THE CONTRACT DOCUMENTS.

BE IN ACCORDANCE WITH AS 1684.

TIMBER TRUSS NOTES

ADDITION TO THEIR SELF-WEIGHT.

GIVEN THE FOLLOWING CONDITIONS:

REGIONAL WIND SPEED (VR) 45M/S

LIVE LOAD TO BE IN ACCORDANCE WITH AS 1170

CONTRACT DOCUMENTS.

ROOF 0.15 kPa.

CEILING...... 0.15 kPa.

WIND REGION A2

TERRAIN CATEGORY 3

SHIELDING MULTIPLIER = 1.0

AS 1170 AND THE B.C.A.

LAYOUT AND DETAILS.

TOPOGRAPHIC MULTIPLIER = 1.0

DEFLECTION.

DRAWINGS SHALL BE IN ACCORDANCE WITH AS 1684.

TEL ALL DESIGN, WORKMANSHIP AND MATERIALS SHALL BE IN ACCORDANCE WITH

AS 1684 AND AS 1720 CURRENT EDITION WITH AMENDMENTS, EXCEPT WHERE

TF2 TIMBER SIZES, WALL BRACING AND CONNECTION DETAILS WHERE NOT SHOWN ON

TE3 ROOF BRACING AND ANCHOR DETAILS WHERE NOT SHOWN ON DRAWINGS SHALL

TF4 ALL TIMBER MEMBERS SUBJECT TO WEATHER EXPOSURE SHALL BE DURABILITY

T1 ALL DESIGN, WORKMANSHIP AND MATERIALS SHALL BE IN ACCORDANCE WITH

TZ TRUSSES SHALL BE CAMBERED AN AMOUNT EQUAL TO THE DEAD LOAD

T3 TRUSSES SHALL BE DESIGNED FOR THE FOLLOWING VERTICAL LOADS, IN

T4 TRUSSES SHALL BE DESIGNED FOR WIND LOADS BASED UPON AS 1170

TS A CERTIFICATE OF STRUCTURAL ADEQUACY, PREPARED BY A STRUCTURAL

TE ALL ROOF BRACING AND ANCHOR DETAILS FOR TRUSSES TO BE SHOWN

2 TRIP-L-GRIPS PER

RECESS POST 25MM -

2 M12 BOLTS G}-

RECESS POST 25MM

ON TRUSS LAYOUT DRAWINGS SUPPLIED BY THE TRUSS MANUFACTURER.

T7 SUBMIT DRAWINGS TO THE SUPERINTENDENT FOR APPROVAL SHOWING THE ROOF

ENGINEER REGISTERED ON THE NATIONAL PROFESSIONAL ENGINEERS REGISTER (MPER), IS TO BE SUBMITTED TO THE SUPERINTENDENT FOR APPROVAL. THE

CERTIFICATE IS TO STATE THE ROOF HAS BEEN DESIGNED IN ACCORDANCE WITH

AS 1728 TO SATISFY THE DESIGN LOADS NOMINATED AND THE REQUIREMENTS OF

AS 1720 CURRENT EDITION WITH AMENDMENTS EXCEPT WHERE VARIED BY THE

CLASS 1 IN ACCORDANCE WITH THE NSW TIMBER MARKETING ACT (1977) OR HAZARD LEVEL HE FOR TREATED TIMBERS IN ACCORDANCE WITH AS1604.

- ST ALL WORKMANSHIP AND MATERIALS SHALL BE IN ACCORDANCE WITH AS 4100 CURRENT EDITION WITH AMENDMENTS, EXCEPT WHERE VARIED BY THE CONTRACT DOCUMENTS.
 - SHOP DRAWINGS
- SHOP DRAWINGS SHALL USE OR REFERENCE ALL MEMBER MARKS SHOWN ON
- THE STRUCTURAL DRAWINGS. S3 STEEL QUALITY

ALL STEELWORK SHALL BE GRADE 250 UNLESS NOTED. ROLLED SECTIONS (UB. UC. PFC, EA etc) SHALL BE GRADE BHP-300PLUS. RECTANGULAR HOLLOW SECTIONS SHALL BE GRADE 350 UNLESS NOTED. COLD FORMED PURLIN AND GIRT SECTIONS SHALL BE IN ACCORDANCE WITH AS1397 AND AS1538, AND BE EQUIVALENT TO BHP GALVASPAN, COATING CLASS Z350.

ALL WELDING SHALL BE IN ACCORDANCE WITH AS 1554. UNLESS NOTED ALL CONNECTIONS BETWEEN MEMBERS SHALL BE 6 mm CONTINUOUS FILLET WELD TYPE G.P. BUTT WELDS SHALL BE COMPLETE PENETRATION TYPE SP. WELDING SYMBOLS ON DRAWINGS ARE IN ACCORDANCE WITH AS 1101 PART 3.

SS BOLTING

BOLTS SHALL BE M28 4.6/S UNLESS NOTED. MEMBERS SHALL BE CONNECTED WITH 2 BOLTS UNLESS NOTED. BOLTING PROCEDURES SHALL BE AS FOLLOWS:

BOLTING PROCEDURE	BOLT NAME	AUSTRALIAN STANDARD	MSTALLATION AS 4100
4.6/5	COMMERCIAL	AS 1111	SNUG TIGHTEMED
8.8/5	HIGH STRENGTH	AS 1252	SNUG TIGHTENED
8.8/TF	HIGH STRENGTH	AS 1252	TENSIONED FRICTION
8.8/TB	HIGH STRENGTH	A\$ 7757	TENSIONED BEARING

APPROVED LOAD-INDICATING WASHERS SHALL BE USED UNDER THE BOLT HEAD OF B.8/TF AND 8.8/TB JOINTS.

- S6 HOLES IN MEMBERS FOR FIXINGS OF OTHER TRADES SHALL NOT EXCEED 14 mm DIAMETER.
- S7 PLATES

ALL PLATES SHALL BE 10 mm THICK UNLESS NOTED. BEARING PLATE DIMENSIONS PARALLEL TO WEBS ARE GIVEN FIRST.

SB SURFACE TREATMENT


PRIMER UNLESS NOTED ALL STEELWORK SHALL BE POWERTOOL CLEANED TO A CLASS 2 PREPARATION IN ACCORDANCE WITH AS 1627-Z AND COATED WITH A MINIMUM OF 75 MICRONS OF AN APPROVED ZINC PHOSPHATE PRIMER IN ACCORDANCE WITH AS K108.

> NO PRIMING COAT SHALL BE APPLIED TO CONTACTING SURFACES UTILISING 8.8/TF BOLTS NOR TO MEMBERS TO BE SUBSEQUENTLY CONCRETE ENCASED OR FIRE RATED.

- MEMBERS NOTED Z SHALL BE GIVEN A CLASS 2.5 PREPARATION IN ACCORDANCE WITH AS 1627.4 AND COATED WITH A MINIMUM OF 75 MICRONS OF AN APPROVED INORGANIC ZINC SILKATE.
- MEMBERS NOTED G SHALL BE HOT DIP GALVANISED.
- ALL BOLTS, NUTS AND WASHERS USED IN CONNECTION OF MEMBERS NOTED Z OR G SHALL BE HOT DIP GALVANISED.

MAKE GOOD PROTECTIVE COATINGS AT SITE WELDS AND UNCOATED STEELWORK AT T.F. BOLTED JOINTS.

S9 STRUCTURAL STEELWORK BELOW GROUND SHALL BE CONCRETE ENCASED AND HAVE 75mm CONCRETE COVER, REINFORCED WITH GALVANISED F41 MESH WITH 40mm COVER, LAPPED 150mm AT SPLICES.

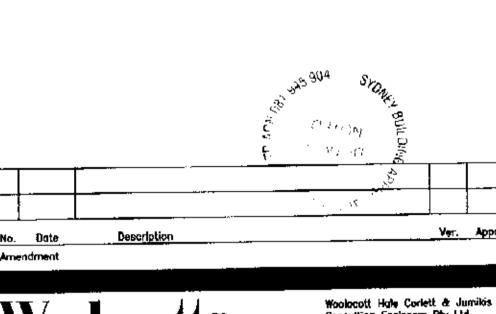

Woolacotts. Consulting Engineers

Consulting Engineers Pty Utd A.C.N. 002 791 620

This drawing is Copyright and must not be used, reproduced or copied wholly or in part without written permission of Woolacott Hale Corlett & Jumikis Consulting Engineers Pty. Ltd.


PROPOSED ALTERATIONS AT 12 NORTH AVALON ROAD, NORTH AVALON

FOR MR & MRS JOHNSON

Peter Downes Designs 115 Palmgrove Rd. Avalon NSW Ph 9973 3312

FIRST FLOOR AND UPPER ROOF PLANS AND DETAILS.

Approved Yerified	Prepared	Date	Şcale
18/16/1/03 ST	16/1/03	July 2003.	1:100, 1:20.
Job number	J	Drawing number	Amendment
114-03		S2	

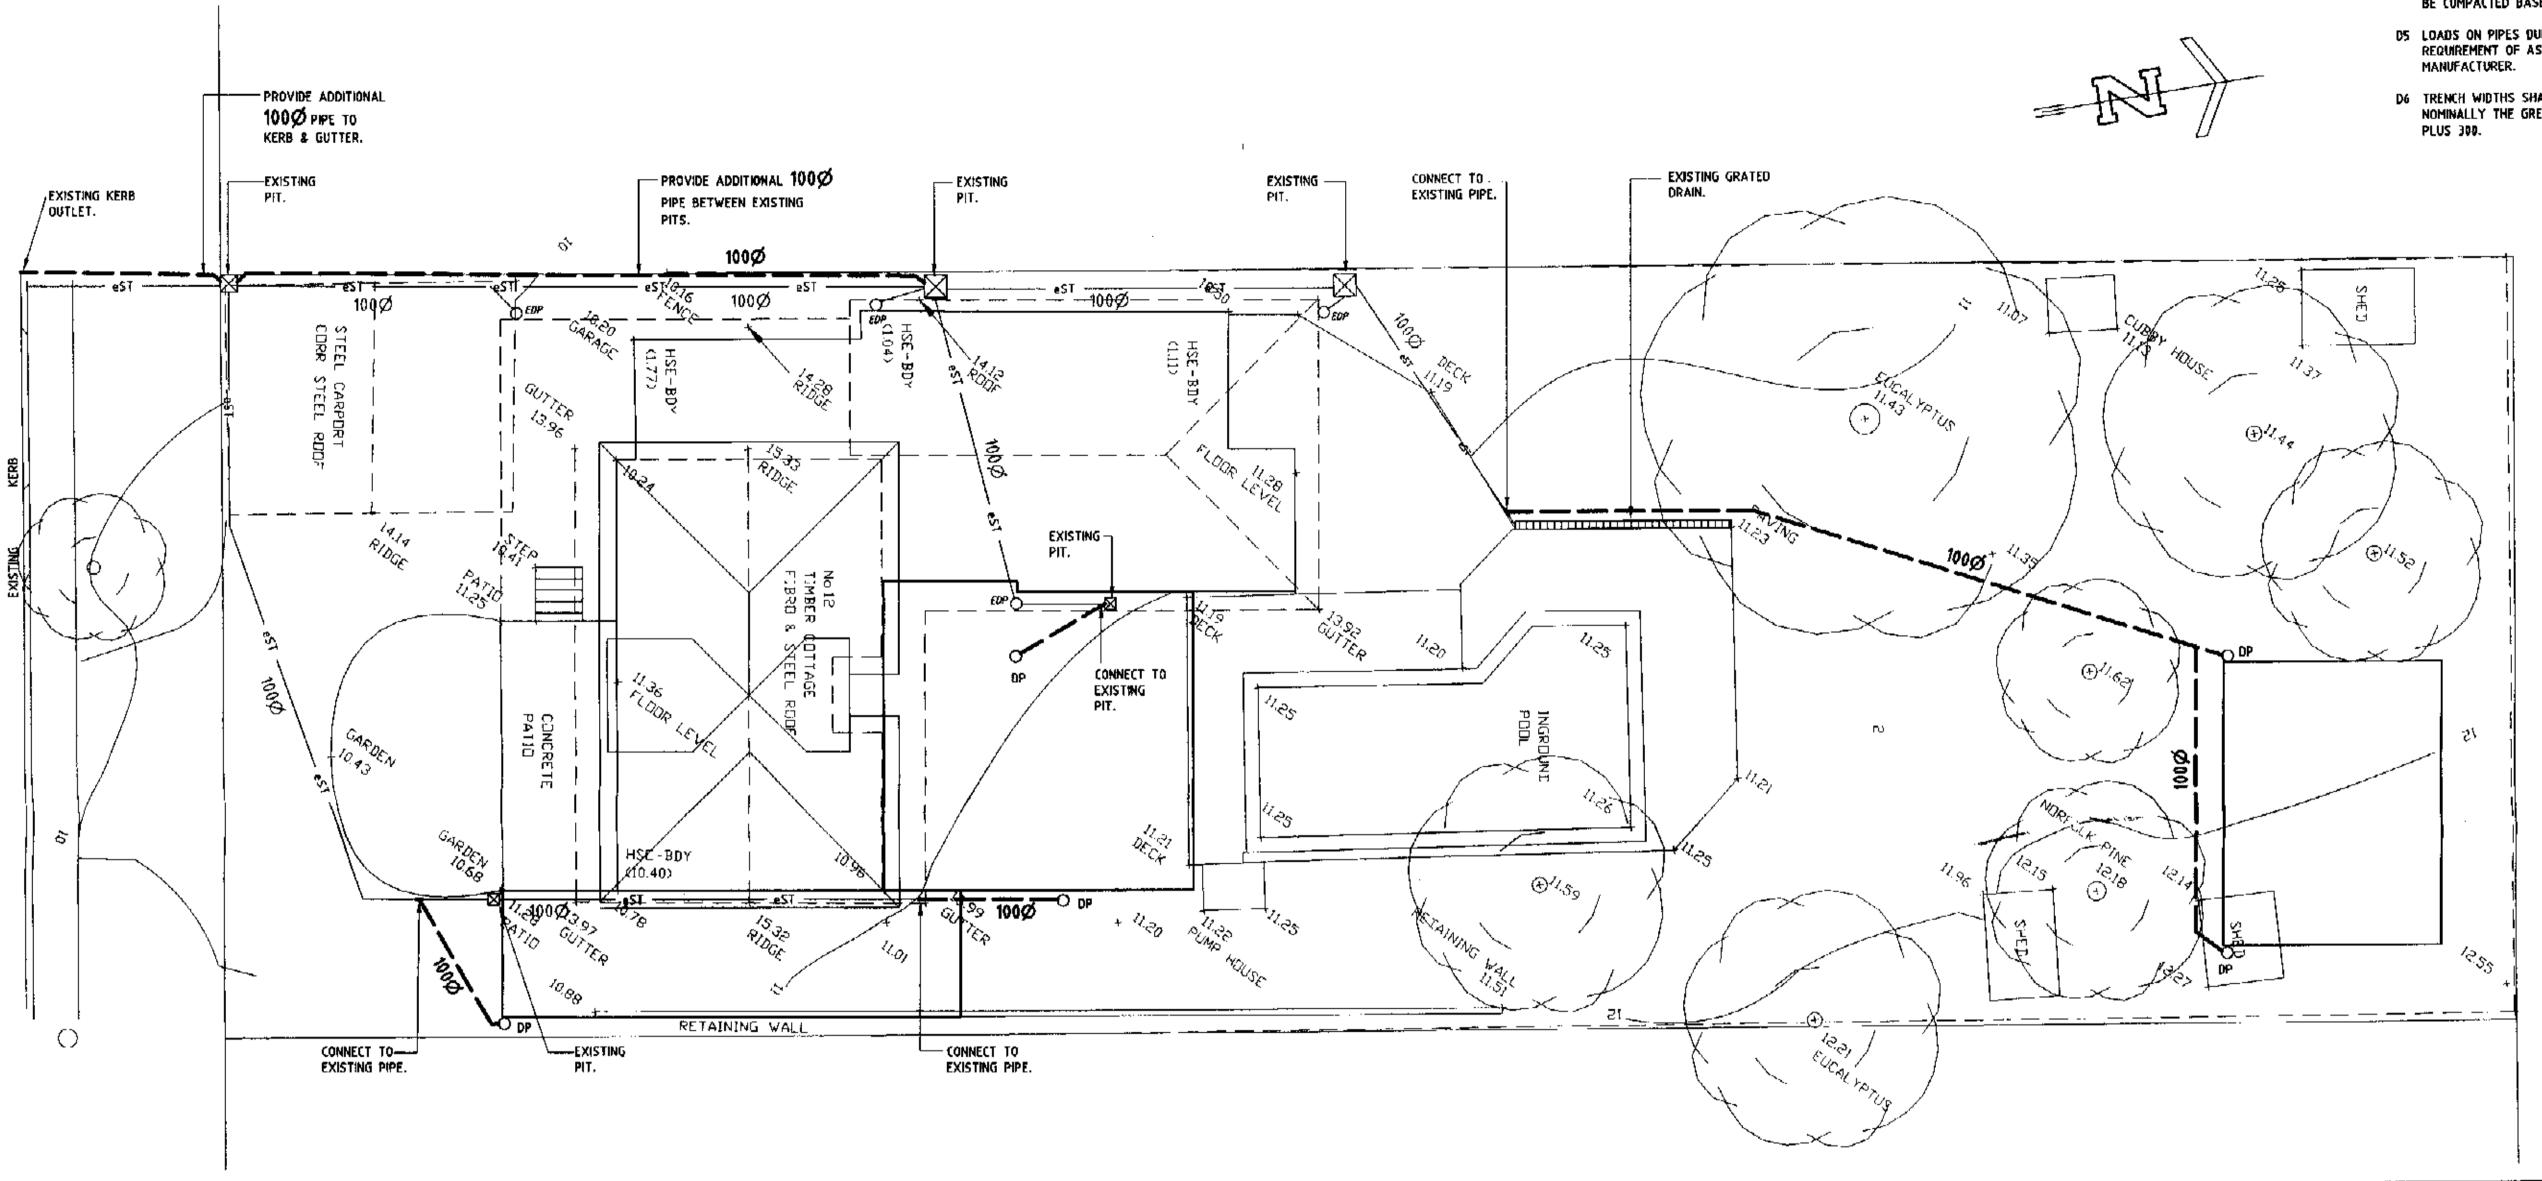

DRAINAGE NOTES

- DI ALL WORKS GENERALLY SHALL BE IN ACCORDANCE WITH AS 3500.3.2
- D2 FOR ALL PIPES USE
- SEWER GRADE UPVC TO AS 1260 OR - CLASS 2 FIBRE REINFORCED CONCRETE TO AS 4139
- D3 PVC PIPES SHALL BE SOLVENT WELDED. ALL OTHER PIPES SHALL BE RUBBER RING JOINTED UNLESS NOTED OTHERWISE.
- D4 UNLESS SPECIFIED OTHERWISE, BED & BACKFEL SHALL BE COMPACTED SAND TO 100mm PLUS ONE THERD PIPE DIAMETER ABOVE THE PIPE.

 REMAINDER OF BACKFILL SHALL BE COMPACTED EXCAVATED MATERIAL. WHEN UNDER VEHICULAR PAVEMENT, REMAINDER OF BACKFILL SHALL BE COMPACTED BASECOURSE.
- DS LOADS ON PIPES DURING CONSTRUCTION SHALL NOT EXCEED THE REQUIREMENT OF AS 3725, OR THE RECOMMENDATIONS OF THE PIPE MANUFACTURER.
- D6 TRENCH WIDTHS SHALL BE IN ACCORDANCE WITH AS 3500, BUT NOMINALLY THE GREATER OF 1.5 PIPE DIAMETER OR PIPE DIAMETER PLUS 300.

Woolacotts.
Consulting Engineers

Woolacatt Hale Carlett & Jumikis
Consulting Engineers Pty Ltd
A.C.N. 002 791 620
2A Broughton Rd.
Artarmon 2064.
Telephone (02) 9413 1399
Facsimile (02) 9413 1132
E—mail affice@woolacatts.com.or

This drawing is Capyright and must not be oxed, reproduced or copied wholly or in part without written permission of Woolacott Hala Captait & Jumikis Consulting Engineers Pty. Ltd.

PROPOSED ALTERATIONS AT
12 NORTH AVALON ROAD, NORTH AVALON

FOR MR & MRS JOHNSON

Architect
Peter Downes Designs
115 Palmgrove Rd. Avalon NSW

Ph 9973 3312

LEGEND

EXISTING STORMWATER PIT.

NEW DOWN PIPE.

EXISTING DOWN PIPE.

EXISTING STORMWATER PIPE.

NEW STORMWATER PIPE.

title

STORMWATER DRAINAGE PLAN

Approved Verified CMM 25/7/93 25:7.5	Prepared 8/1/203	JULY 2003	Scale 1:100
Job humber		Drawing number	Amendment
114-03		C1	

