DRAWING SCHEDULE

DA-00 Cover Page + Location Plan

DA-01 BASIX Commitments

DA-02 Site Analysis Plan

DA-03 Site Plan

DA-04 Basement Plan

DA-05 Ground Floor Plan

DA-06 First Floor Plan

DA-07 Roof Plan

DA-08 Development Calcs. + Landscape Plan

DA-09 Elevations: NE + SW

DA-10 Elevations: NW + SE

DA-11 Sections


DA-12 Sections

DA-13 External Materials + Finishes

DA-14 Site Waste Management Plan

DA-15 Landscape + Planting Details

282m2 lawn + gardens, with 50m2 low water species throughout site

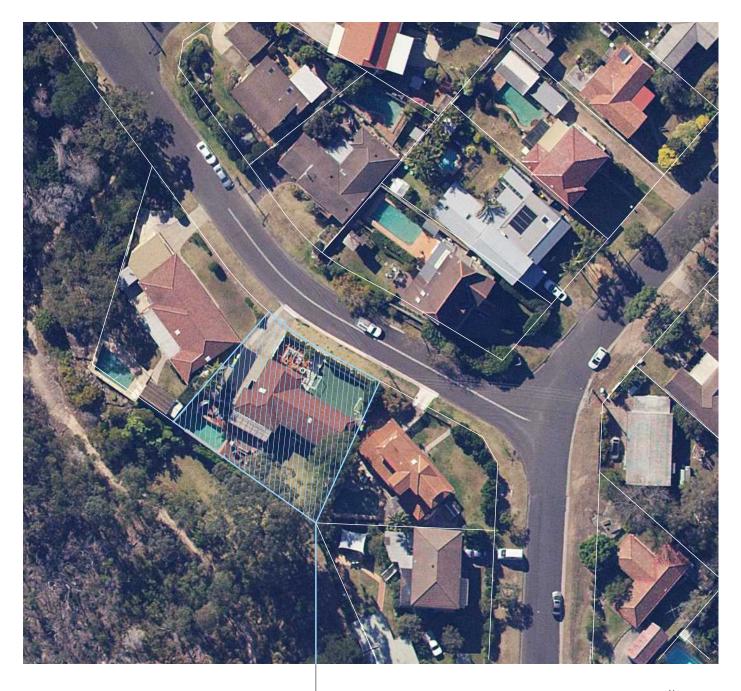



Location Plan



BASIX COMMITMENTS: CERTIFICATE NUMBER: 1287525S

Landscape

Toilet flushing 5 star Shower 4 star Fixtures: Artificial Lighting: Compact fluorescent or LED with dedicated fittings throughout Internal Walls: min 5200L water tank to collect run-off from at least 150sqm of roof area, with Alternative Energy Photovoltaic, 1.0kW peak connections for use in gardens + pool Cooking: Induction cook-top, electric over 55kL with pool cover, solar heating only, timers to pumps Clothes Line: Private outdoor + indoor Floors: Well ventilated

Ventilation:

Ceilinas:

Fridge: Air conditioning, 1-phase, 3.5 star to Living and Bedroom areas

Ceiling fans to all bedrooms and upper Study Roof: Air conditioning, 1-phase, 3.5 star to Living and Bedroom areas

Ducted and sealed exhaust fans with manual on/off switch to Laundry, Kitchen, WC

Concrete, 'light' colour, R2.0 insulation to topside of roof

R2.5 insulation to all ceilings with roof above, rated with sealed exhaust ventilation, not

External Walls

Additional Ventilation

Cavity brick: 'medium' colour, R1.0 insulation to lower levels walls (ex. garage) Cavity brick(timber clad): 'dark' colour, R1.0 insulation to first floor was

Plasterboard on stud to first floor internal walls Brick (or cavity brick) to lower level internal walls

NFRC: Uw = 3.0, SHGC = 0.26 to all glazing e.g. thermally improved, aluminium framed, double glazed 'Low-e' glass

Concrete floors to all levels

R1.5 insulation to all floors with garage level or subfloor below R1.0 insulation to all heated slab floors

Timber and tile coverings to floors as per plans

Sealed ceiling ventilation to upper hall + upper study Sealed wall ventilation to lower hall

| F | 8 JUNE 22 | FOR DEVELOPMENT APPLICATION |
|-------|-----------|-----------------------------|
| E | 20 MAY 22 | FOR DEVELOPMENT APPLICATION |
| D | MAY 22 | PRELIMINARY |
| С | MAR 22 | PRELIMINARY |
| В | FEB 22 | PRELIMINARY |
| A | MAY 21 | PRELIMINARY |
| ISSUE | DATE | AMENDMENT |



joe@jqdm.com.au | www.jqdm.com.au

Amy + Steve Firth

IMPORTANT NOTES:

ot work
All discrepancies to be brought to the attention of the Architec
Larger scale drawings and written dimensions take preference.
This drawing is copyright and the property of the author, and
must not be retained, copied or used without the express
authority of the author.

PROJECT

Proposed alterations + additions to existing dwelling

LOCATION

3 Cootamundra Drive Allambie Heights Lot 2 D.P.241969

DRAWING TITLE

COVER PAGE + LOCATION PLAN

| 1:200@A3 | MAY21 | CH | JQ |
|----------------|-------|----|------------|
| JOB №. 2102 | DA-00 |) | ISSUE F |

'WATER' OPTIONS:

(selection of all 'options' will enable the 'WATER' target to be achieved)

| Landscape vegetation: | ★ 282m² lawn + gardens, with 50m² low water use species. |
|-----------------------------|--|
| Rainwater tank: | ★ 5200 litres. ★ Collecting from roof area = 150m² min. ★ Water to be used in: gardens + pool. |
| Swimming pool / Spa: | ★ Pool = 55 kilolitres, with pool cover. |
| Hot Water Recirculation: | ★ Yes, 'on-demand'. |
| Toilets, Showerheads, Taps: | ★ Showerheads '4★' (4.5-6.0 L/min), Toilets '5★', Kitchen Taps '5★', Bathroom taps '5★'. |

'THERMAL COMFORT' (AccuRate) OPTIONS:

(selection of all 'options' will NOT enable the 'THERMAL COMFORT' target to be achieved)

The following design options were included during the New Run of the AccuRate Assessment process. Inclusion of <u>ALL</u> 'options' will enable the dwelling to achieve the targets set by BASIX:

| Roof: | ★ Concrete + R2.0 insulation to topside of roof. ★ 'Light' colour. |
|-------------------------|---|
| <u>Ceilings</u> : | Minimum R2.5 insulation to all ceilings with roof above. Rated with sealed exhaust ventilation Not rated with down-lights. |
| External Walls: | ★ Cavity brick + R1.0 insulation to lower levels walls (except 'Garage'). ★ Cavity brick (timber-clad) + R1.0 insulation to first floor walls. ★ 'Medium' colour brick walls; 'Dark' coloured timber-clad walls. |
| Internal Walls: | ≯ Plasterboard on stud to all first floor internal walls. ≯ Brick (or cavity brick) to lower level internal walls. |
| Glazing: | NFRC: Uw = 3.0, SHGC = 0.26 to all glazing. eg Thermally-improved aluminium-framed double-glazed 'Low-e' glass. (All windows changes + No roof glazing). |
| Floors: | ★ Concrete floors to all levels. ★ R1.5 insulation to all floors with 'Garage' level or subfloor below. ★ R1.0 insulation to all heated slab floors (BASIX requirement). ★ Timber & tile coverings to floors (as per plans). |
| Additional Ventilation: | ★ Sealed ceiling ventilation to: Upper Hall & Upper Study. ★ Sealed wall ventilation to: Lower Hall. |

'ENERGY' OPTIONS:

(selection of all 'options' will enable the 'ENERGY' target to be achieved.)

| Cooling: | ★ Air-conditioner, 1-phase, 3.5 'star' to Living & Bed areas. ★ Ceiling fans to all bedrooms & upper Study. |
|----------------------------|--|
| <u>Heating</u> : | ★ Air-conditioner, 1-phase, 3.5 'star' to Living & Bed areas. |
| Water Heating: | ★ Gas instantaneous, min. 5.0 'Star'. |
| Energy Efficient Lighting: | ★ Compact fluorescent or LED to: <u>All rooms</u> . |
| Cooking: | ★ Induction cook-top, electric oven. |
| Ventilation: | ★ Bathrooms+ WCs + Laundry + Kitchen: exhausts ducted & sealed; manual 'on'/ 'off'. |
| Refrigerator space: | ★ Well ventilated. |
| Clothes drying lines: | ★ Outdoor & indoor lines installed. |
| Swimming Pool: | ★ Solar only heating; timers to pumps. |
| Alternative Energy Supply: | ★ Photovoltaic, 1.0 kilowatt peak. |

'BASIX' ASSESSMENT - NEW RESULTS #2:

PROJECT: 3 Cootamundra Drive, Allambie Heights - Proposed New Dwelling.

COUNCIL: Northern Beaches.

BASIX RESULTS: The following table shows the overall BASIX RESULTS achieved for the dwelling(s)

based upon 'OPTIONS' provided below:

| | BASIX 'Targets' | PROJECT |
|----------------------------|-----------------|----------|
| 'WATER' | (40 Points) | 40 🗸 |
| 'THERMAL COMFORT' AccuRate | ('PASS') | 'PASS' ✓ |
| 'ENERGY' | (50 Points) | 50 ✔ |

Do not scale from drawings
All dimensions to be checked on site before commencement
of work
All discrepancies to be brought to the attention of the Architect
Larger scale drawings and written dimensions take preference
This drawing is copyright and the property of the author, and
must not be retained, copied or used without the express
authority of the author.

IMPORTANT NOTES:

B 20 MAY 22 FOR DEVELOPMENT APPLICATION

A MAR 22 PRELIMINARY

ISSUE DATE AMENDMENT

JOSEPH QUARELLO DESIGN AND MANAGEMENT joe@jqdm.com.au | www.jqdm.com.au

CLIENT

Amy + Steve Firth

PROJECT

Proposed alterations + additions to existing dwelling

LOCATION

3 Cootamundra Drive Allambie Heights Lot 2 D.P.241969

DRAWING TITL

BASIX COMMITMENTS

| SCALE | DATE | DRAWN | CHECKED |
|----------|-------------|-------|---------|
| 1:200@A3 | MAY21 | CH | JQ |
| | | | |
| JOB No. | DRAWING No. | | ISSUE |
| 2102 | DA-01 | | В |







282m2 lawn + gardens, with 50m2 low water species throughout site Landscape: Shower 4 star Toilet flushing 5 star Fixtures: Kitchen taps 5 star Alternative Water min 5200L water tank to collect run-off from at least 150sqm of roof area, with connections for use in gardens + pool Swimming Pool: 55kL with pool cover, solar heating only, timers to pumps Hot Water Service: Air conditioning, 1-phase, 3.5 star to Living and Bedroom areas Cooling: Ceiling fans to all bedrooms and upper Study Air conditioning, 1-phase, 3.5 star to Living and Bedroom areas Heating:

Ventilation: Ducted and sealed exhaust fans with manual on/off switch to Laundry, Kitchen, WC Artificial Lighting: Compact fluorescent or LED with dedicated fittings throughout. Alternative Energy Photovoltaic, 1.0kW peak Cooking: Induction cook-top, electric oven Clothes Line: Private outdoor + indoor Fridge: Well ventilated Concrete, 'light' colour, R2.0 insulation to topside of roof Roof:

Ceilinas:

R2.5 insulation to all ceilings with roof above, rated with sealed exhaust ventilation, not

Cavity brick: 'medium' colour, R1.0 insulation to lower levels walls (ex. garage) External Walls: Cavity brick(timber clad): 'dark' colour, R1.0 insulation to first floor walls Plasterboard on stud to first floor internal walls Brick (or cavity brick) to lower level internal walls Internal Walls:

NFRC: Uw = 3.0, SHGC = 0.26 to all glazing Glazing: e.g. thermally improved, aluminium framed, double glazed 'Low-e' glass

> Concrete floors to all levels R1.5 insulation to all floors with garage level or subfloor below R1.0 insulation to all heated slab floors Timber and tile coverings to floors as per plans

Floors:

Additional Ventilation:

Sealed ceiling ventilation to upper hall + upper study Sealed wall ventilation to lower hall

IMPORTANT NOTES:

All dimensions to be checked on site before commencement, of work All discrepancies to be brought to the attention of the Architect Larger scale drawings and written dimensions take preference This drawing is copyright and the property of the author, and must not be retained, copied or used without the express authority of the author.



| _ | |
|---|--|
| | |

| D | | |
|---------------|----|---------------------|
| awning window | rw | rendered walls |
| brick | sl | sliding door/windo |
| concrete | st | steel |
| door | sp | stone paving |
| downpipe | tf | tile floor |
| existing | tb | timber floor boards |
| fibre cement | tm | timber |
| fixed glass | W | window |
| glazed door | | |

-- Site boundary

Neighbouring boundary

Existing tree

Line of structure over / under

Existing building element to be retained

| J | 20 MAY 22 | FOR DEVELOPMENT APPLICATION |
|---|-----------|-----------------------------|
| 1 | MAY 22 | PRELIMINARY |
| н | MAY 22 | PRELIMINARY |
| G | APR 22 | PRELIMINARY |
| F | MAR 22 | PRELIMINARY |
| Е | FEB 22 | PRELIMINARY |
| D | FEB 22 | PRELIMINARY |
| С | JULY 21 | PRELIMINARY |
| В | JULY 21 | PRELIMINARY |
| A | MAY 21 | PRELIMINARY |
| | | |



JOSEPH QUARELLO DESIGN AND MANAGEMENT joe@jqdm.com.au | www.jqdm.com.au

CLIENT

Amy + Steve Firth

PROJECT

Proposed alterations + additions to existing dwelling

LOCATION

3 Cootamundra Drive Allambie Heights Lot 2 D.P.241969

BASEMENT PLAN

| SCALE | DATE | DRAWN | CHECKED |
|----------|-------------|-------|---------|
| 1:200@A3 | JUNE21 | CH | JQ |
| | | | |
| JOB No. | DRAWING No. | | ISSUE |
| 2102 | DA-04 | | J |
| 2102 | DA-04 | | , |



| Landscape: | 282m2 lawn + gardens, with 50m2 low water species throughout site | | Ventilation: |
|--------------------|---|---|----------------------|
| Fixtures: | Shower 4 star Kitchen taps 5 star | Toilet flushing 5 star Bathroom taps 5 star | Artificial Lighting: |
| Alternative Water: | min 5200L water tank to collect run-off from at least 150sqm of roof area, with connections for use in gardens + pool | | Alternative Energy: |
| Swimming Pool: | 55kL with pool cover, solar heating only, timers to pumps | | Cooking: |
| · · | | | Clothes Line: |
| Hot Water Service: | | | Fridge: |
| Cooling: | | ir conditioning, 1-phase, 3.5 star to Living and Bedroom areas eiling fans to all bedrooms and upper Study | |
| Heating: | Air conditioning, 1-phase, 3.5 star to Living and Bedroom areas | | Ceilings: |
| | | | |

| ventilation: | and Bathroom areas | External vvalis: | Cavity brick(timber clad): 'dark' |
|----------------------|--|-------------------------|---|
| Artificial Lighting: | Compact fluorescent or LED with dedicated fittings throughout. | Internal Walls: | Plasterboard on stud to first flo Brick (or cavity brick) to lower I |
| Alternative Energy: | Photovoltaic, 1.0kW peak | Glazing: | NFRC: Uw = 3.0, SHGC = 0.26 |
| Cooking: | Induction cook-top, electric oven | | e.g. thermally improved, alumin |
| Clothes Line: | Private outdoor + indoor | Floors: | Concrete floors to all levels R1.5 insulation to all floors with |
| Fridge: | Well ventilated | | R1.0 insulation to all heated sla Timber and tile coverings to flo |
| Roof: | Concrete, 'light' colour, R2.0 insulation to topside of roof | Additional Ventilation: | Sealed ceiling ventilation to up |
| | | | |

R2.5 insulation to all ceilings with roof above, rated with sealed exhaust ventilation, not

rated with downlights.

our, R1.0 insulation to lower levels walls (ex. garage) rk' colour, R1.0 insulation to first floor wall:

floor internal walls er level internal walls

.26 to all glazing minium framed, double glazed 'Low-e' glass

with garage level or subfloor below slab floors

floors as per plans

Sealed ceiling ventilation to upper hall + upper study Sealed wall ventilation to lower hall

IMPORTANT NOTES:

All dimensions to be checked on site perore commencement of work
All discrepancies to be brought to the attention of the Architect
Larger scale drawings and written dimensions take preference
This drawing is copyright and the property of the author, and
must not be retained, copied or used without the express
authority of the author.



LEGEND

| ••• | - | | |
|-----|---------------|----|-------------------|
| | awning window | rw | rendered walls |
| | brick | sl | sliding door/wind |
| | concrete | st | steel |
| | door | sp | stone paving |
| | downpipe | tf | tile floor |
| | existing | tb | timber floor boar |
| | fibre cement | tm | timber |
| | fixed glass | w | window |
| | glazed door | | |
| | | | |

---- Site boundary

Neighbouring boundary

Existing tree Line of structure over / under

Brick internal walls throughout

| 1 | 20 MAY 22 | FOR DEVELOPMENT APPLICATION |
|---|-----------|-----------------------------|
| н | MAY 22 | PRELIMINARY |
| G | APR 22 | PRELIMINARY |
| F | MAR 22 | PRELIMINARY |
| E | FEB 22 | PRELIMINARY |
| D | FEB 22 | PRELIMINARY |
| С | JULY 21 | PRELIMINARY |
| В | JULY 21 | PRELIMINARY |
| A | MAY 21 | PRELIMINARY |
| | | |



JOSEPH QUARELLO DESIGN AND MANAGEMENT joe@jqdm.com.au | www.jqdm.com.au

CLIENT

Amy + Steve Firth

PROJECT


Proposed alterations + additions to existing dwelling

LOCATION

3 Cootamundra Drive Allambie Heights Lot 2 D.P.241969

GROUND FLOOR PLAN

| SCALE | DATE | DRAWN | CHECKED |
|----------|-------------|-------|---------|
| 1:200@A3 | JUNE21 | CH | JQ |
| JOB No. | DRAWING No. | 1 | ISSUE |
| 2102 | DA-05 | 5 | 1 |

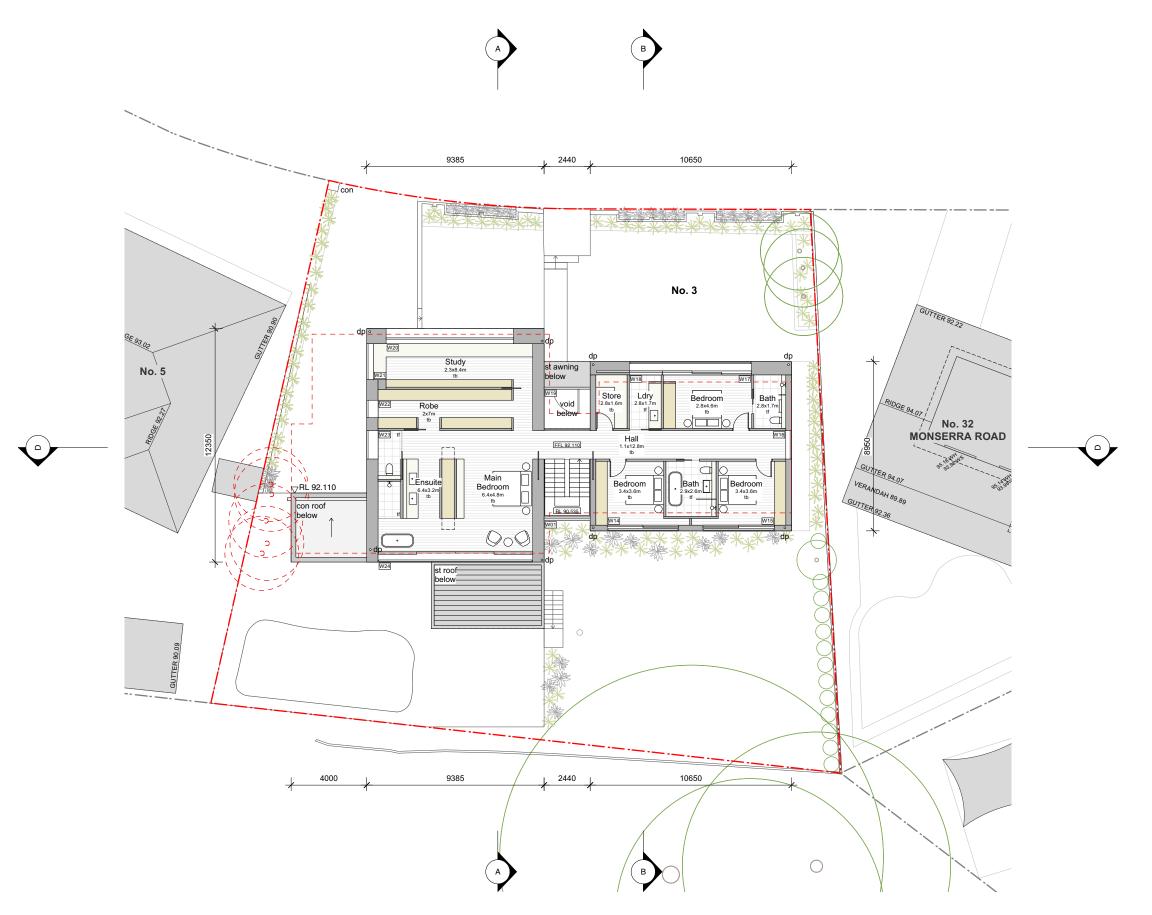

| Landscape: | 282m2 lawn + gardens, with 50m2 low water species throughout site | Ventilation: | Ducted and sealed exhaust fans with manual on/off switch to Laundry, Kitchen, WC and Bathroom areas | External Walls: | Cavity brick: 'medium' colour, R1.0 insulation to lower levels walls (ex. garage) Cavity brick(timber clad): 'dark' colour, R1.0 insulation to first floor walls |
|--------------------|---|----------------------|--|-------------------------|--|
| Fixtures: | Shower 4 star Toilet flushing 5 star Kitchen taps 5 star Bathroom taps 5 star | Artificial Lighting: | Compact fluorescent or LED with dedicated fittings throughout. | Internal Walls: | Plasterboard on stud to first floor internal walls Brick (or cavity brick) to lower level internal walls |
| Alternative Water: | min 5200L water tank to collect run-off from at least 150sqm of roof area, with connections for use in gardens + pool | Alternative Energy: | Photovoltaic, 1.0kW peak | Glazing: | NFRC: Uw = 3.0, SHGC = 0.26 to all glazing |
| Outros Deel | | Cooking: | Induction cook-top, electric oven | Glazing. | e.g. thermally improved, aluminium framed, double glazed 'Low-e' glass |
| Swimming Pool: | 55kL with pool cover, solar heating only, timers to pumps | Clothes Line: | Private outdoor + indoor | Floors: | Concrete floors to all levels |
| Hot Water Service: | Gas instantaneous, min 5 star | Fridge: | Well ventilated | | R1.5 insulation to all floors with garage level or subfloor below R1.0 insulation to all heated slab floors |
| Cooling: | Air conditioning, 1-phase, 3.5 star to Living and Bedroom areas Ceiling fans to all bedrooms and upper Study | Roof: | Concrete, 'light' colour, R2.0 insulation to topside of roof | | Timber and tile coverings to floors as per plans. |
| Heating: | Air conditioning, 1-phase, 3.5 star to Living and Bedroom areas | Ceilings: | R2.5 insulation to all ceilings with roof above, rated with sealed exhaust ventilation, not rated with downlights. | Additional Ventilation: | Sealed ceiling ventilation to upper hall + upper study Sealed wall ventilation to lower hall |

IMPORTANT NOTES:

Do not scale from drawings
All dimensions to be checked on sile before commencement
of work
All discrepancies to be brought to the attention of the Architect
Larger scale drawings and written dimensions take preference
This drawing is copyright and the property of the author, and
must not be retained, copied or used without the express
authority of the author.



| - 1 | F | a | _ | N | П | |
|-----|---|---|---|---|---|--|

| E١ | ND | | |
|----|---------------|----|--------------------|
| | awning window | rw | rendered walls |
| | brick | sl | sliding door/wind |
| | concrete | st | steel |
| | door | sp | stone paving |
| | downpipe | tf | tile floor |
| | existing | tb | timber floor board |
| | fibre cement | tm | timber |
| | fixed glass | W | window |

Neighbouring boundary

Existing tree

Line of structure over / under

Existing building element to be retained

| J | 20 MAY 22 | FOR DEVELOPMENT APPLICATION |
|---|-----------|-----------------------------|
| 1 | MAY 22 | PRELIMINARY |
| н | MAY 22 | PRELIMINARY |
| G | APR 22 | PRELIMINARY |
| F | MAR 22 | PRELIMINARY |
| E | FEB 22 | PRELIMINARY |
| D | FEB 22 | PRELIMINARY |
| С | JULY 21 | PRELIMINARY |
| В | JULY 21 | PRELIMINARY |
| A | MAY 21 | PRELIMINARY |
| | | |



JOSEPH QUARELLO DESIGN AND MANAGEMENT joe@jqdm.com.au | www.jqdm.com.au

CLIENT

Amy + Steve Firth

PROJECT

Proposed alterations + additions to existing dwelling


LOCATION

3 Cootamundra Drive Allambie Heights Lot 2 D.P.241969

DRAWING TITLE

FIRST FLOOR PLAN

| SCALE 1:200@A3 | JUNE21 | DRAWN | JQ |
|-------------------|-------------|-------|----|
| JOB No. 2102 | DRAWING No. | 6 | J |

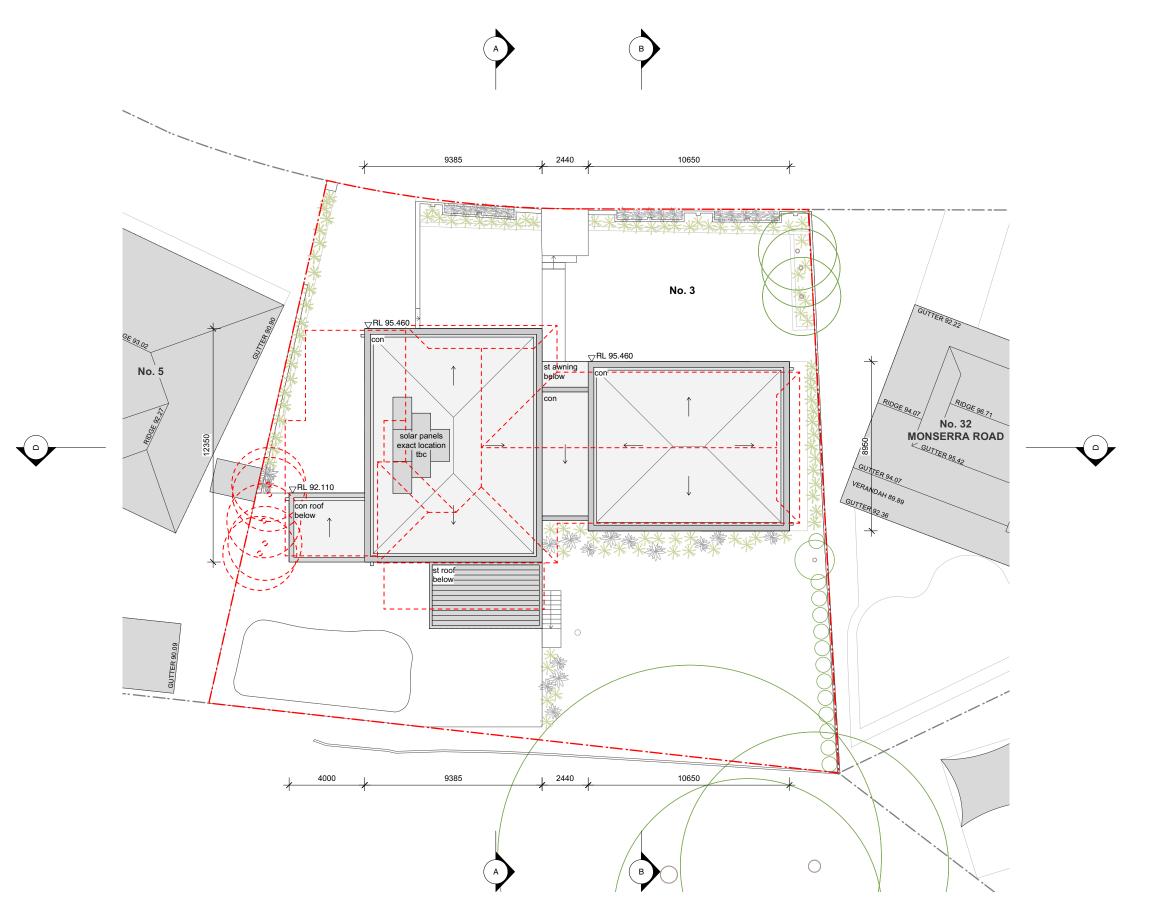

| Landscape: | 282m2 lawn + gardens, with 50m2 low water species throughout site | Ventilation: | Ducted and sealed exhaust fans with manual on/off switch to Laundry, Kitchen, WC and Bathroom areas | External Walls: | Cavity brick: 'medium' colour, R1.0 insulation to lower levels walls (ex. garage) Cavity brick(timber clad): 'dark' colour, R1.0 insulation to first floor walls |
|--------------------|---|----------------------|--|-------------------------|--|
| Fixtures: | Shower 4 star Toilet flushing 5 star Kitchen taps 5 star Bathroom taps 5 star | Artificial Lighting: | Compact fluorescent or LED with dedicated fittings throughout. | Internal Walls: | Plasterboard on stud to first floor internal walls Brick (or cavity brick) to lower level internal walls |
| Alternative Water: | min 5200L water tank to collect run-off from at least 150sqm of roof area, with connections for use in gardens + pool | Alternative Energy: | Photovoltaic, 1.0kW peak | Glazing: | NFRC: Uw = 3.0, SHGC = 0.26 to all glazing |
| Swimming Pool: | 55kL with pool cover, solar heating only, timers to pumps | Cooking: | Induction cook-top, electric oven | Cidzing. | e.g. thermally improved, aluminium framed, double glazed 'Low-e' glass |
| Hot Water Service: | Gas instantaneous. min 5 star | Clothes Line: | Private outdoor + indoor | Floors: | Concrete floors to all levels |
| | , | Fridge: | Well ventilated | | R1.5 insulation to all floors with garage level or subfloor below R1.0 insulation to all heated slab floors |
| Cooling: | Air conditioning, 1-phase, 3.5 star to Living and Bedroom areas Ceiling fans to all bedrooms and upper Study | Roof: | Concrete, 'light' colour, R2.0 insulation to topside of roof | | Timber and tile coverings to floors as per plans. |
| Heating: | Air conditioning, 1-phase, 3.5 star to Living and Bedroom areas | Ceilings: | R2.5 insulation to all ceilings with roof above, rated with sealed exhaust ventilation, not rated with downlights. | Additional Ventilation: | Sealed ceiling ventilation to upper hall + upper study Sealed wall ventilation to lower hall |

IMPORTANT NOTES:

Do not scale from drawings
All dimensions to be checked on sile before commencement
of work
All discrepancies to be brought to the attention of the Architect
Larger scale drawings and written dimensions take preference
This drawing is copyright and the property of the author, and
must not be retained, copied or used without the express
authority of the author.



| - 1 | F | a | _ | NI | П | |
|-----|---|---|---|----|---|--|

| D | | |
|---------------|----|---------------------|
| awning window | rw | rendered walls |
| brick | sl | sliding door/windo |
| concrete | st | steel |
| door | sp | stone paving |
| downpipe | tf | tile floor |
| existing | tb | timber floor boards |
| fibre cement | tm | timber |
| fixed glass | W | window |
| alazad daar | | |

---- Site boundary

Neighbouring boundary

Existing tree

- Line of structure over / under

Existing building element to be retained

| Н | 20 MAY 22 | FOR DEVELOPMENT APPLICATION |
|---|-----------|-----------------------------|
| G | MAY 22 | PRELIMINARY |
| F | MAY 22 | PRELIMINARY |
| E | APR 22 | PRELIMINARY |
| D | MAR 22 | PRELIMINARY |
| С | FEB 22 | PRELIMINARY |
| В | FEB 22 | PRELIMINARY |
| А | MAY 21 | PRELIMINARY |
| | | |



JOSEPH QUARELLO DESIGN AND MANAGEMENT joe@jqdm.com.au | www.jqdm.com.au

CLIENT

Amy + Steve Firth

PROJECT

Proposed alterations + additions to existing dwelling

LOCATION

3 Cootamundra Drive Allambie Heights Lot 2 D.P.241969

DRAWING TITLE

ROOF PLAN

| SCALE 1:200@A3 | MAY21 | DRAWN | JQ |
|-------------------|-------------|-------|---------|
| JOB No. 2102 | DRAWING No. | , | ISSUE H |




LANDSCAPED OPEN SPACE CALCULATIONS: MINIMUM AREA: 335m² (40% site area)




288.5m² (34.4% site area)

PROPOSED AREA: 335m² (40% site area)

PRIVATE OPEN SPACE CALCULATIONS: MINIMUM AREA: 60m²

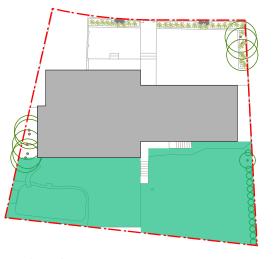

EXISTING AREA: 333.5m²

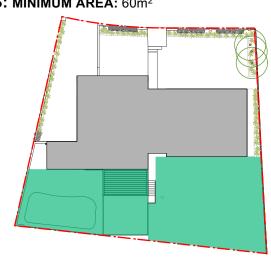

PROPOSED AREA: 317m²

IMPORTANT NOTES:

All dimensions to be checked on site before commencement, of work All discrepancies to be brought to the attention of the Architect Larger scale drawings and written dimensions take preference This drawing is copyright and the property of the author, and must not be retained, copied or used without the express authority of the author.



| 1 | a | _ | NI | П |
|---|---|---|----|---|

| LLOLI | 10 | | |
|-------|---------------|----|--------------------|
| a | awning window | rw | rendered walls |
| br | brick | sl | sliding door/windo |
| con | concrete | st | steel |
| d | door | sp | stone paving |
| dp | downpipe | tf | tile floor |
| ex | existing | tb | timber floor board |
| fc | fibre cement | tm | timber |
| fg | fixed glass | W | window |
| ad | alazad daar | | |

Neighbouring boundary

Existing tree

---- Line of structure over / under





joe@jqdm.com.au | www.jqdm.com.au

Amy + Steve Firth

PROJECT


Proposed alterations + additions to existing dwelling


LOCATION

3 Cootamundra Drive Allambie Heights Lot 2 D.P.241969

DEVELOPMENT CALCS. + LANDSCAPE PLAN

| 1:200@A3 | MAY21 | DRAWN CH | JQ |
|----------------|-------|-------------|----|
| JOB №. 2102 | DA-08 | 3 | D |

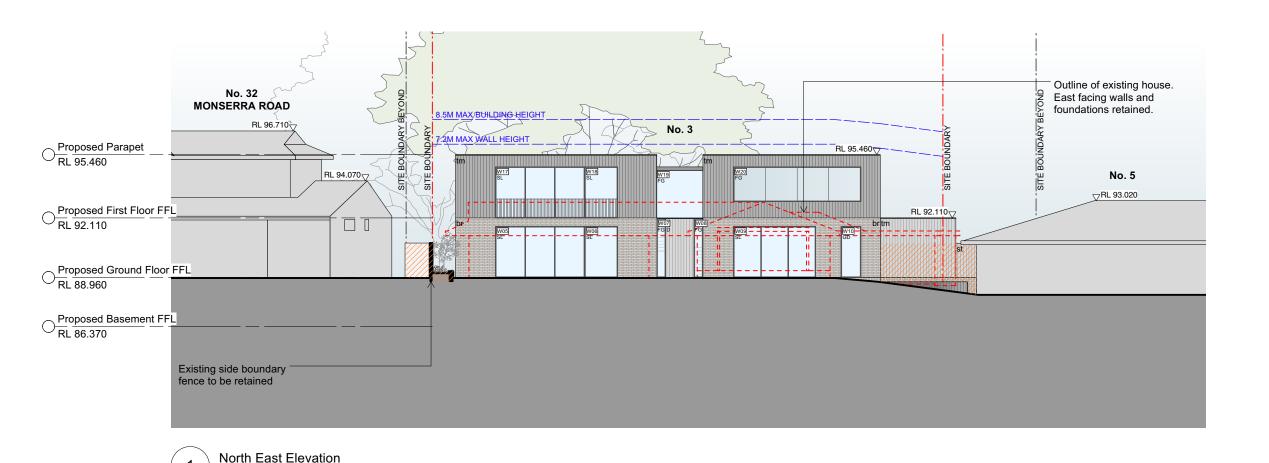

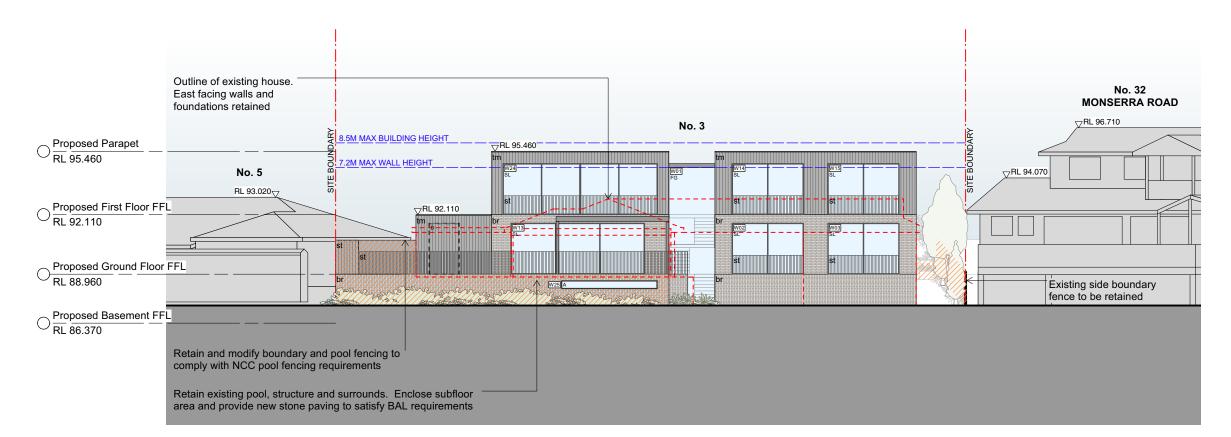

South West Elevation 2

IMPORTANT NOTES:

Do not scale from drawings
All dimensions to be checked on site before commencement
of work
All discrepancies to be brought to the attention of the Architect
Larger scale drawings and written dimensions take preference
This drawing is copyright and the property of the author, and
must not be retained, copied or used without the express
authority of the author.

| LLOLIV | 0 | | |
|--------|---------------|----|---------------------|
| а | awning window | rw | rendered walls |
| br | brick | sl | sliding door/window |
| con | concrete | st | steel |
| d | door | sp | stone paving |
| dp | downpipe | tf | tile floor |
| ex | existing | tb | timber floor boards |
| fc | fibre cement | tm | timber |
| fg | fixed glass | W | window |
| gd | glazed door | | |

--- Site boundary - - Neighbouring boundary Existing tree

Line of structure over / under

To be demolished Existing structure

New structure

Existing building element to be retained

MAY 22 PRELIMINARY



JOSEPH QUARELLO DESIGN AND MANAGEMENT joe@jqdm.com.au | www.jqdm.com.au

CLIENT

Amy + Steve Firth

PROJECT

Proposed alterations + additions to existing dwelling


LOCATION


3 Cootamundra Drive Allambie Heights Lot 2 D.P.241969

DRAWING TITLE

ELEVATIONS

| 1:200@A3 | MAY21 | СН | JQ |
|----------------|-------------|----|---------|
| JOB №. 2102 | DRAWING No. |) | ISSUE H |

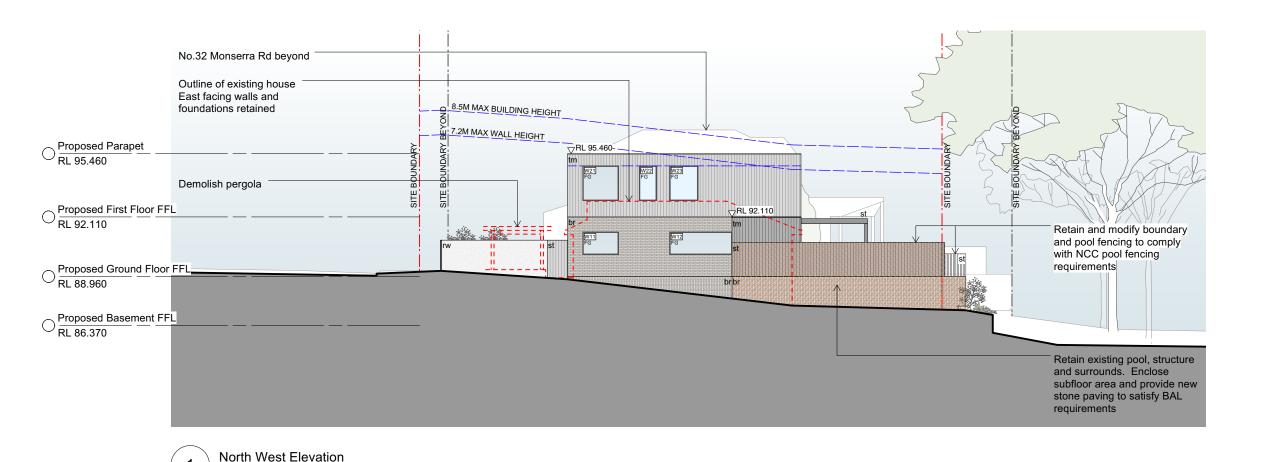

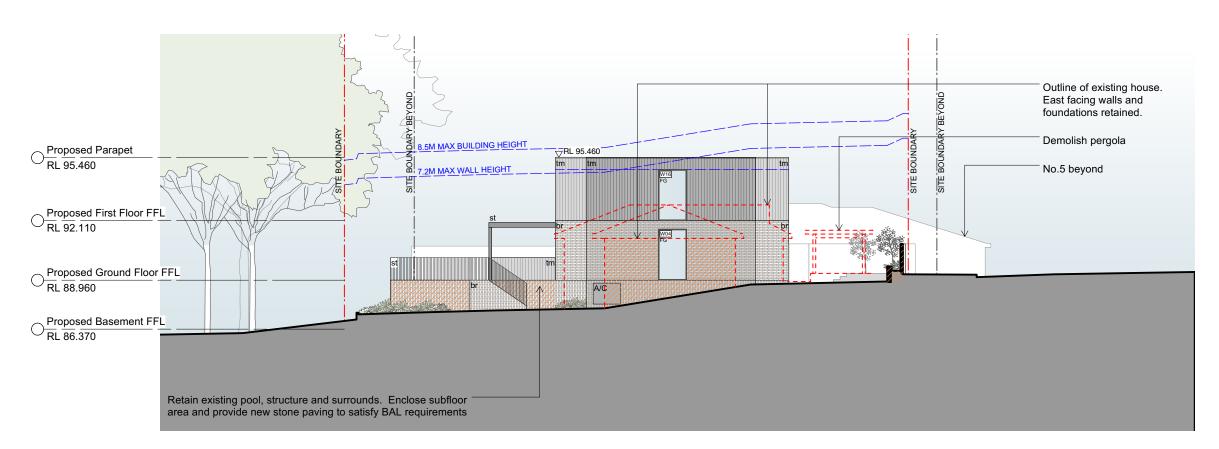

South East Elevation 2

IMPORTANT NOTES:

Do not scale from drawings
All dimensions to be checked on site before commencement
of work
All discrepancies to be brought to the attention of the Architect
Larger scale drawings and written dimensions take preference
This drawing is copyright and the property of the author, and
must not be retained, copied or used without the express
authority of the author.

| LEGE | ND | | |
|------|---------------|----|-------------------|
| а | awning window | rw | rendered walls |
| br | brick | sl | sliding door/wind |
| con | concrete | st | steel |
| d | door | sp | stone paving |
| dp | downpipe | tf | tile floor |
| ex | existing | tb | timber floor boar |
| fc | fibre cement | tm | timber |
| fg | fixed glass | w | window |
| ad | glazed door | | |

Existing tree

Existing building element to be retained

| | 20 MIA 1 22 | FOR DEVELOPMENT AFFEICATION |
|-------|-------------|-----------------------------|
| G | MAY 22 | PRELIMINARY |
| F | MAY 22 | PRELIMINARY |
| E | MAR 22 | PRELIMINARY |
| D | MAR 22 | PRELIMINARY |
| С | FEB 22 | PRELIMINARY |
| В | FEB 22 | PRELIMINARY |
| A | MAY 21 | PRELIMINARY |
| ISSUE | DATE | AMENDMENT |



joe@jqdm.com.au | www.jqdm.com.au

CLIENT

Amy + Steve Firth

PROJECT

Proposed alterations + additions to existing dwelling


LOCATION

3 Cootamundra Drive Allambie Heights Lot 2 D.P.241969


DRAWING TITLE

ELEVATIONS

| SCALE | DATE | DRAWN | CHECKED |
|---------------------|------------|-------|---------|
| 1:200@A3 | MAY21 | CH | JQ |
| | 1 | | |
| JOB No. DRAWING No. | | | ISSUE |
| 2102 | 2102 DA-10 | | H |

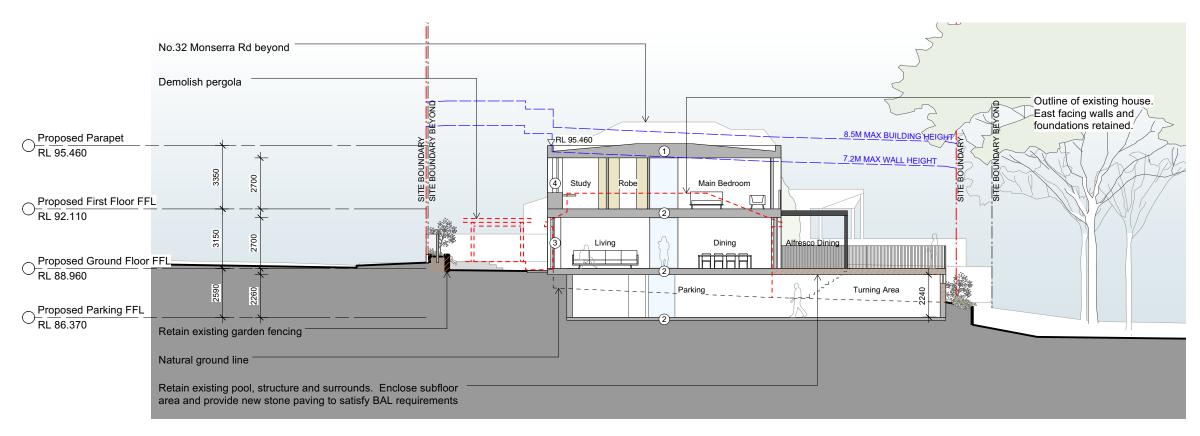



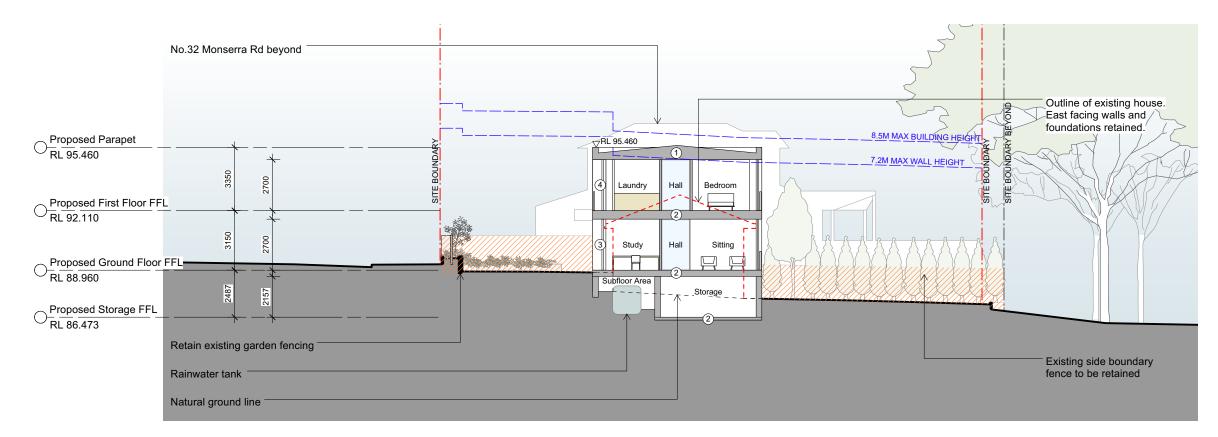

Section B 2

IMPORTANT NOTES:

Do not scale from drawings All dimensions to be checked on site before commencement of work
All discrepancies to be brought to the attention of the Architect
Larger scale drawings and written dimensions take preference
This drawing is copyright and the property of the author, and
must not be retained, copied or used without the express
authority of the author.

LEGEND

| а | awning window | rw | rendered walls |
|-----|---------------|----|------------------|
| br | brick | sl | sliding door/win |
| con | concrete | st | steel |
| d | door | sp | stone paving |
| dp | downpipe | tf | tile floor |
| ex | existing | tb | timber floor boa |
| fc | fibre cement | tm | timber |
| fg | fixed glass | W | window |
| gd | glazed door | | |
| | | | |

--- Site boundary

- - Neighbouring boundary

Existing tree

Line of structure over / under

To be demolished

Existing building element to be retained (1) Concrete roof with R2.0 insulation topside

2

3 Cavity brick external walls Ground Floor

Timber-clad cavity brick external walls First Floor

| н | 20 MAY 22 | FOR DEVELOPMENT APPLICATION |
|---|-----------|-----------------------------|
| G | MAY 22 | PRELIMINARY |
| F | MAY 22 | PRELIMINARY |
| E | MAR 22 | PRELIMINARY |
| D | MAR 22 | PRELIMINARY |
| С | FEB 22 | PRELIMINARY |
| В | FEB 22 | PRELIMINARY |
| A | MAY 21 | PRELIMINARY |
| | | |



JOSEPH QUARELLO DESIGN AND MANAGEMENT joe@jqdm.com.au | www.jqdm.com.au

CLIENT

Amy + Steve Firth

PROJECT

Proposed alterations + additions to existing dwelling


LOCATION

3 Cootamundra Drive Allambie Heights Lot 2 D.P.241969


DRAWING TITLE

SECTIONS

| SCALE 1:200@A3 | MAY21 | DRAWN CH | JQ |
|-------------------|-------|-------------|----|
| JOB No. 2102 | DA-11 | | H |

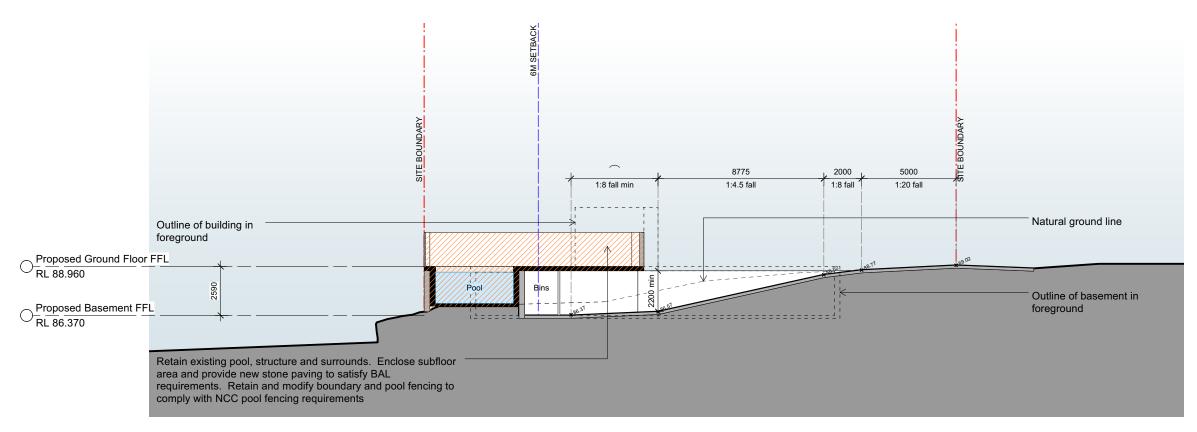



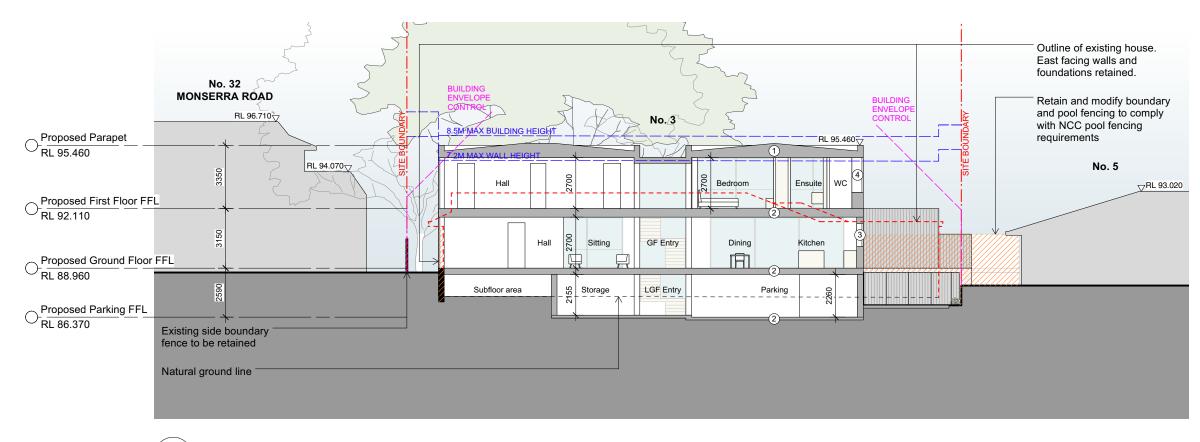

Section D

IMPORTANT NOTES:

Do not scale from drawings All dimensions to be checked on site before commencement of work
All discrepancies to be brought to the attention of the Architect
Larger scale drawings and written dimensions take preference
This drawing is copyright and the property of the author, and must not be retained, copied or used without the express authority of the author.

| LEGE | ND | | | |
|------|---------------|----|--------------------|--|
| а | awning window | rw | rendered walls | |
| br | brick | sl | sliding door/winde | |
| con | concrete | st | steel | |
| d | door | sp | stone paving | |
| dp | downpipe | tf | tile floor | |
| ex | existing | tb | timber floor board | |
| fc | fibre cement | tm | timber | |
| fg | fixed glass | W | window | |
| gd | glazed door | | | |
| | | | | |

--- Site boundary

- - Neighbouring boundary

Existing tree

Line of structure over / under

To be demolished

Existing structure

1

Existing building element to be retained

Concrete roof with R2.0 insulation topside

2

3 Cavity brick external walls Ground Floor

Timber-clad cavity brick external walls First Floor

| н | 20 MAY 22 | FOR DEVELOPMENT APPLICATION |
|---|-----------|-----------------------------|
| G | MAY 22 | PRELIMINARY |
| F | MAY 22 | PRELIMINARY |
| E | MAR 22 | PRELIMINARY |
| D | MAR 22 | PRELIMINARY |
| С | FEB 22 | PRELIMINARY |
| В | FEB 22 | PRELIMINARY |
| A | MAY 21 | PRELIMINARY |
| | | |



joe@jqdm.com.au | www.jqdm.com.au

CLIENT

Amy + Steve Firth

ISSUE DATE AMENDMENT

PROJECT

Proposed alterations + additions to existing dwelling


LOCATION

3 Cootamundra Drive Allambie Heights Lot 2 D.P.241969

DRAWING TITLE

SECTIONS

| 1:200@A3 | MAY21 | CH | JQ |
|----------|-------------|----|-------|
| JOB No. | DRAWING No. | l | ISSUE |
| 2102 | DA-12 | 2 | Н |

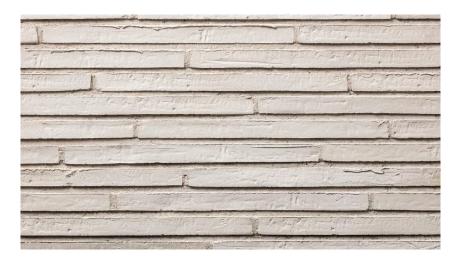

brick walls



sp stone paving




timber floorboards - internal



concrete roofs, paths, driveway and structure



steel balustrades, gates, fence + awning

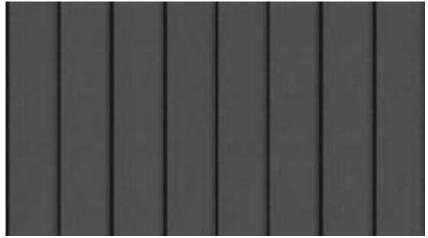

timber cladding - charred finish

NOTE:

ALL MATERIALS AND INSTALLATION TO COMPLY WITH DESIGNATED BUSHFIRE ATTACK LEVEL (BAL 29) AND BASIX REQUIREMENTS.

IMPORTANT NOTES:

Do not scale from drawings
All dimensions to be checked on sile before commencement
of work
All discrepancies to be brought to the attention of the Architect
Larger scale drawings and written dimensions take preference
This drawing is copyright and the property of the author, and
must not be retained, copied or used without the express
authority of the author.

| LEGEN | ND | | |
|-------|---------------|----|--------------------|
| а | awning window | rw | rendered walls |
| br | brick | sl | sliding door/windo |
| con | concrete | st | steel |
| d | door | sp | stone paving |
| dp | downpipe | tf | tile floor |
| ex | existing | tb | timber floor board |
| fc | fibre cement | tm | timber |
| fg | fixed glass | W | window |
| gd | glazed door | | |
| | | | |

| F | 20 MAY 22 | FOR DEVELOPMENT APPLICATION | |
|-------|-----------|-----------------------------|---|
| E | MAY 22 | PRELIMINARY | |
| D | MAY 22 | PRELIMINARY | |
| С | MAR 22 | PRELIMINARY | |
| В | FEB 22 | PRELIMINARY | _ |
| A | MAY 21 | PRELIMINARY | |
| ISSUE | DATE | AMENDMENT | |



joe@jqdm.com.au | www.jqdm.com.au

CLIENT
Amy + Steve Firth

PROJECT

Proposed alterations + additions to existing dwelling

LOCATION

3 Cootamundra Drive Allambie Heights Lot 2 D.P.241969

EXTERNAL MATERIALS + **FINISHES**

| SCALE | DATE | DRAWN | CHECKED |
|----------|-------------|-------|---------|
| 1:200@A3 | MAY21 | CH | JQ |
| | | | |
| JOB No. | DRAWING No. | | ISSUE |
| 2102 | DA-13 | } | F |
| | J, | | ' |





Bluewaves

Coastal

rosemary


KEY


EXISTING TREE TO BE REMOVED




Bangalow Palm (Archontophoenix cunninghamiana)

EXISTING TREE TO BE RETAINED

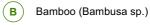

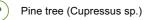

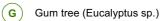

NEW PLANTING



Mass planting beds



Groundcover

Turf



HARDSCAPE



Concrete surface




Paved surface

BASIX COMMITMENTS

- Proposed area of low water use planting >50m²
- Proposed area of lawn 282m²
- External taps connected to rainwater tanks for garden watering and swimming pool

- Refer to Arborists Report for details of tree removal and retention
- Refer to Bushfire Report for details and extent of asset protection zone
- Refer to Hydraullic Engineering documentation for drainage
- All work in accordance with relevant codes and standards.

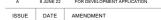



JOSEPH QUARELLO DESIGN AND MANAGEMENT joe@jqdm.com.au | www.jqdm.com.au

CLIENT

Amy + Steve Firth

IMPORTANT NOTES:

LEGEND

existing fibre cement

Site boundary

Existing tree

Line of structure over / under

of work
All discrepancies to be brought to the attention of the Architect
Larger scale drawings and written dimensions take preference
This drawing is copyright and the property of the author, and
must not be retained, copied or used without the express
authority of the author.

rendered walls sliding door/windo

timber floor boards timber

stone paving tile floor

PROJECT

Proposed alterations + additions to existing dwelling

LOCATION

Parrot-pea

5

2

6

2

44

3

TOTAL

3 Cootamundra Drive Allambie Heights Lot 2 D.P.241969

LANDSCAPE + PLANTING **DETAILS**

MAY21 СН 1:200@A3 JQ 2102 DA-15 Α

INDICATIVE PLANTING SCHEDULE:

Basket grass

Acacia

'limelight'

| COMMON NAME | BOTANICAL NAME | POT SIZE | MATURE SIZE | TOTAL |
|--------------------|--------------------------|----------|---------------|-------|
| Acacia 'limelight' | Acacia cognata Limelight | 20cm | H:1.5m W:1.5m | 20 |
| Basket grass | Lomandra longifolia | 14cm | H:1m W:1m | 12 |
| Blue chalksticks | Senecio serpens | 14cm | H:0.6m W:0.6m | 10 |
| Blue flax lily | Dianella caerulea | 50cm | H:1m W:1m | 13 |
| Bluewaves | Crassula undulatifolia | 14cm | H:1m W:1m | 10 |
| Coastal rosemary | Westringia fruticosa | 20cm | H:2m W:2m | 5 |

Blue chalksticks

Blue flax lily

LANDSCAPED OPEN SPACE CALCULATIONS: MINIMUM AREA: 335m² (40% site area) **PROPOSED AREA: EXISTING AREA:**

288.5m² (34.4% site area) 335m² (40% site area) **COMMON NAME** Flannel flower Grey spider flower Indian hawthorn Kangaroo paws Kidney weed

EXISTING AREA:

Parrot-pea

333.5m²

Flannel flower

BOTANICAL NAME Actinotus helianthi Grevillea buxifolia Rhaphiolepis indica Anigozanthos sp. Dichondra repens Dillwynia floribunda

Grey spider

flower

Indian

hawthorn

14cm 17cm 14cm 14cm 5cm

Kangaroo Paw

POT SIZE

14cm

H:1m W:0.5m

H:0.1m W:1m H:1m W:0.5m

H:0.6m W:0.6m

MATURE SIZE

H:0.5m W:0.5m

H:2m W:2m

Kidney weed

PRIVATE OPEN SPACE CALCULATIONS: MINIMUM AREA: 60m²

PROPOSED AREA: 317m²