

CONSTRUCTION CERTIFICATE APPLICATION

Made under the Environmental Planning and Assessment Act 1979 Sections 109C (1) (b), 81a (2) and 81a (4)

Pittwater Council

PO Box 882, Mona Vale NSW 1660

Tei: (612) 9970 1111 Fax: (612) 9970 7150

Internet: www.pittwaterlga.com.au

Unit/Suite: Street No:						
	Street:	05				
24 A CHILTERN Suburb:			RD.			
INGLESIDE	MW 2101.		Lot No:	Deposit /Strata Plan: DP 595804		
DEVELOPMENT CONS	SENT					
Development Application No:			Determination Date:			
N0279	105		03 - August - 2005.			
APPLICANT DETAILS						
Name/Company:		С	Contact Person:			
DAVID MARSHAL	<u>_</u>		DAVID .	MARSHALL		
Postal Address:	0-	С	ontact Numi	pers:		
24 A CHILTERN		Р	Phone (H/B): (4) 9997 - 7080			
THE ELIDE MIN	ر ۱۵۱۶	М	Mobile: 04/3 709 239			
			Fax:			
Signature of Applicant:		D	Date: 06/09/2005			
OWNERS DETAILS						
Name: PAVID W. M/	YRSHALL	If	Company, c	ontact person:		
LISA K. MA	ARSHALL			•		
Postal Address:		C	ontact Numb	ers:		
24 A CHILTERN		Pł	Phone (H/B): (H) 9997-7080			
Incespe as	J 2101	M	Mobile: 04/3 709 239			
		Fa	ıx:			
As the owner of the land to which authorised Council Officer to ent	n this application relates, I er the land to carry out ins	⊥ conse oectioi	nt to this applicans.	ntion. I also give consent for the		
Signature of Owners:	l	Da	ite: 06/09/2	.005		
dise Karen Mo	uslall		06/09/	200 ≤ .		
f more than one owner, every ownthorised director and the com-	vner must sign. If the owne	r is a	company the fo	rm must be signed by an		
uthorised director and the common the property has been recently the contracts have been recently	purchased, written confirm	ation	from the nurcha	ser's Solicitor must be needed		
the contracts have been excha	nged for the purchase of th	e land	d, the current ow	ner is to sign the application.		

DEVELOPMENT DETAILS	
Type of Work:	
OR	
☐ Subdivision Work	
Description of proposal – (Provide brief, concise details):	
ERECTION OF A RURAL SHED.	• · · · · · · · · · · · · · · · · · · ·
	••••••
	· • • • • • • • • • • • • • • • • • • •
WHO WILL BE DOING THE BUILDING WORKS?	
Owner Builder	
Owner Builders Permit No: 297671 P	
Copy of Owner Builders Permit attached: Yes No – to be provided with Notice of	
Commencement Form	
If you are an Owner-Builder for the residential building work exceeding \$5000 you must a for a permit at NSW Office of Fair Trading, 1 Fitzwilliam Street, Paramatta NSW 2150 Aust	pply
Tel: 61 2 98950111 Fax: 61 2 9895 0222.	I dila.
OR	
Licensed Builder Builder's License Number	
Builder's License Number	
Name of Builder: Phone:	
Contact person: Mobile:	!
Address	
Fax:	
Incurance Co-	
Insurance Company: Insurance Certificate attached: Yes	
□ No – to be provided with Notification of	
Commencement form	
If you are using a licensed builder for residential building work exceeding \$12,000 you mu obtain Home Building Act Insurance. A certificate of insurance must be provided with this	ıst
application or submitted with the Notification of Commencement form.	S

VALUE OF PROPOSED D	EVELOPM	ENT			
Value of Works: \$/5, 040		(including full cost of	flabour and materials)		
DO YOU NEED TO PAY T	'HE BUILDI	NG INDUSTRY LO	NG SERVICE LEVY?		
☐ Yes		☑ No			
Only required if the developn	nent involves b	uilding works exceeding	g \$25,000.00.		
OFFICE USE ONLY					
Fee Type		Cashier's Code	Fee Amount		
Construction Certificate Application Fee		TCER	368.50		
Long Service Levy Fee		QLSL			
Driveway/Street Levels		ESTR			
Sec 94 Contributions					
Bonds/Guarantees					
Other Fees					
TOTAL			368 sto		
Date of Receipt: 8.9.05		Receipt No: 176161	Accepted By:		
PRIVACY AND PERSONA	L INFORM	ATION PROTECTION	ON NOTICE		
Purpose of collection:	To enable Council as the consent authority to assess your proposal.				
Intended recipients	Council Staff and any other relevant government agency that may be required to assess the proposal.				
Supply:	The information is required by legislation.				
Consequence of Non-provision:	Your application may not be accepted, not processed or rejected for lack of information				
Storage:	The Pittwater Council will store details of the application and any				
Retention period:	subsequent decision in a register that can be viewed by the public. Hard copies of the application will be destroyed after 7 years and				

electronic records will be kept indefinitely.

Please contact Council if this information you have provided is incorrect or changes.

STATISTICAL RETURN FOR AUSTRALIAN BUREAU OF STATISTICS

180-41-41				
What is the area of the land?		Area in square metres 25,000 ~~		
Gross floor area of existing building?		Area in square metres SOOM		Soom
If no existing building, w	rite "NIL"			
What is the existing building or site used for		Main uses:	Ras	dertal/ Rural.
at present?	at present?			
Does the site contain a	Does the site contain a dual occupancy?			No No
Gross floor area of proposed building?		Proposed floor	area in s	square metres(08
What will the proposed building to be used for?		Main uses:	RUR	AL SHED.
		Other uses:		•••••
How many dwellings:				
Are pre-existing at this p	roperty?	Dwellings:	1	
Are proposed to be dem	olished?	Dwellings:	Nic	
Are proposed to be cons	structed?	Dwellings:	210	
How many storeys will building consist of?		Storeys:	0n 4	·
What are the main build	ding materials?			
Walls		Roof		
Full Brick		Aluminium	······································	0
Brick veneer		Concrete or slat	e	
Concrete, masonry		Tile		
Steel		Fibrous cement		Q
Fibrous cement		Steel		
Timber/weatherboard		Other	-	
Cladding-aluminium		Unknown		
Curtain glass				
Other				
Unknown	Q			
			_	
Floor		Frame		
Concrete	\(\sigma\)	Timber		
Timber		Steel		<u>-</u>
Other		Other		
Unknown		Unknown		

APPLICANTS CHECK LIST

items may not be required	and Section E ecify further ac	he type of information to be submitted. Some 3 of the Conditions of Development Consent for dditional information required with submission of .
Application Form –		Owners Consent
		Applicant's Signature
İ	2	Long Service Levy - N/A
	<u> </u>	Driveway/Street levels Application - NIA
Supporting		to a construction and the second
Documentation -		A 12 4 4 5 5
(3 copies of each)		Architectural Plans
		Quick Check Plans endorsed by Sydney Water
		Construction Specifications for Building Works
	3	Structural Engineer's Plans
		Structural/Geotechnical Certificates
		Landscape Plans
		Driveway Level Plans
		On-site Stormwater Detention Plans
	Ø	Drainage Plans on Site Storm Management
		Erosion and Sediment Management Plan
	Ø	Sydney Water Quick Check Plans
		Subdivision Work Plans
	d	Schedule of External Finishes/Colours
		Fire Safety Measures Schedule
		Form No. 2 – "Geotechnical Risk Managemer Policy for Pittwater"
		Details and location of fencing for Swimming Pool to comply with AS 1926-1986 "Fences and Gates for Private Swimming Pools"
		Specifications for construction of buildings in Bushfire-prone areas
		Security Deposit / Section 94 contributions

Ref:councilco

07 September 2005

Pittwater Council
PO Box 882
MONA VALE NSW 1660

David and Lisa Marshall 24 A Chiltern Rd. INGLESIDE NSW 2103 Phone 9997 7080

RE: Construction Certificate Application
Consent No. 0279/05 - Erection of a Rural Shed

Please find attached Pittwater Council Construction Certificate Application with details completed and duly signed by the owners. We request Council issue a Construction Certificate.

In accordance with the requirements of the Consent, the following additional supporting details are provided (3 sets):


1/.. Approved Construction plans and specifications:

- Site Plan (including Quick Check approval by Sydney Water).
- General Arrangement and Specification Drawing No. FF-01-D.
- Frame Detail
 Drawing No. FF-053-F.
- Purlin and Girt Layout and Misc. Details Drawing No. FF-054-E.
- Column Hold Down Bolt Layout Drawing No. FF-055-F.
- 2/.. Copy of Owner Builders permit No. 297671P.
- 3/.. On site detention and stormwater management system details.

We understand that a valid Construction Certificate is required prior to appointment of a Principal Certifying Authority. It is our intention to appoint Pittwater Council as the Principal Certifying Authority and have also appointed a structural engineer to provide any necessary certification.


I can be contacted any time on my mobile phone number 0413 709 239 or home 9997 7090 should there be any other requirements.

Yours faithfully
DAVID MARSHALL

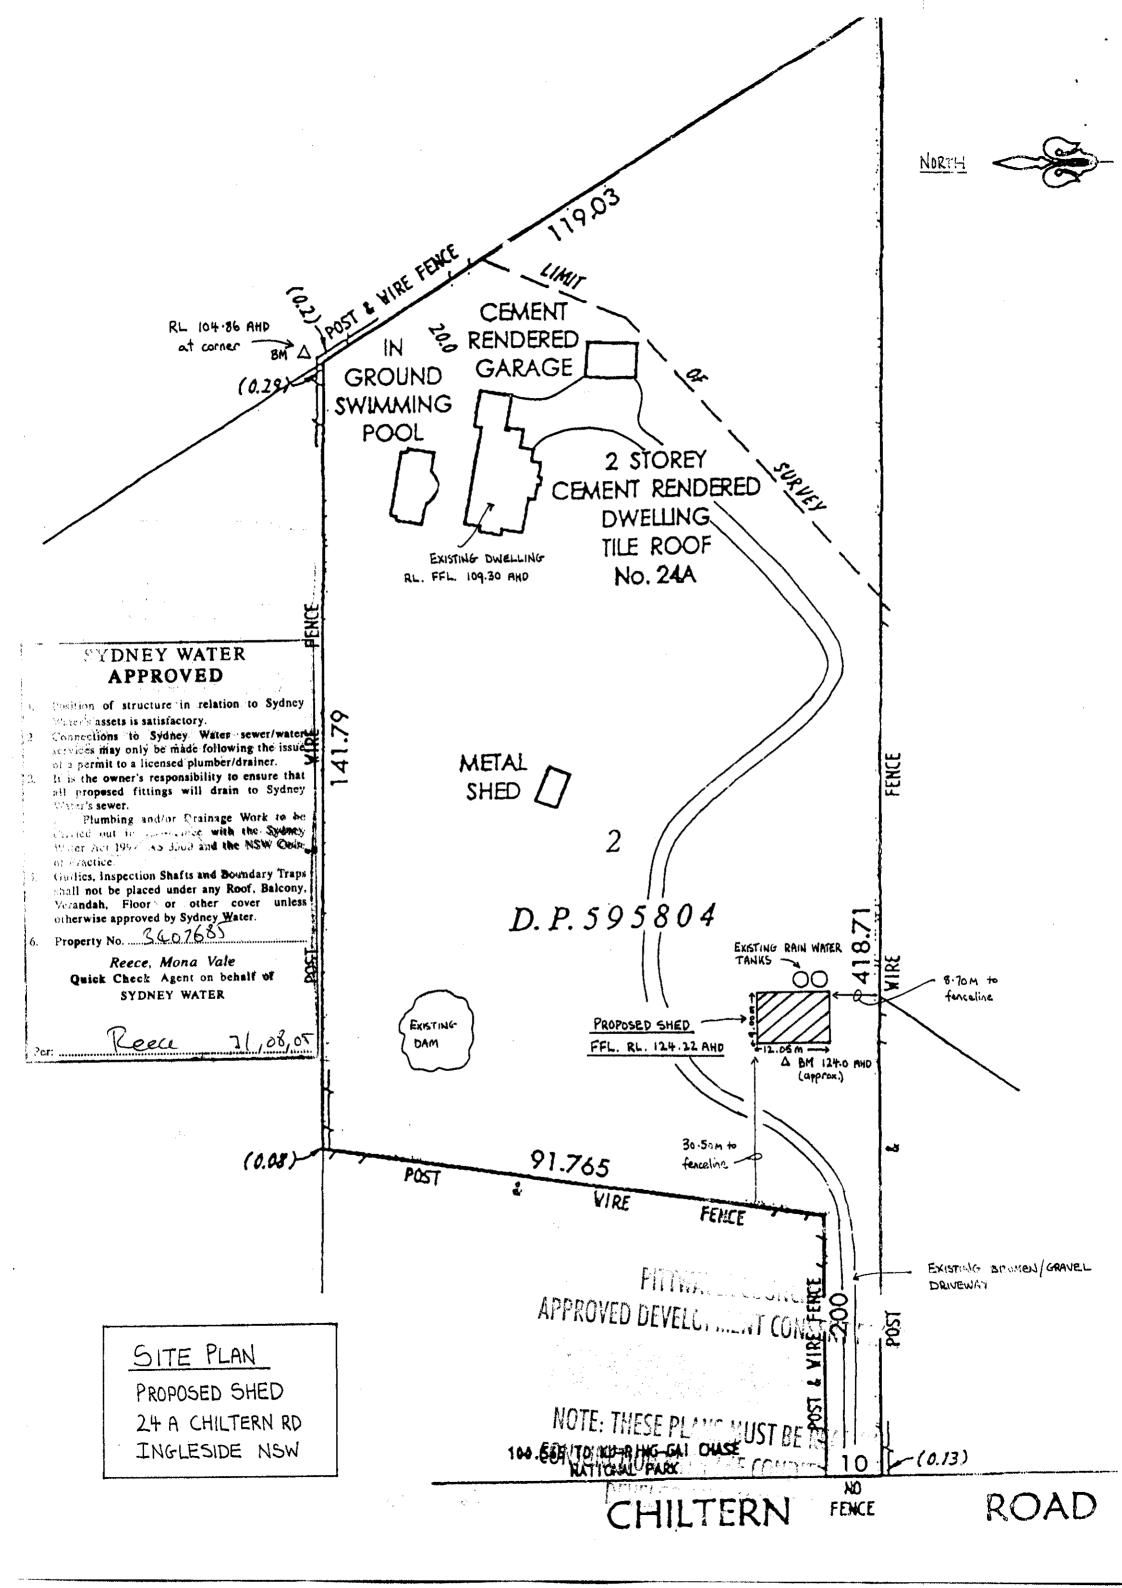



FIFTY-FIFTY BUILDING
GENERAL ARRANGEMENT AND SPECIFICATION

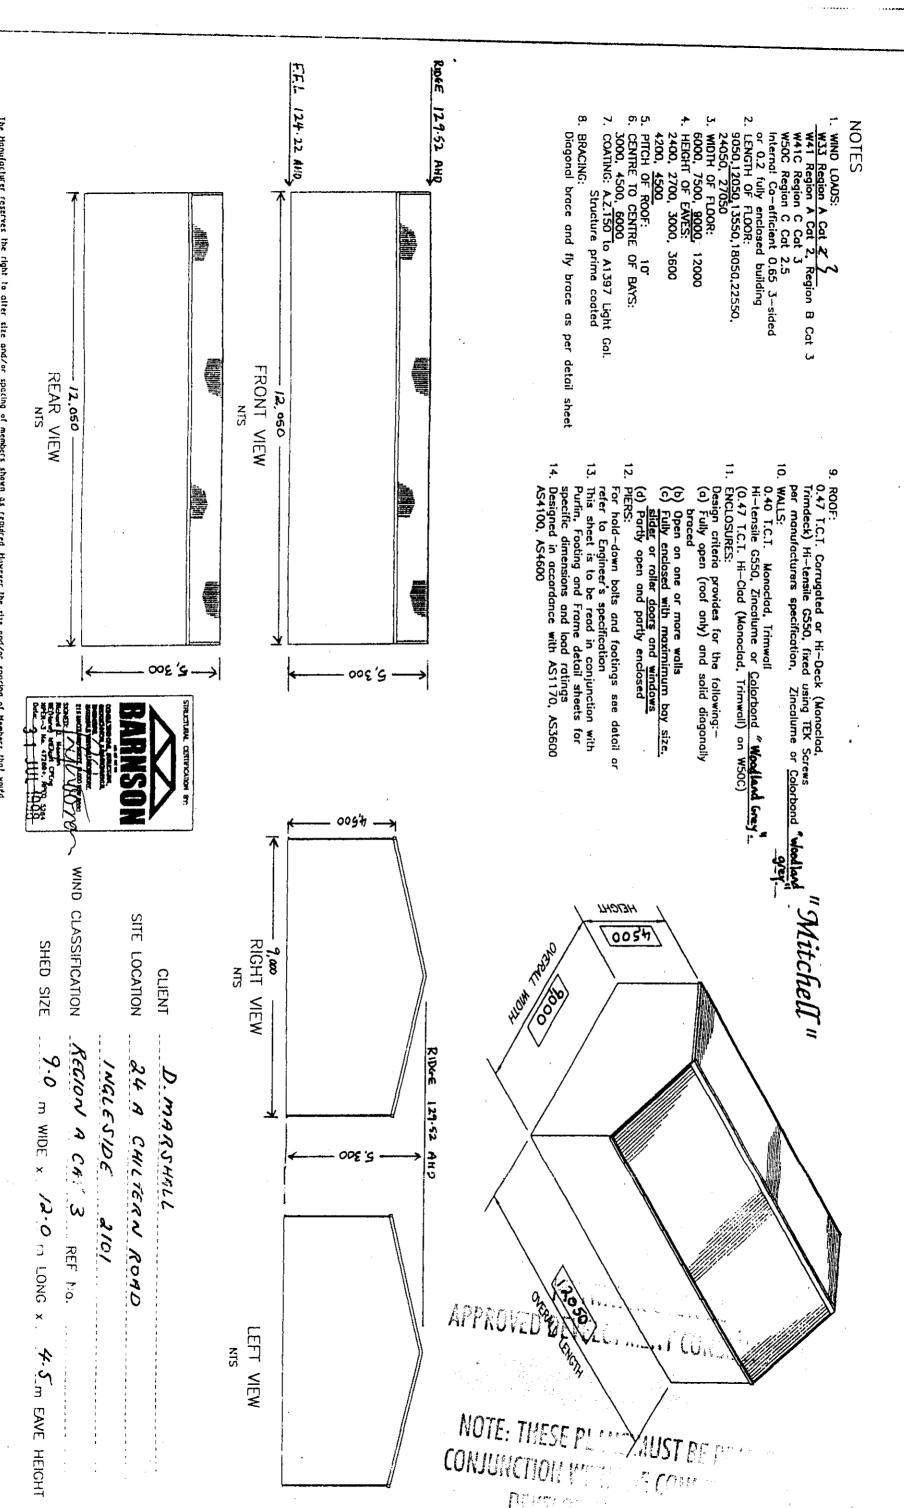


The Hanvlacturer reserves the right to alter size and/or spacing of members shown as required, However the size and/or spacing of Members that would be used must have section properties etc. not less than those shown. These plans and specifications are copyright and no part may be reproduced without written permission, other than permitted by law.

FF-01-0



9m **MIDE** ENCLOSED, W41F 4.5m જ઼ EAVE W41 SIDE ED AND EIGHT x BUILDING CLASSIFICATION ROOF ONLY 4.5-6.0m BAYS

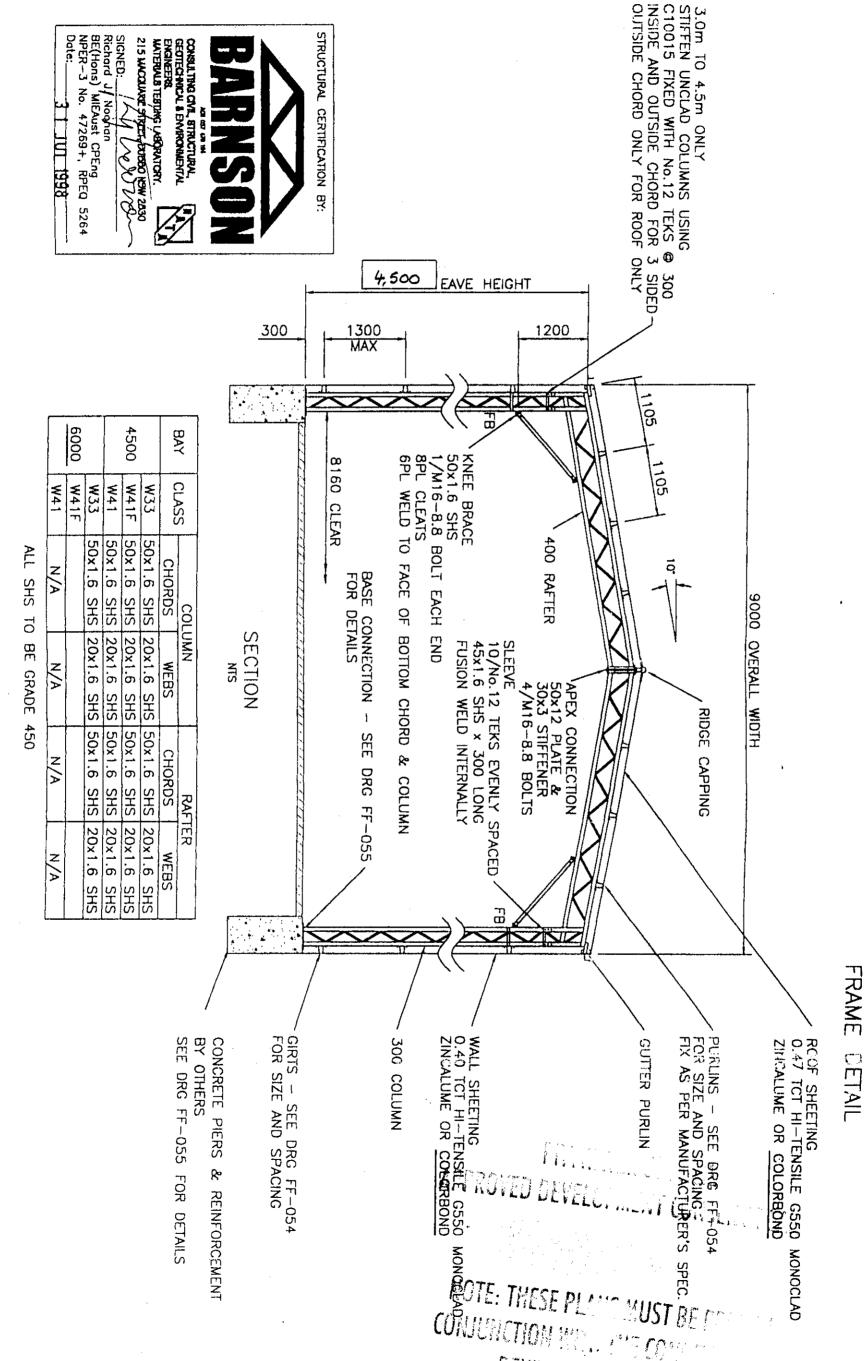



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FF-053-F **




9m WIDE x COLUMN HOLD Y ENCLOSED, W41F FIFTY-FIFTY om EAVE ጵ 3 SI DOWN BOLTS LAYOUT **W**4 DED AND BUILDING HEIGHT × CLASSIFICATION ROOF ONLY 4.5-6m BAYS



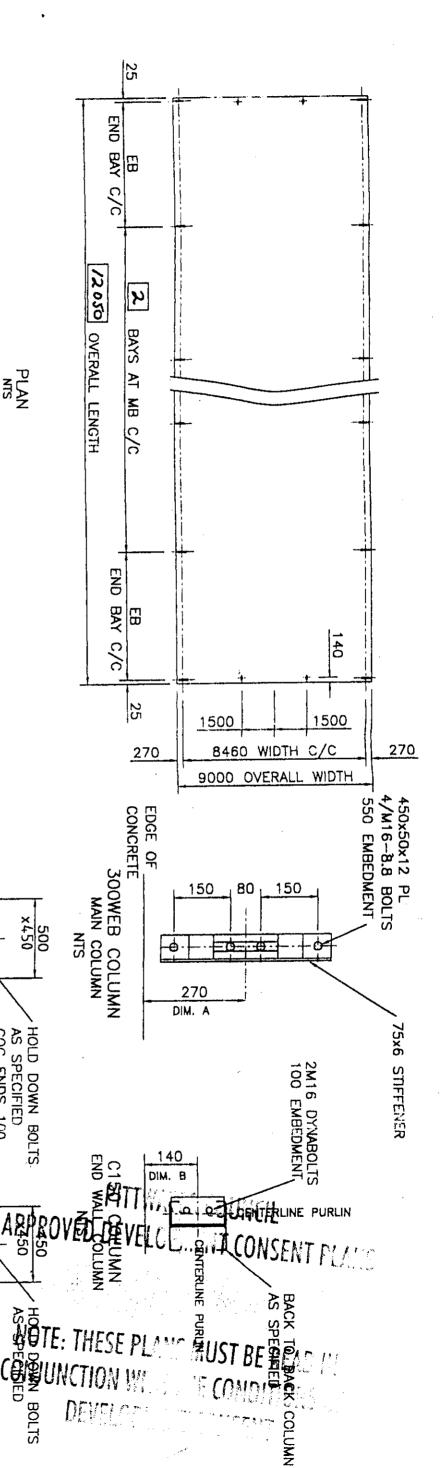

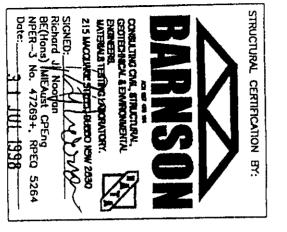FOOTING DIMENSIONS

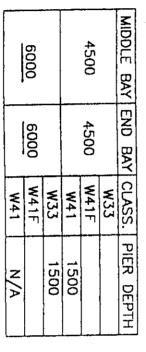

BORED PIER MAIN COLUMN NTS	300 450 DIA	4/Y16 LAPPED WITH BOLTS	500
THE FOOTINGS SHOWN HAVE BEEN DESIGNED FOR A CLASS M SITE AS DEFINED BY AS2870 WITH AN ALLOWABLE BEARING PRESSURE OF 100kPa AND CONCRETE STRENGTH OF 25MPa. SHOULD SITE CONDITIONS DIFFER FROM THIS, THE ADVISE OF A PROFESSIONAL ENGINEER SHOULD BE OBTAINED.	MASS FOOTING END WALL COLUMN (OPTIONAL) NTS	500 600	

COG ENDS 100

The Hamufacturer reserves the right to alter size and/or spacing of members shown as required. However the size and/or spacing of Hembers that would be used must have section properties etc. not less than those shown. These plans and specifications are copyright and no part may be reproduced without written permission, other than permitted by law.


FF-055-F *

Plot Scale 1:175 Org. No. FF-055-F *



9m WIDE W41F 4.5m FIFTY-FIFTY ģ W4: BUILDING EIGHT x CLASSIFICATION 6.0m BAYS

PURLIN AND ENCLOSED, GIRT LAYOUT AND SIDE D AND MISCELLANEOUS DETAILS ROOF ONLY

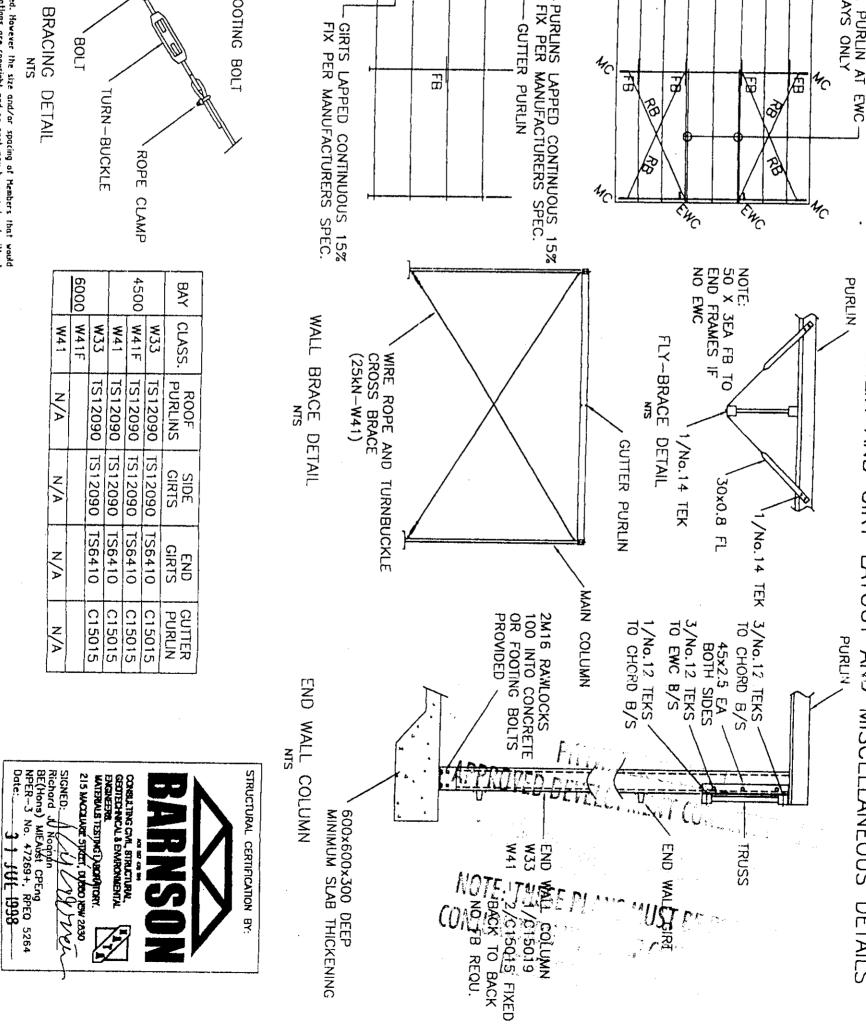

1300 MAX

ST.

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83

FB

33

BRACING LOCATION No. OF BAYS

5-10 11-20 14

BOTH ENDS

MID & BOTH ENDS

FOOTING BOLT

END

BRACING

FRONT VIEW

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PLAN

CUTTER PURLIN

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FB 4C

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DOUBLE PURLIN AT EWC 6.0m BAYS ONLY

140

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FB

FB

The Hanufacturer reserves the right to alter size and/or spacing of members shown as required. However the size and/or spacing of Hembers that would be used must have section properties etc. not less than those shown. These plans and specifications are copyright and no part may be reproduced without FF-054-E *

Plat Scale 1:175 Drg. No. FF-054-E *

RIGHT VIEW

LEND GIRTS

ENCLOSED WALL ONLY

BRACING

DETAIL


LTOB,


TURN-BUCKLE

FΒ


FВ

1300 MAX

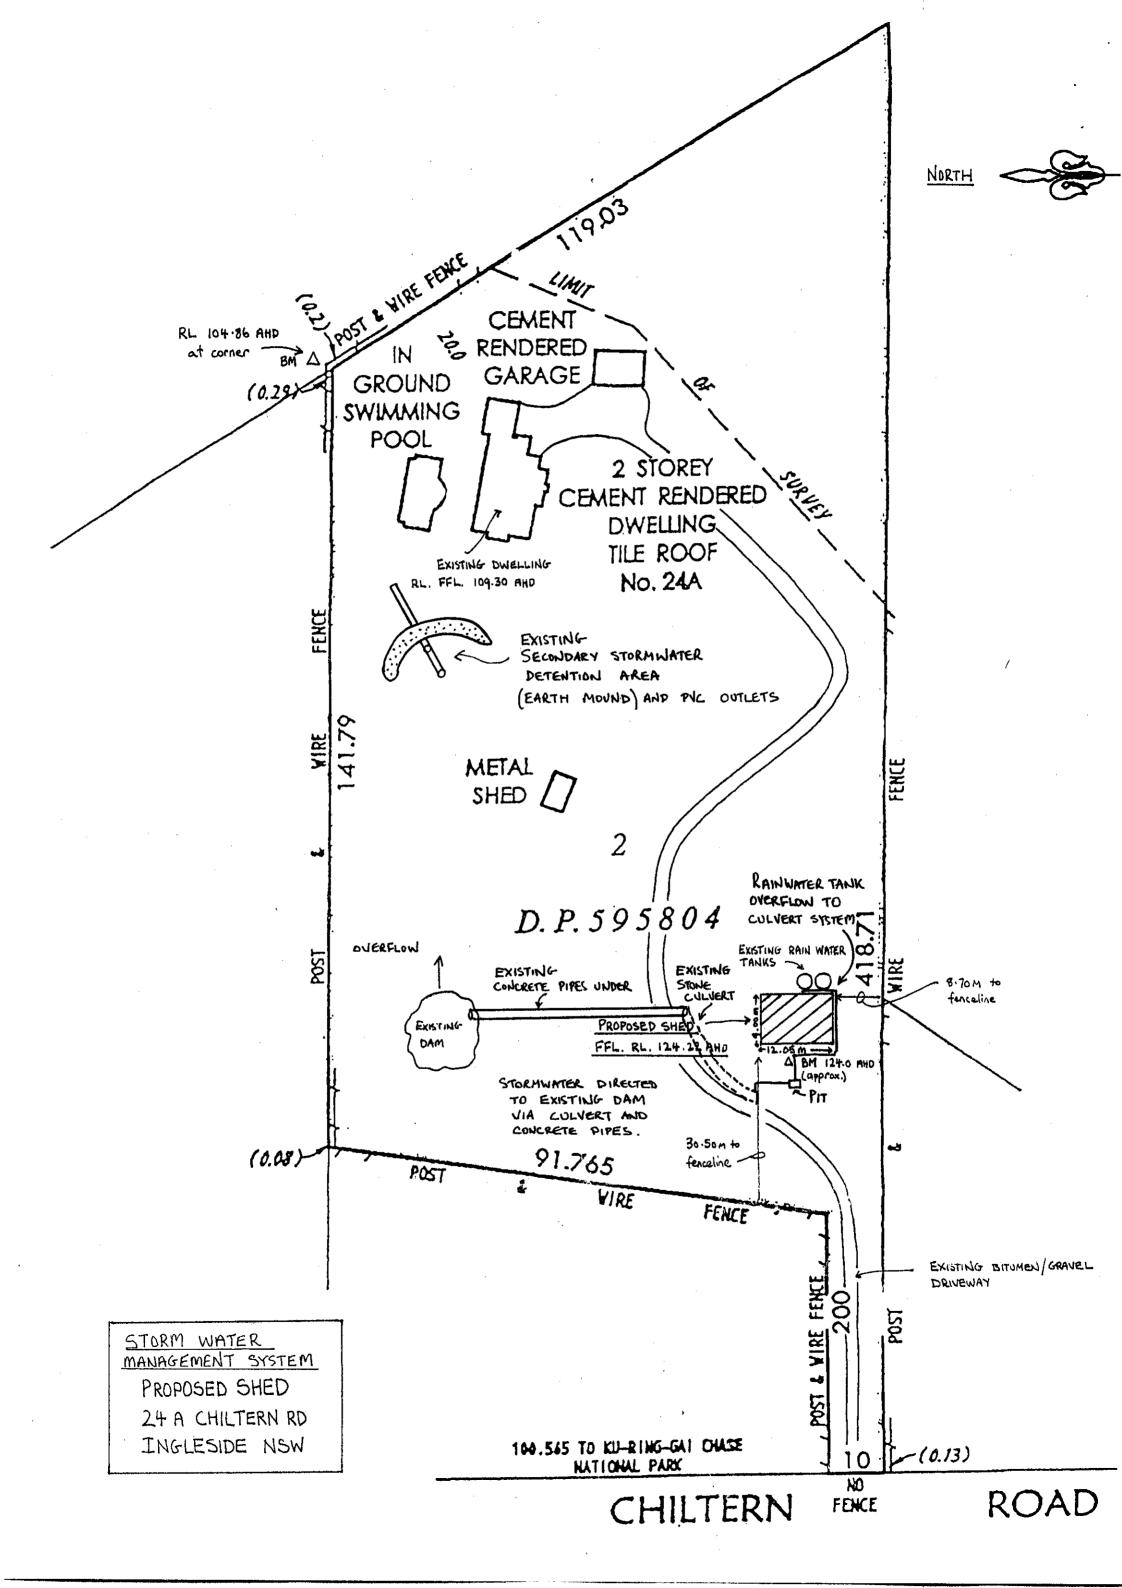

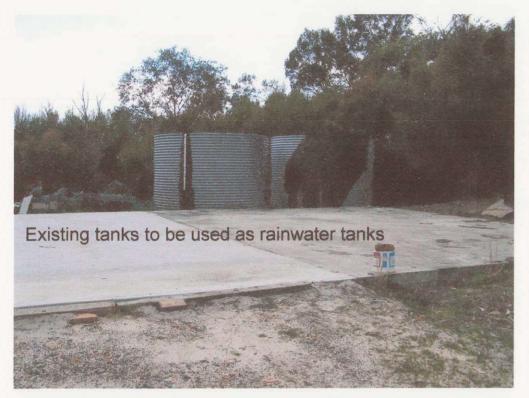



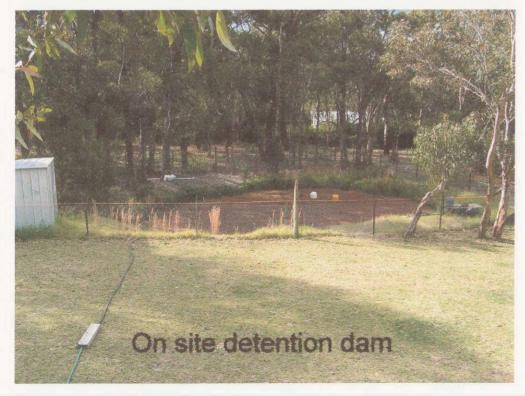









DAVID WILLIAM MARSHALL 24 A CHILTERN RD INGLESIDE 2101 HOME BUILDING ACT 1989
OWNER BUILDER PERMIT

Permit :297671P Receipt:AA2114207 Issued:12/08/2005 Amount:\$132.00

Building Site:

24 A CHILTERN ROAD, INGLESIDE 2101

Authorised Building Work:

DA NO279/05 KIT FORM SHED, STEEL FRAME & ROOF ISSUED BY PITTWATER COUNCIL

Should the property be sold within 6 years of completion of the work it will be necessary to obtain home warranty building insurance from approved insurers if the value of the work was greater than \$12,000. A certificate of insurance must be attached to any contract for sale.

You should obtain professional advice from general insurers regarding public liability and property damage cover, etc.

Note: This permit is only valid when an official receipt has been imprinted.

If payment is made by cheque, the permit is conditional on the cheque being met at presentation.

Issuing Officer

****** END OF PERMIT *******



Application Lodgement Summary



Reference Number 1442967

Date Requested: Wed August 31 2005

Agent

Reece Mona Vale, 10 Taronga Pl Mona Vale

Applicant

Dw Marshall Lk Marshall, Lot 2 Chiltern Rd Ingleside 2101

Property/Asset

Lot 2 Chiltern Rd, Ingleside 2101 (Dw Marshall Lk Marshall) PNum: 3407685

Product

Building Plan Approval Application

Charge Product Cost GST Total

Building Plan Approval Application Fee \$16.50 \$0.00 \$16.50

Construction Certificate Application Consent No. 0279/05 - Erection of a Rural Shed

David and Lisa Marshall 24 A Chiltern Rd. INGLESIDE NSW 2103 Phone 9997 7080

Site Detention and Stormwater Management System Details.

Our property located at Ingleside has no town water supply. The management of rainwater and stormwater in an efficient manner is of utmost importance to us.

The property has a number of existing stormwater and detention systems that we plan to utilise as part of the new development.

The attached drawing titled STORMWATER MANAGEMENT SYSTEMS shows the extent of existing features and the additional reticulation to be installed.

- 1/.. Rainwater that falls onto the roof of the new development will be directed to the 2 (two) existing water tanks adjacent to the site. These tanks each have a capacity of 10,000 litres giving a total of 20,000 litres storage. This exceeds the requirements of Consent item Part B 1. These tanks are shown on the attached photograph titled *Existing tanks to be used as rainwater tanks*.
- 2/.. Any overflow from the rainwater tanks will be directed to the existing dam via a system of pipework and stone lined drainage culverts. This system is shown on the attached photographs Stone lined drainage culvert to dam, on site detention dam, and Stormwater detention dam showing inlet. In addition to the dam, there is a secondary detention area as part of the management system. This is shown on the photographs marked Secondary detention area and Secondary detention area detail 1. Together the detention capacity of the dam and secondary area is estimated in excess of 50,000 litres. This satisfies Consent item Parts B 2. and B 3.