MOD LANDSCAPE

142 Melwood ave Killarney Heights NSW 2087

LANDSCAPE MAINTENANCE NOTES

MONTH	MOWING EDGING BLOWING	FERTILISING (SEASOL)	CHECK	HAND WEED REMOVAL	PRUNING	WEED SPARAYING	WATERING/ IRRIGATION	PLANT REPLACEMENT IF REQUIRED
DEC	W	М	М	W	F	М	D	W
JAN	W	М	М	W	F	М	D	W
FEB	W	М	М	W	F	М	D	W
MAR	F	М	М	F	М	М	D	W
APR	F	N/A	М	F	М	М	D	W
MAY	F	N/A	М	М	М	М	D	W
JUNE	M	N/A	М	М	N/A	N/A	2ND D	W
JULY	М	N/A	М	М	N/A	N/A	2ND D	W
AUG	М	N/A	М	М	N/A	N/A	2ND D	W
SEP	М	M	М	М	N/A	N/A	2ND D	W
ОСТ	F	F	М	F	М	М	D	W
NOV	F	F	М	F	М	М	D	W



Drawing List

Sheet No.	Sheet Name	Scale	Rev. No.	Rev. Date	Project No.
L-00	TITLE PAGE	1:200 @A3	l	11/04/2025	1411
L-01	SITE PLANS	1:200 @A3	ı	11/04/2025	1411
L-02	WASTE MANAGEMENT SITE PLAN	1:200 @A3	I	11/04/2025	1411
L-03	LANDSCAPED AREA CALCULATION PLAN	1:200 @A3	ı	11/04/2025	1411
L-04	PLANTING PLAN (Rear Yard)	1:100 @A3	ı	11/04/2025	1411
L-05	PLANTING PLAN (Front Yard)	1:100 @A3	ı	11/04/2025	1411
L-06	SECTION A	1:50 @A3	ı	11/04/2025	1411
L-07	ELEVATION B	1:50 @A3	l	11/04/2025	1411
L-08	ELEVATION C	1:50 @A3	ı	11/04/2025	1411
L-09	ELEVATION D	1:50 @A3	ı	11/04/2025	1411
L-10	SECTION E (CARPORT)	1:50 @A3	1	11/04/2025	1411
L-11	ELEVATION F (CARPORT)	1:50 @A3	I	11/04/2025	1411
L-12	ELEVATION G (CARPORT)	1:50 @A3	l	11/04/2025	1411
L-13	ELEVATION H (CARPORT)	1:50 @A3	ı	11/04/2025	1411
L-14	ELEVATION I (STREET ELEVATION)	1:75 @A3	I	11/04/2025	1411
L-15	SPECIFICATION	N.T.S@A3	ı	11/04/2025	1411
L-16	NOTES	N.T.S@A3	I	11/04/2025	1411



Note:

Modification applies solely to the Front Yard area. No changes are proposed beyond this specified zone.

11/04/25 ISSUE FOR MOD APPROVAL

ISSUE DATE COMMENT

AMENDMENTS

MAINTENANCE GENERAL

until the formal maintenance period commences.

1.4 RECURRENT WORKS

1.6 REPLACEMENTS

1.8 GRASSED AREAS

Furnish a proposed planting maintenance program with the tender

1.3 MAINTENANCE LOGBOOK

limited to: - Activities carried out during each attendance; - Irregularities encountered and actions taken;

conducted to all current and relevant Australian Standards

2.1 LANDSCAPE MAINTENANCE REPORT

Note:

Note:

SECTION C: LANDSCAPE MAINTENANCE SPECIFICATION 1.0 SCOPE

NB: Maintenance payments will be evaluated on submission of monthly logbooks.

The 52 week Planting Establishment Period commences at the date of registration of the repective plan.

The contractor is to also allow for maintenance from the date of Practical Completion to the start date of the 52 week Planting Establishment Period. The allowance shall be for a weekly rate which will then be implemented

Contractor to keep a maintenance record of works carried out on a monthly basis. Log should include but not

Throughout the Planting Establishment Period, continue to carry out recurrent works of a maintenance nature including, but not limited to, watering, mowing, weeding, rubbish removal, fertilising, pest and disease control, staking and tying, replanting, cultivating, pruning and keeping the site neat and tidy. All rubbish related to landscape works shall be removed by the landscape contractor before it is allowed to accumulate.

Commence recurrent planting maintenance works at the completion of planting. Ensure the stock arriving on site is protected and maintained for healthy growth.

Commence grass maintenance works at the completion of turfing, and continue to carry out grass maintenance throughout the contract and Planting Establishment Period, maintaining healthy weed free growth.

The contractor is to be completely responsible for the coordination of the installation of the irrigation system with other services throughout the site. Recommended flow rates: The system shall be set up on a trial basis and them adjusted to suit the local requirements and conditions. Once the system is satisfactorily adjusted the contractor shall make fortnightly visits within the establishment period to ensure satisfactory performance of the system and to adjust the watering periods as required. A minimum even coverage of 25mm of water per week is

'Landscape Maintenance Reports' shall be submitted to the Principle Certifying Authority by the contractor verifying that satisfactory maintenance of the landscape works has been undertaken and that any necessary rectification measures have been carried out to a high professional standard. This documentation is to be submitted through the plant establishment period.

All building works must be carried out in accordance with the

requirements of the Building Code of Australia (BCA)

Stormwater Disposal - All stormwater drainage will be

connected to the existing stormwater system

Continue to replace failed, damaged or stolen plants for the extent of the Planting Establishment Period. 1.7 MULCHED SURFACES

Adjust or replace as required. Remove those not required at the end of the Planting Establishment Period. 1.10 WATERING/ IRRIGATION An irrigation system is to be installed to all mass planted beds and new tree planting, connected to a pump and the rainwater tank /OSD tank. Install one tap near the front boundary (Wurrook Circuit) and one tap on the rear (eastern) boundary. This system shall be installed and maintained for the duration of the maintenance period (52 weeks) and in perpetuity of the development. All irrigation works shall be performed by a licensed irrigation contractor. Materials to be used are to be submitted to the site superintendent for approval. The contractor shall provide design drawings and material specifications/samples prior to commencing work. All works are to be

Maintain the surface in a clean and tidy condition and reinstate the mulch as necessary

NOTES

Date 11/04/2025

Scale 1:200 @A3

Project Barda Residence SYDNEY NORTH STUDIO

142 Melwood Avenue Killarney, Heights NSW 2087

Drawing Title TITLE PAGE

es Regulations and all other relevant Authorities concerned.

ural work and site drainage to be subject to Engineer's details or certification where required by Council. This shall include r.c. slabs and footings, r.c. an ams & columns, wind bracing to AS 1170

36 columns, wind bracing to AS 1170

36 columns, wind bracing to AS 1170

37 columns wind bracing to AS 1170

38 columns, wind bracing to AS 1170

38 columns, wind bracing to AS 1170

39 columns and Sa 1170

30 columns and Sa 1170

30 columns and Sa 1170

30 columns and Sa 1170

31 columns and Sa 1170

32 columns and Sa 1170

33 columns and Sa 1170

34 columns and Sa 1170

35 columns and Sa 1170

36 columns and Sa 1170

37 columns and Sa 1170

38 columns and Sa 1170

39 columns and Sa 1170

30 columns and S SITEDESIGN

PO Box 265 SEAFORTH NSW 2092 info@sdstudios.com.au www.sdstudios.com.au


creating places to live in and enjoy

0417685846 <u>p</u> 1300 22 44 55

Drawing No.1411

Page

Note: All building works must be carried out in accordance with the requirements of the Building Code of Australia (BCA)

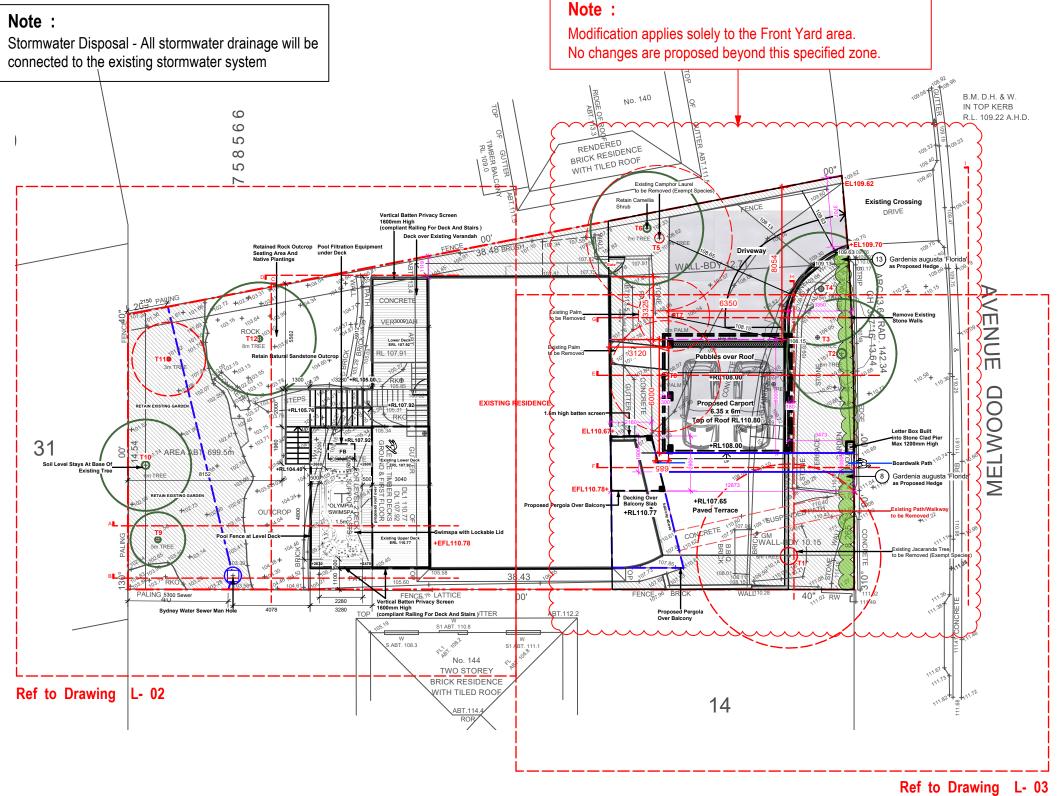

EXISTING TREES LEGEND



LEGEND




SITE COVERAGE CALC

SITE AREA OF BLOCK = 699.5 Sqm

Proposed Landscape Area (Include Rock Outcrop area) = 268 Sqm or 40.1% of Site Area

Pool Capacity 7.325 KL

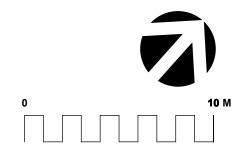

11/04/25 ISSUE FOR MOD APPROVAL

ISSUE DATE COMMENT

AMENDMENTS

Page

GENERAL NOTES
All work to be carried out in accordance with the Building Code of Australia, all Local and State Government Ordinances, relevant Australian Standards, Local Authorities Regulations and all other relevant Authorities concerned.
All structural work and site drainage to be subject to Engineer's details or certification where required by Council. This shall include r.c. slabs and foolings, r.c. and steel beams & columns, wind bracing to AS 1170
and AS4055, anchor rods or boils, its devones, fixings etc., driveway slabs and drainage to Council's satisfaction. All timbers to be in accordance with SAA Timber Structure Code AS1702 and AS407 milmer Framing Code AS 1684. All work to be carried out in a professional and workman-shiplike manner according to the plan

of accepted work produced reasoning in the control of acceptance of the first CLAUSE and acceptance of the first f



SYDNEY NORTH STUDIO PO Box 265 SEAFORTH NSW 2092 0417685846 <u>p</u> 1300 22 44 55 info@sdstudios.com.au www.sdstudios.com.au

Project	Barda Residence	
Address	142 Melwood Avenue Killarney, Heights NSW 2087	Date 11/04/2025
Drawing Ti	tle SITE PLANS	Scale 1:200 @A3
		Drawing No. 1411

CONSTRUCTION MANAGEMENT NOTES

- 1. NO VEGETATION OR GRASS COVER IS TO BE REMOVED EXCEPT WITHIN AREAS OF NEW CONSTRUCTION.
- 2. INSTALL HAY BALES OR SEDIMENT CONTROL FENCING AS NECESSARY TO ENSURE THAT SILT FROM ANY DISTURBED AREAS IS TRAPPED ON-SITE.
- 3. PROVIDE BARRIERS AROUND ALL CONSTRUCTION WORK ON THE FOOTPATH AREA TO PROVIDE SAFE ALTERNATIVE ACCESS FOR PEDESTRIANS.
- 4. ALL WASTE MATERIALS ARE TO BE REMOVED FROM SITE OR STOCKPILED WITHIN THE SITE PRIOR TO REMOVAL.

5. ALL CONSTRUCTION MATERIALS & SITE SHEDS ARE TO BE KEPT WITHIN THE SITE AT ALL TIMES.

9

9 2

 ∞

2

Sediment & Erosion Control Fe

SOIL & WATER MANAGEMENT NOTES

- 1. WHEREVER POSSIBLE, EXISTING VEGETATION & GRASS COVER IS TO BE LEFT UNDISTURBED.
- 2. REMOVAL OR DISTURBANCE OF VEGETATION & TOP SOIL SHALL BE CONFINED TO WITHIN 3m OF THE APPROVED BUILDING AREA.
- 3. TEMPORARY SILT FENCE (AS SHOWN) TO BE INSTALLED PRIOR TO THE COMMENCEMENT OF ANY EARTHWORKS.

-Material storage area

+RL107.65


14

4. AND MAINTAINED THROUGHOUT THE CONSTRUCTION PERIOD, AND PARTICULAR AFTER STORM EVENTS.

RENDERED BRICK RESIDENCE

WITH TILED ROOF

EXISTING TREES LEGEND

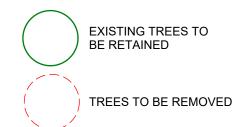

B.M. D.H. & W. IN TOP KERB


DRIVE


R.L. 109.22 A.H.D.

VENUE

ELWOOD

⋀

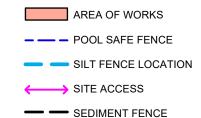

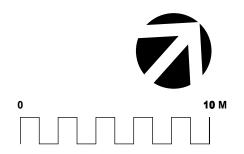

Note:

Modification applies solely to the Front Yard area. No changes are proposed beyond this specified zone.

Note:

All building works must be carried out in accordance with the requirements of the Building Code of Australia (BCA)

Note:

Stormwater Disposal - All stormwater drainage will be connected to the existing stormwater system

11/04/25 ISSUE FOR MOD APPROVAL ISSUE DATE COMMENT

AMENDMENTS

: In is the property of Sitedesign and should not be reproduced either in part or whole without the written o

SITEDESIGN creating places to live in and enjoy

SYDNEY NORTH STUDIO PO Box 265 SEAFORTH NSW 2092 0417685846 <u>p</u> 1300 22 44 55 info@sdstudios.com.au www.sdstudios.com.au

Project **Barda Residence** 142 Melwood Avenue Killarney, Heights NSW 2087 Date 11/04/2025 Drawing Title WASTE MANAGEMENT SITE PLAN Scale 1:200 @A3 Page

Drawing No.1411

EFL110.78

No. 144

TWO STOREY BRICK RESIDENCE ITH TILED ROOF

600mm High compliant Railing For Deck And Stairs)

Lower Deck



LANDSCAPE CALCULATION:


SITE AREA = 699.5 sqm


Existing Landscaped Area (Excluding Landscape less than 2 m wide, includes Natural Sandstone Outcrop as Landscape Area.) is 245 sqm or 35% of Site Area

Proposed Landscaped Area (Excluding Landscape less than 2 m wide, includes Natural Sandstone Outcrop as Landscape Area.) is 283 sqm or 40.46% of Site Area

EXISTING TREES LEGEND



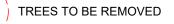

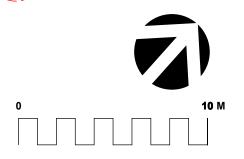

11/04/25 ISSUE FOR MOD APPROVAL


ISSUE DATE COMMENT

AMENDMENTS

SITEDESIGN +STUDIOS creating places to live in and enjoy

SYDNEY NORTH STUDIO PO Box 265 SEAFORTH NSW 2092 0417685846 <u>p</u> 1300 22 44 55 info@sdstudios.com.au www.sdstudios.com.au Project Barda Residence 142 Melwood Avenue Killarney, Heights NSW 2087 Date 11/04/2025 Drawing Title LANDSCAPED AREA CALCULATION Scale 1:200 @A3 **PLAN** Drawing No.1411


Page

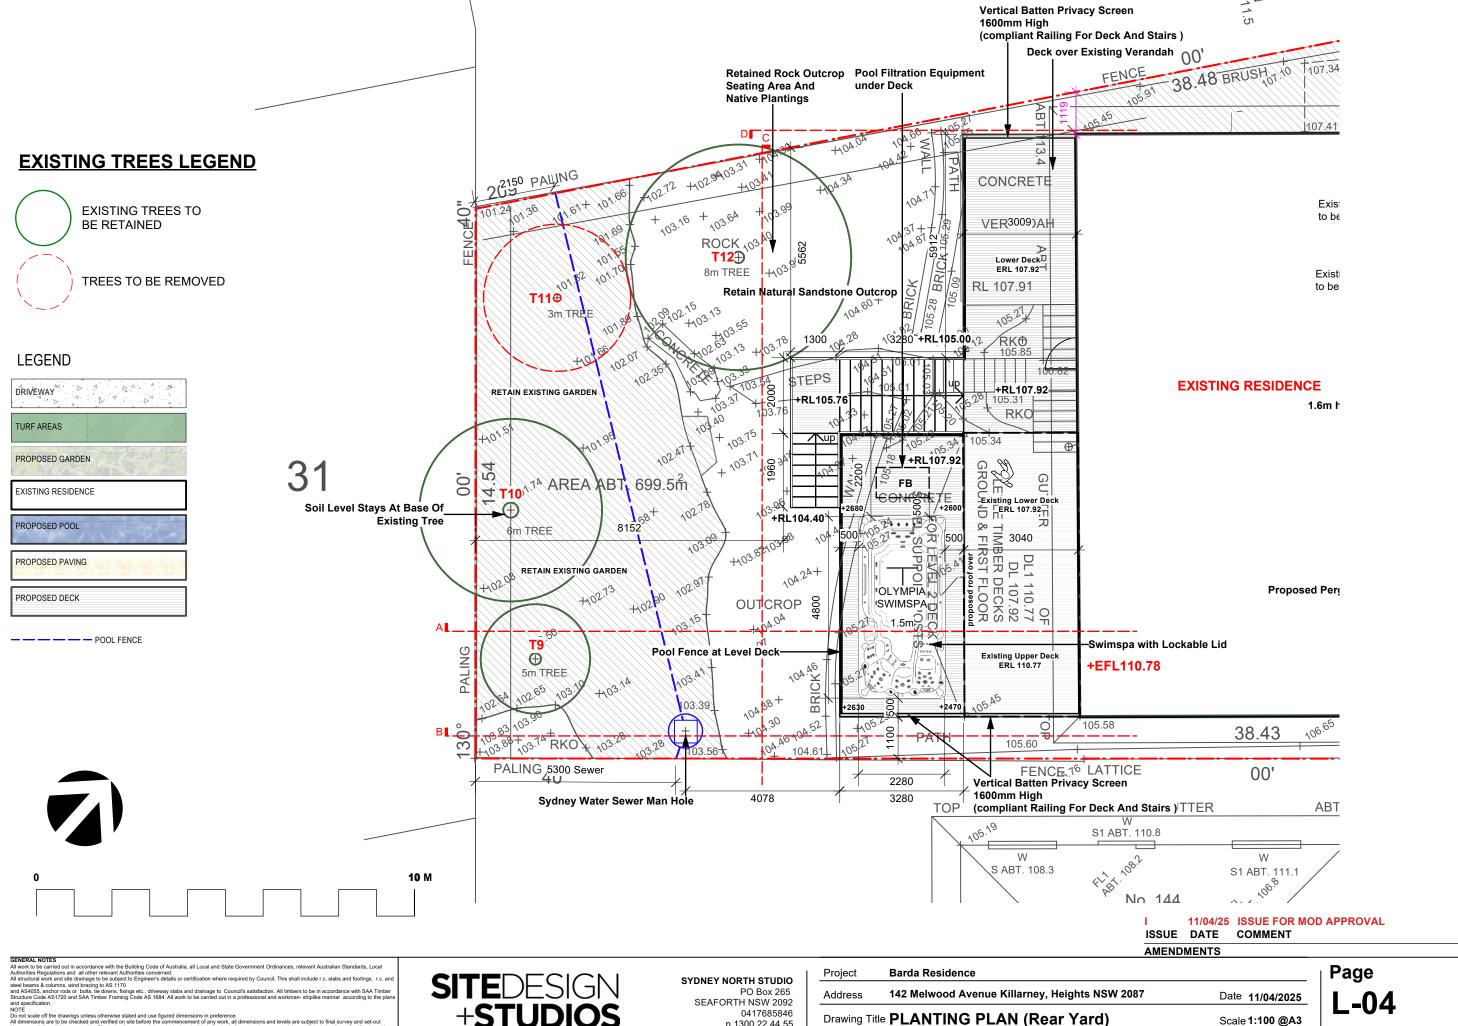



creating places to live in and enjoy


<u>p</u> 1300 22 44 55 info@sdstudios.com.au www.sdstudios.com.au


Drawing No.1411

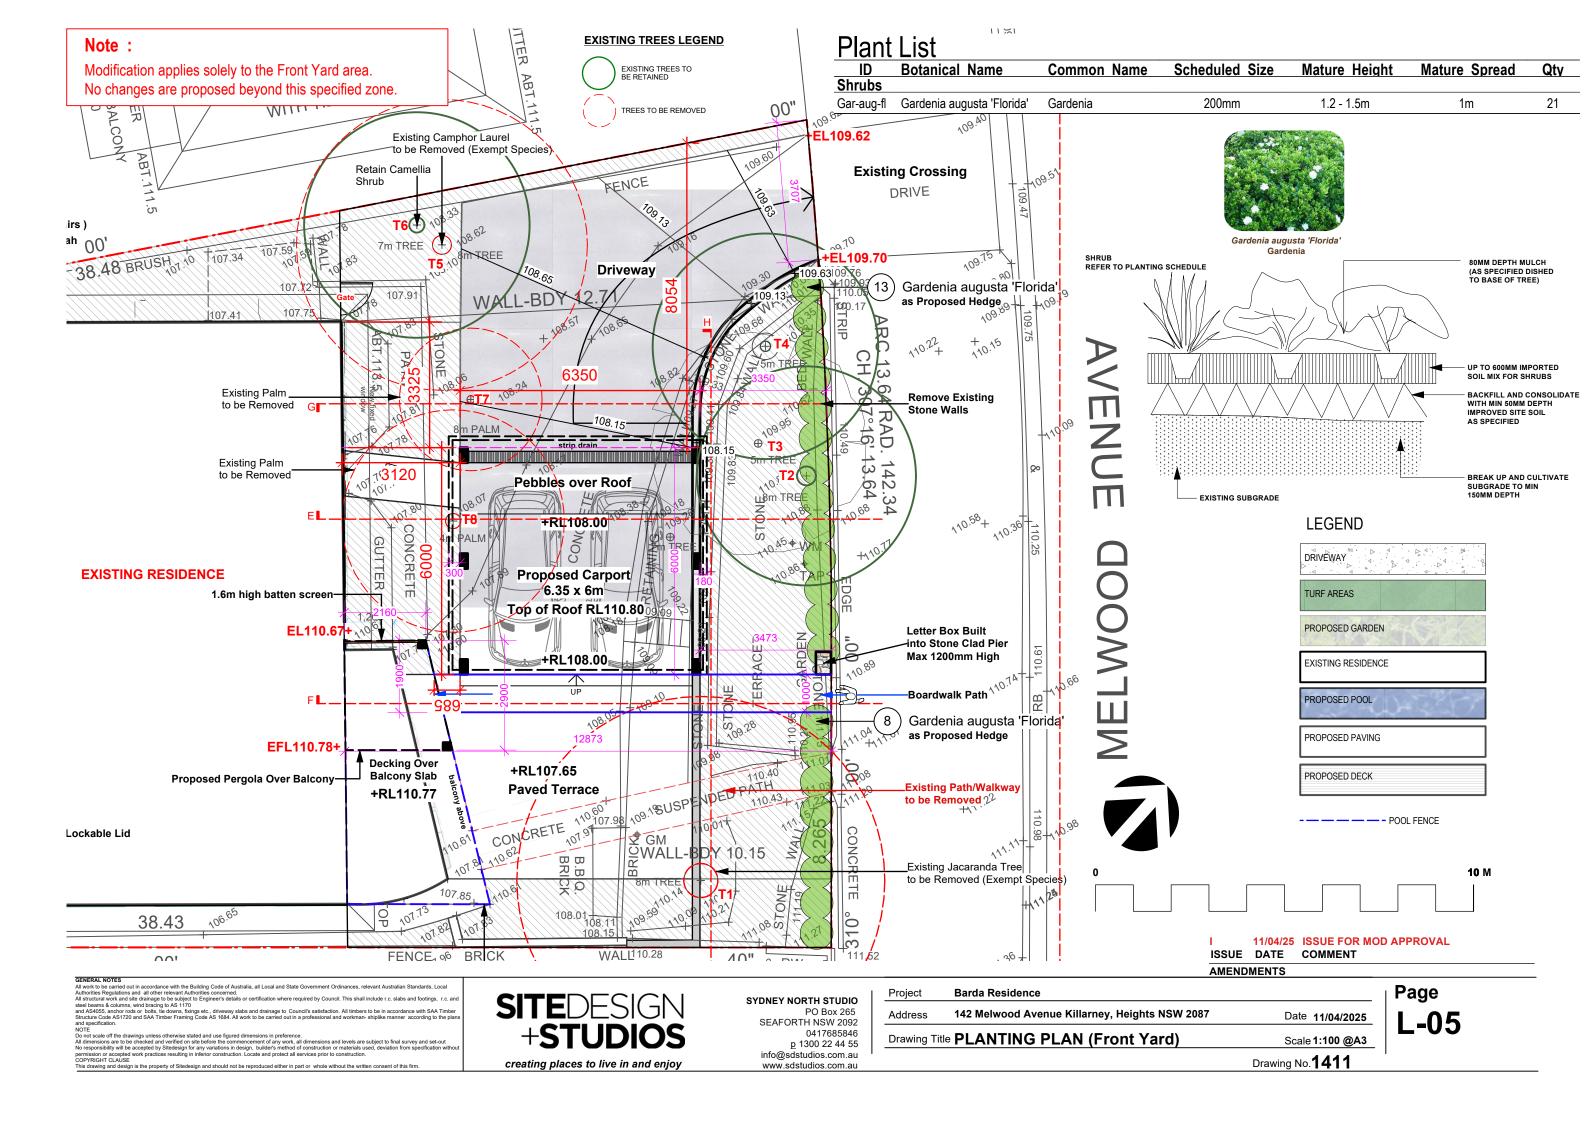

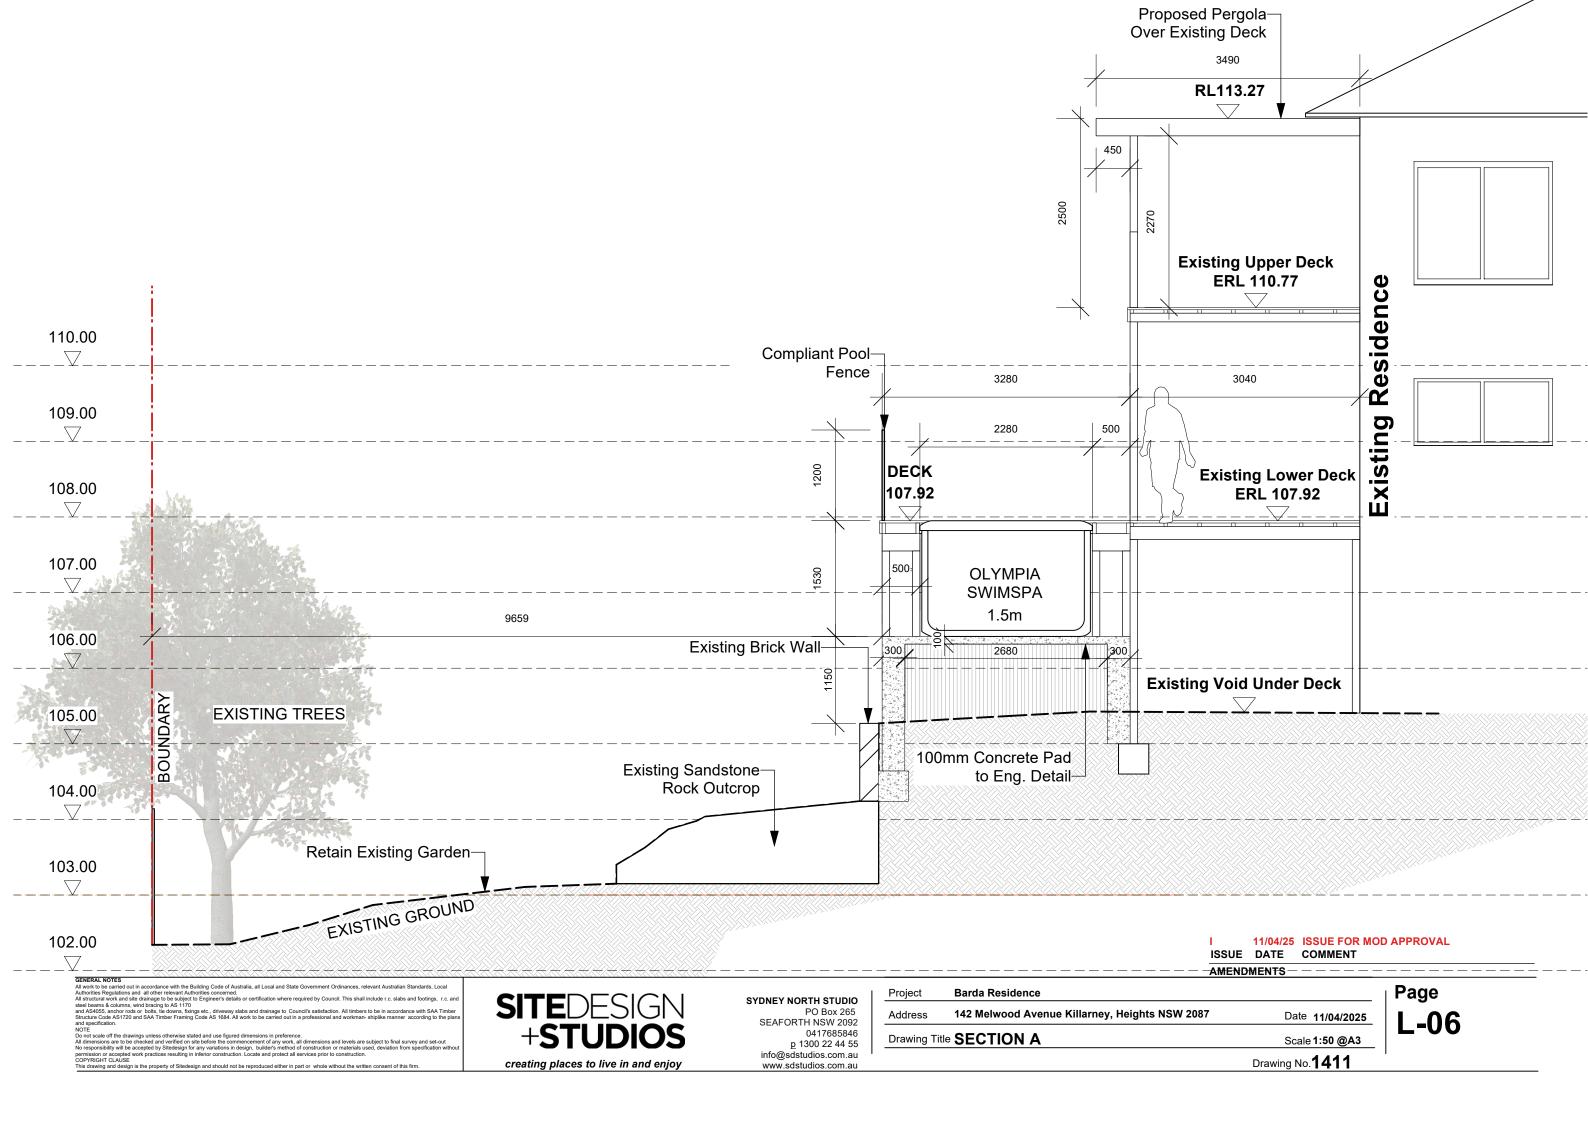

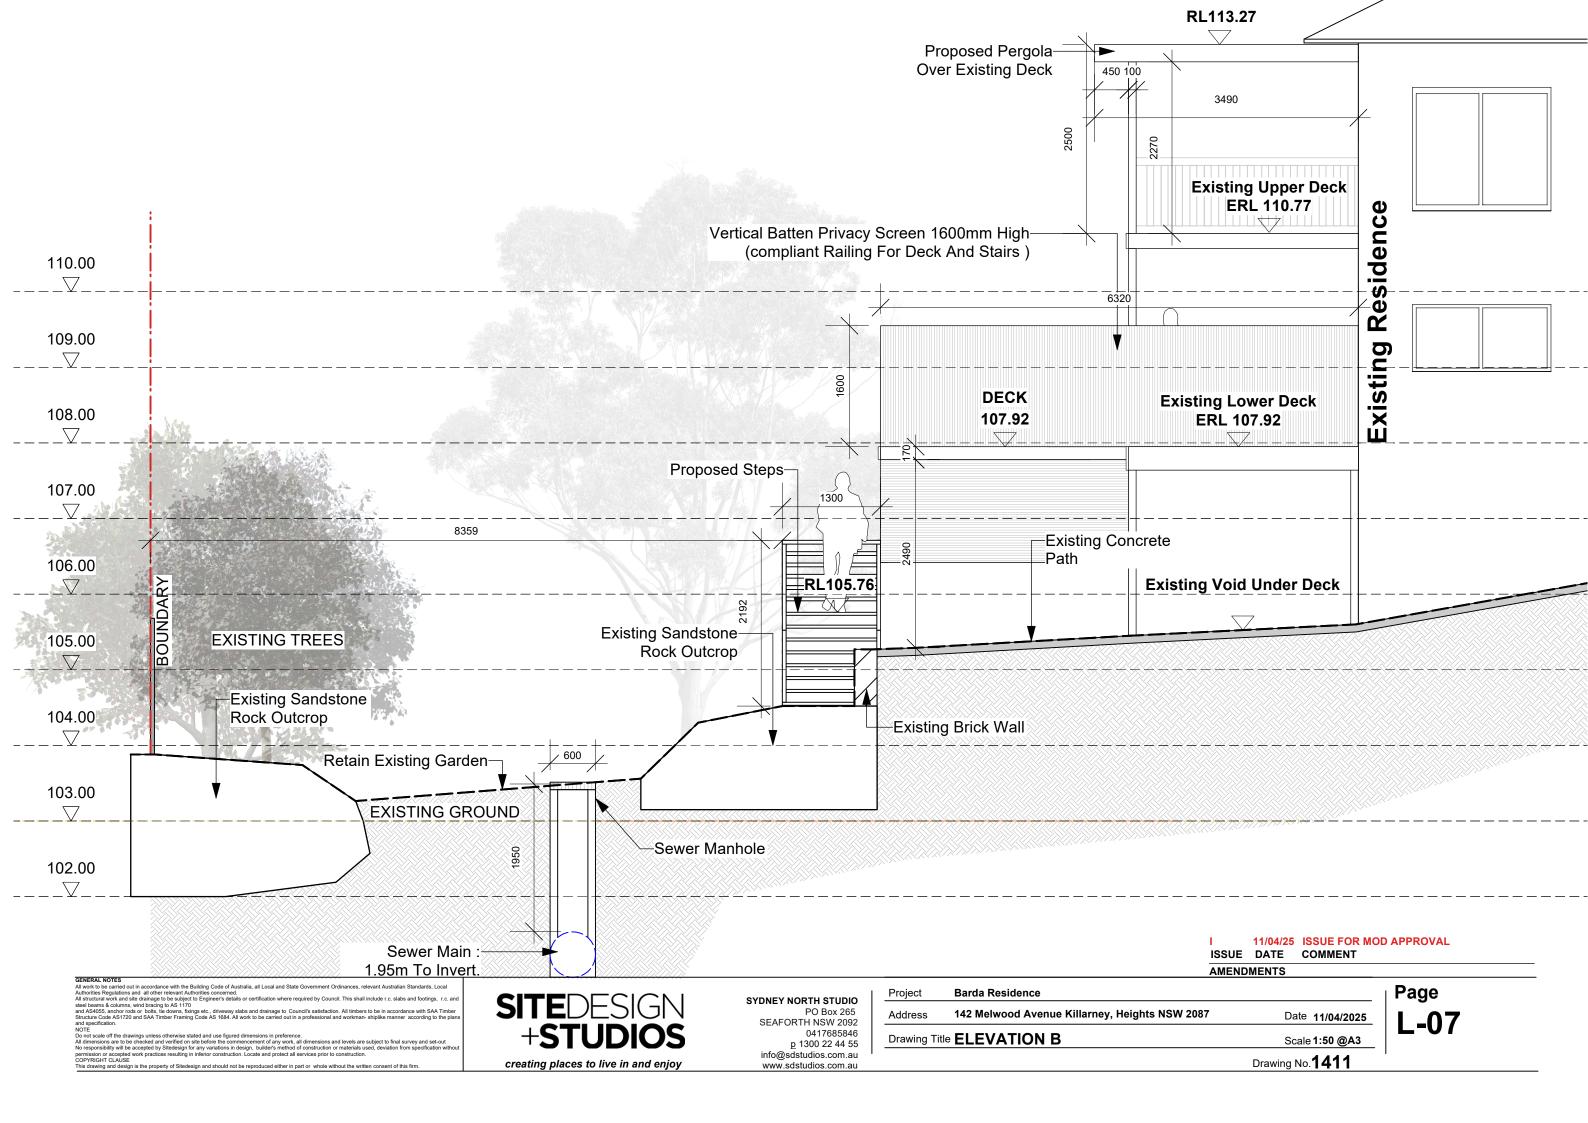

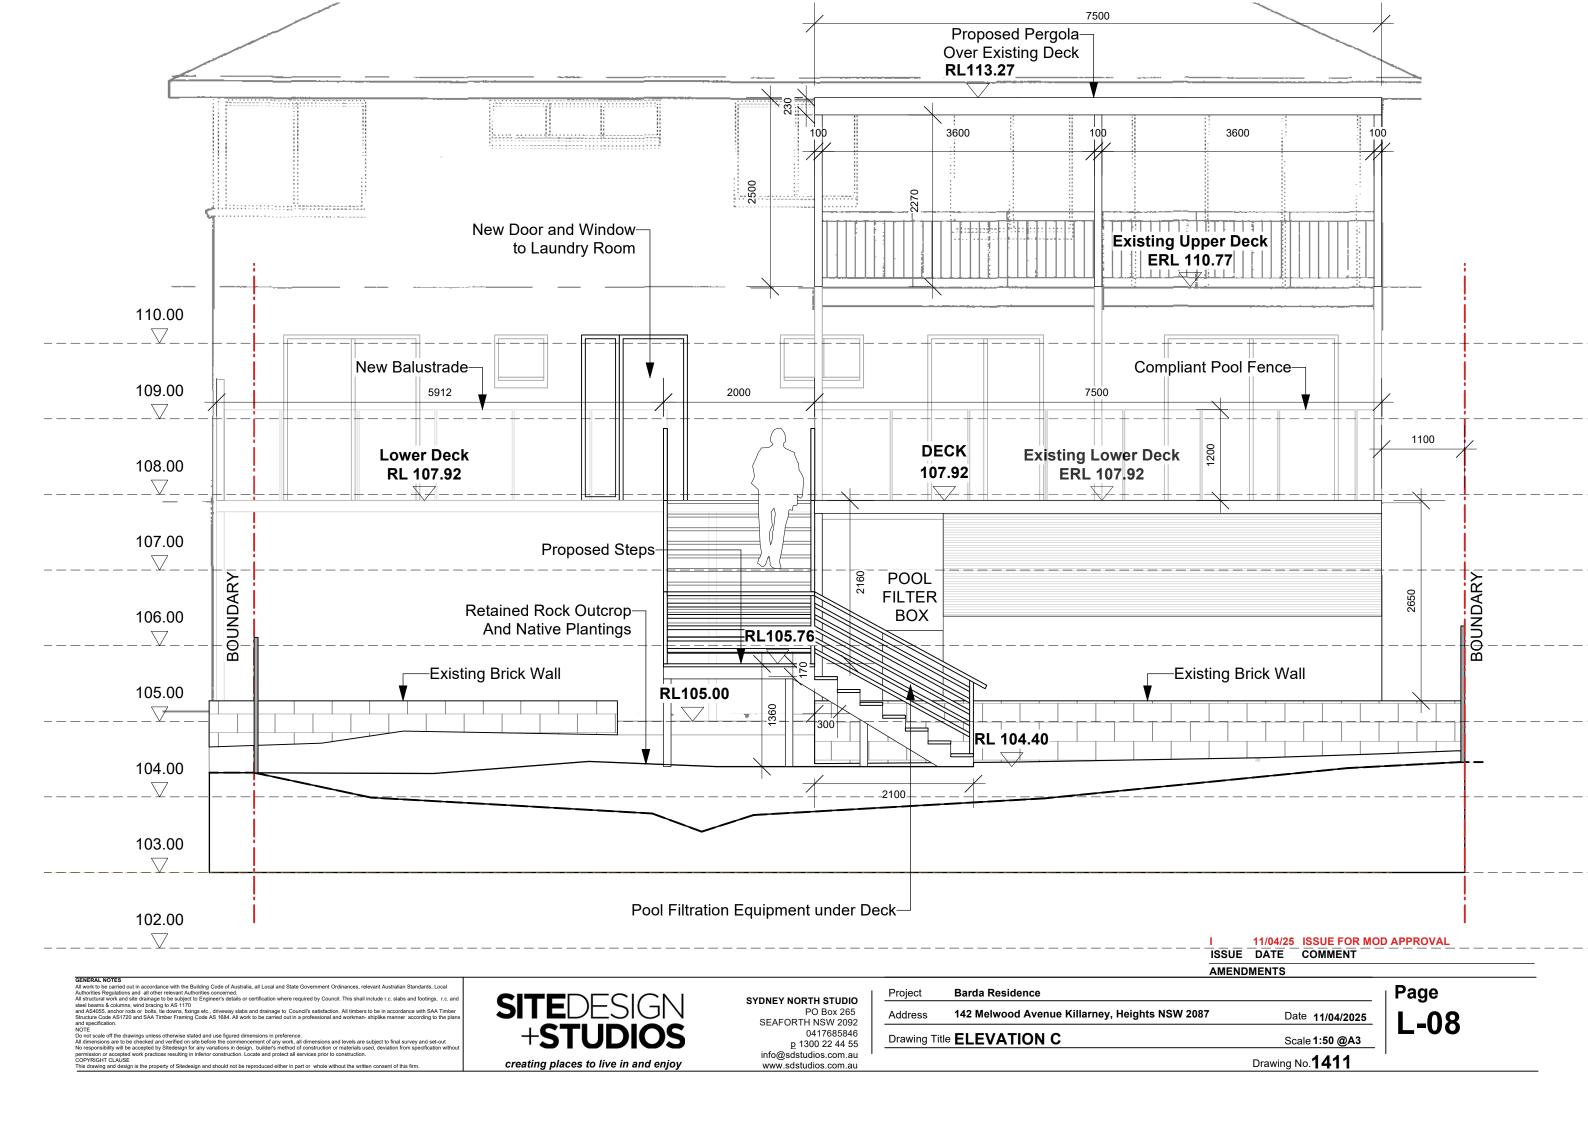

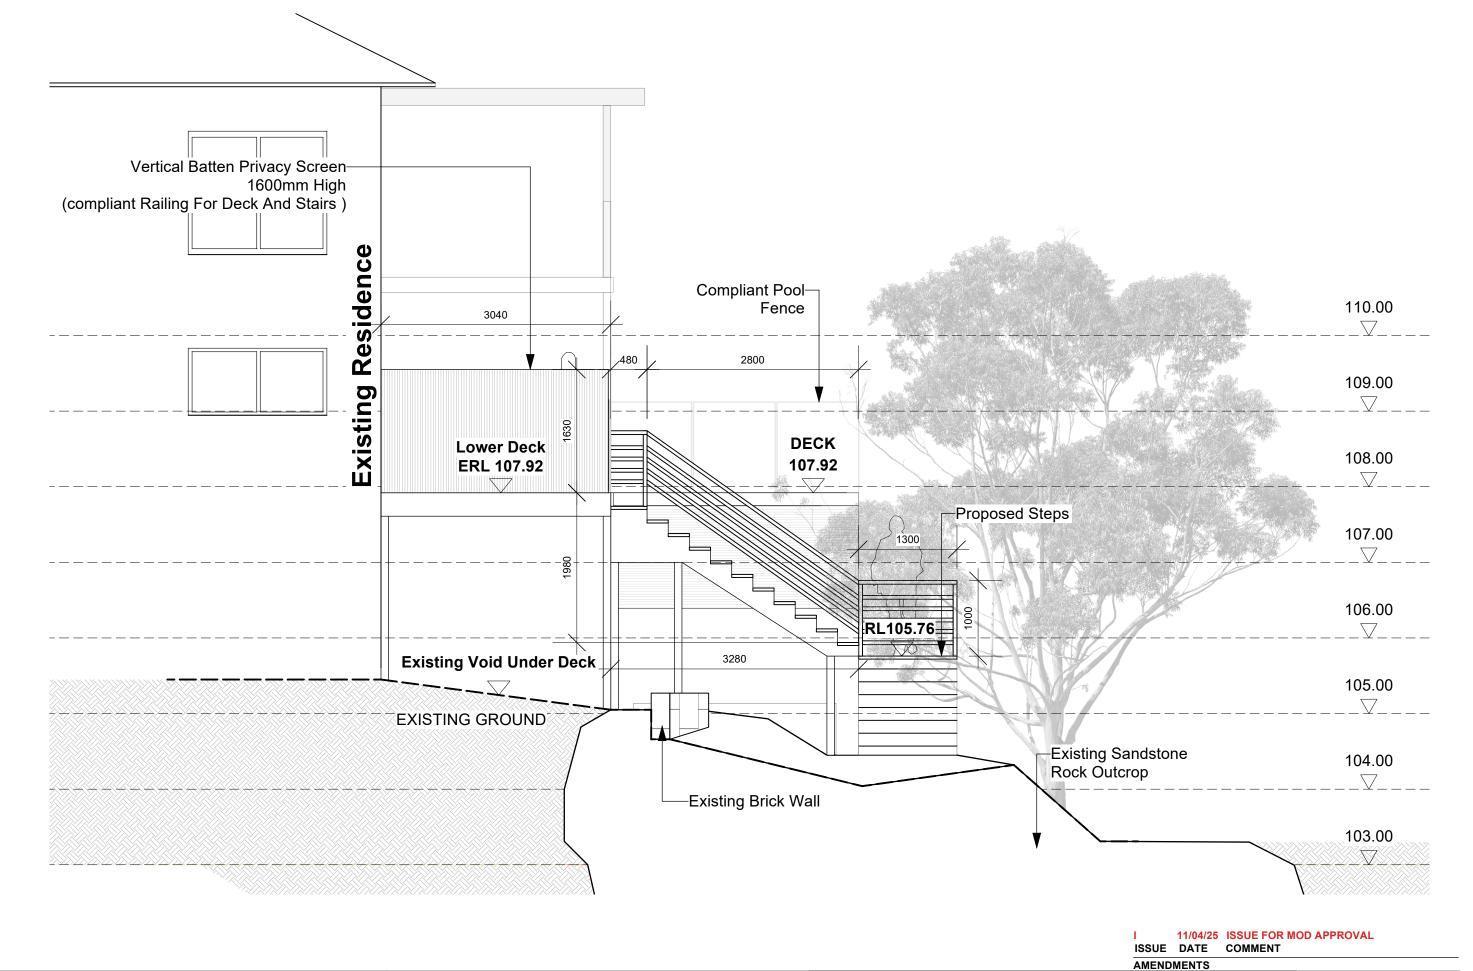


SITEDESIGN +STUDIOS creating places to live in and enjoy

SYDNEY NORTH STUDIO
PO Box 265
SEAFORTH NSW 2092
0417685846
p 1300 22 44 55 info@sdstudios.com.au www.sdstudios.com.au

Barda Residence Project 142 Melwood Avenue Killarney, Heights NSW 2087 Date 11/04/2025 Drawing Title **ELEVATION D** Scale 1:50 @A3 Drawing No.1411

Page L-09

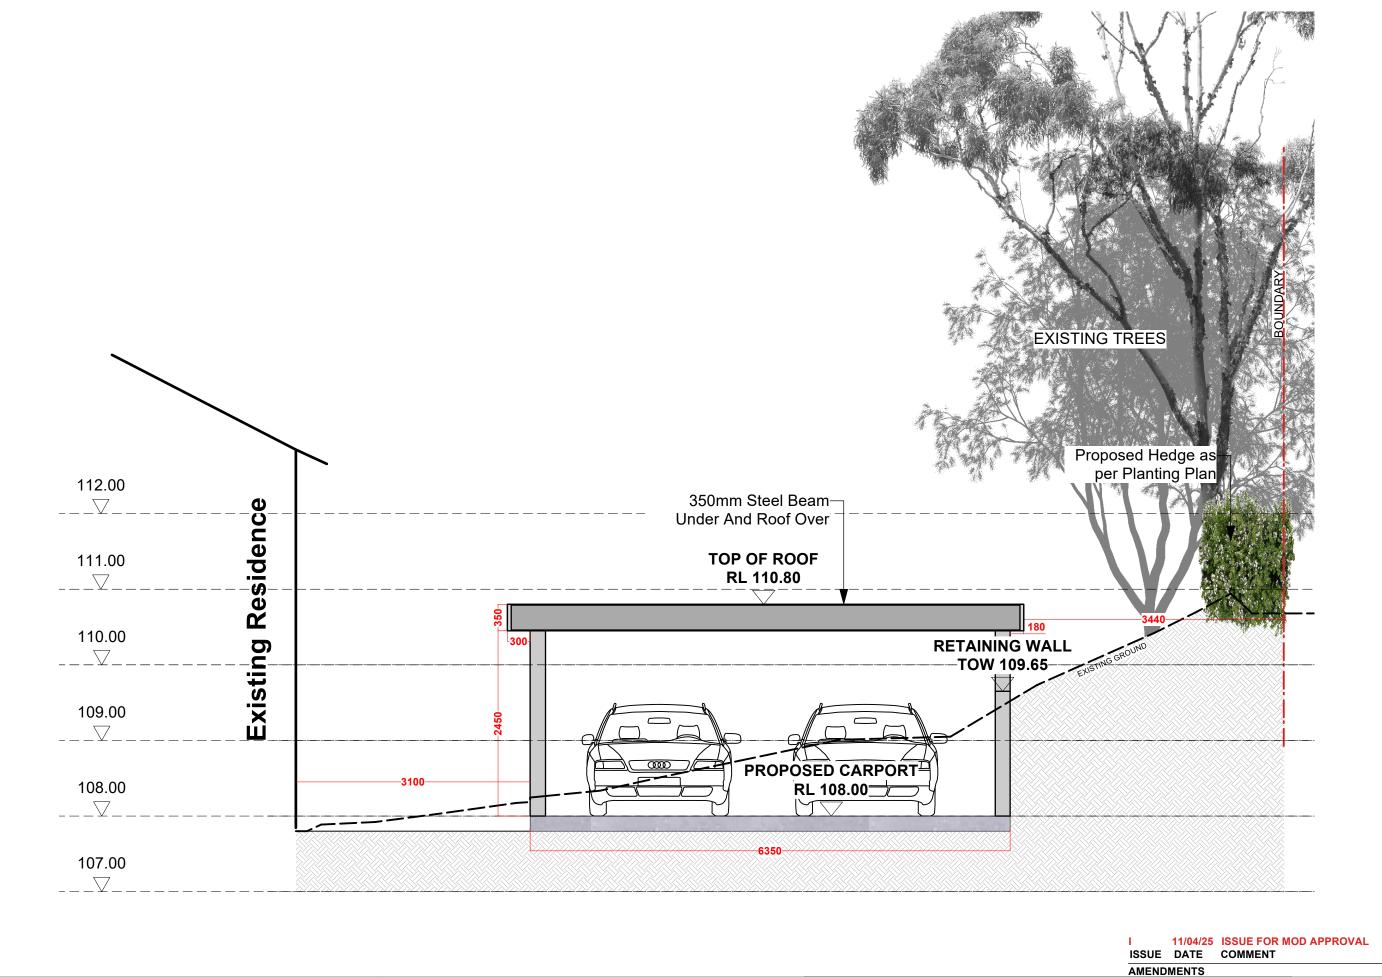


SITEDESIGN +STUDIOS creating places to live in and enjoy

SYDNEY NORTH STUDIO
PO Box 265
SEAFORTH NSW 2092
0417685846
p 1300 22 44 55 info@sdstudios.com.au www.sdstudios.com.au

Barda Residence Project 142 Melwood Avenue Killarney, Heights NSW 2087 Date 11/04/2025 Drawing Title SECTION E (CARPORT) Scale 1:50 @A3 Drawing No.1411

Page L-10

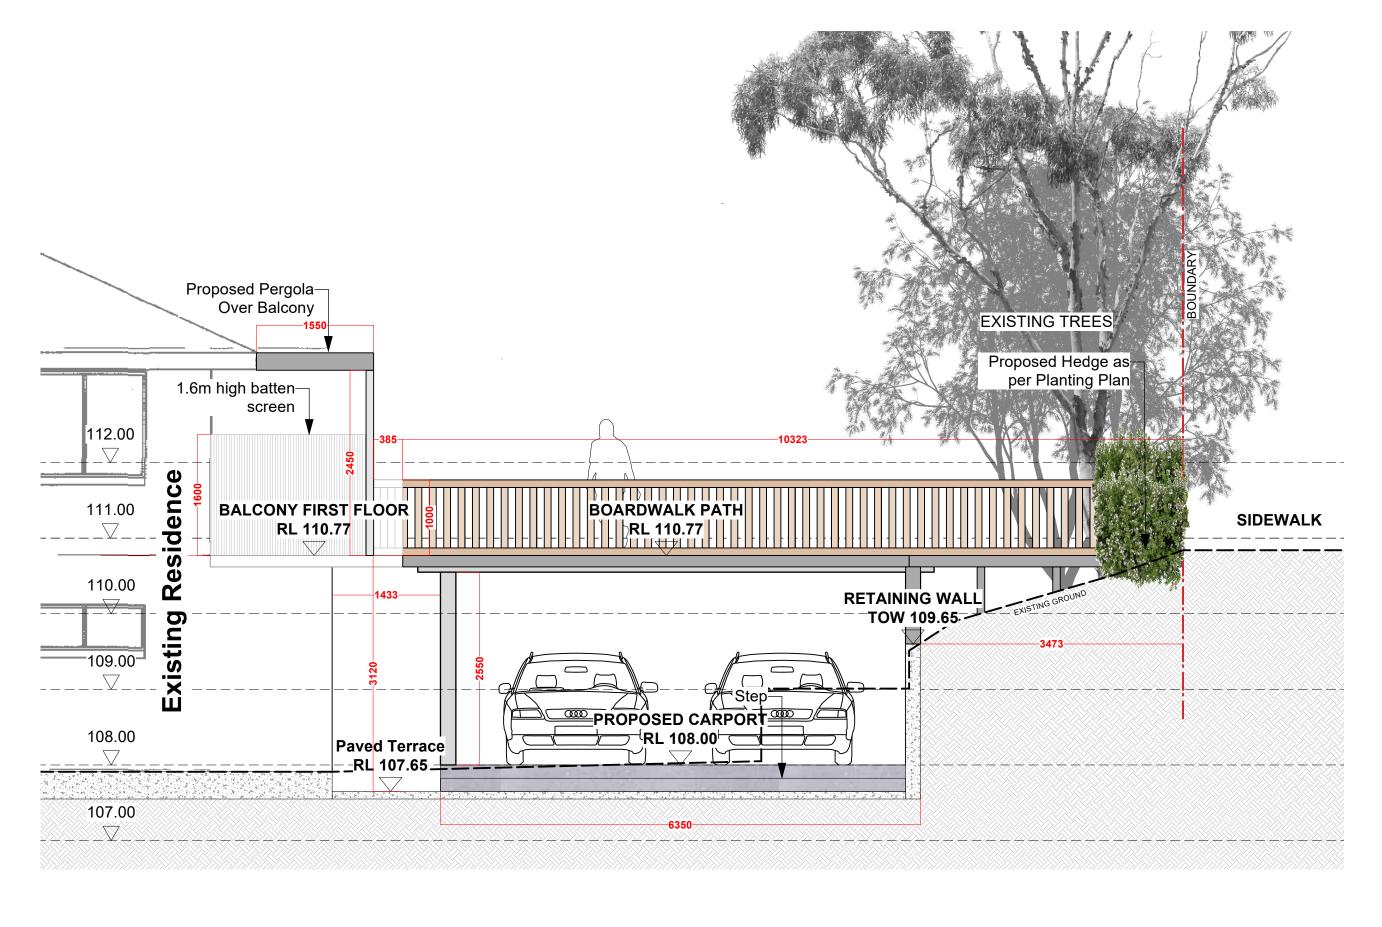

I 11/04/25 ISSUE FOR MOD APPROVAL ISSUE DATE COMMENT

AMENDMENTS

NERAL NOTE

All work to be carried out in accordance with the Building Code of Australia, all Local and State Government Ordinances, relevant Australian Standards, Local Authorities Regulations and all other relevant Authorities concerned.

All structural work and site drainage to be subject to Engineer's details or certification where required by Council. This shall include r.c. slabs and footings, r.c.

is structural work and set ordinated to be supertioned because the contraction where required by council, rins shall include 12, state and toolings, 12, and tele beams & columns, wind bracing to AS 1170 and AS 4055, anchor rods or bolts, tie downs, fixings etc., driveway slabs and drainage to Council's satisfaction. All timbers to be in accordance with SAA Timber tructure Code AS 1720 and SAA Timber Framing Code AS 1684. All work to be carried out in a professional and workman-shiplike manner according to the plan nd specification.

Do not scale off the drawings unless otherwise stated and use figured dimensions in preference.

Il dimensions are to be checked and verified on site before the commencement of any work, all dimensions and levels are subject to final survey and set-out, or esponsibility will be accepted by Sitedesign for any variations in design, builder's method of construction or materials used, deviation from specification wirmlission or accepted work practices resulting in inferior construction. Locate and protect all services prior to construction.


nis drawing and design is the property of Sitedesign and should not be reproduced either in part or whole without the written consent of this firm.

SITEDESIGN +STUDIOS creating places to live in and enjoy SYDNEY NORTH STUDIO
PO Box 265
SEAFORTH NSW 2092
0417685846
p 1300 22 44 55
info@sdstudios.com.au
www.sdstudios.com.au

	Project	Barda Residence		
	Address 142 Melwood Avenue Killarney, Heights NSW 2087		Date 11/04/2025	
Drawing Title ELEVATION F(CARPORT) Scale			Scale 1:50 @A3	

Drawing No.**1411**

Page **L-11**

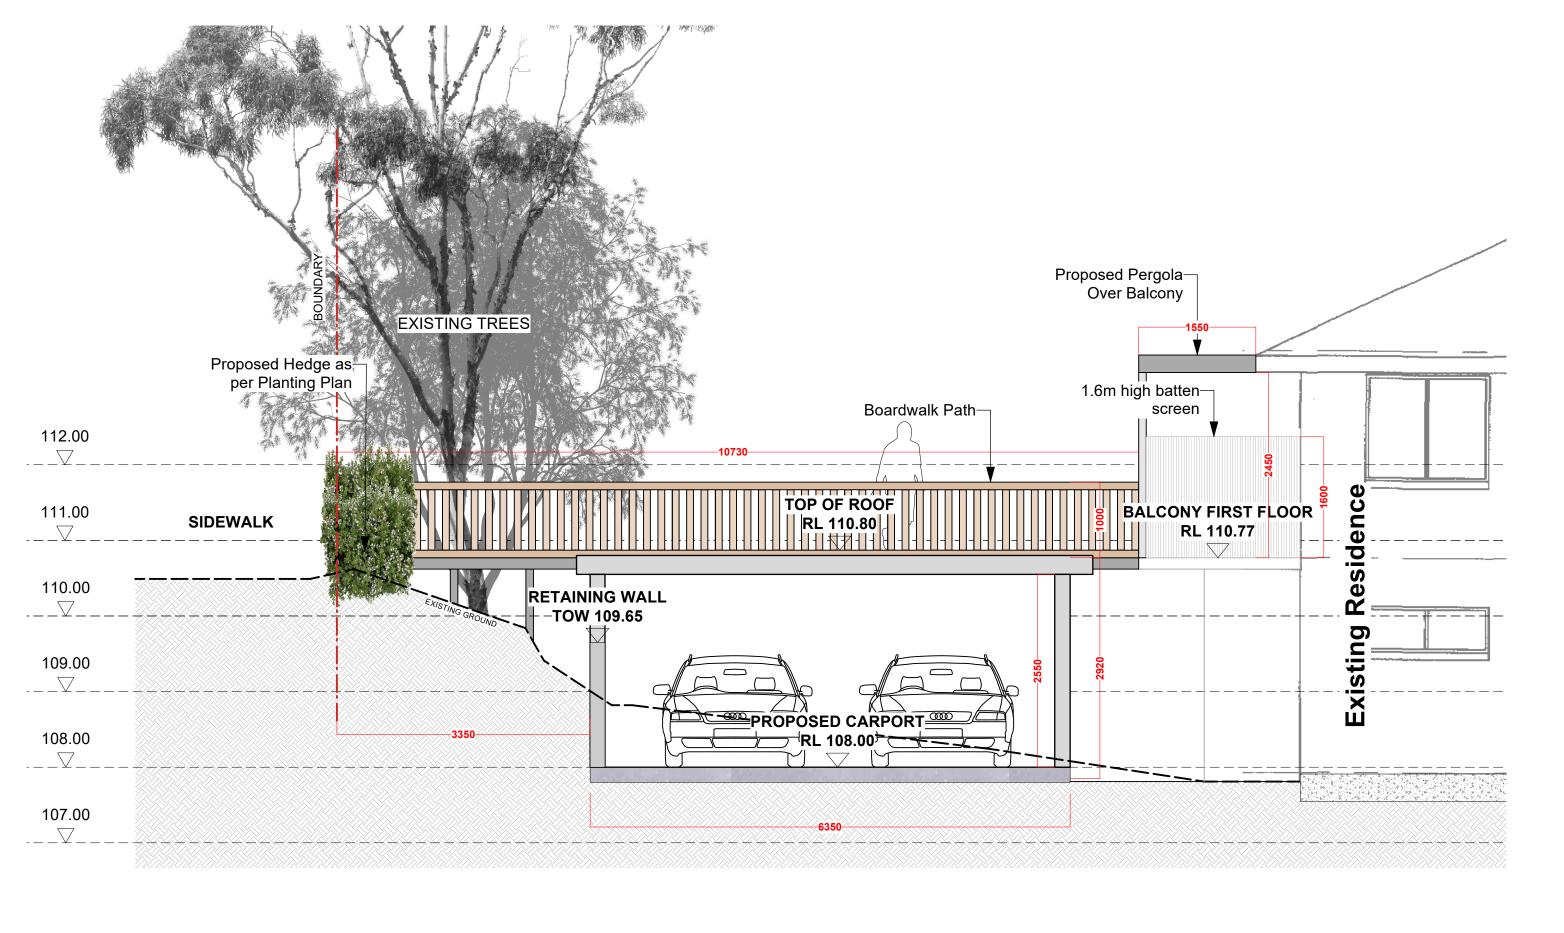


I 11/04/25 ISSUE FOR MOD APPROVAL ISSUE DATE COMMENT

AMENDMENTS

SITEDESIGN +STUDIOS creating places to live in and enjoy

SYDNEY NORTH STUDIO
PO Box 265
SEAFORTH NSW 2092
0417685846
p 1300 22 44 55 info@sdstudios.com.au www.sdstudios.com.au

1	Project	Barda Residence		∣ Page
	Address	142 Melwood Avenue Killarney, Heights NSW 2087	Date 11/04/2025	L-12
	Drawing Ti	tle ELEVATION G (CARPORT)	Scale 1:50 @A3	L- 1 Z
l			Drawing No 1411	1

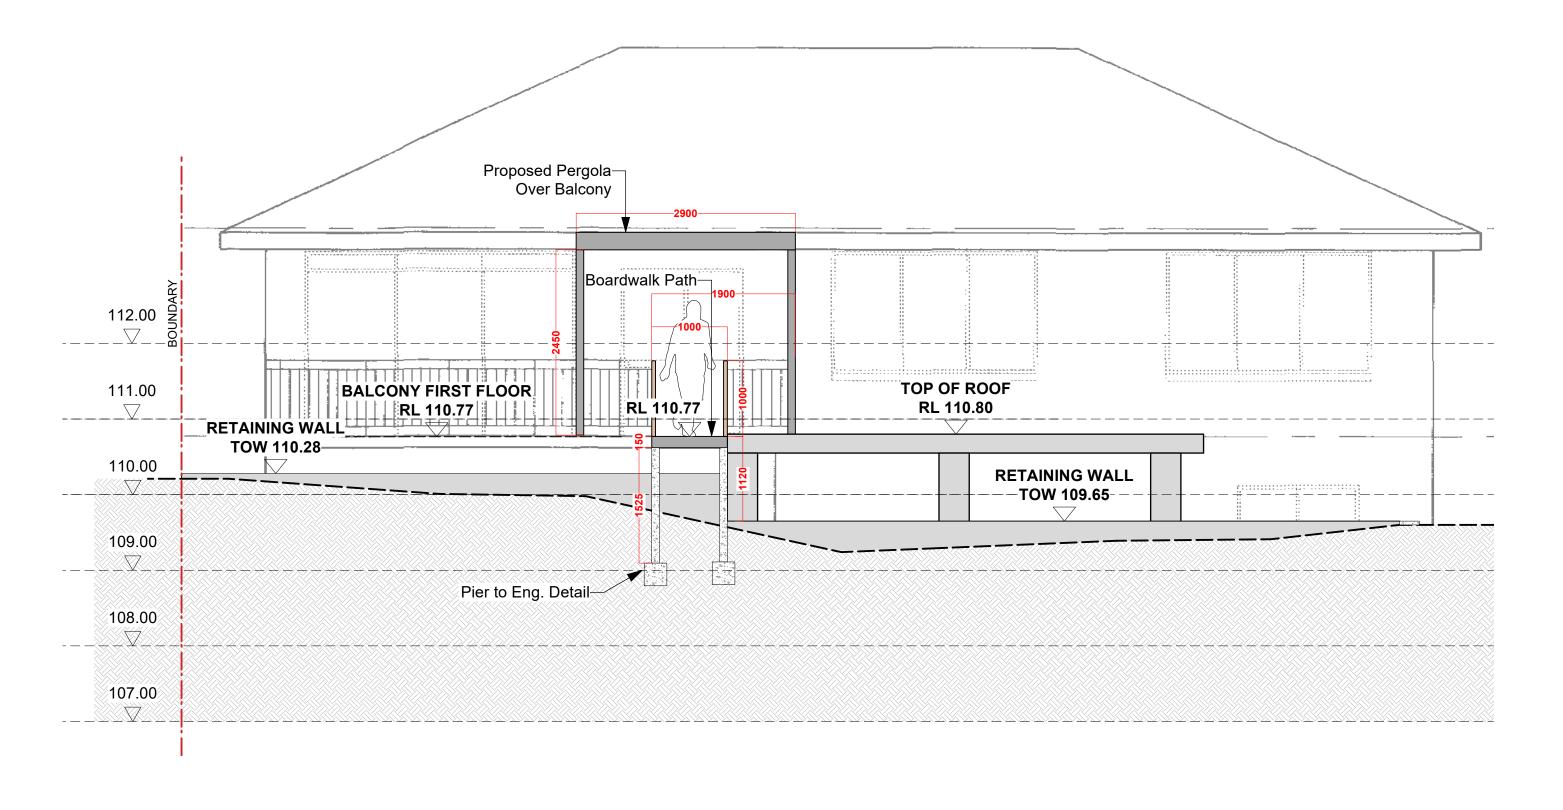

I 11/04/25 ISSUE FOR MOD APPROVAL ISSUE DATE COMMENT

AMENDMENTS

SITEDESIGN +STUDIOS creating places to live in and enjoy

SYDNEY NORTH STUDIO
PO Box 265
SEAFORTH NSW 2092
0417685846
p 1300 22 44 55
info@sdstudios.com.au
www.sdstudios.com.au

ı	Project	Barda Residence	
	Address	142 Melwood Avenue Killarney, Heights NSW 2087	Date 11/04/2025
	Drawing Ti	tle ELEVATION H (CARPORT)	Scale 1:50 @A3
ı			Drawing No. 1411

Page L-13



11/04/25 ISSUE FOR MOD APPROVAL

ISSUE DATE COMMENT

AMENDMENTS

ENERAL NOTE

All work to be carried out in accordance with the Building Code of Australia, all Local and State Government Ordinances, relevant Australian Standards, Local Authorities Regulations and all other relevant Authorities concerned. All structural work and site drainage to be subject to Engineer's details or certification where required by Council. This shall include r.c. slabs and footings, r.c. as

I structural work and site drainage to be subject to Engineer's oteralis or certification where required by Council. This shall include f.c. slabs and tootings, f.c. and eel beams & Coultmans, wind bracing to AS 4105 and SAS 4055, anchor rods or bolts, tie downs, fixings etc., driveway slabs and drainage to Council's satisfaction. All timbers to be in accordance with SAA Timber ructure Code AS 1720 and SAA Timber Framing Code AS 1684. All work to be carried out in a professional and workman-shiplike manner according to the plans dd specification.

Do not scale off the drawings unless otherwise stated and use figured dimensions in preference.

All dimensions are to be checked and verified on site before the commencement of any work, all dimensions and levels are subject to final survey and set-out No responsibility will be accepted by Stedesign for any variations in design, builder's method of construction or materials used, deviation from specification vipermission or accepted work practices resulting in inferior construction. Locate and protect all services prior to construction.

DEFINION CLAUSE

is drawing and design is the property of Sitedesign and should not be reproduced either in part or whole without the written consent of this firm.

SITEDESIGN +STUDIOS creating places to live in and enjoy

SYDNEY NORTH STUDIO
PO Box 265
SEAFORTH NSW 2092
0417685846
p 1300 22 44 55
info@sdstudios.com.au
www.sdstudios.com.au

ı	Project	Barda Residence	
	Address	142 Melwood Avenue Killarney, Heights NSW 2087	Date 11/04/2025
	Drawing Ti	ttle ELEVATION I (STREET ELEVATION)	Scale 1:75 @A3

Drawing No.**1411**

Page **L-14**

LANDSCAPE WORK SPECIFICATION

PREI IMINARIES

1.01 GENERAL

The following general conditions should be considered prior to the commencement of landscape works

The landscape plans should be read in conjunction with the architectural plans, hydraulic plans, service plans and survey prepared for the proposed

All services including existing drainage should be accurately located prior to the commencement of landscape installation. Any proposed tree planting which falls close to services will be relocated on site under the instruction of the landscape architect

Installation of conduit for required irrigation, electrical and other services shall be completed prior to the commencement of hardscape works and

All outdoor lighting specified by architect or client to be installed by qualified electrician

Anomalies that occur in these plans should be brought to our immediate attention.

Where an Australian Standard applies for any landscape material testing or installation technique, that

standard shall be followed.

1.02 PROTECTION OF ADJACENT FINISHES

The Contractor shall take all precautions to prevent damage to all or any adjacent finishes by providing adequate protection to these areas / surfaces prior

1.03 PROTECTION OF EXISTING TREES

Existing trees identified to be retained shall be done so in accordance with NATSPEC Guide 2 "A Guide to Assessing Tree Quality". Where general works are occurring around such trees, or pruning is required, a qualified Arborist shall be engaged to oversee such works and manage tree health

Existing trees designated on the drawing for retention shall be protected at all times during the construction period. Any soil within the drip-line of existing trees shall be excavated and removed by hand only. No stockpiling shall occur within the root zone of existing trees to be retained.

Any roots larger in diameter than 50mm shall only be severed under instruction by a qualified arborist. Roots smaller than 50mm diameter shall be cut cleanly with a saw.

Temporary fencing shall be installed around the base of all trees to be retained prior to the commencement of landscape works. Where possible this fencing will be located around the drip line of these trees, or a minimum of 3m from the trunk. The fencing shall be maintained for the full construction period.

The Contractor shall take all proper precautions to prevent the erosion of soil from the subject site. The contractor shall install erosion & sediment control barriers and as required by council, and maintain these barriers throughout the construction period. Note that the sediment control measures adopted should reflect the soil type and erosion characteristics of the site

Erosion & pollution control measures shall incorporate the following:

- Construction of a sediment trap at the vehicle access point to the subject site
- Sediment fencing using a geotextile filter fabric in the location indicated on the erosion control plan or as instructed on site by the landscape architec
- Earth banks to prevent scour of stockpiles
- Sandbag kerb sediment traps - Straw bale & geotextile sediment filter.
- Exposed banks shall be pegged with an approved Jute matting in preparation for mass planting

Refer to "Sitewise Reference Kit" as prepared by DLWC & WSROC (1997) for construction techniques

SOIL WORKS

2.01 MATERIALS

Specified Soil Conditioner (Generally to improve site soil)

The specified soil conditioner for site top-soil improvement shall be an organic mix, equal to "Botany Humus", as supplied by ANL. Note that for sites where

soil testing indicates toxins or extremes in pH, or soils that are extremely poor, allow to excavate and supply 300mm of imported soil mix

New gardens & proposed Planting

New garden and planting areas shall consist of a 50/50 mix of clean site soil (refer d) below) and imported "Organic Garden Mix" as supplied by ANL or approved equal. All mixes are to comply with AS 4419 Soils for landscaping & garden use, & AS 4454 Composts, Soil conditioners & mulches

Specified Soil Mix - Turf

The specified soil mix for all turf areas shall be a min 75mm layer of imported soil mix consisting of 80% washed river sand (reasonably coarse), and 20% composted organic matter equivalent to mushroom compost or soil conditioner, or other approved lawn top dress,

Site topsoil is to be clean and free of unwanted matter such as gravel, cXXlay lumps, grass, weeds, tree roots, sticks, rubbish and plastics, and any deleterious materials and materials toxic to plants. The topsoil must have a pH of between 5.5 and 7. Use 100% imported soil mix when site when site topsoil runs out.

a) Establishing Subgrade Levels

Subgrade levels are defined as the finished base levels prior to the placement of the specified material (i.e. soil conditioner). The following subgrade levels shall apply

K to be carried out in accordance with the Building Code of Australia, all Local and State Government Ordinances, relevant Australian Standards, Local cities Regulations and all other relevant Authorities concerns cut and accordance with the Standards of the Common Control of the Contr

All structural work and site drainage to be subject to Engineer's details or certification where required by Courncil. This shall includer.c. slabs and footings, r.c. an steel beams & Coulmns, with draining to AS 1170 and AS 4055, and a state of the s

E
of scale off the drawings unless otherwise stated and use figured dimensions in preference.
imensions are to be checked and verified on site before the commencement of any work, all dimensions and levels are subject to final survey and set-out
seponsibility will be accepted by Sitedesign for any variations in design, builder's method of construction or materials used, deviation from specification will
ission or accepted work practices resulting in inferior construction. Locate and protect all services prior to construction.

: In is the property of Sitedesign and should not be reproduced either in part or whole without the written consent of this firn

normies concerned. to Engineer's details or certification where required by Council. This shall include r.c. slabs and footings, r.c. an

Mass Planting Beds - 300mm below existing levels with specified imported soil mix

Turf areas - 100mm below finished surface level

Note that all subgrades shall consist of a relatively free draining natural material, consisting of site topsoil placed previously by the Civil Contractor. No builders waste material shall be acceptable

b) Subgrade Cultivatio

Cultivate all subgrades to a minimum depth of 100mm in all planting beds and all turf areas, ensuring a thorough breakup of the subgrade into a reasonably coarse tilth. Grade subgrades to provide falls to surface and subsurface drains, prior to the placement of the final specified soil mix.

c) Drainage Works

Install surface and subsurface drainage where required and as detailed on the drawing. Drain subsurface drains to outlets provided, with a minimum

d) Placement and Preparation of Specified Soil Conditioner & Mixes.

Trees in turf & beds - Holes shall be twice as wide as root ball and minimum 100mm deeper - backfill hole with 50/50 mix of clean site soil and imported "Organic Garden Mix" as supplied by ANL or approved equal.

Mass Planting Beds - Install specified soil conditioner to a compacted depth of 100mm

Place the specified soil conditioner to the required compacted depth and use a rotary hoe to thoroughly mix the conditioner into the top 300mm of garden bed soil. Ensure thorough mixing and the preparation of a reasonably fine tilth and good growing medium in preparation for planting. Turf Areas - Install specified soil mix to a minimum compacted depth of 75mm

Place the specified soil mix to the required compacted depth and grade to required finished soil levels, in preparation for planting and turfing.

PI ANTING

3.01 MATERIALS

a) Quality and Size of Plant Material

All trees supplied above a 25L container size must be grown and planted in accordance with Clarke, R 1996 Purchasing Landscape Trees: A guide to assessing tree quality. Natspec Guide No. 2. Certification that trees have been grown to Natspec guidelines is to be provided upon request c Council's Tree Management Officer.

Above - Ground Assessment

The following plant quality assessment criteria should be followed:

Plant true to type, Good vigour and health, free from pest & disease, free from injury, self-supporting, good stem taper, has been pruned correctly, is apically dominant, has even crown symmetry, free from included bark & stem junctions, even trunk position in pot, good stem structure

Good root division & direction, rootball occupancy, rootball depth, height of crown, non-suckering For further explanation and description of these sment criteria, refer to Ross Clark's book

All Plant material shall be to the type and size specified. No substitutions of plant material shall be permitted without written prior approval by the Landscape Architect. No plant shall be accepted which does not conform to the standards listed above.

Provide min. 2 No. Stakes and ties to all plants identified as trees in the plant schedule. Stakes shall be sound, unpainted, straight hardwood, free of knots and pointed at one end. They shall be 2200mm x 50mm x 50mm Hardwood, or approved alternative. Ties shall be 50mm wide hessian webbing material

c) Fertilisers

Fertilisers shall be approved slow release fertilisers suitable for the proposed planting types. Note that for native plants. specifically Proteaceae family plants including Grevillea species, low phosphorus fertilizers shall be used.

d) Mulch

Mulch shall be an approved equal to "Forest Blend" as supplied by ANL. Mulch shall be completely free from any soil, weeds rubbish or other debris.

e) Turf

Turf shall be "Sir Walter" Buffalo or equivalent (unless stated otherwise), free from any weeds and other grasses, and be in a healthy growing condition

3.02 INSTALLATION

a) Setting Out

All planting set out shall be in strict accordance with the drawings, or as directed. Note that proposed tree planting located near services should be adjusted at this stage. Notify Landscape Architect for inspection for approval prior to planting.

b) Planting

All plant material shall be planted as soon after delivery as possible. Planting holes for trees shall be excavated as detailed and specified. Plant containers shall be removed and discarded, and the outer roots gently teased from the soil mass Immediately set plant in hole and backfill with specified soil mix, incorporating the approved quantity of fertiliser for each plant type. Ensure that plants are set plumb vertically and root balls set to the consolidated finished grades detailed on the drawings. Compact the backfilled soil and saturate by hand watering to expel any remaining air pockets immediately after planting.

c) Staking and Tying

Staking and tying shall be in strict accordance with the drawings and shall occur immediately following plant placement and soil backfilling. All plants identified as "Trees" on the planting schedule shall be staked with a min. 3 stakes.

d) Mulching

Mulch should be spread so that a compacted thickness of 75mm is achieved after settlement in all planting beds and around each individual plant. Apply immediately following planting and watering in, ensuring that a 50mm radius is maintained around the trunk of each plant. There shall be no mixing of soil and mulch material.

e) Turfing

Moisten soil prior to the turf being laid. Turf shall be neatly butt jointed and true to grade to finish flush with adjacent surfaces. Incorporate a lawn fertilizer and thoroughly water in. Keep turf moist until roots have taken and sods/rolls cannot be lifted. Keep all traffic off turf until this has occurred. Allow for top dressing of all turf areas. All turf shall be rolled immediately following installation

The Contractor shall install stone edging as shown on the drawings, to all mass planting beds adjoining turf or gravel mulched areas, and where required. The resultant edge shall be true to line and flush with adjacent surfaces.

HARDSCAPE WORKS

4.01 GENERAL

The Contractor shall undertake the installation of all hardscape works as detailed on the drawing, or where not detailed, by manufacturers specification

Paving - refer to typical details provided, and applicable Australian Standards. Permeable paving may be used as a suitable means of satisfying Council permeable surface requirements, while providing a useable, hardwearing, practical surface. In most instances, the client shall nominate the appropriate paving material to be

Australian Standards shall be adhered to in relation to all concrete, masonry & metal work. Some details are typical and may vary on site. All hardscape works shall be setout as per the drawings, and inspected and approved by the Landscape Architect prior to installation. All workmanship shall be of the highest standard. Any queries or problems that arise from hardscape variations should be bought to the attention of the Landscape Architect.

Your attention is directed to any obligations or responsibilities under the Dividing Fences Act, 1991 in respect of adjoining property owner/s which may arise from this application. Any enquiries in this regard may be made to the Crown Lands Division on (02) 8836 5332

IRRIGATION WORKS

5.01 GENERAL (PERFORMANCE SPECIFICATION)

An automated drip-irrigation system is to be installed to all gardens, planters and lawn areas in accordance with the approved Irrigation Design

This system shall be designed and installed by a qualified and licensed irrigation specialist, to the highest industry standards and to maximise the efficient usage of

The Installer is required to obtain all approvals necessary for the completion of works in accordance with the Laws of Australia, Laws of the State of NSW. Council By-Laws and Ordinances

Drawings:

- The Landscape Contractor nominated Licensed Irrigation Specialist shall provide irrigation drawings for approval upon engager

Design Requirements

- The irrigation system shall be installed prior to all planting works. It shall incorporate a commercially available irrigation system, with sub-surface dripper lines to irrigate all gardens, planters and lawn areas

It shall incorporate a suitable back flow prevention device for the scale of works, an in-line filter, check valves, and suitable high and low density poly hose fittings and PVC piping to achieve flow rates suitable for specified planting.

- The irrigation application rate shall not exceed the infiltration rate of the soil or creates run-off
- The landscape contractor shall check the existing pressure available from the ring mains and size irrigation piping to suit. Supply shall be from local hose cock where
- All piping and fittings shall be buried 50mm below the finished soil levels in garden and lawn areas, and secured in position at 500mm centres with galy wire pins.
- Size of pipes shall be selected to ensure the working pressure at the end of the line does not decrease by more than 5%.

Services Co-ordination

- Co-ordination required by Landscape Contractor or Project Manager to provide required conduit, pipe work and penetration through slabs and planter walls for water
- The Landscape Contractor shall be engaged with the Irrigation Specialist to co-ordinate with the Project Manager to identify the preferred service and conduit
- Project Manager and Landscape Contractor to establish area suitable for irrigation control system with required area, power provision and water supply.

Upon completion of installation, the system shall be tested, including:

- Main Line Pressure Test: The main line is pressurised to test for leaks. All valves are shut and the pressure is taken over a determined length of time
- Dripper Pressure Test; Measurement at flushing valves are taken and the pressure gauged to make sure it conforms to the manufacturer recommendations. The inlet pressure is then tested under the same conditions to check it does not exceed 300Kpa.
- All components are to be satisfactorily functional and operational prior to approval. Should any defect develop, or the capacity or efficiency of the system decline during the agreed maintenance system, then these faults shall be immediately rectified

Warranty

- A full 12 month warranty shall be included to cover labour and all parts

Further Documentation

- On request, a detailed irrigation performance specification report can be issued

12 MONTH MAINTENANCE

The consolidation and maintenance period shall be 12 months beginning from the approved completion of the specified construction work (Practical Completion). A qualified landscape maintenance contractor shall undertake the required landscape maintenance works. Consolidation and maintenance shall mean the care and naintenance of Contracted works by accepted landscaping or horticultural practices, ensuring that all plants are in optimum growing conditions and appearance at all times, as well as rectifying any defects that become apparent in the contracted works

This shall include, but not be limited to, the following items where and as required: Watering all planting and lawn areas / irrigation maintenance

Clearing litter and other debris from landscaped areas.

Removing weeds, pruning and general plant maintenance

Replacement of damaged, stolen or unhealthy plants. Make good areas of soil subsidence or erosion

Topping up of mulched areas. Spray / treatment for Insect and disease control

142 Melwood Avenue Killarney, Heights NSW 2087

Barda Residence

Fertilizing with approved fertilizers at correct rates

Mowing lawns & trimming edges each 14 days in summer or 18 days in winter Adjusting ties to Stakes

Maintenance of all paying, retaining and hardscape elements.

On the completion of the maintenance period, the landscape works shall be inspected and at the satisfaction of the superintendent or landscape architect, the responsibility will be signed over to the client.xx

11/04/25 ISSUE FOR MOD APPROVAL

ISSUE DATE COMMENT

AMENDMENTS

Page

Date 11/04/2025

Scale N.T.S@A3



Project

POOL COMPLIANCE NOTES

The design of the swimming pool and associated equipment must comply with the following requirements:

i) The Swimming Pools Act & Regulations.

ii) Australian Standard 1926 Swimming Pool Safety as prescribed under the

Building Code of Australia.

iii) The pump and associated equipment must be sound insulated and/or isolated so

that the noise emitted does not exceed an LAeq (15min) of not more than 5 dB(A) above the background level in any octave band from 31.5Hz to 8KHz centre frequencies inclusive at the boundary of the site

The swimming pool excavation and/or swimming pool must be provided with a suitable barrier to prevent a risk of falling into the excavation or pool at all times throughout the construction phase.

- -The measurement of sound must be carried out in accordance with Australian
- -Landscaping and ancillary structures must not intrude into the child-resistant

barrier Non-Climbable Zone.

- -Only structures associated with the pool may be located within the pool area.
- -Clothes lines, barbeque, sheds, entertainment structure, outside toilets or any other non pool-related structures are not permitted within the pool area.

Before the issue of any Occupation Certificate;

- i) The child resistant barrier must be installed in accordance with A above.
- ii) The swimming pool is to be registered in the NSW Swimming Pool Register.

The pump and associated equipment must be maintained and operated in accordance with the noise levels described above.

ii) The child resistant barrier must be maintained in accordance with the Australian Standard as described above

IRRIGATION NOTE

NOTE

ALL GARDENS TO HAVE INSTALLED A DRIP IRRIGATION SYSTEM CONTROLLED FROM WITHIN THE STORE AND RUN OF TANK WATER (POSSIBLE TOWN WATER TOP UP). IRRIGATION SYSTEM CAN BE DESIGNED AND INSTALLED BY SITEDESIGN + IRRIGATION CALL DAVID JAMES +61 488 358 180

EXEMPT TREE REMOVAL

Any declared noxious plant. The applicant is to ensure that all noxious plants are properly identified and controlled/removed. iv) Any tree species exempted by the Sutherland Shire Local Environmental Plan 2015.

PLAN NOTES

This plan should be read in conjunction with the architectural and hydraulics plans. Work specific to these plans should be prepared in accordance to these plans, including specification and details prior to the installation of landscaping, and should not be altered or compromised during landscape construction.

Retaining wall details to engineers design.

Elements such as drainage swales may be incorporated in garden bed areas (using non-floatable mulch) without compromising the capacity or form.

The Design & location of new letter boxes shall be in accordance with Australia Post's "Requirements for Delivery of Mail to Residential Premises" published Feb '97. All noxious weeds listed in Councils weed lists & located on the site shall be continually removed & suppressed. Reinstate all boundary fencing in poor condition with Council approved 1.8m fencing to rear of building line, rake to 1m forward of BL. Pollution, sediment & erosion control devices as specified shall be in place, and maintained for the duration of the construction period. Proposed excavation near existing established trees to be supervised by arborist.

This plan has been prepared for DA approval only, not for construction.

Planting proposed using commercially available plant species selected from local planting lists and the BASIX local plant list

D.A approved landscape plan's are required to be constructed as approved to obtain occupancy certificate.



11/04/25 ISSUE FOR MOD APPROVAL

ISSUE DATE COMMENT

AMENDMENTS

Page

Barda Residence 142 Melwood Avenue Killarney, Heights NSW 2087 Date 11/04/2025

Scale N.T.S@A3

GENERAL NOTES
All work to be carried out in accordance with the Building Code of Australia, all Local and State Government Ordinances, relevant Australian Standards, Local
Authorities Regulations and all other relevant Authorities concorrend.
All structural work and site drainage to be subject to Engineer's details or certification where required by Council. This shall include r.c. slabs and footings, r.c. and
steel beams & columns, wind bracing to AS 1170
and AS4055, anchor rods or botts, tie downs, fixings etc., driveway slabs and drainage to Council's satisfaction. All timbers to be in accordance with SAA Timber
Structure Code AS1720 and SAS 1874 and SAS 1787 and SAS 17

: on is the property of Sitedesian and should not be reproduced either in part or whole without the written consent of this firm

SITEDESIGN creating places to live in and enjoy

SYDNEY NORTH STUDIO PO Box 265 SEAFORTH NSW 2092 0417685846 <u>p</u> 1300 22 44 55 info@sdstudios.com.au Project