



DEMOLITION ALL DEMOLITION WORK IN ACCORDANCE WITH THE NATIONAL CONSTRUCTION CODE OF AUSTRALIA, AUSTRALIAN STANDARDS, STATUTORY REGULATIONS AND LOCAL AUTHORITY REQUIREMENTS. IN ACCORDANCE WITH DEVELOPMENT APPLICATION CONDITIONS ALL HAZARDOUS SUBSTANCES LOCATED ON SITE ARE TO BE IDENTIFIED IN A REPORT PREPARED IN ACCORDANCE WITH AS2601. THIS IS TO BE PREPARED BY A SUITABLY QUALIFIED COMPETENT PERSON AND SUBMITTED TO THE PCA FOR APPROVAL AND SUBMISSION TO COUNCIL CONTRACTOR IS RESPONSIBLE FOR THE ORGANISATION OF AND PROVISION OF TEMPORARY SERVICES TO BE ABLE TO CARRY OUT ANY AND ALL DEMOLITION WORKS AS THESE DOCUMENTS ARE COMPOSITE DRAWINGS TAKEN FROM EXISTING CONDITIONS DRAWINGS, SURVEY & SITE MEASUREMENTS; DRAWINGS ARE INDICATIVE ONLY. CONTRACTOR MUST VERIFY & CHECK ALL SITE CONDITIONS INCLUDING BUT NOT LIMITED TO CEILING HEIGHTS AND DIMENSIONS BEFORE COMMENCING WORK ON SITE OR PREPARING SHOP DRAWINGS. CONTRACTOR TO ADVISE OF ANY INCONSISTENCIES TO DIMENSIONS SHOWN PRIOR TO ANY CONSTRUCTION; FINAL SET OUT TO BE APPROVED BY ALEXANDER &CO. DEMOLITION DRAWINGS TO BE READ IN CONJUNCTION WITH PROPOSED ARCHITECTURAL PACKAGE & SPECIFICATIONS. ALL EXISTING FLOOR FINISHES, SUBSTRATES, MEMBRANES TO BE REMOVED AS DOCUMENTED. MAKE GOOD TO ALL STRUCTURAL ELEMENTS AND ENSURE 26.71 26.69 STRUCTURAL INTEGRITY IS RETAINED. STRUCTURAL ENGINEER TO SIGN OFF AND APPROVE PRIOR TO ANY STRUCTURAL WORKS ALL HYDRAULIC LOCATIONS ARE INDICATIVE ONLY AND TO BE VERIFIED ON SITE; ALL WORKS TO BE MADE GOOD AND REROUTED AS PER PROPOSED DOCUMENTATION ALL EXISTING FIXTURES AND JOINERY TO BE REMOVED UNLESS OTHERWISE DOCUMENTED

DP 1183845 15.83 1, 2 & 3 STOREY RENDERED RESIDENCE DP 8075 (TILE & METAL ROOF) No.40 NEW RENDERED RETAINING WALL EXISTING PORTION FENCE TO BE DEMOLISHED 13.64 EXISTING POOL FENCE TO BE RETAINED ALL ELECTRICAL FITTINGS AND FIXTURES TO BE REMOVED INTERNALLY AND EXTERNALLY. CONTRACTOR TO ALLOW FOR ⁺ 25.98 EXISTING TREE TO BE REMOVED DOTTED IN RED NEW WIRING THROUGHOUT. REFER TO ARBORIST'S REPORT CONTRACTOR TO ALLOW SUFFICIENT WEATHER PROTECTION EXISTING PLANTER TO BE EXISTING ROOFING, EAVES, SOFFIT, EXISTING PORTION OF LANDSCAPING TO BE EXCAVATED 6/.3/1 & SITE PROTECTION TO MAINTAIN THE REMAINING PARTS OF EXISTING FINISH TO BE —DEMOLISHED FASCIAS AND GUTTERS AND ROOF EXISTING PLANTS TO BE REMOVED AND REPLANTED THE DWELLING DURING EACH STAGE OF DEMOLITION AND DEMOLISHED 24.62 STRUCTURE TO BE DEMOLISHED 24.11 STRUCTURE TO BE CONSTRUCTION. 15.82 EXISTING PORTION OF FENCE TO BE DEMOLISHED RETAINED EXISTING RETAINING WALL TO BE RETAINED RETAIN EXISTING HYDRAULIC CONNECTIONS AS DOCUMENTED EXISTING RENDERED SOLID EXISTING PORTION OF FENCE TO BE RETAINED. STRUCTURE TO BE DEMOLISHED REMOVE ALL EXISTING DOOR FRAMES TO ALL DOORS AS INDICATED DOORS WITH A DOOR NUMBER TO BE REMOVED BUT 25.60 RETAINED IN PREPARATION FOR RELOCATION ON SITE. 25.55 ALL SKIRTING AND ARCHITRAVES TO BE REMOVED. PATCH EXISTING PORTION OF RETAINING WALL TO EXISTING TIMBER FENCE TO BE DEMOLISHED AND REPAIR WALL AS NECESSARY FOR NEW FINISH. BE DEMOLISHED EXISTING PLANTER TO BE DEMOLISHED-ALL EXISTING REDUNDANT RETICULATION TO BE REMOVED. NEW METAL FLUE TO NEW SOLID EXISTING TIMBER GATE TO BE DEMOLISHED-DEMOLISHED AND REPLACED EXISTING PLANTER TO BE DEMOLISHED— FUEL - WOOD BURNING FIREPLACE 2533 25.63 EXISTING FINISH TO BE DEMOLISHED EXISTING PLANTER TO BE DEMOLISHED STRUCTURE TO BE RETAINED EXISTING PORTION OF RETAINING WALL TO EXISTING RENDERED SOLID 27.62 BE DEMOLISHED STRUCTURE TO BE DEMOLISHED 27.37 * 27.53 EXISTING PORTION OF RETAINING WALLS TO BE DEMOLISHED & REPLACED EXISTING RETAINING WALL TO BE DEMOLISHED— 26.00 25.91 6/.35/12 _EXISTING TIMBER FENCE TO BE DEMOLISHED 3/.25/5 EXISTING RENDERED SOLID RL = 27.49 A.H.D. STRUCTURE TO BE DEMOLISHED EXISTING TIMBER GATE TO BE DEMOLISHED-12,898 **VEHICLE** CROSSING EXISTING DRIVEWAY TO BE DEMOLISHED-EXISTING ROOF STRUCTURE TO BE DEMOLISHED 27.53 EXISTING GLASS BALUSTRADE TO BE DEMOLISHED 27.40 —EXISTING PLANTER TO BE DEMOLISHED EXISTING FLOOR FINISH BE DEMOLISHED, EXISTING GARAGE STRUCTURE AND ROOF STRUCTURE TO BE RETAINED FASCIAS AND GUTTERS TO BE ROOF TO BE DEMOLISHED 27.40 * 27.54 EXISTING PLANTER TO BE DEMOLISHED 5.32 DEMOLISHED EXISTING STEPS TO BE DEMOLISHED-ROOF STRUCTURE TO BE RETAINED EXISTING STEPS TO BE DEMOLISHED EXISTING RETAINING WALL TO BE DEMOLISHED~ 2/.2/4 25.98 5/.25/4 23.96 23.86 26.97 +23.85_ 24.61 1, 2 & 3 STOREY RENDERED RESIDENCE (METAL ROOF) DP 807 23.96 THIS PLAN IS TO BE READ IN CONJUNCTION WITH THE CONDITIONS OF DEVELOPMENT 4.94 4.78 CONSENT MOD2024/0441

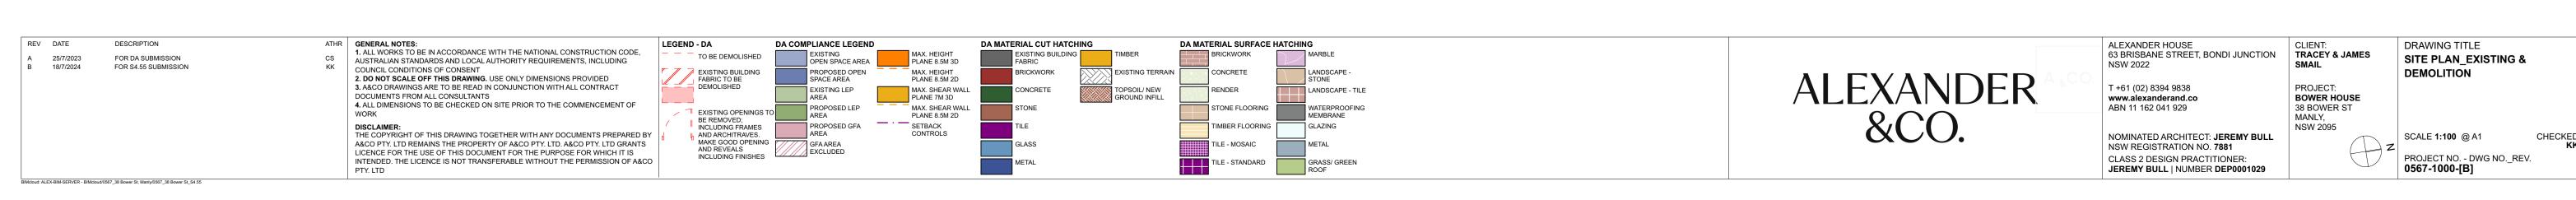


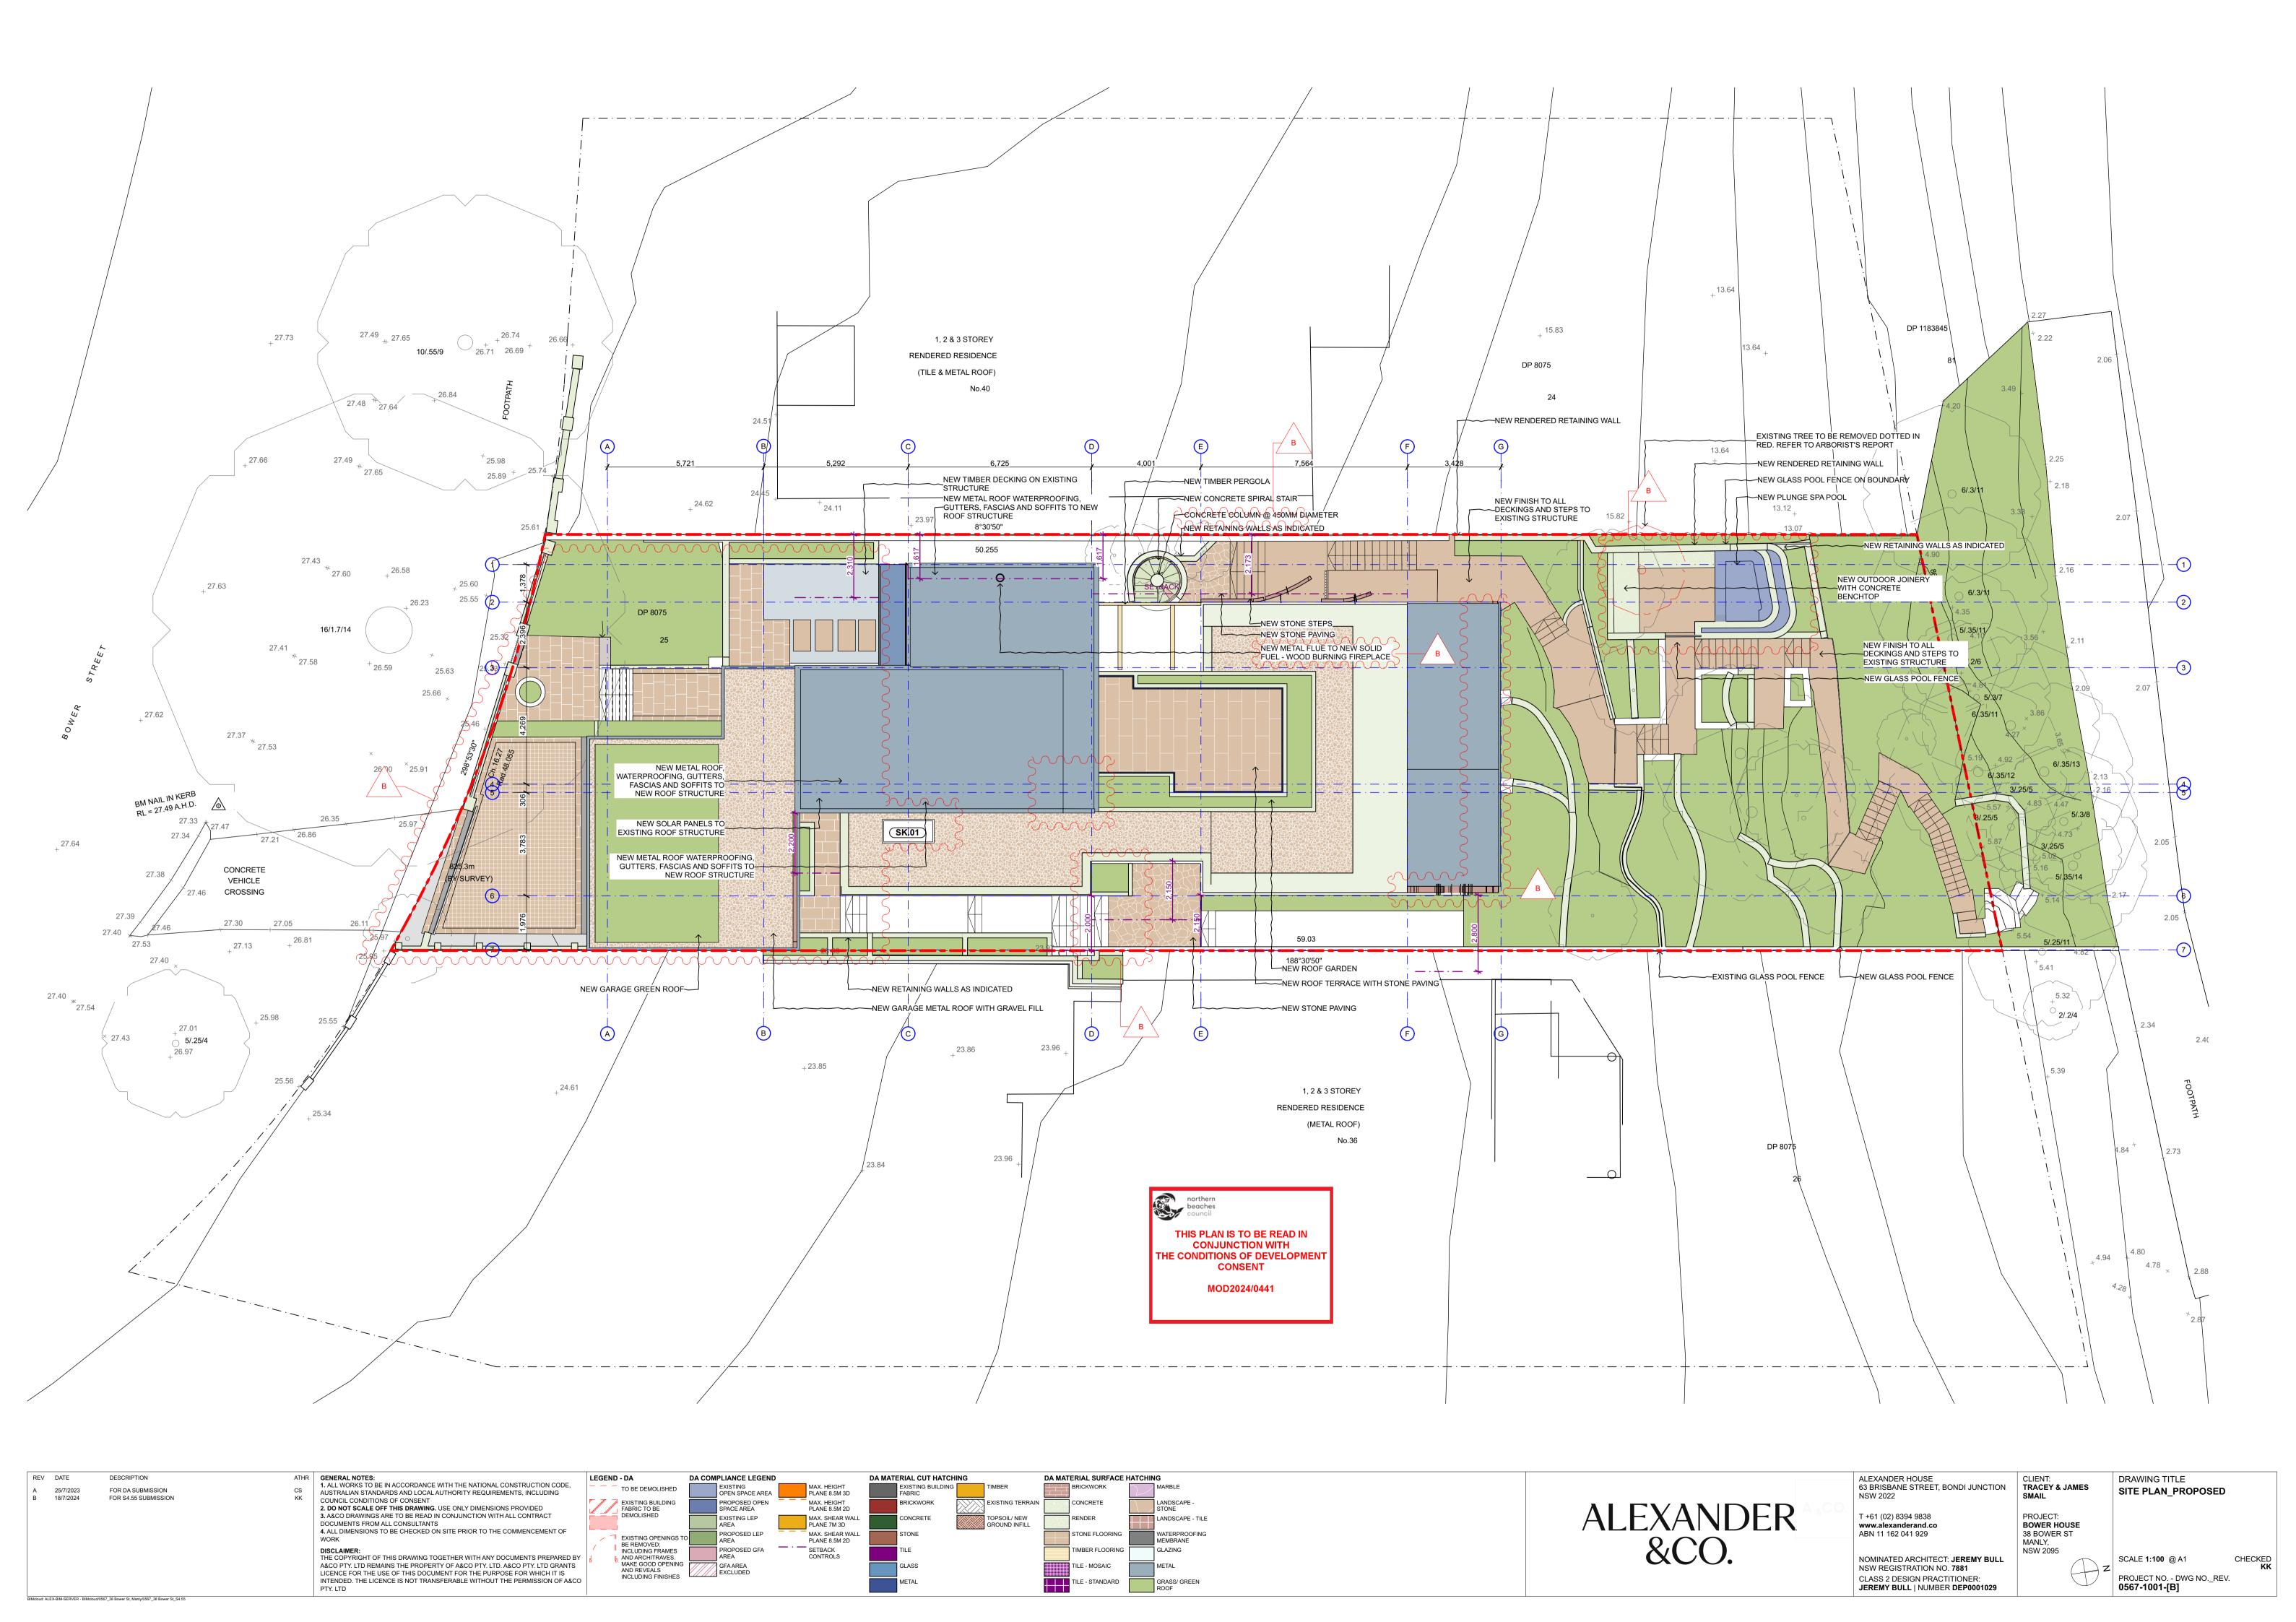

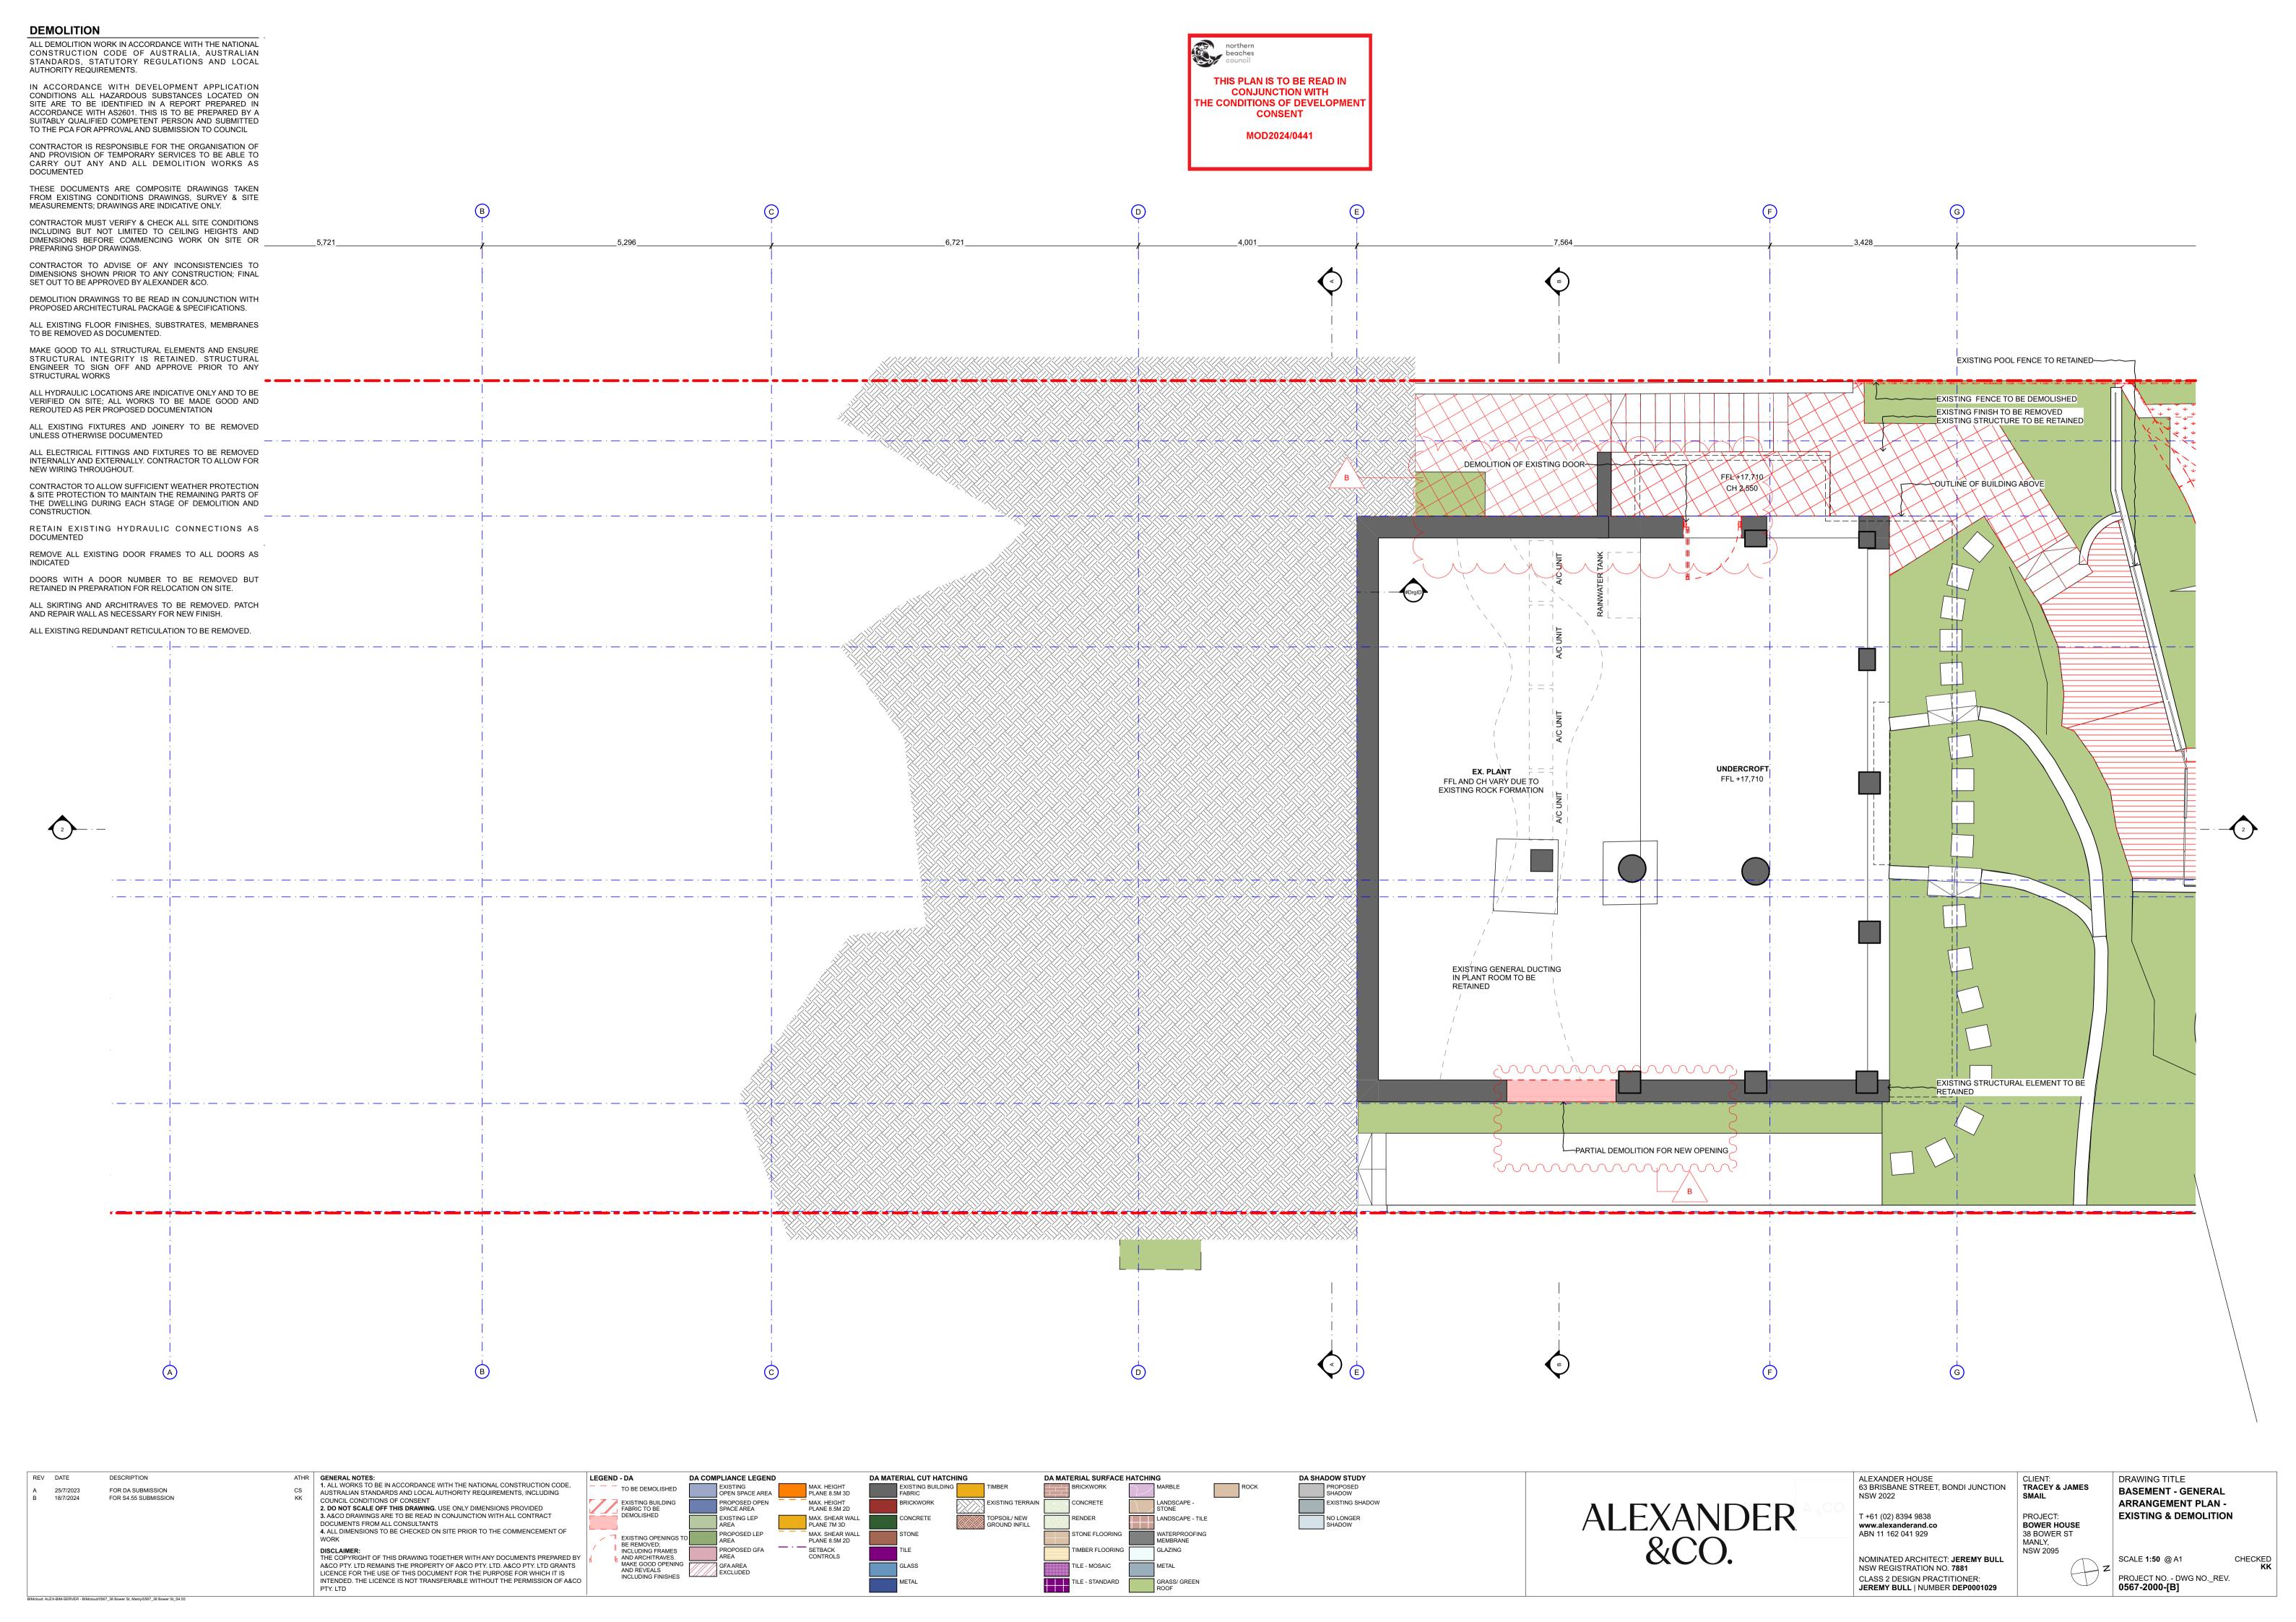

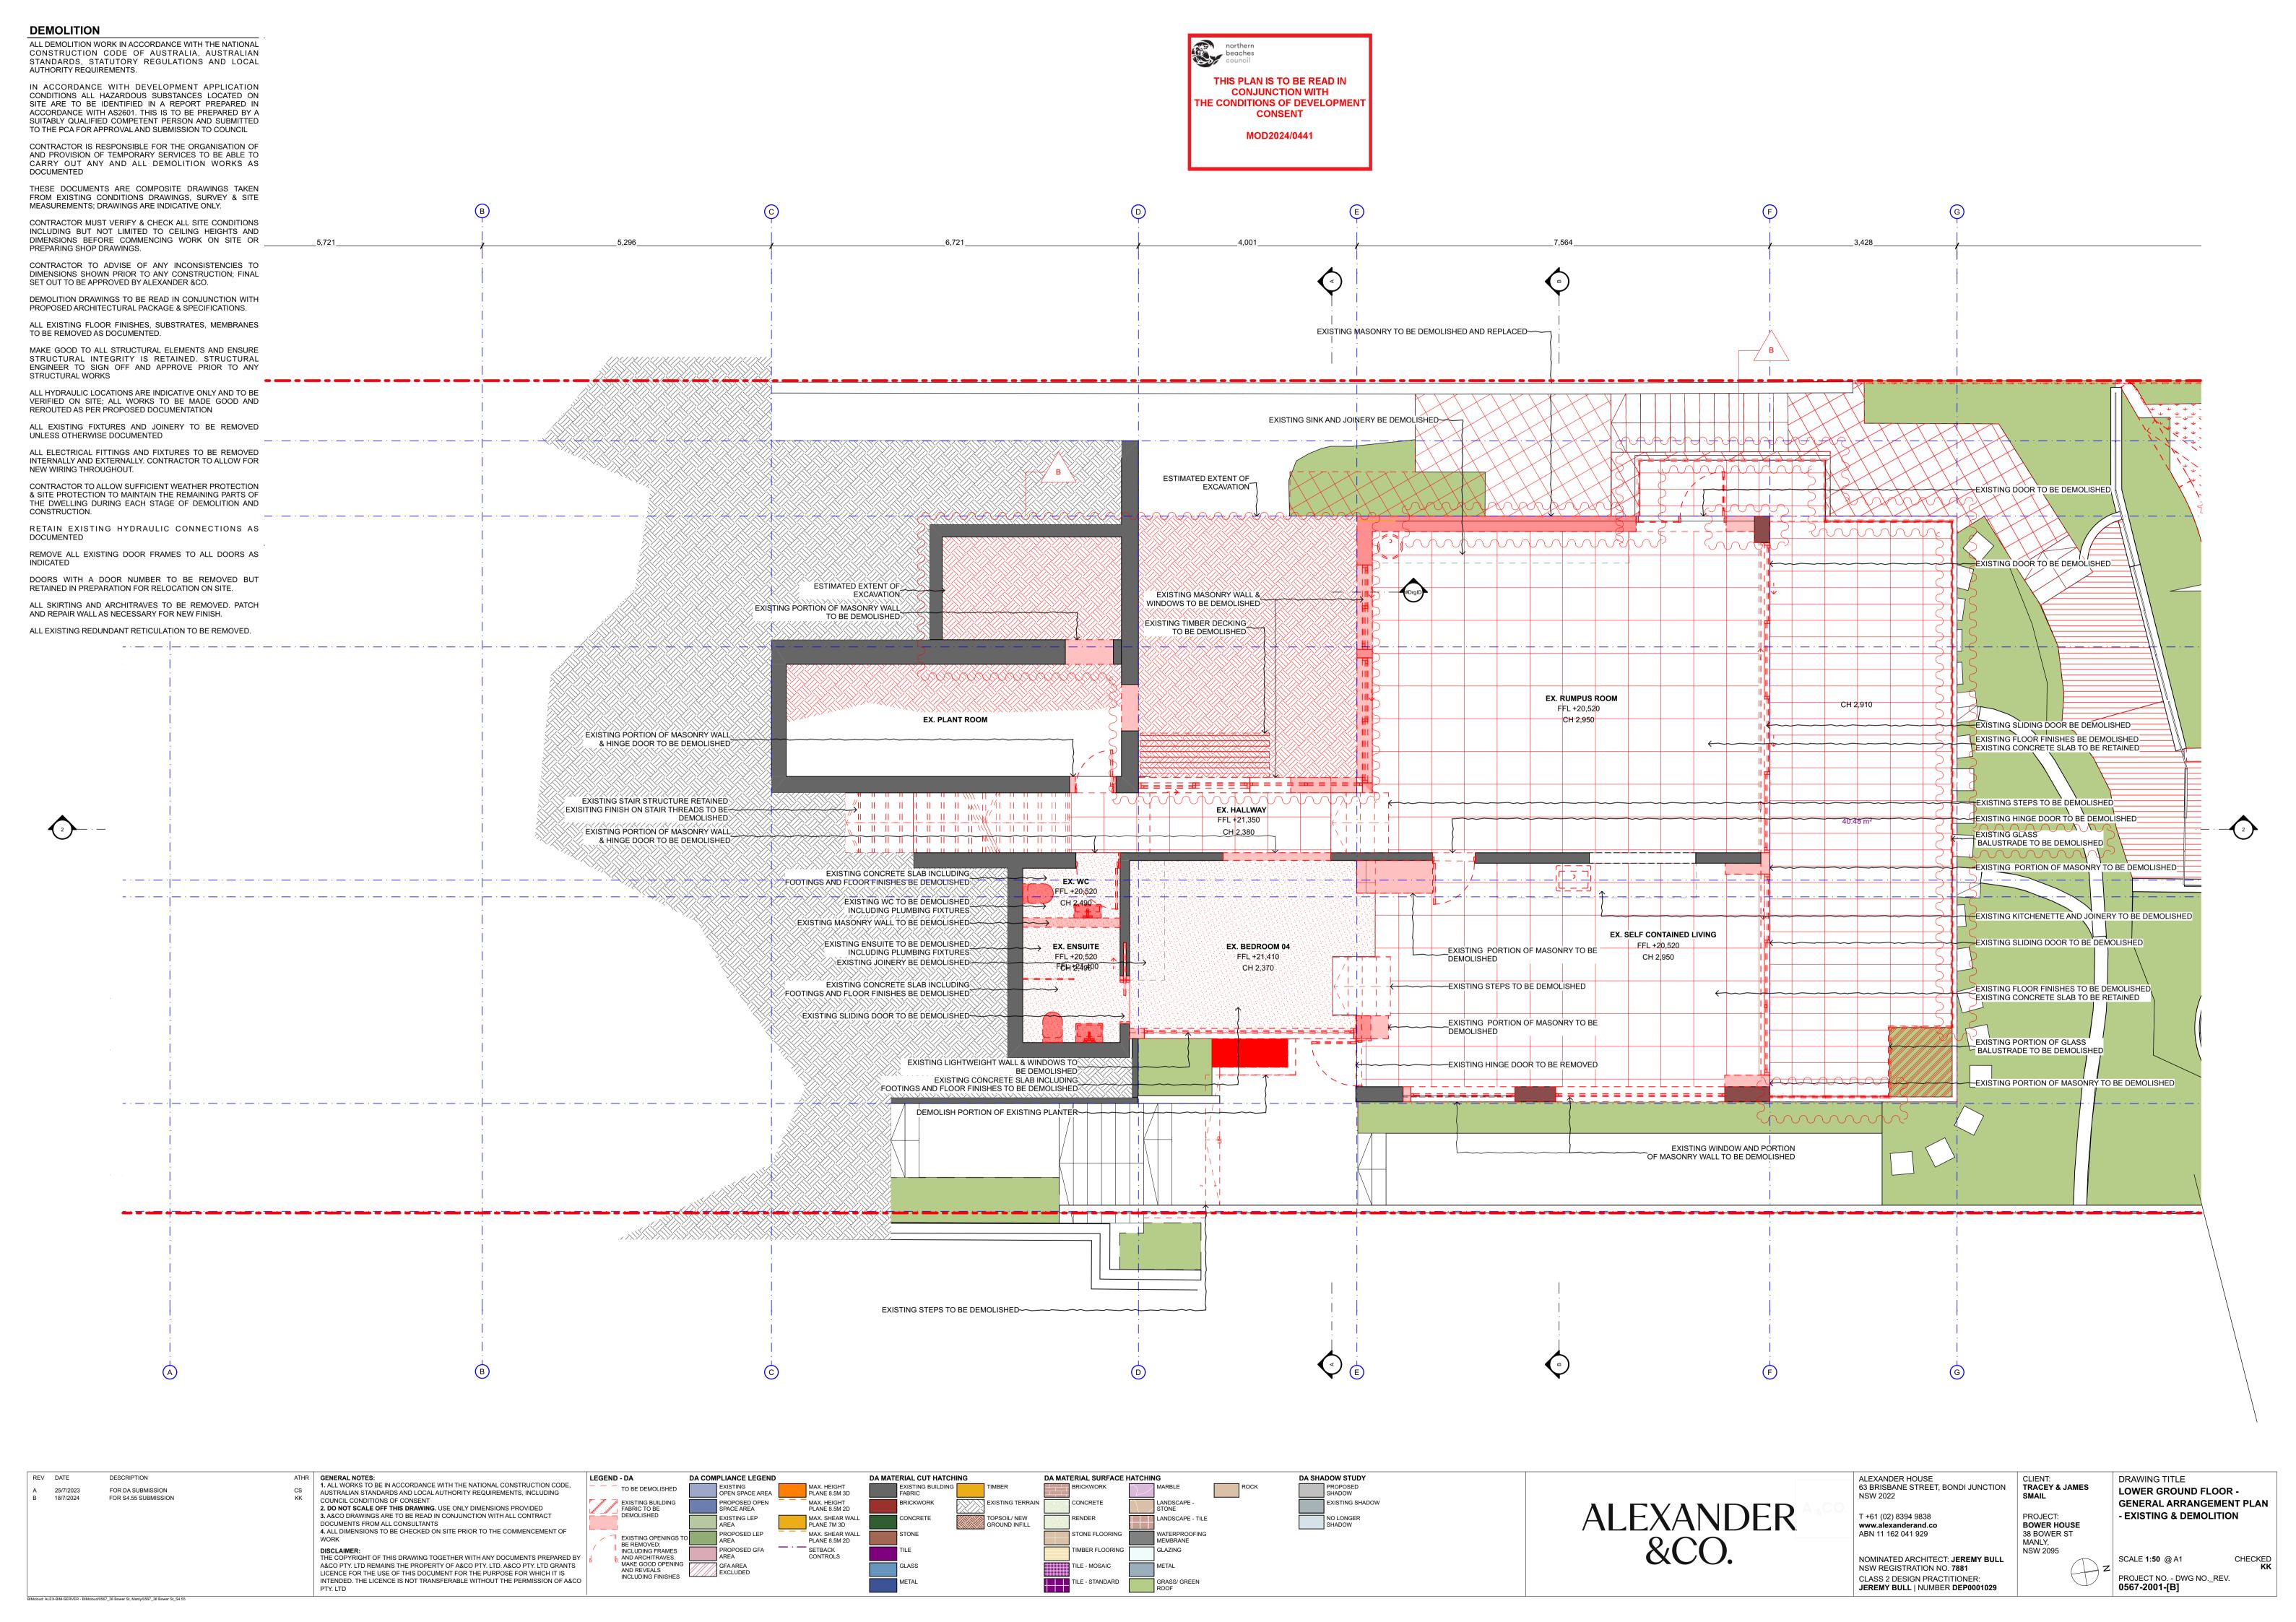


DEMOLITION ALL DEMOLITION WORK IN ACCORDANCE WITH THE NATIONAL CONSTRUCTION CODE OF AUSTRALIA, AUSTRALIAN STANDARDS, STATUTORY REGULATIONS AND LOCAL AUTHORITY REQUIREMENTS. THIS PLAN IS TO BE READ IN IN ACCORDANCE WITH DEVELOPMENT APPLICATION CONJUNCTION WITH CONDITIONS ALL HAZARDOUS SUBSTANCES LOCATED ON THE CONDITIONS OF DEVELOPMENT SITE ARE TO BE IDENTIFIED IN A REPORT PREPARED IN ACCORDANCE WITH AS2601. THIS IS TO BE PREPARED BY A CONSENT SUITABLY QUALIFIED COMPETENT PERSON AND SUBMITTED TO THE PCA FOR APPROVAL AND SUBMISSION TO COUNCIL MOD2024/0441 CONTRACTOR IS RESPONSIBLE FOR THE ORGANISATION OF AND PROVISION OF TEMPORARY SERVICES TO BE ABLE TO CARRY OUT ANY AND ALL DEMOLITION WORKS AS THESE DOCUMENTS ARE COMPOSITE DRAWINGS TAKEN FROM EXISTING CONDITIONS DRAWINGS, SURVEY & SITE MEASUREMENTS; DRAWINGS ARE INDICATIVE ONLY. CONTRACTOR MUST VERIFY & CHECK ALL SITE CONDITIONS INCLUDING BUT NOT LIMITED TO CEILING HEIGHTS AND DIMENSIONS BEFORE COMMENCING WORK ON SITE OR PREPARING SHOP DRAWINGS. CONTRACTOR TO ADVISE OF ANY INCONSISTENCIES TO DIMENSIONS SHOWN PRIOR TO ANY CONSTRUCTION; FINAL SET OUT TO BE APPROVED BY ALEXANDER &CO. —EXISTING WINDOW TO BE DEMOLISHE DEMOLITION DRAWINGS TO BE READ IN CONJUNCTION WITH PROPOSED ARCHITECTURAL PACKAGE & SPECIFICATIONS. ALL EXISTING FLOOR FINISHES, SUBSTRATES, MEMBRANES TO BE REMOVED AS DOCUMENTED. EXISTING SLIDING DOOR TO BE DEMOLISHED MAKE GOOD TO ALL STRUCTURAL ELEMENTS AND ENSURE EXISTING WINDOW TO BE DEMOLISHED STRUCTURAL INTEGRITY IS RETAINED. STRUCTURAL ↓EXISTING MASONRY TO BE DEMOLISHED ENGINEER TO SIGN OFF AND APPROVE PRIOR TO ANY STRUCTURAL WORKS ALL HYDRAULIC LOCATIONS ARE INDICATIVE ONLY AND TO BE VERIFIED ON SITE; ALL WORKS TO BE MADE GOOD AND REROUTED AS PER PROPOSED DOCUMENTATION ALL EXISTING FIXTURES AND JOINERY TO BE REMOVED UNLESS OTHERWISE DOCUMENTED ALL ELECTRICAL FITTINGS AND FIXTURES TO BE REMOVED INTERNALLY AND EXTERNALLY. CONTRACTOR TO ALLOW FOR NEW WIRING THROUGHOUT. EXISTING JOINERY TO BE DEMOLISHED BALCONY CONTRACTOR TO ALLOW SUFFICIENT WEATHER PROTECTION BELOW & SITE PROTECTION TO MAINTAIN THE REMAINING PARTS OF THE DWELLING DURING EACH STAGE OF DEMOLITION AND CONSTRUCTION. XISTING WINDOW TO BE RETAIN EXISTING HYDRAULIC CONNECTIONS AS DEMOLISHED EX. FAMILY DOCUMENTED FFL +24,140 EXISTING GLASS ROOF OVERHEAD TO BE DEMOLISHED REMOVE ALL EXISTING DOOR FRAMES TO ALL DOORS AS **CH VARIES** INDICATED EXISTING GATE LANDING TO BE DEMOLISHED FFL)+24,100 DOORS WITH A DOOR NUMBER TO BE REMOVED BUT RETAINED IN PREPARATION FOR RELOCATION ON SITE. EXISTING WINDOW TO BE EXISTING FLOOR FINISHES TO BE DEMOLISH DEMOLISHED ALL SKIRTING AND ARCHITRAVES TO BE REMOVED. PATCH = = ‡ = = ‡ = = |= = |= = AND REPAIR WALL AS NECESSARY FOR NEW FINISH. PATH AND STEPS TO BE EXISTING FLOOR FINISHES TO BE DEMOLISHED ALL EXISTING REDUNDANT RETICULATION TO BE REMOVED. DEMOLISHED EXISTING PORTION OF MASONRY WALL TO BE DEMOLISHED EX. TERRACE EXISTING SLIDING DOOR TO BE DEMOLISHED-FFL +24,100 GLASS BALUSTRADE TO BE DEMOLISHED CH 2,900 EX. HALLWAY EXISTING ENTRY DOOR TO BE DEMOLISHED FFL +24,140 FFL +23,730 INCLUDING SIDE WINDOWS CH 3,255 EXISTING SLIDING DOOR TO BE DEMOLISHED CH 2,915 EXISTING HINGE DOOR TO BE DEMOLISHED-EXISTING SKYLIGHTS INCLUDING STRUCTURE TO BE DEMOLISHED EXISTING PORTION OF MASONRY TO BE DEMOLISHED : = ± = = ± = = |= = |= EXISTING HINGE DOOR TO BE DEMOLISHED—— EXISTING STEPS TO BE DEMOLISHED EX. POWDER ROOM EXISTING PORTION OF MASONRY WALL TO + $^{\prime\prime}$ $^{\prime\prime}$ EX. KITCHEN TRE DEMOLISHED FFL +24,140 FFL +24,140 EXISTING SLIDING DOOR TO BE DEMOLISHED. CH 3,255 CH 2,390 EXISTING PORTION OF MASONRY TO BE DEMOLISHED— _____ EXISTING PORTION OF MASONRY TO BE DEMOLISHED EXISTING NIB WALL TO BE DEMOLISHED _ _ _ _ EXISTING_WINDOW TO BE DEMOLISHED EXISTING HINGE DOOR TO BE DEMOLISHED EX. MASTER WIR EXISTING MASTER WIR TO BE EXISTING HINGE DOOR TO BE DEMOLISHED FFL +23,730 DEMOLISHED INCLUDING JOINERY CH 2,915 EXISTING JOINERY TO BE DEMOLISHED EX. MASTER BEDROOM NCLUDING PLUMBING FIXTURES EX. PANTRY FFL +23,730 EXISTING SLIDING DOOR TO BE DEMOLISHED EXISTING STEPS TO BE DEMOLISHED FFL +24,140 EXISTING PORTION OF MASONRY WALL TO EX. BEDROOM 02 CH 2,390 BE DEMOLISHED FFL +2<mark>4,140</mark> EX. BEDROOM 03 EXISTING FLOOR FINISHES TO BE DEMOLISHED EX. MASTER ENSUITE CH 2,590 FFL +24,140 FFL +23,730 EXISTING JOINERY TO BE DEMOLISHED EXISTING WINDOW BE DEMOLISHED CH 2,915 EXISTING MASONRY WALL TO BE DEMOLISHED EX. GARAGE EXISTING MASTER ENSUITE TO BE DEMOLISHED FFL +24,844 INCLUDING PLUMBING FIXTURES EXISTING WINDOW BE DEMOLISHED CH 2,215 EXISTING WINDOW TO BE DEMOLISHED GLASS BALUSTRADE BE DEMOLISHED EXISTING WINDOW BE DEMOLISHED EXISTING WINDOW TO BE DEMOLISHED——— EXISTING PORTION OF MASONRY TO BE DEMOLISHED-EXISTING JOINERY TO BE DEMOLISHED-EXISTING PORTION OF MASONRY TO BE DEMOLISHED-**EXISTING LIGHTWEIGHT WALL & WINDOWS TO** BE DEMOLISHED EXISTING RETAINING WALL TO BE DEMOLISHED—— DA COMPLIANCE LEGEND DA MATERIAL CUT HATCHING DA MATERIAL SURFACE HATCHING **DA SHADOW STUDY** DESCRIPTION LEGEND - DA DRAWING TITLE 1. ALL WORKS TO BE IN ACCORDANCE WITH THE NATIONAL CONSTRUCTION CODE, 63 BRISBANE STREET, BONDI JUNCTION TRACEY & JAMES TO BE DEMOLISHED **GROUND FLOOR - GENERAL** FOR DA SUBMISSION PLANE 8.5M 3D AUSTRALIAN STANDARDS AND LOCAL AUTHORITY REQUIREMENTS, INCLUDING OPEN SPACE AREA NSW 2022 18/7/2024 FOR \$4.55 SUBMISSION COUNCIL CONDITIONS OF CONSENT MAX. HEIGHT PLANE 8.5M 2D EXISTING SHADOW ALEXANDER &CO. ARRANGEMENT PLAN -2. DO NOT SCALE OFF THIS DRAWING. USE ONLY DIMENSIONS PROVIDED SPACE AREA **EXISTING & DEMOLITION** 3. A&CO DRAWINGS ARE TO BE READ IN CONJUNCTION WITH ALL CONTRACT DEMOLISHED T +61 (02) 8394 9838 PROJECT: MAX. SHEAR WALL PLANE 7M 3D CONCRETE EXISTING LEP LANDSCAPE - TILE www.alexanderand.co ABN 11 162 041 929 DOCUMENTS FROM ALL CONSULTANTS **BOWER HOUSE** 4. ALL DIMENSIONS TO BE CHECKED ON SITE PRIOR TO THE COMMENCEMENT OF MAX. SHEAR WALL PLANE 8.5M 2D 38 BOWER ST EXISTING OPENINGS T BE REMOVED; INCLUDING FRAMES AND ARCHITRAVES. **DISCLAIMER:**THE COPYRIGHT OF THIS DRAWING TOGETHER WITH ANY DOCUMENTS PREPARED BY SETBACK GLAZING NSW 2095 NOMINATED ARCHITECT: **JEREMY BULL** SCALE 1:50 @ A1 A&CO PTY. LTD REMAINS THE PROPERTY OF A&CO PTY. LTD. A&CO PTY. LTD GRANTS MAKE GOOD OPENING AND REVEALS NSW REGISTRATION NO. 7881 LICENCE FOR THE USE OF THIS DOCUMENT FOR THE PURPOSE FOR WHICH IT IS PROJECT NO. - DWG NO._REV. 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DEMOLITION ALL DEMOLITION WORK IN ACCORDANCE WITH THE NATIONAL CONSTRUCTION CODE OF AUSTRALIA. AUSTRALIAN STANDARDS, STATUTORY REGULATIONS AND LOCAL AUTHORITY REQUIREMENTS. THIS PLAN IS TO BE READ IN **CONJUNCTION WITH** IN ACCORDANCE WITH DEVELOPMENT APPLICATION THE CONDITIONS OF DEVELOPMENT CONDITIONS ALL HAZARDOUS SUBSTANCES LOCATED ON CONSENT SITE ARE TO BE IDENTIFIED IN A REPORT PREPARED IN ACCORDANCE WITH AS2601. THIS IS TO BE PREPARED BY A SUITABLY QUALIFIED COMPETENT PERSON AND SUBMITTED MOD2024/0441 TO THE PCA FOR APPROVAL AND SUBMISSION TO COUNCIL CONTRACTOR IS RESPONSIBLE FOR THE ORGANISATION OF AND PROVISION OF TEMPORARY SERVICES TO BE ABLE TO CARRY OUT ANY AND ALL DEMOLITION WORKS AS DOCUMENTED THESE DOCUMENTS ARE COMPOSITE DRAWINGS TAKEN FROM EXISTING CONDITIONS DRAWINGS, SURVEY & SITE MEASUREMENTS; DRAWINGS ARE INDICATIVE ONLY. G CONTRACTOR MUST VERIFY & CHECK ALL SITE CONDITIONS INCLUDING BUT NOT LIMITED TO CEILING HEIGHTS AND DIMENSIONS BEFORE COMMENCING WORK ON SITE OR PREPARING SHOP DRAWINGS. CONTRACTOR TO ADVISE OF ANY INCONSISTENCIES TO DIMENSIONS SHOWN PRIOR TO ANY CONSTRUCTION; FINAL SET OUT TO BE APPROVED BY ALEXANDER &CO. EXISTING PLANTER TO BE DEMOLITION DRAWINGS TO BE READ IN CONJUNCTION WITH DEMOLISHED EXISTING ROOFING, EAVES, SOFFIT, PROPOSED ARCHITECTURAL PACKAGE & SPECIFICATIONS. -FASCIAS AND GUTTERS AND ROOF EXISTING FINISH TO BE STRUCTURE TO BE DEMOLISHED DEMOLISHED ALL EXISTING FLOOR FINISHES, SUBSTRATES, MEMBRANES STRUCTURE TO BE TO BE REMOVED AS DOCUMENTED. RETAINED MAKE GOOD TO ALL STRUCTURAL ELEMENTS AND ENSURE —EXISTING RETAINING WALL TO BE RETAINED STRUCTURAL INTEGRITY IS RETAINED. STRUCTURAL ENGINEER TO SIGN OFF AND APPROVE PRIOR TO ANY STRUCTURAL WORKS ALL HYDRAULIC LOCATIONS ARE INDICATIVE ONLY AND TO BE VERIFIED ON SITE; ALL WORKS TO BE MADE GOOD AND REROUTED AS PER PROPOSED DOCUMENTATION ALL EXISTING FIXTURES AND JOINERY TO BE REMOVED ______ UNLESS OTHERWISE DOCUMENTED ALL ELECTRICAL FITTINGS AND FIXTURES TO BE REMOVED INTERNALLY AND EXTERNALLY. CONTRACTOR TO ALLOW FOR NEW WIRING THROUGHOUT. CONTRACTOR TO ALLOW SUFFICIENT WEATHER PROTECTION & SITE PROTECTION TO MAINTAIN THE REMAINING PARTS OF THE DWELLING DURING EACH STAGE OF DEMOLITION AND CONSTRUCTION. RETAIN EXISTING HYDRAULIC CONNECTIONS AS DOCUMENTED ידום מוחודודום מוחודודום!! REMOVE ALL EXISTING DOOR FRAMES TO ALL DOORS AS INDICATED DOORS WITH A DOOR NUMBER TO BE REMOVED BUT RETAINED IN PREPARATION FOR RELOCATION ON SITE. (|----|----|----|----|---|----|----| ALL SKIRTING AND ARCHITRAVES TO BE REMOVED. PATCH AND REPAIR WALL AS NECESSARY FOR NEW FINISH. ALL EXISTING REDUNDANT RETICULATION TO BE REMOVED. ---------______ 0 0 (Հայ հայ հայ հայ արագրագրության արգագրությանը հայ հայ հայ հայիսակությանը արագրագրությանը հայ հայ արագրությանը (Maria da 1906) | 1906 | 1906 | 1906 | 1906 | 1906 | 1906 | 1906 | 1906 | 1906 | 1906 | 1906 | 1906 | 1906 | 1 (Maria da 1906) | 1906 | 1906 | 1906 | 1906 | 1906 | 1906 | 1906 | 1906 | 1906 | 1906 | 1906 | 1906 | 1906 | 1 -----1||----| - - -|- -,--| EXISTING ROOF STRUCTURE TO BE DEMOLISHED EXISTING GLASS BALUSTRADE TO BE DEMOLISHED EXISTING PLANTER TO BE DEMOLISHED EXISTING FLOOR FINISH BE DEMOLISHED ROOF STRUCTURE TO BE RETAINED EXISTING ROOFING, EAVES, SOFFIT, FASCIAS AND GUTTERS TO BE EXISTING PLANTER TO BE DEMOLISHED DEMOLISHED ROOF STRUCTURE TO BE RETAINED EXISTING STEPS TO BE DEMOLISHED DA COMPLIANCE LEGEND DA MATERIAL CUT HATCHING DA MATERIAL SURFACE HATCHING DA SHADOW STUDY DESCRIPTION LEGEND - DA ALEXANDER HOUSE DRAWING TITLE 1. ALL WORKS TO BE IN ACCORDANCE WITH THE NATIONAL CONSTRUCTION CODE, KISTING BUILDING 63 BRISBANE STREET, BONDI JUNCTION TRACEY & JAMES TO BE DEMOLISHED **ROOF - GENERAL** FOR DA SUBMISSION PLANE 8.5M 3D AUSTRALIAN STANDARDS AND LOCAL AUTHORITY REQUIREMENTS, INCLUDING OPEN SPACE AREA NSW 2022 18/7/2024 FOR \$4.55 SUBMISSION COUNCIL CONDITIONS OF CONSENT MAX. HEIGHT PLANE 8.5M 2D **ARRANGEMENT PLAN -**ALEXANDER &CO. 2. DO NOT SCALE OFF THIS DRAWING. USE ONLY DIMENSIONS PROVIDED SPACE AREA **EXISTING & DEMOLITION** T +61 (02) 8394 9838 3. A&CO DRAWINGS ARE TO BE READ IN CONJUNCTION WITH ALL CONTRACT DEMOLISHED PROJECT: MAX. SHEAR WALL PLANE 7M 3D CONCRETE EXISTING LEP LANDSCAPE - TILE www.alexanderand.co ABN 11 162 041 929 DOCUMENTS FROM ALL CONSULTANTS **BOWER HOUSE** 4. ALL DIMENSIONS TO BE CHECKED ON SITE PRIOR TO THE COMMENCEMENT OF MAX. SHEAR WALL PLANE 8.5M 2D 38 BOWER ST MANLY, BE REMOVED; INCLUDING FRAMES AND ARCHITRAVES. **DISCLAIMER:**THE COPYRIGHT OF THIS DRAWING TOGETHER WITH ANY DOCUMENTS PREPARED BY SETBACK CONTROLS NSW 2095 NOMINATED ARCHITECT: **JEREMY BULL** SCALE 1:50 @ A1 A&CO PTY. LTD REMAINS THE PROPERTY OF A&CO PTY. LTD. A&CO PTY. LTD GRANTS MAKE GOOD OPENING AND REVEALS NSW REGISTRATION NO. 7881 LICENCE FOR THE USE OF THIS DOCUMENT FOR THE PURPOSE FOR WHICH IT IS PROJECT NO. - DWG NO._REV. CLASS 2 DESIGN PRACTITIONER: INTENDED. THE LICENCE IS NOT TRANSFERABLE WITHOUT THE PERMISSION OF A&CO 0567-2004-[B] JEREMY BULL | NUMBER DEP0001029
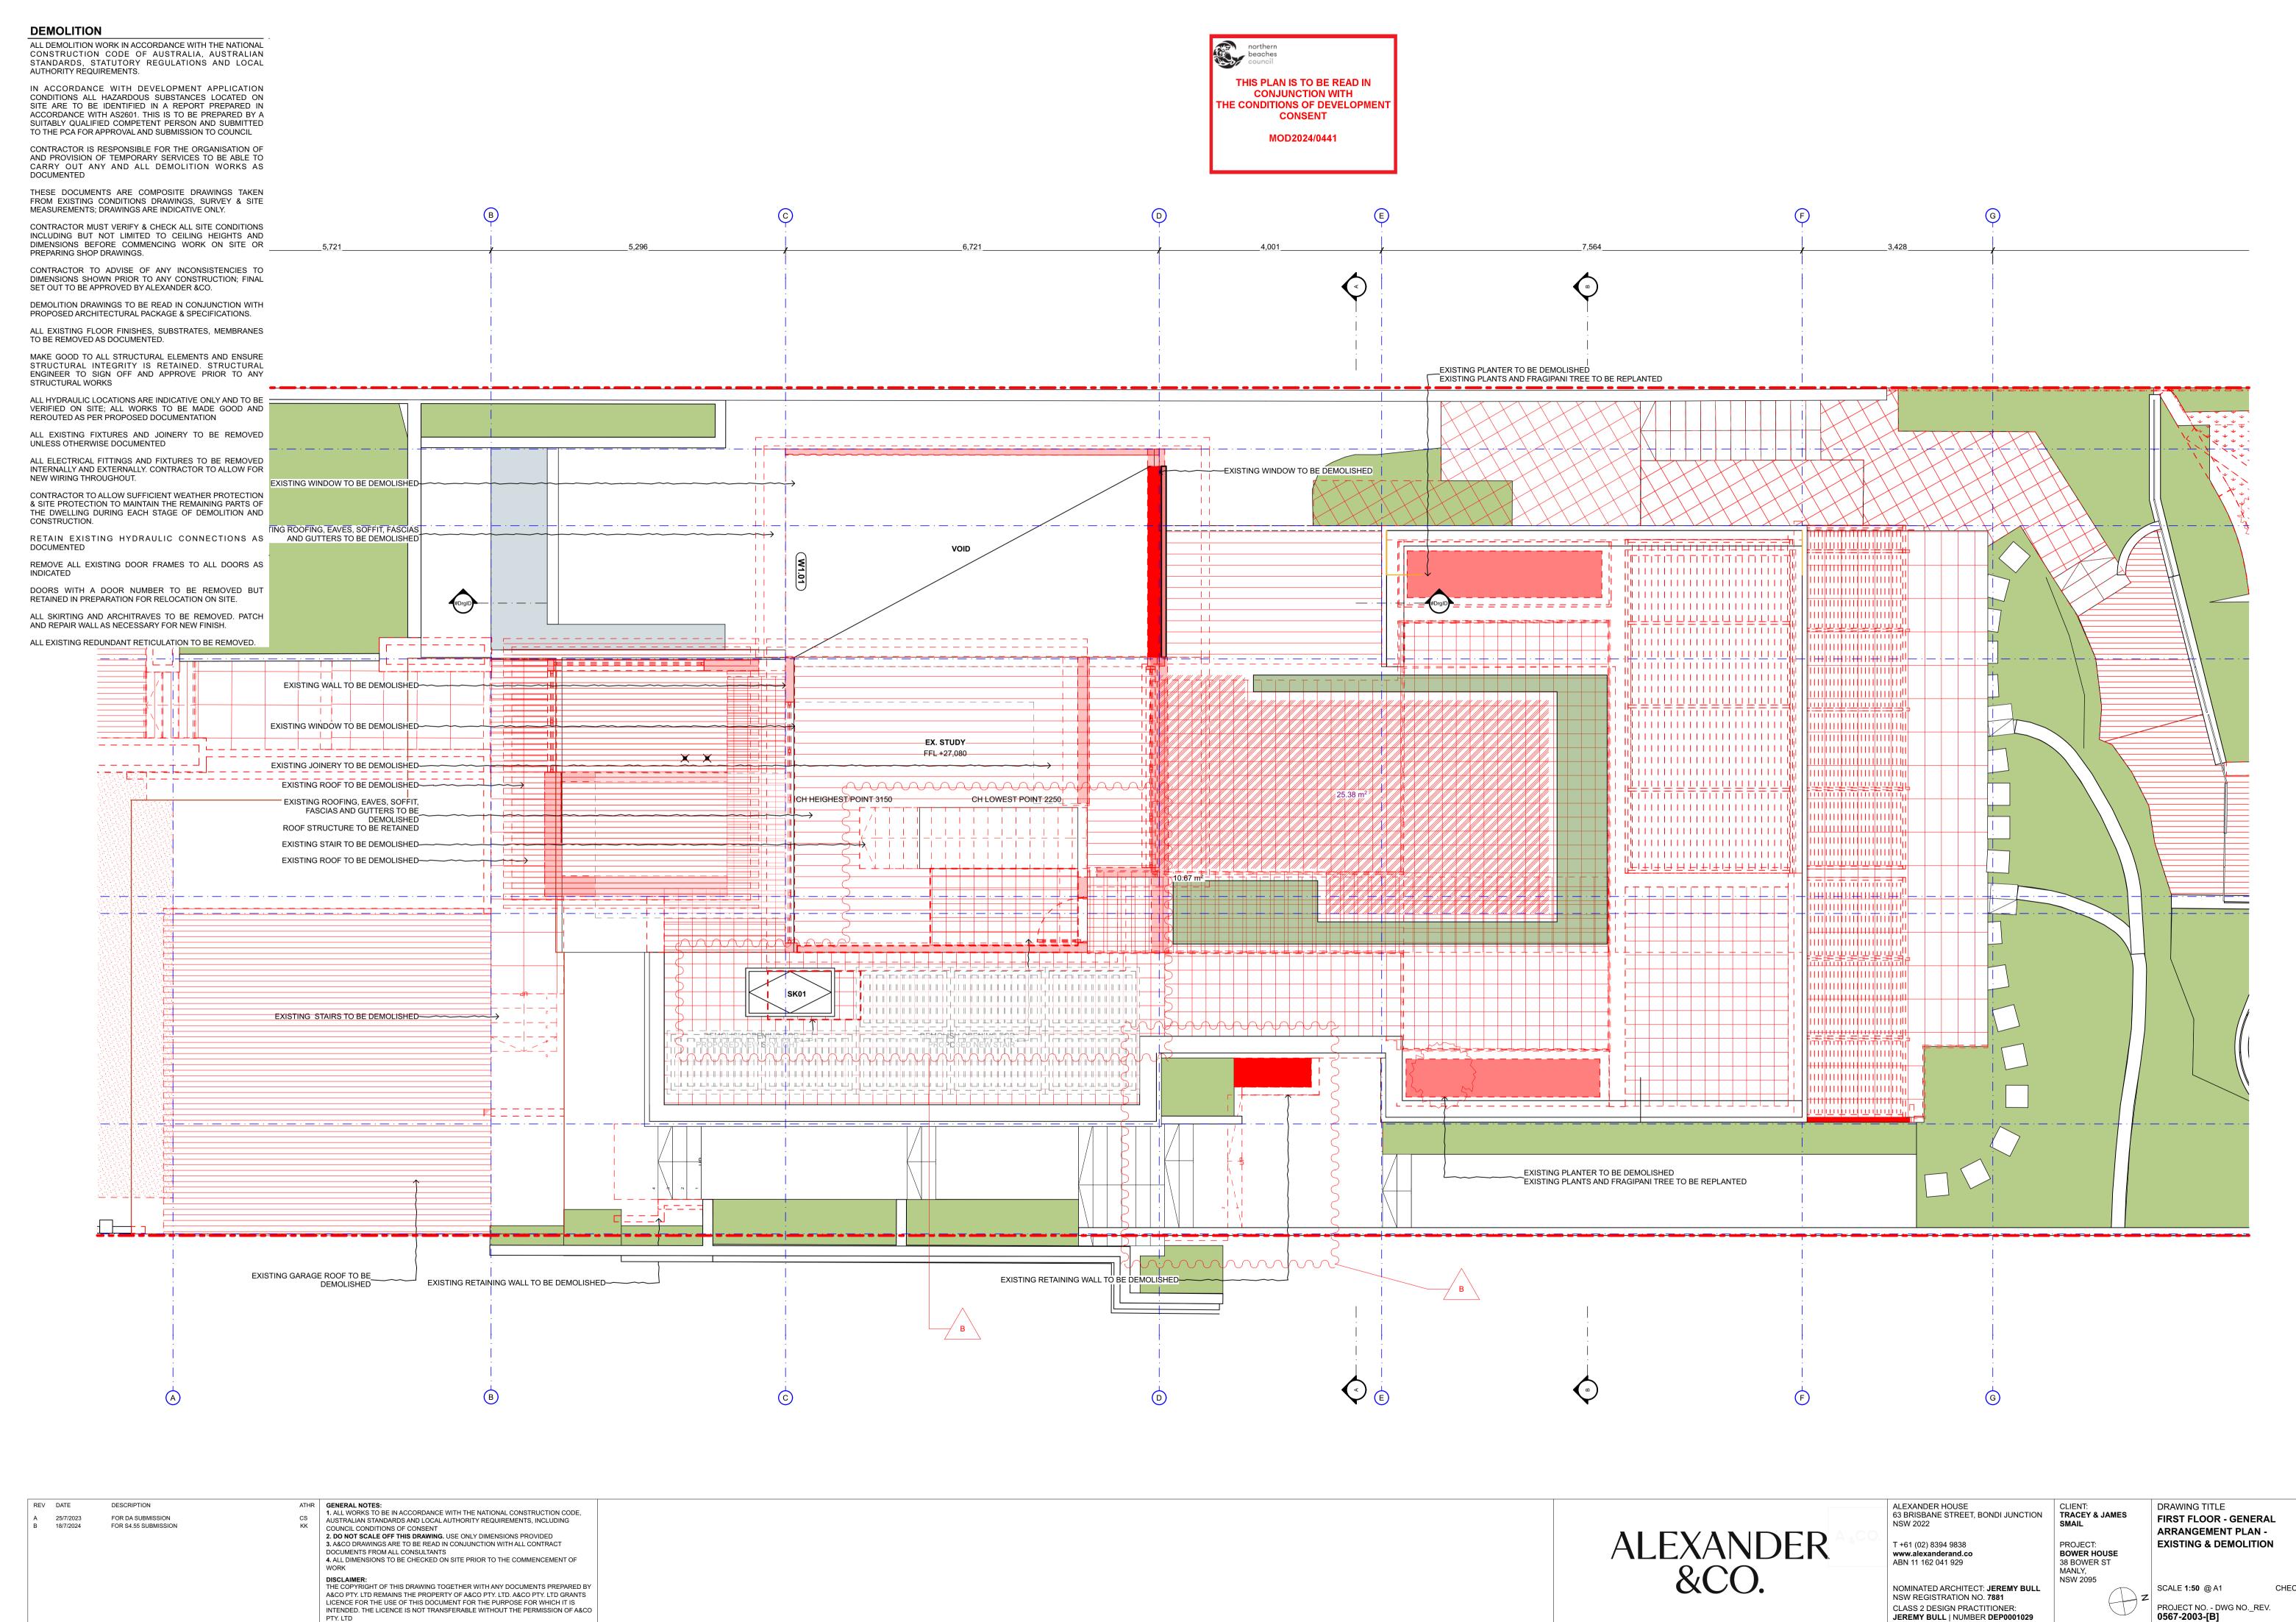
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GLAZING

EXISTING LEP AREA

EXISTING OPENINGS TO
BE REMOVED;
INCLUDING FRAMES
INCLUDING FRAMES
AND ARCHITRAVES.
MAKE GOOD OPENING
AND REVEALS

4. ALL DIMENSIONS TO BE CHECKED ON SITE PRIOR TO THE COMMENCEMENT OF
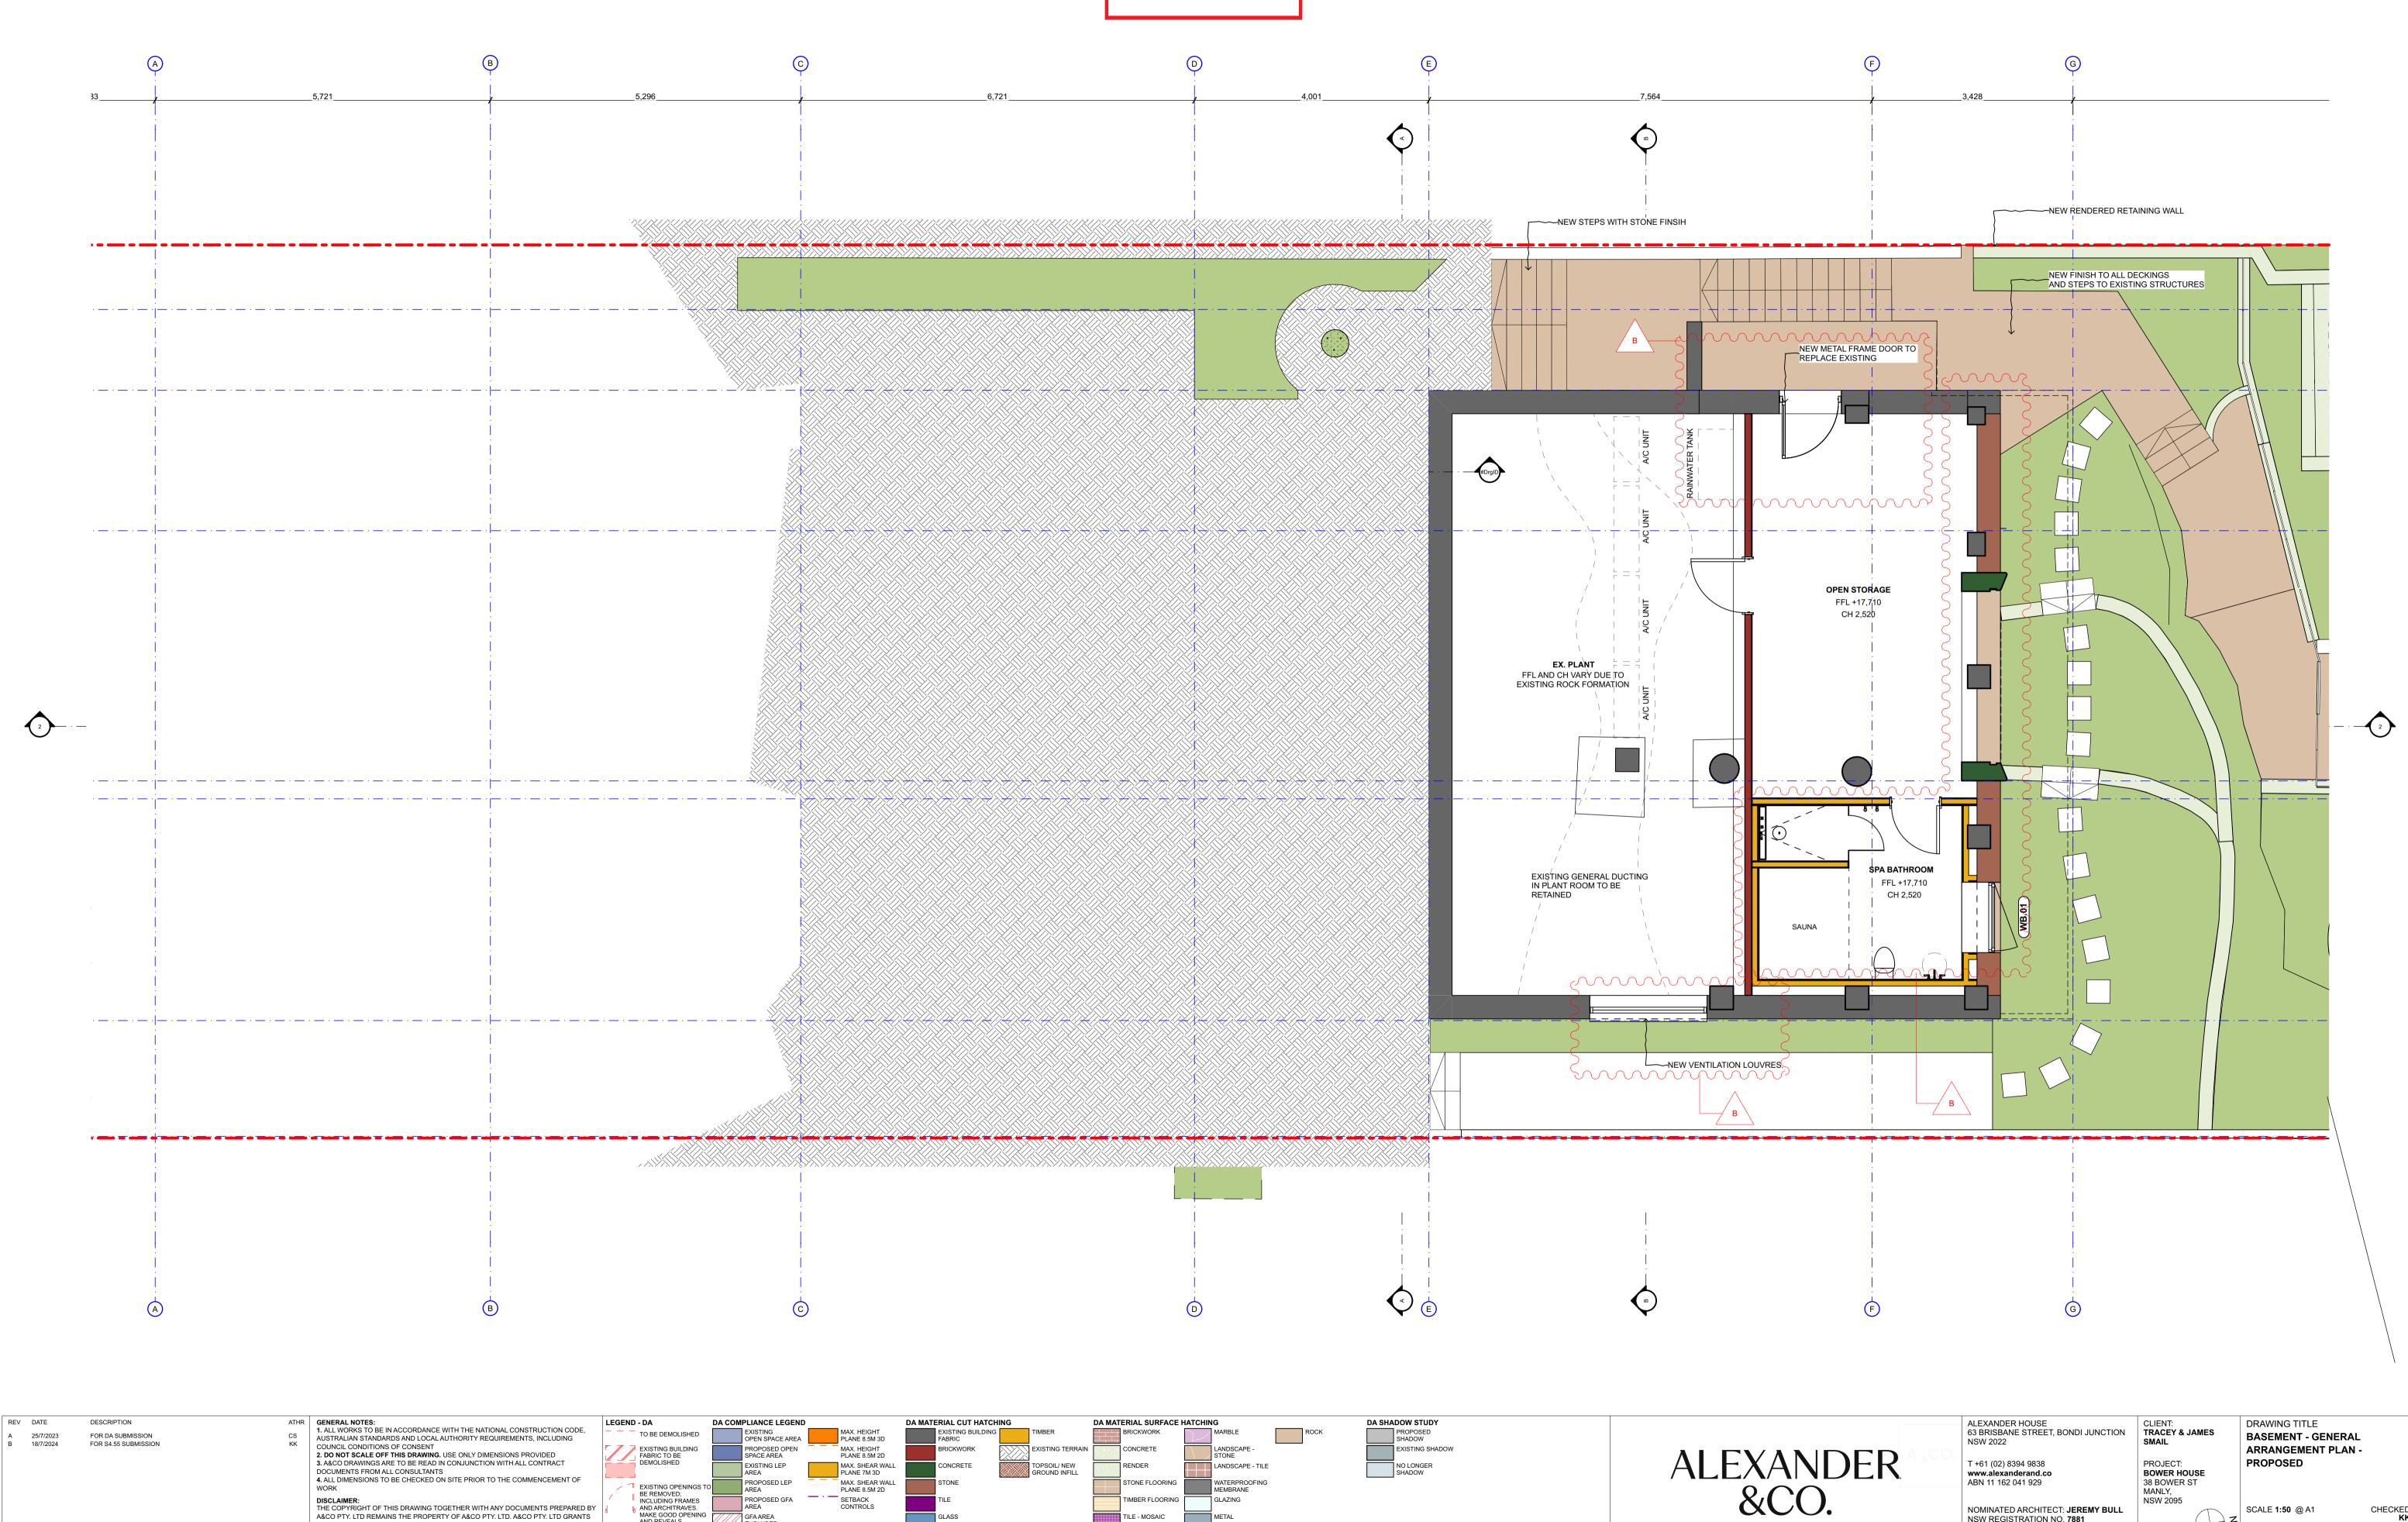
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MAX. SHEAR WALL PLANE 7M 3D

MAX. SHEAR WALL PLANE 8.5M 2D

SETBACK CONTROLS

CONCRETE

PROPOSED

SCALE 1:50 @ A1

0567-2100-[B]

PROJECT NO. - DWG NO._REV.

PROJECT:

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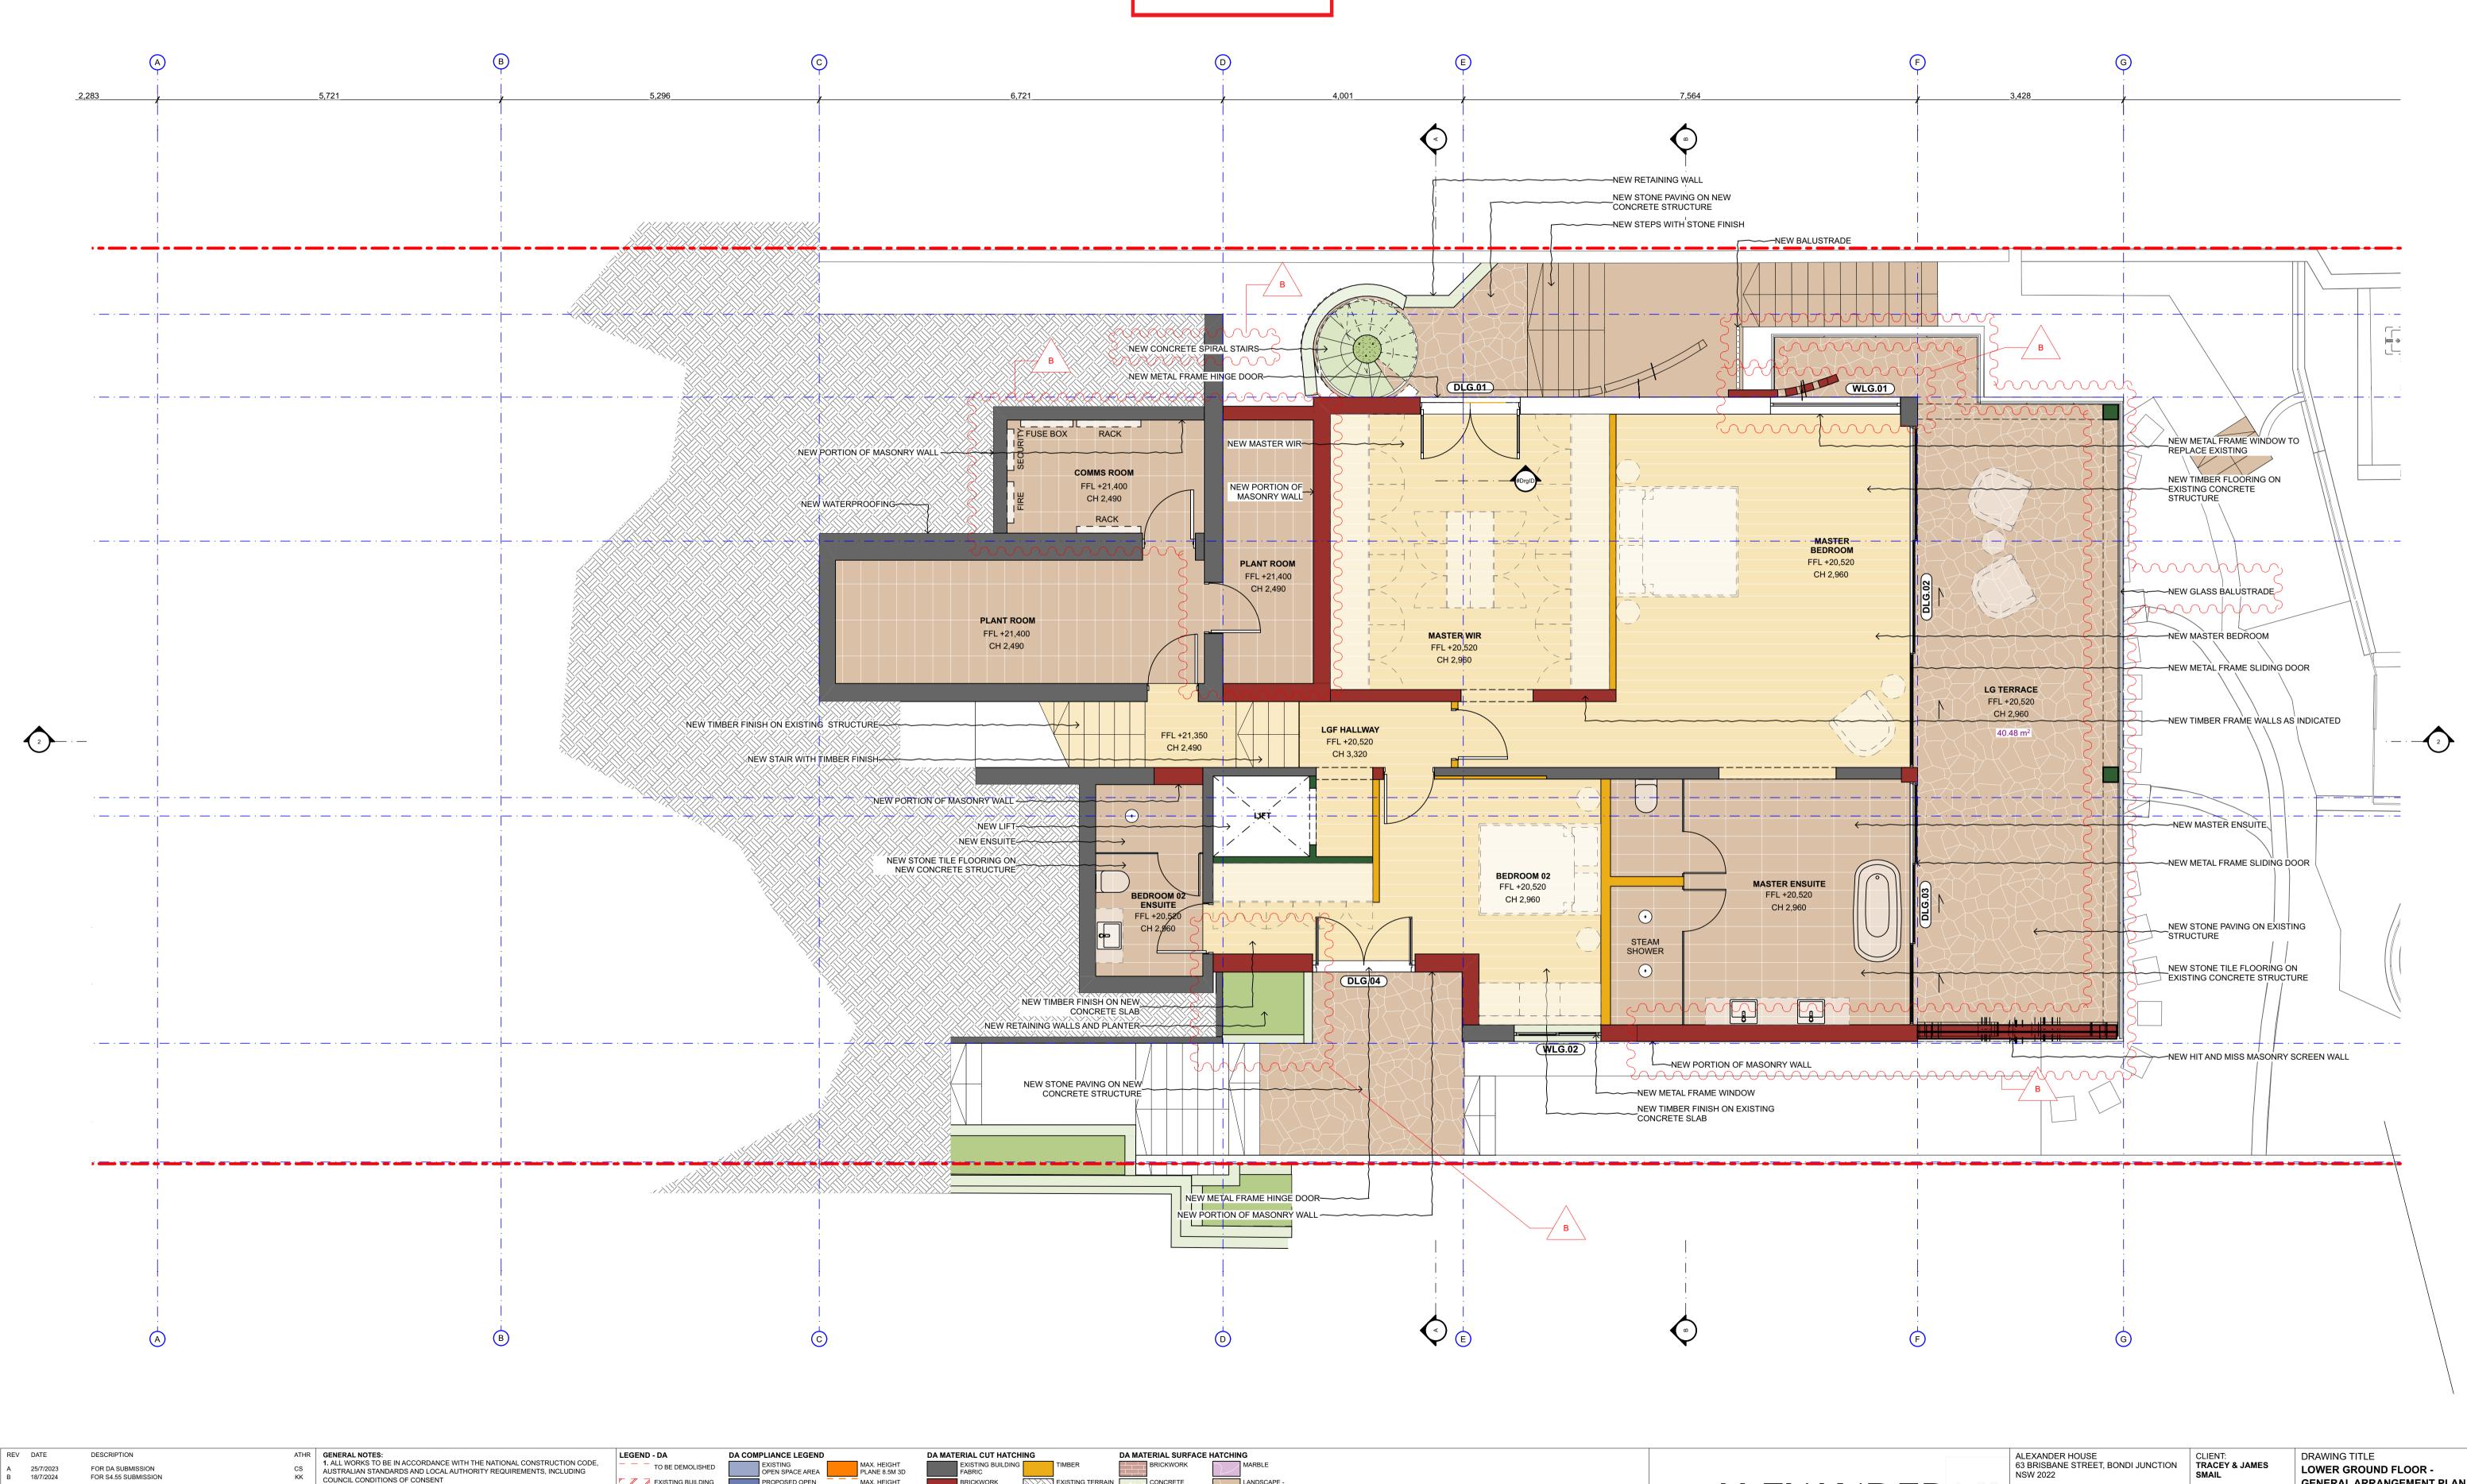
NOMINATED ARCHITECT: **JEREMY BULL** NSW REGISTRATION NO. **7881**

CLASS 2 DESIGN PRACTITIONER: JEREMY BULL | NUMBER DEP0001029

NSW 2095

BOWER HOUSE 38 BOWER ST





GLAZING

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NSW REGISTRATION NO. 7881

CLASS 2 DESIGN PRACTITIONER:

JEREMY BULL | NUMBER DEP0001029

GENERAL ARRANGEMENT PLAN

CHECKED **KK**

- PROPOSED

SCALE 1:50 @ A1

0567-2101-[B]

PROJECT NO. - DWG NO._REV.

PROJECT:

MANLY,

NSW 2095

BOWER HOUSE 38 BOWER ST

PROPOSED OPEN SPACE AREA

EXISTING LEP

MAX. HEIGHT PLANE 8.5M 2D

MAX. SHEAR WALL PLANE 7M 3D

MAX. SHEAR WALL PLANE 8.5M 2D

SETBACK CONTROLS

CONCRETE

EXISTING BUILDING FABRIC TO BE DEMOLISHED

EXISTING OPENINGS TO
BE REMOVED;
INCLUDING FRAMES
AND ARCHITRAVES.
MAKE GOOD OPENING
AND REVEALS

2. DO NOT SCALE OFF THIS DRAWING. USE ONLY DIMENSIONS PROVIDED 3. A&CO DRAWINGS ARE TO BE READ IN CONJUNCTION WITH ALL CONTRACT DOCUMENTS FROM ALL CONSULTANTS

PTY. LTD

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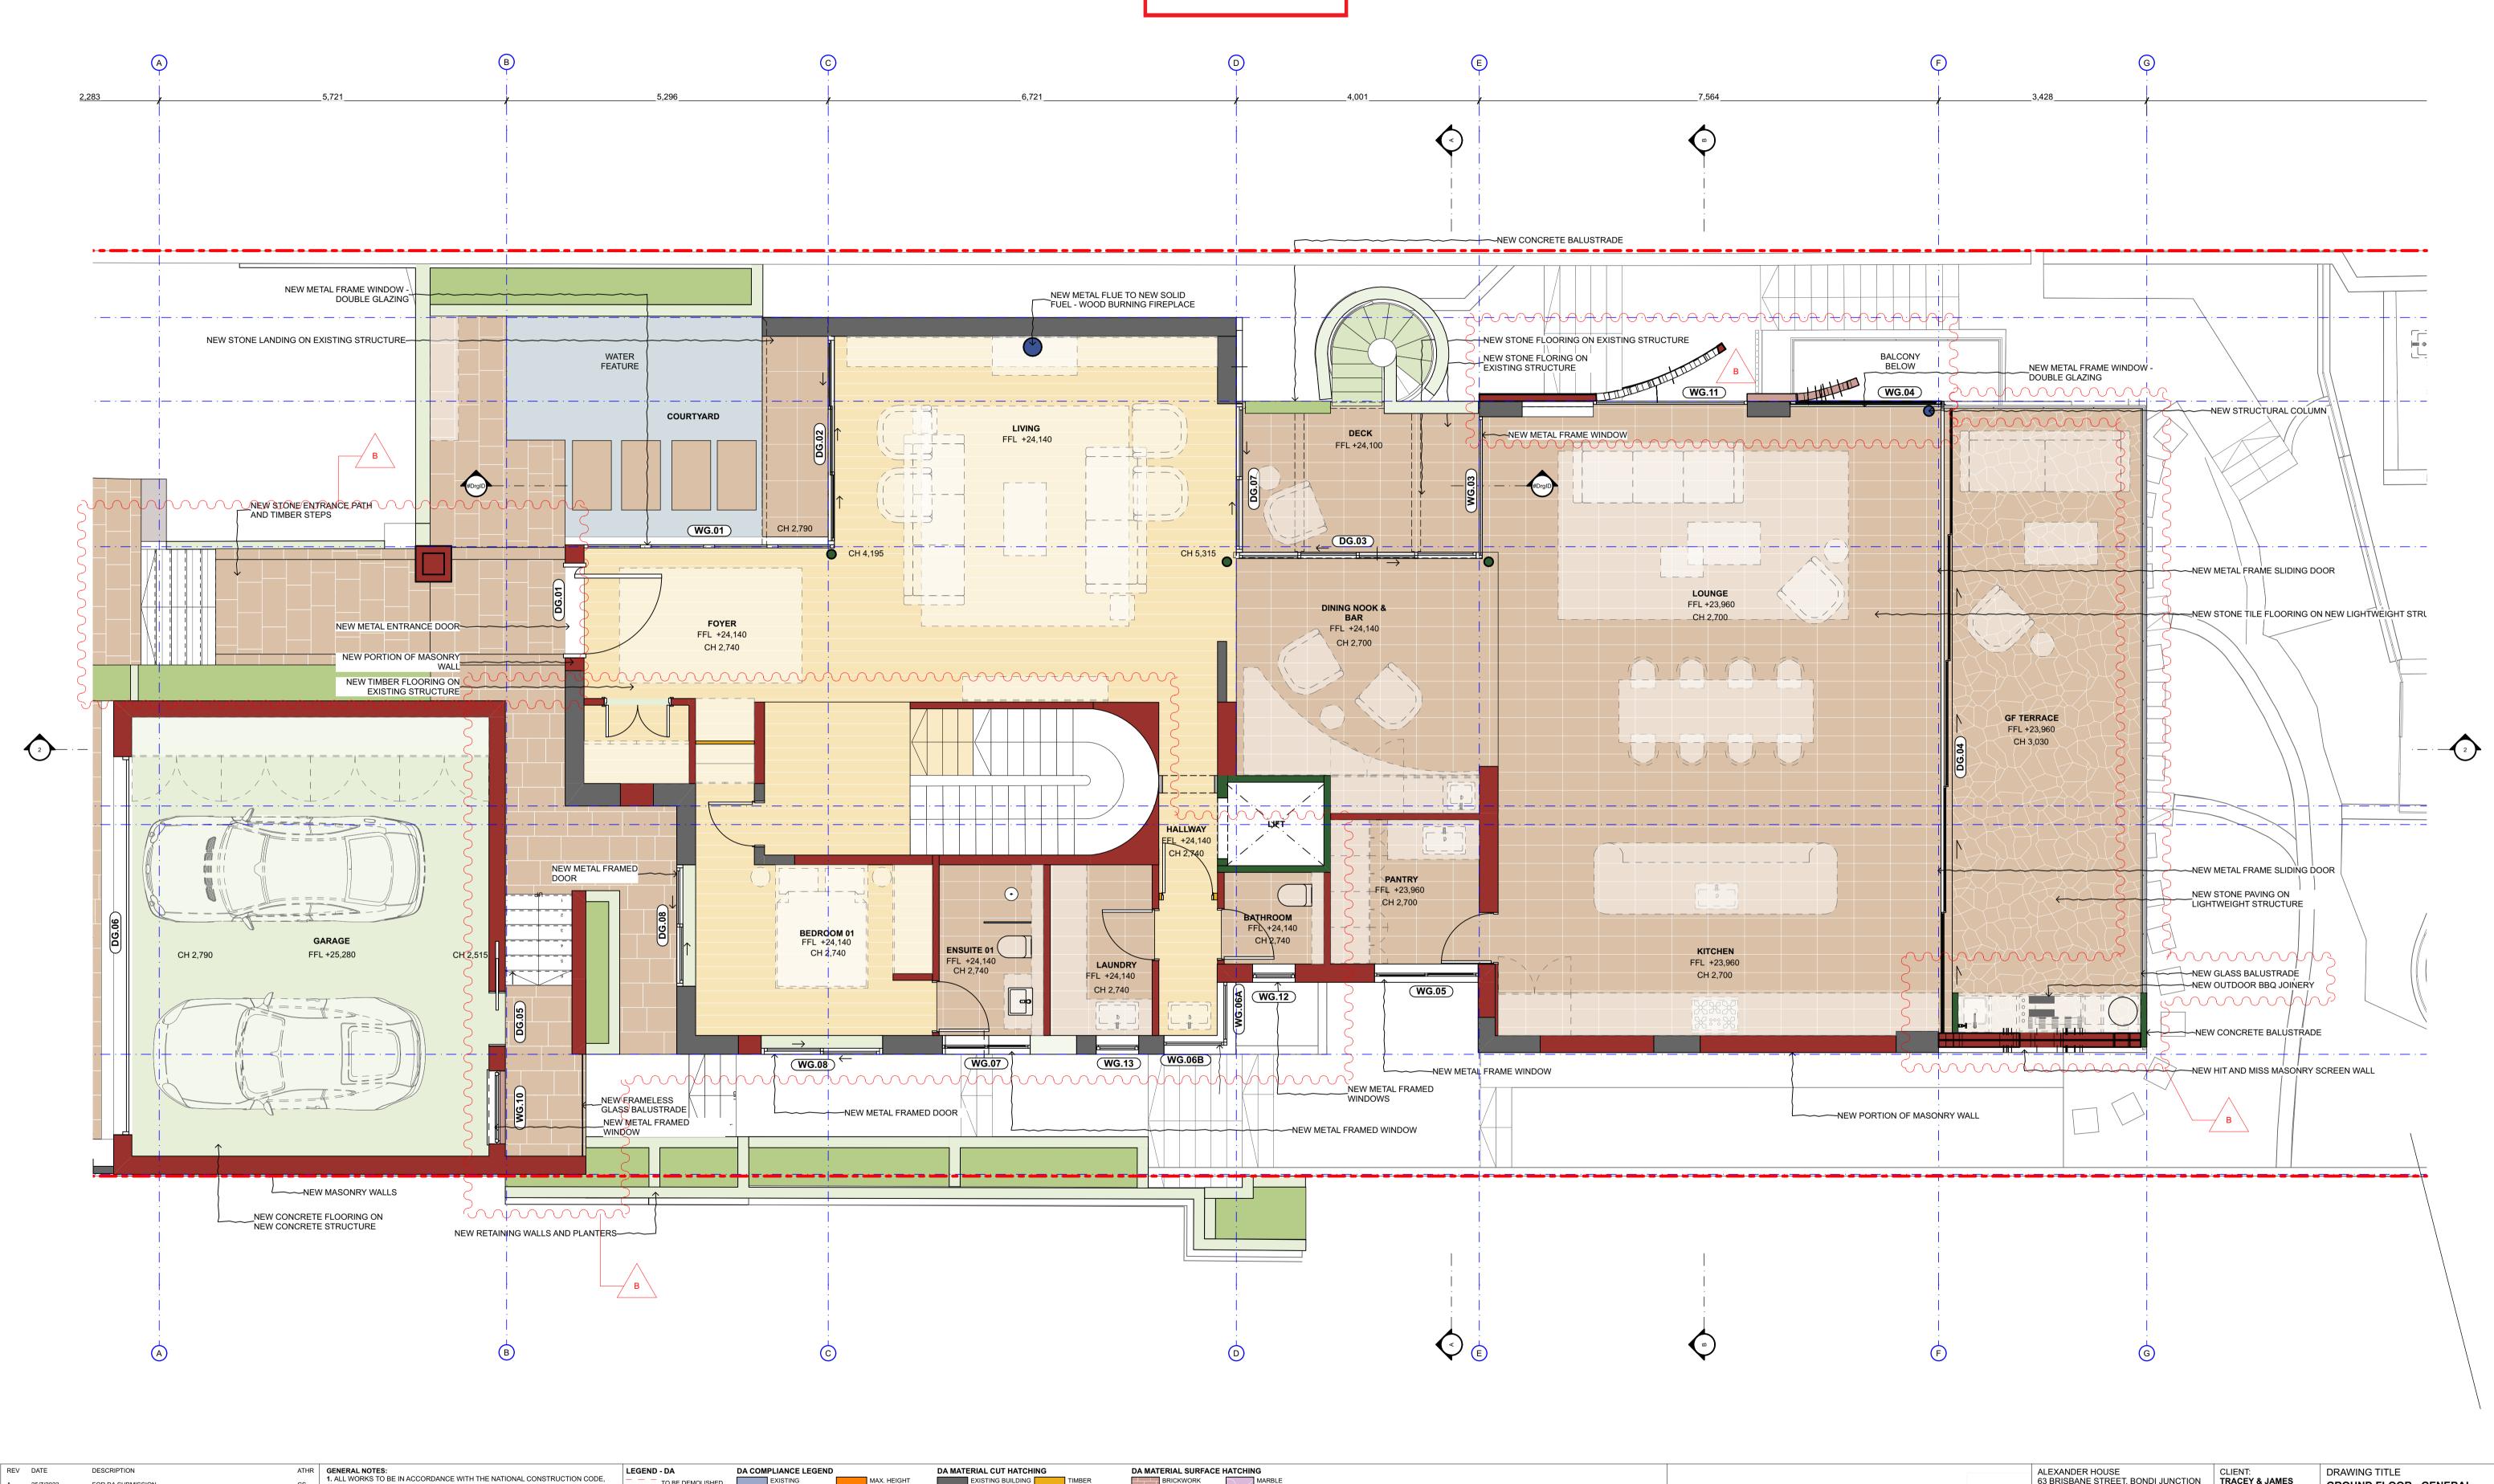
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B 18/7/2024

FOR \$4.55 SUBMISSION

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GLAZING

MAX. HEIGHT PLANE 8.5M 3D

MAX. HEIGHT PLANE 8.5M 2D

MAX. SHEAR WALL PLANE 7M 3D

MAX. SHEAR WALL PLANE 8.5M 2D

SETBACK CONTROLS

OPEN SPACE AREA

PROPOSED OPEN SPACE AREA

EXISTING LEP

TO BE DEMOLISHED

EXISTING BUILDING FABRIC TO BE DEMOLISHED

EXISTING OPENINGS T BE REMOVED;
INCLUDING FRAMES
AND ARCHITRAVES.
MAKE GOOD OPENING
AND REVEALS

AUSTRALIAN STANDARDS AND LOCAL AUTHORITY REQUIREMENTS, INCLUDING

4. ALL DIMENSIONS TO BE CHECKED ON SITE PRIOR TO THE COMMENCEMENT OF

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2. DO NOT SCALE OFF THIS DRAWING. USE ONLY DIMENSIONS PROVIDED 3. A&CO DRAWINGS ARE TO BE READ IN CONJUNCTION WITH ALL CONTRACT DOCUMENTS FROM ALL CONSULTANTS

COUNCIL CONDITIONS OF CONSENT

FOR DA SUBMISSION

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B 18/7/2024

KISTING BUILDING

CONCRETE

63 BRISBANE STREET, BONDI JUNCTION

NOMINATED ARCHITECT: **JEREMY BULL**

JEREMY BULL | NUMBER DEP0001029

NSW REGISTRATION NO. 7881

CLASS 2 DESIGN PRACTITIONER:

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ALEXANDER &CO.

TRACEY & JAMES

BOWER HOUSE

38 BOWER ST

PROJECT:

MANLY,

NSW 2095

GROUND FLOOR - GENERAL

CHECKED **KK**

ARRANGEMENT PLAN -


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NOMINATED ARCHITECT: **JEREMY BULL**

NSW REGISTRATION NO. 7881

CLASS 2 DESIGN PRACTITIONER:

JEREMY BULL | NUMBER DEP0001029

ARRANGEMENT PLAN -

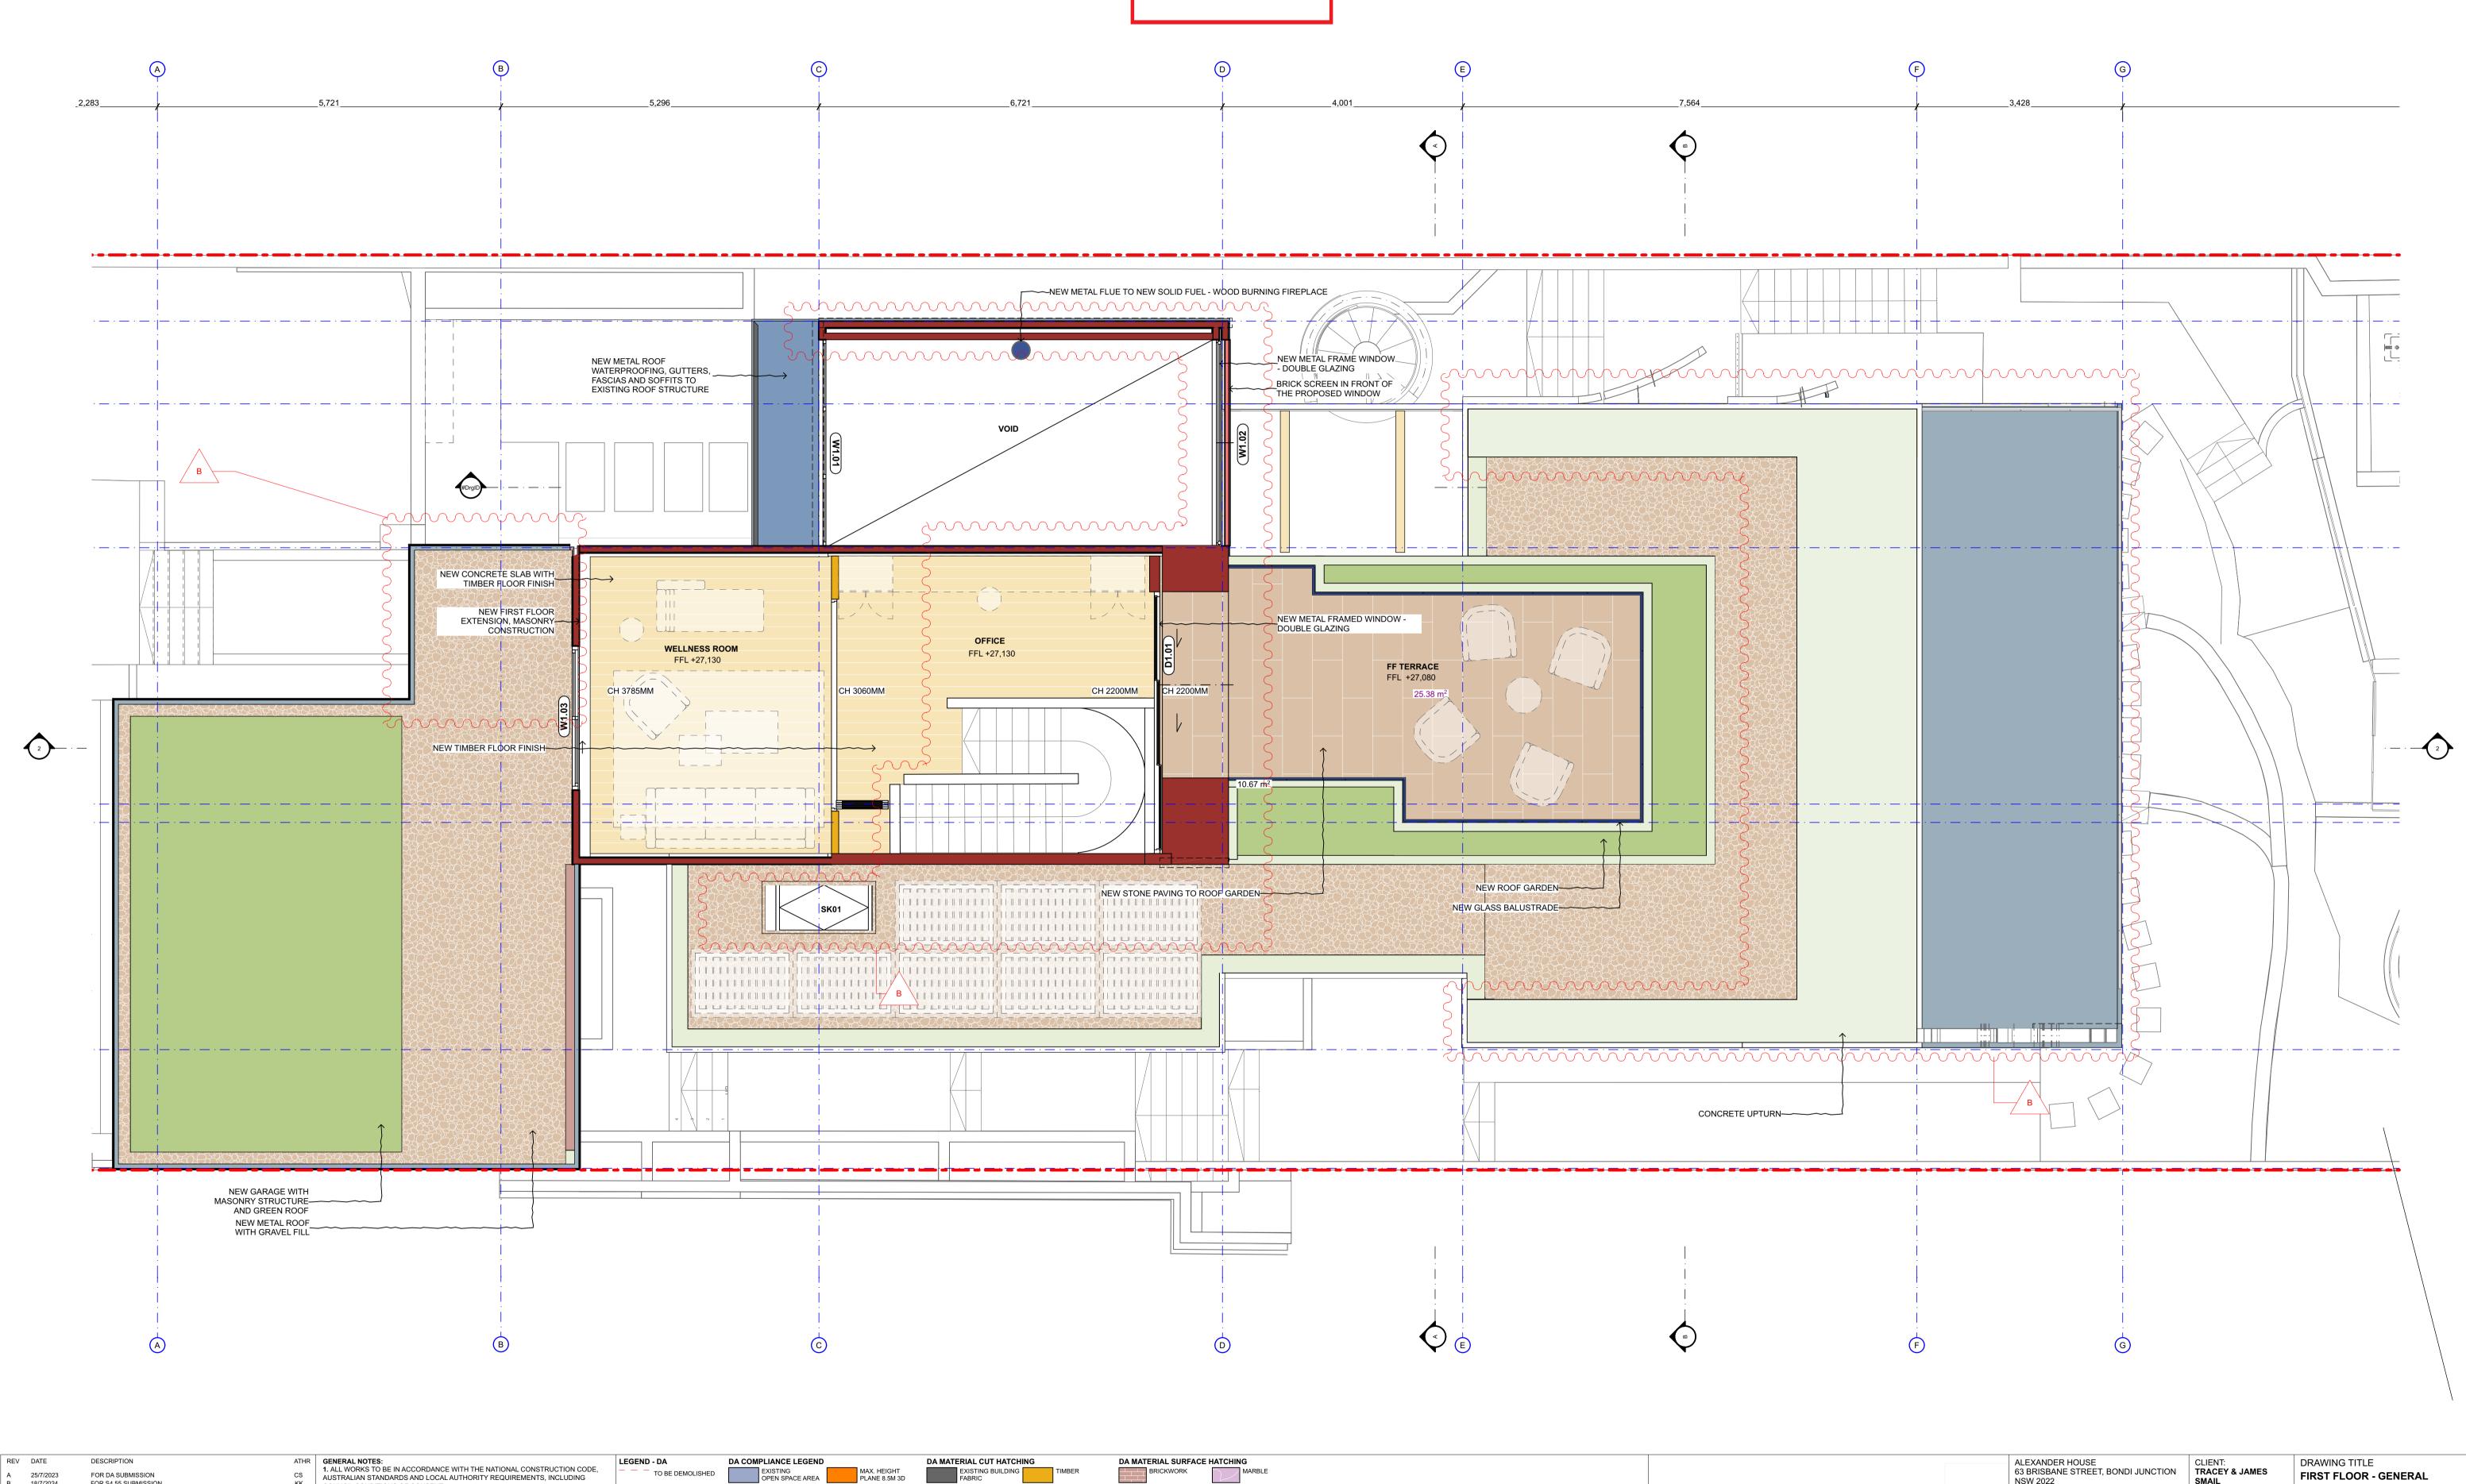PROJECT NO. - DWG NO._REV.

PROPOSED

SCALE 1:50 @ A1

0567-2103-[B]

PROJECT:

MANLY,

NSW 2095

BOWER HOUSE 38 BOWER ST

ALEXANDER &CO.

AUSTRALIAN STANDARDS AND LOCAL AUTHORITY REQUIREMENTS, INCLUDING COUNCIL CONDITIONS OF CONSENT

4. ALL DIMENSIONS TO BE CHECKED ON SITE PRIOR TO THE COMMENCEMENT OF

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B 18/7/2024

FOR \$4.55 SUBMISSION

BIMcloud: ALEX-BIM-SERVER - BIMcloud/0567_38 Bower St, Manly/0567_38 Bower St_S4.55

OPEN SPACE AREA

PROPOSED OPEN SPACE AREA

EXISTING LEP

MAX. HEIGHT PLANE 8.5M 2D

MAX. SHEAR WALL PLANE 7M 3D

MAX. SHEAR WALL PLANE 8.5M 2D

SETBACK CONTROLS

CONCRETE


EXISTING BUILDING FABRIC TO BE DEMOLISHED

EXISTING OPENINGS TO

BE REMOVED;
INCLUDING FRAMES
AND ARCHITRAVES.


MAKE GOOD OPENING AND REVEALS




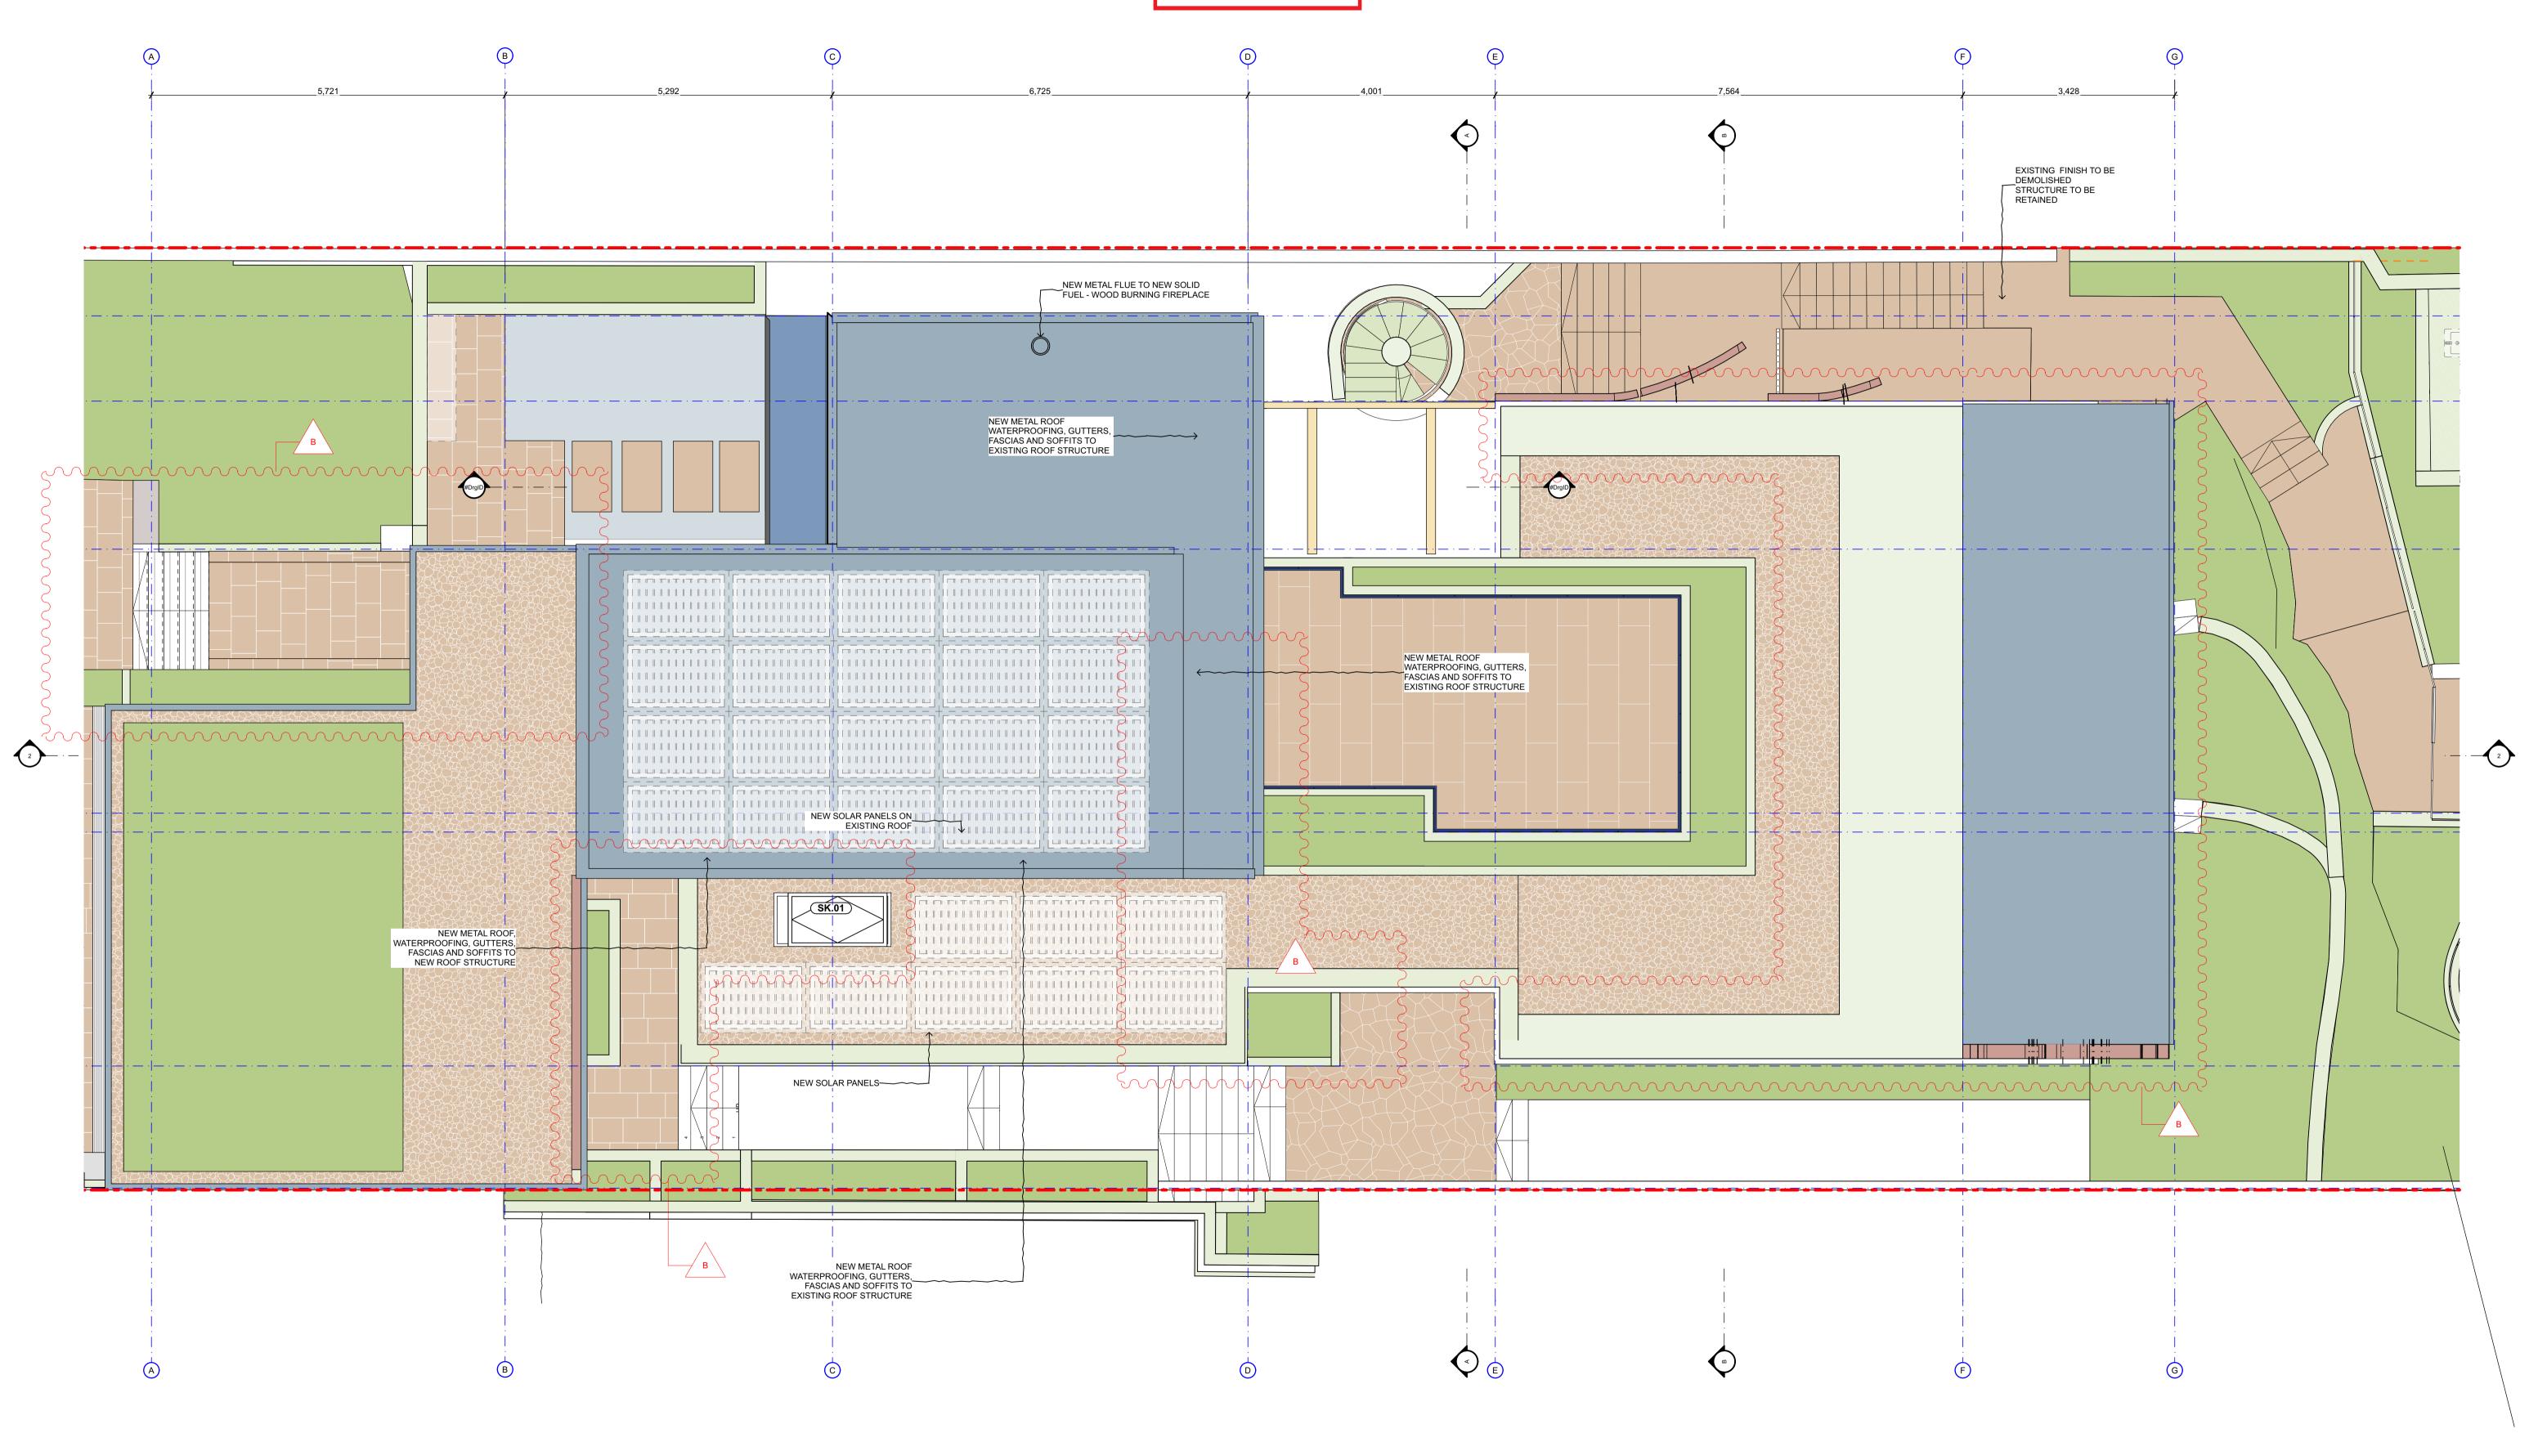


ATHR GENERAL NOTES:

1. ALL WORKS TO BE IN ACCORDANCE WITH THE NATIONAL CONSTRUCTION CODE, DESCRIPTION ALEXANDER HOUSE DRAWING TITLE 63 BRISBANE STREET, BONDI JUNCTION TRACEY & JAMES **ROOF - GENERAL** FOR DA SUBMISSION AUSTRALIAN STANDARDS AND LOCAL AUTHORITY REQUIREMENTS, INCLUDING NSW 2022 B 18/7/2024 FOR \$4.55 SUBMISSION COUNCIL CONDITIONS OF CONSENT ALEXANDER &CO. **ARRANGEMENT PLAN -**2. DO NOT SCALE OFF THIS DRAWING. USE ONLY DIMENSIONS PROVIDED 3. A&CO DRAWINGS ARE TO BE READ IN CONJUNCTION WITH ALL CONTRACT DOCUMENTS FROM ALL CONSULTANTS T +61 (02) 8394 9838 PROPOSED PROJECT: www.alexanderand.co ABN 11 162 041 929 **BOWER HOUSE** 4. ALL DIMENSIONS TO BE CHECKED ON SITE PRIOR TO THE COMMENCEMENT OF 38 BOWER ST MANLY, **DISCLAIMER:**THE COPYRIGHT OF THIS DRAWING TOGETHER WITH ANY DOCUMENTS PREPARED BY NSW 2095 NOMINATED ARCHITECT: **JEREMY BULL** SCALE 1:50 @ A1 A&CO PTY. LTD REMAINS THE PROPERTY OF A&CO PTY. LTD. A&CO PTY. LTD GRANTS NSW REGISTRATION NO. 7881 LICENCE FOR THE USE OF THIS DOCUMENT FOR THE PURPOSE FOR WHICH IT IS INTENDED. THE LICENCE IS NOT TRANSFERABLE WITHOUT THE PERMISSION OF A&CO CLASS 2 DESIGN PRACTITIONER: PROJECT NO. - DWG NO._REV. JEREMY BULL | NUMBER DEP0001029 0567-2104-[B] BIMcloud: ALEX-BIM-SERVER - BIMcloud/0567_38 Bower St, Manly/0567_38 Bower St_S4.55

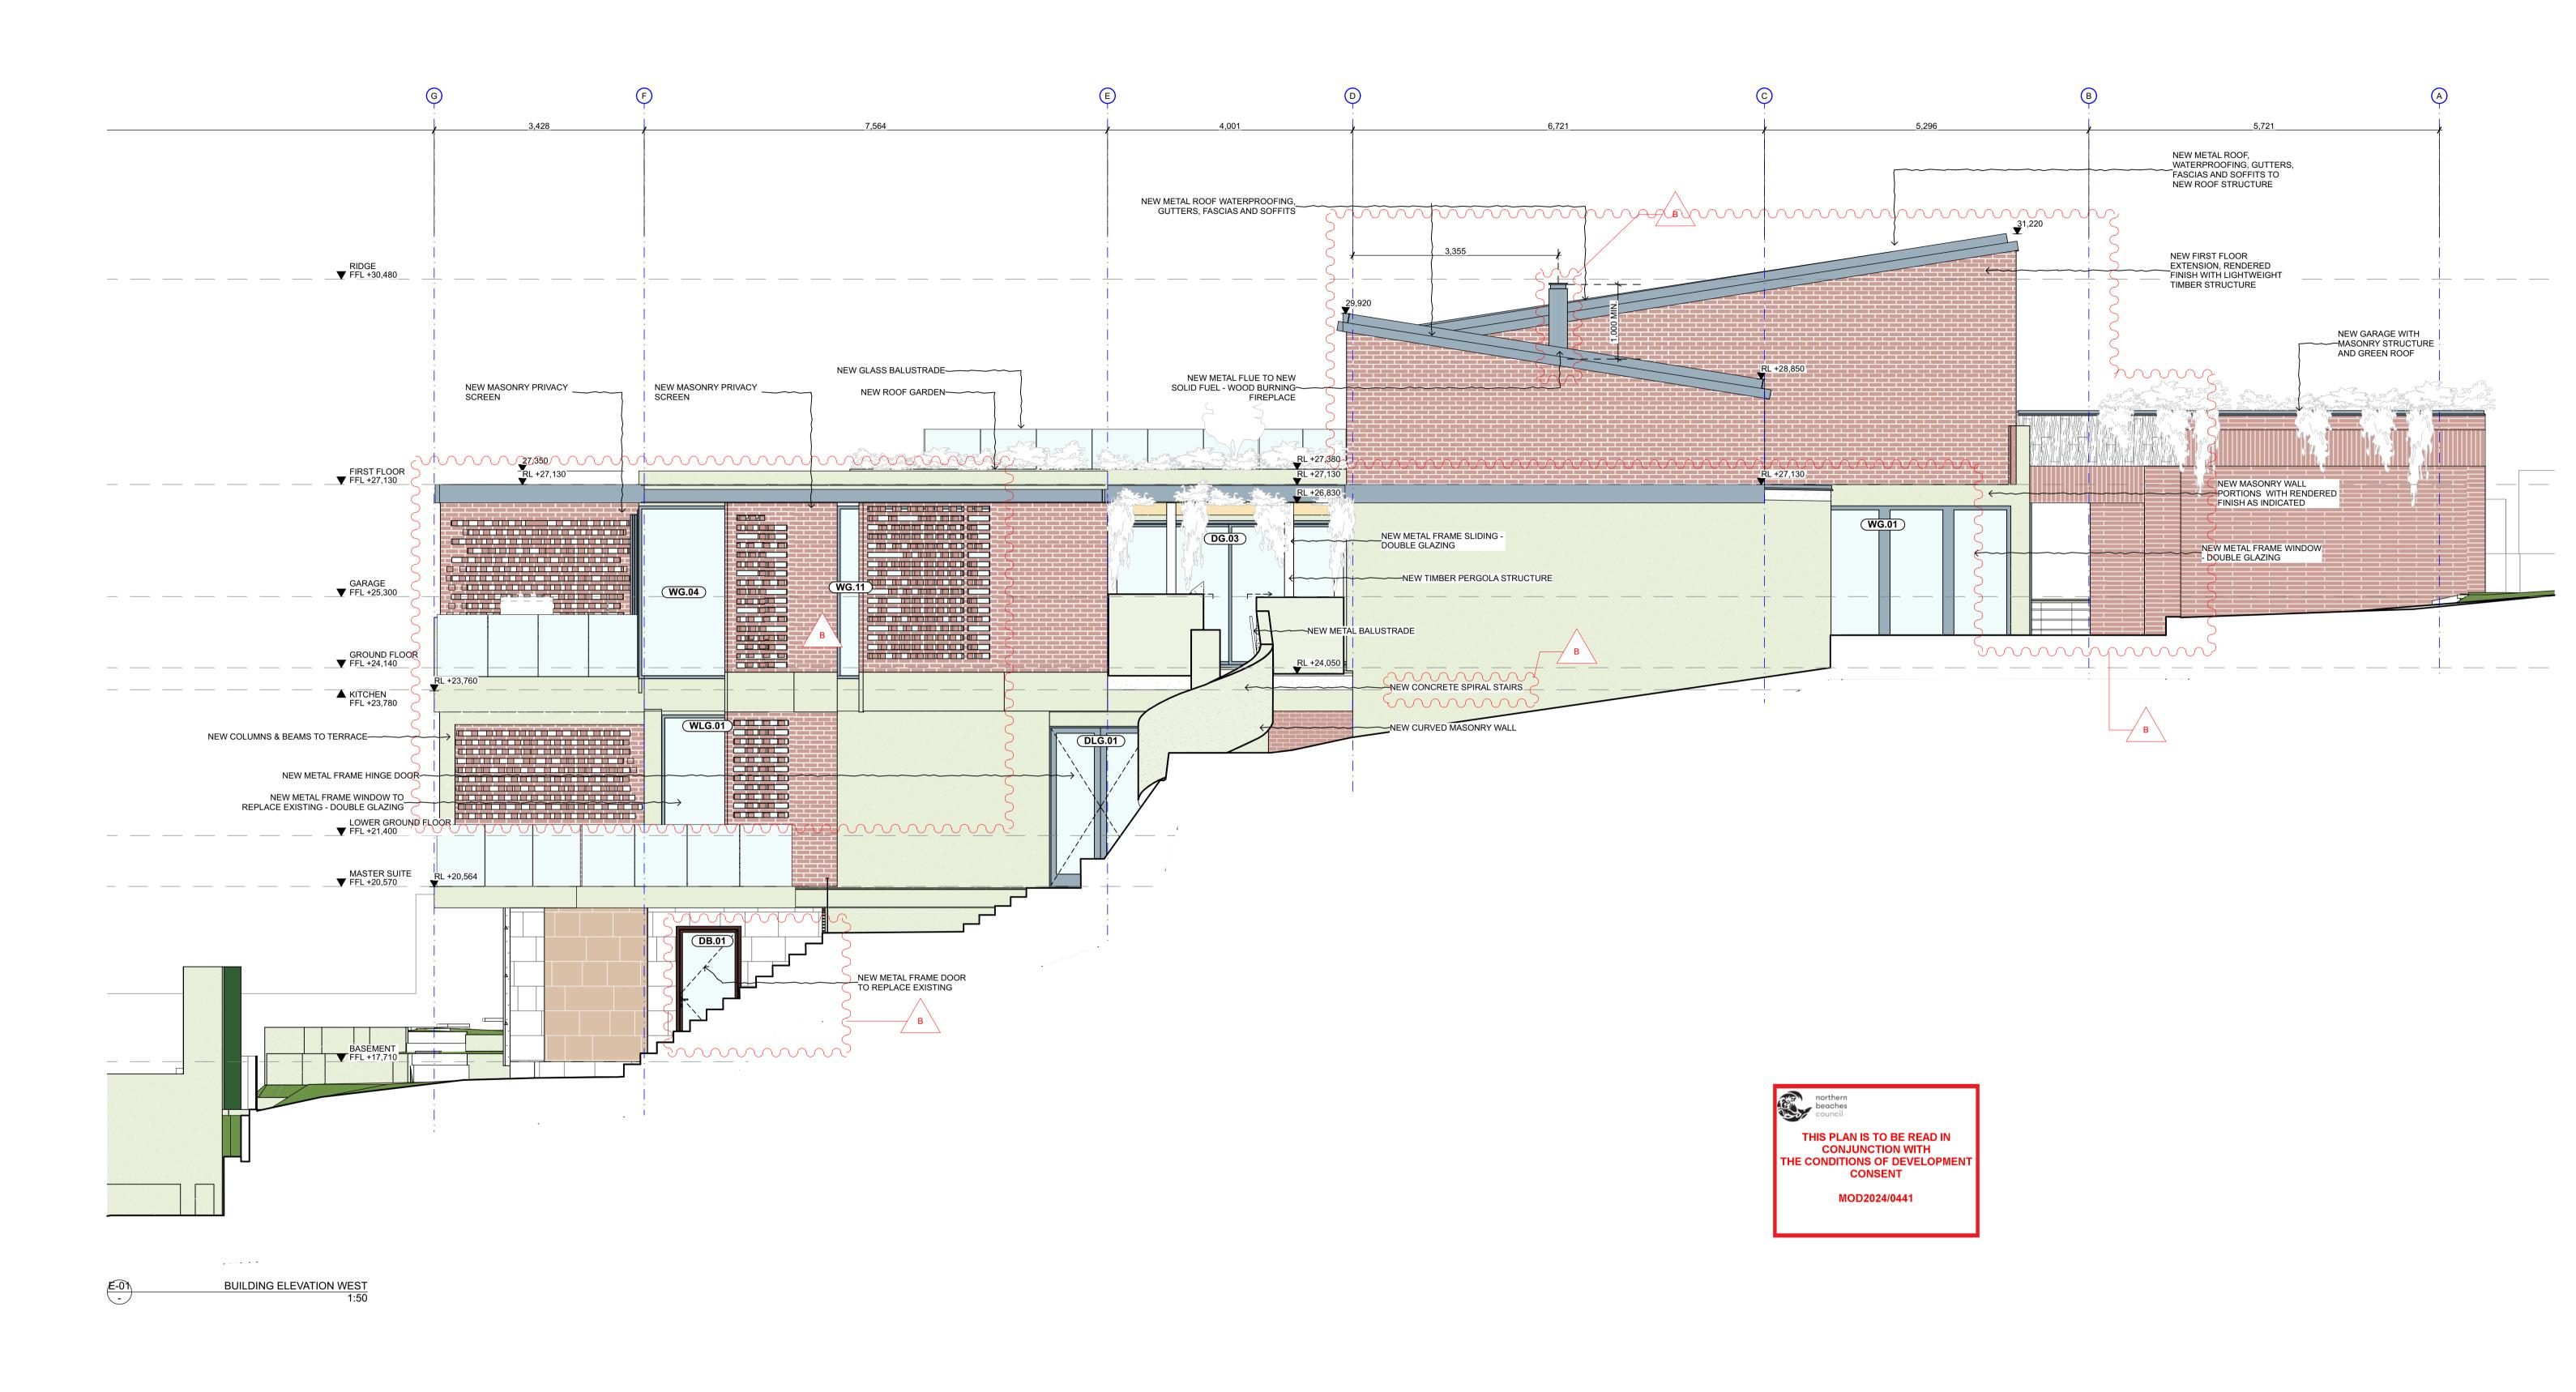

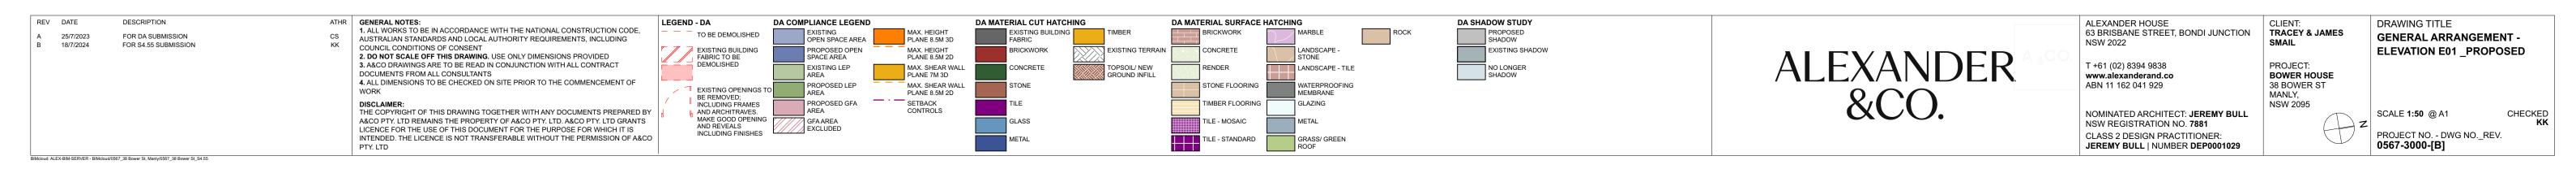


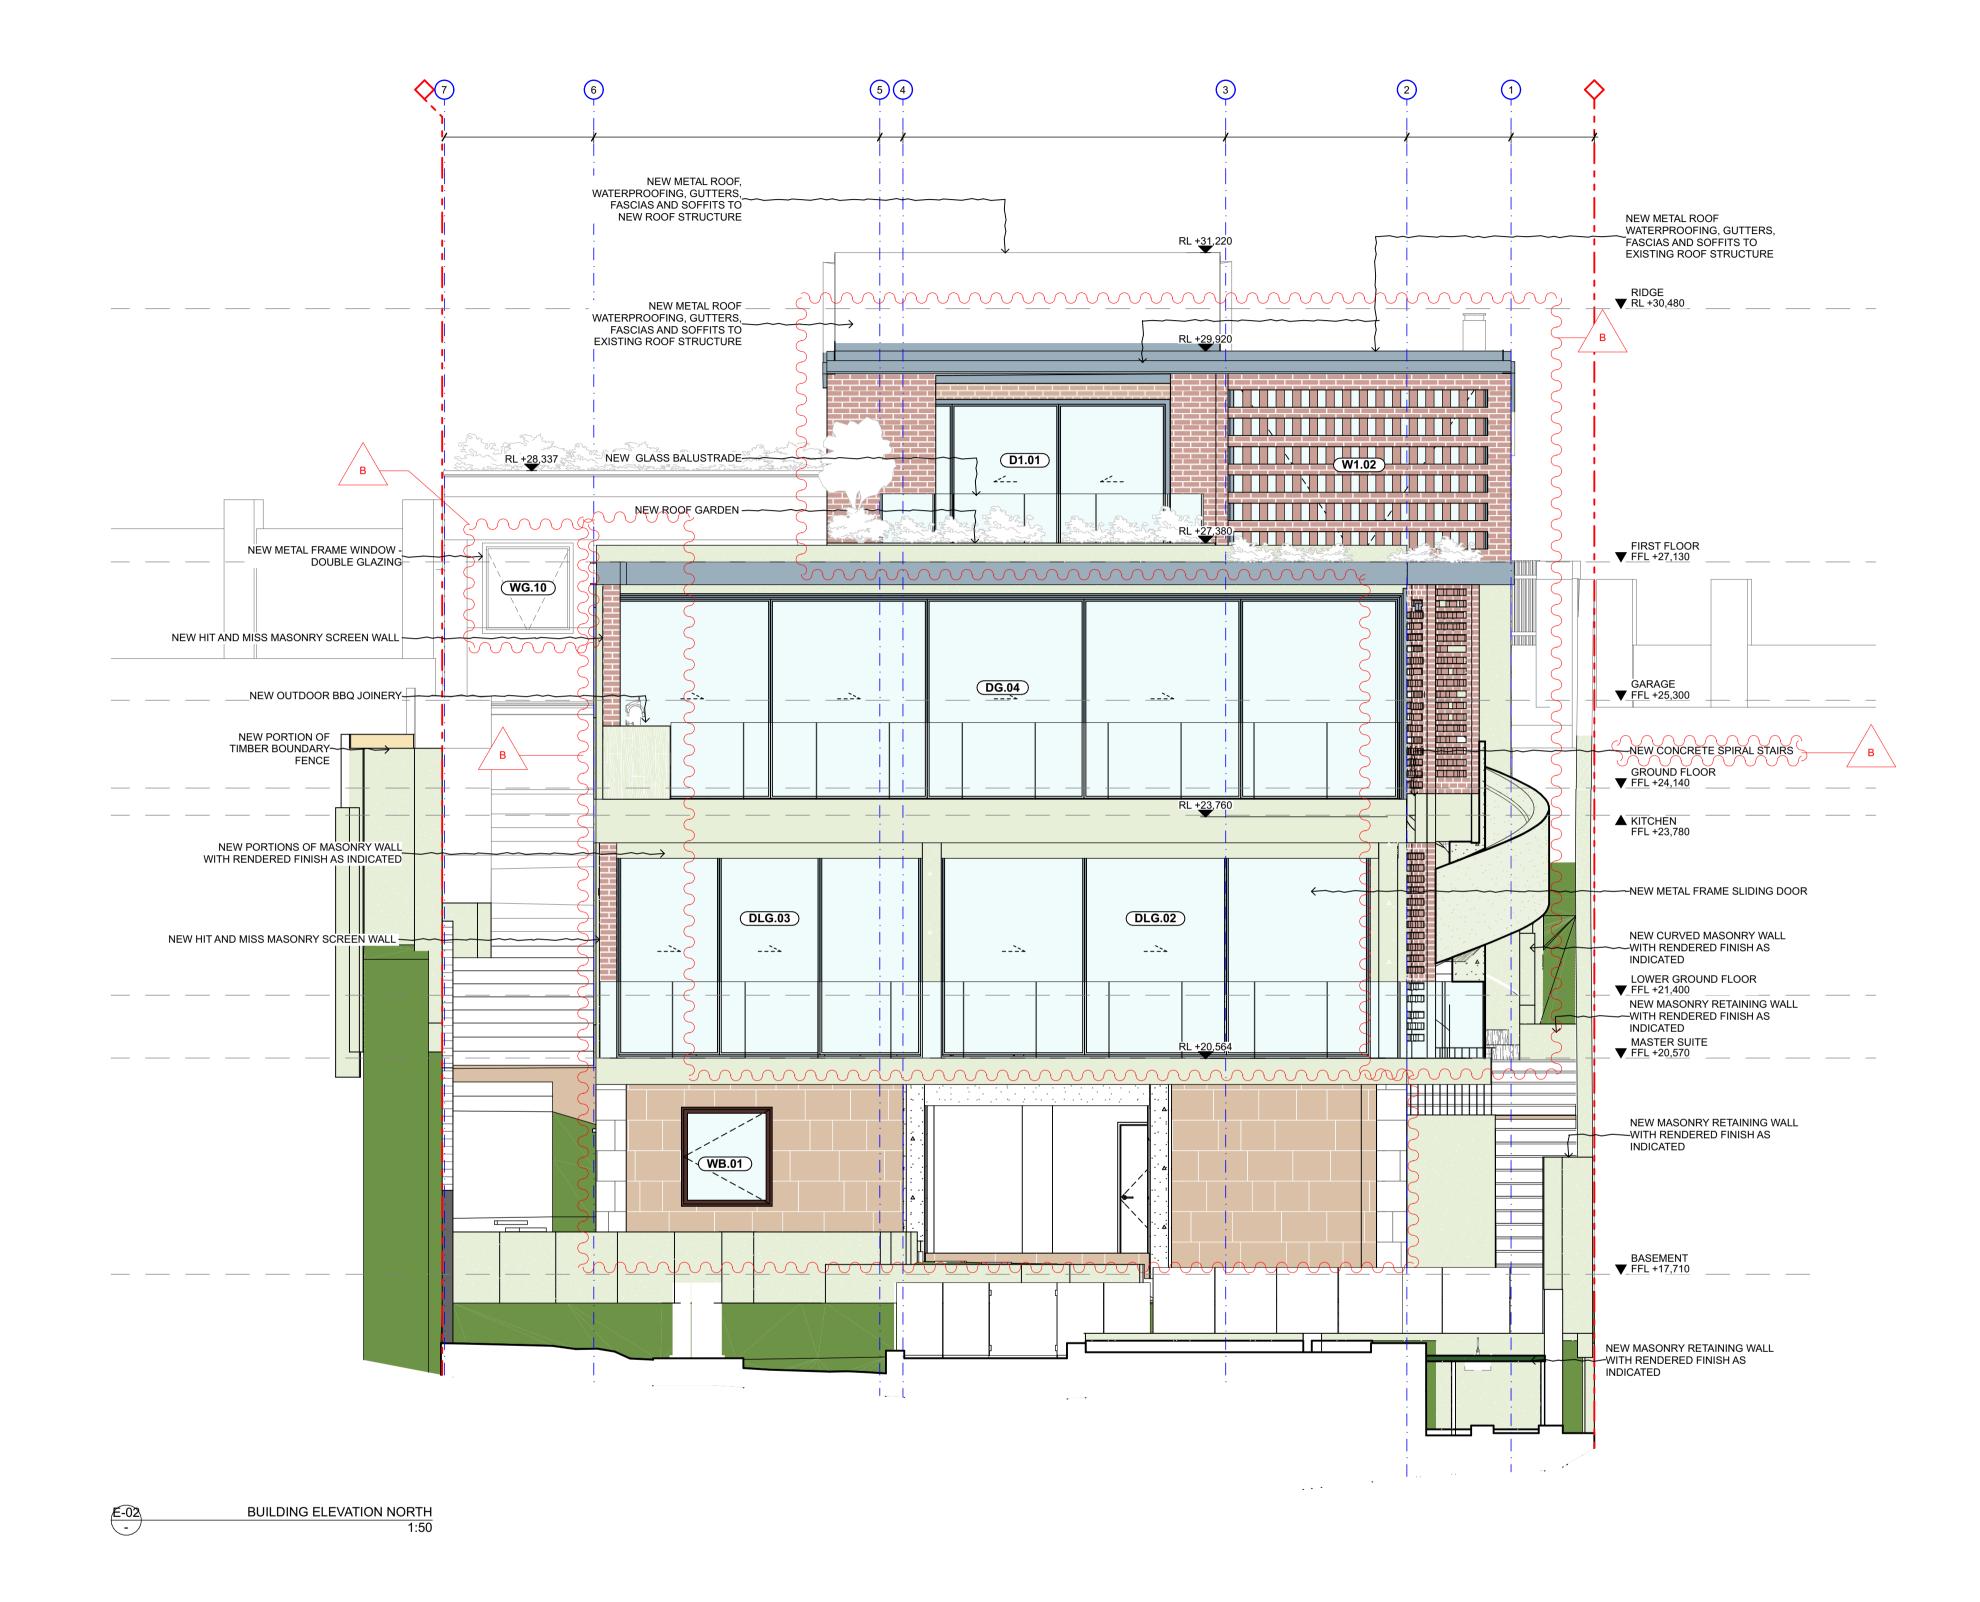






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BE REMOVED;
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MAKE GOOD OPENING
AND REVEALS MANLY, **DISCLAIMER:**THE COPYRIGHT OF THIS DRAWING TOGETHER WITH ANY DOCUMENTS PREPARED BY SETBACK CONTROLS GLAZING TIMBER FLOORING NSW 2095 CHECKED KK NOMINATED ARCHITECT: **JEREMY BULL** SCALE 1:50 @ A1 A&CO PTY. LTD REMAINS THE PROPERTY OF A&CO PTY. LTD. A&CO PTY. LTD GRANTS NSW REGISTRATION NO. 7881 LICENCE FOR THE USE OF THIS DOCUMENT FOR THE PURPOSE FOR WHICH IT IS INTENDED. THE LICENCE IS NOT TRANSFERABLE WITHOUT THE PERMISSION OF A&CO PROJECT NO. - DWG NO. REV. CLASS 2 DESIGN PRACTITIONER: 0567-3001-[B] JEREMY BULL | NUMBER DEP0001029 BIMcloud: ALEX-BIM-SERVER - BIMcloud/0567_38 Bower St, Manly/0567_38 Bower St_S4.55



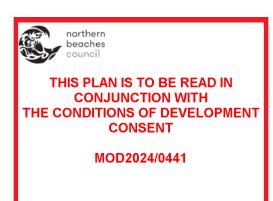


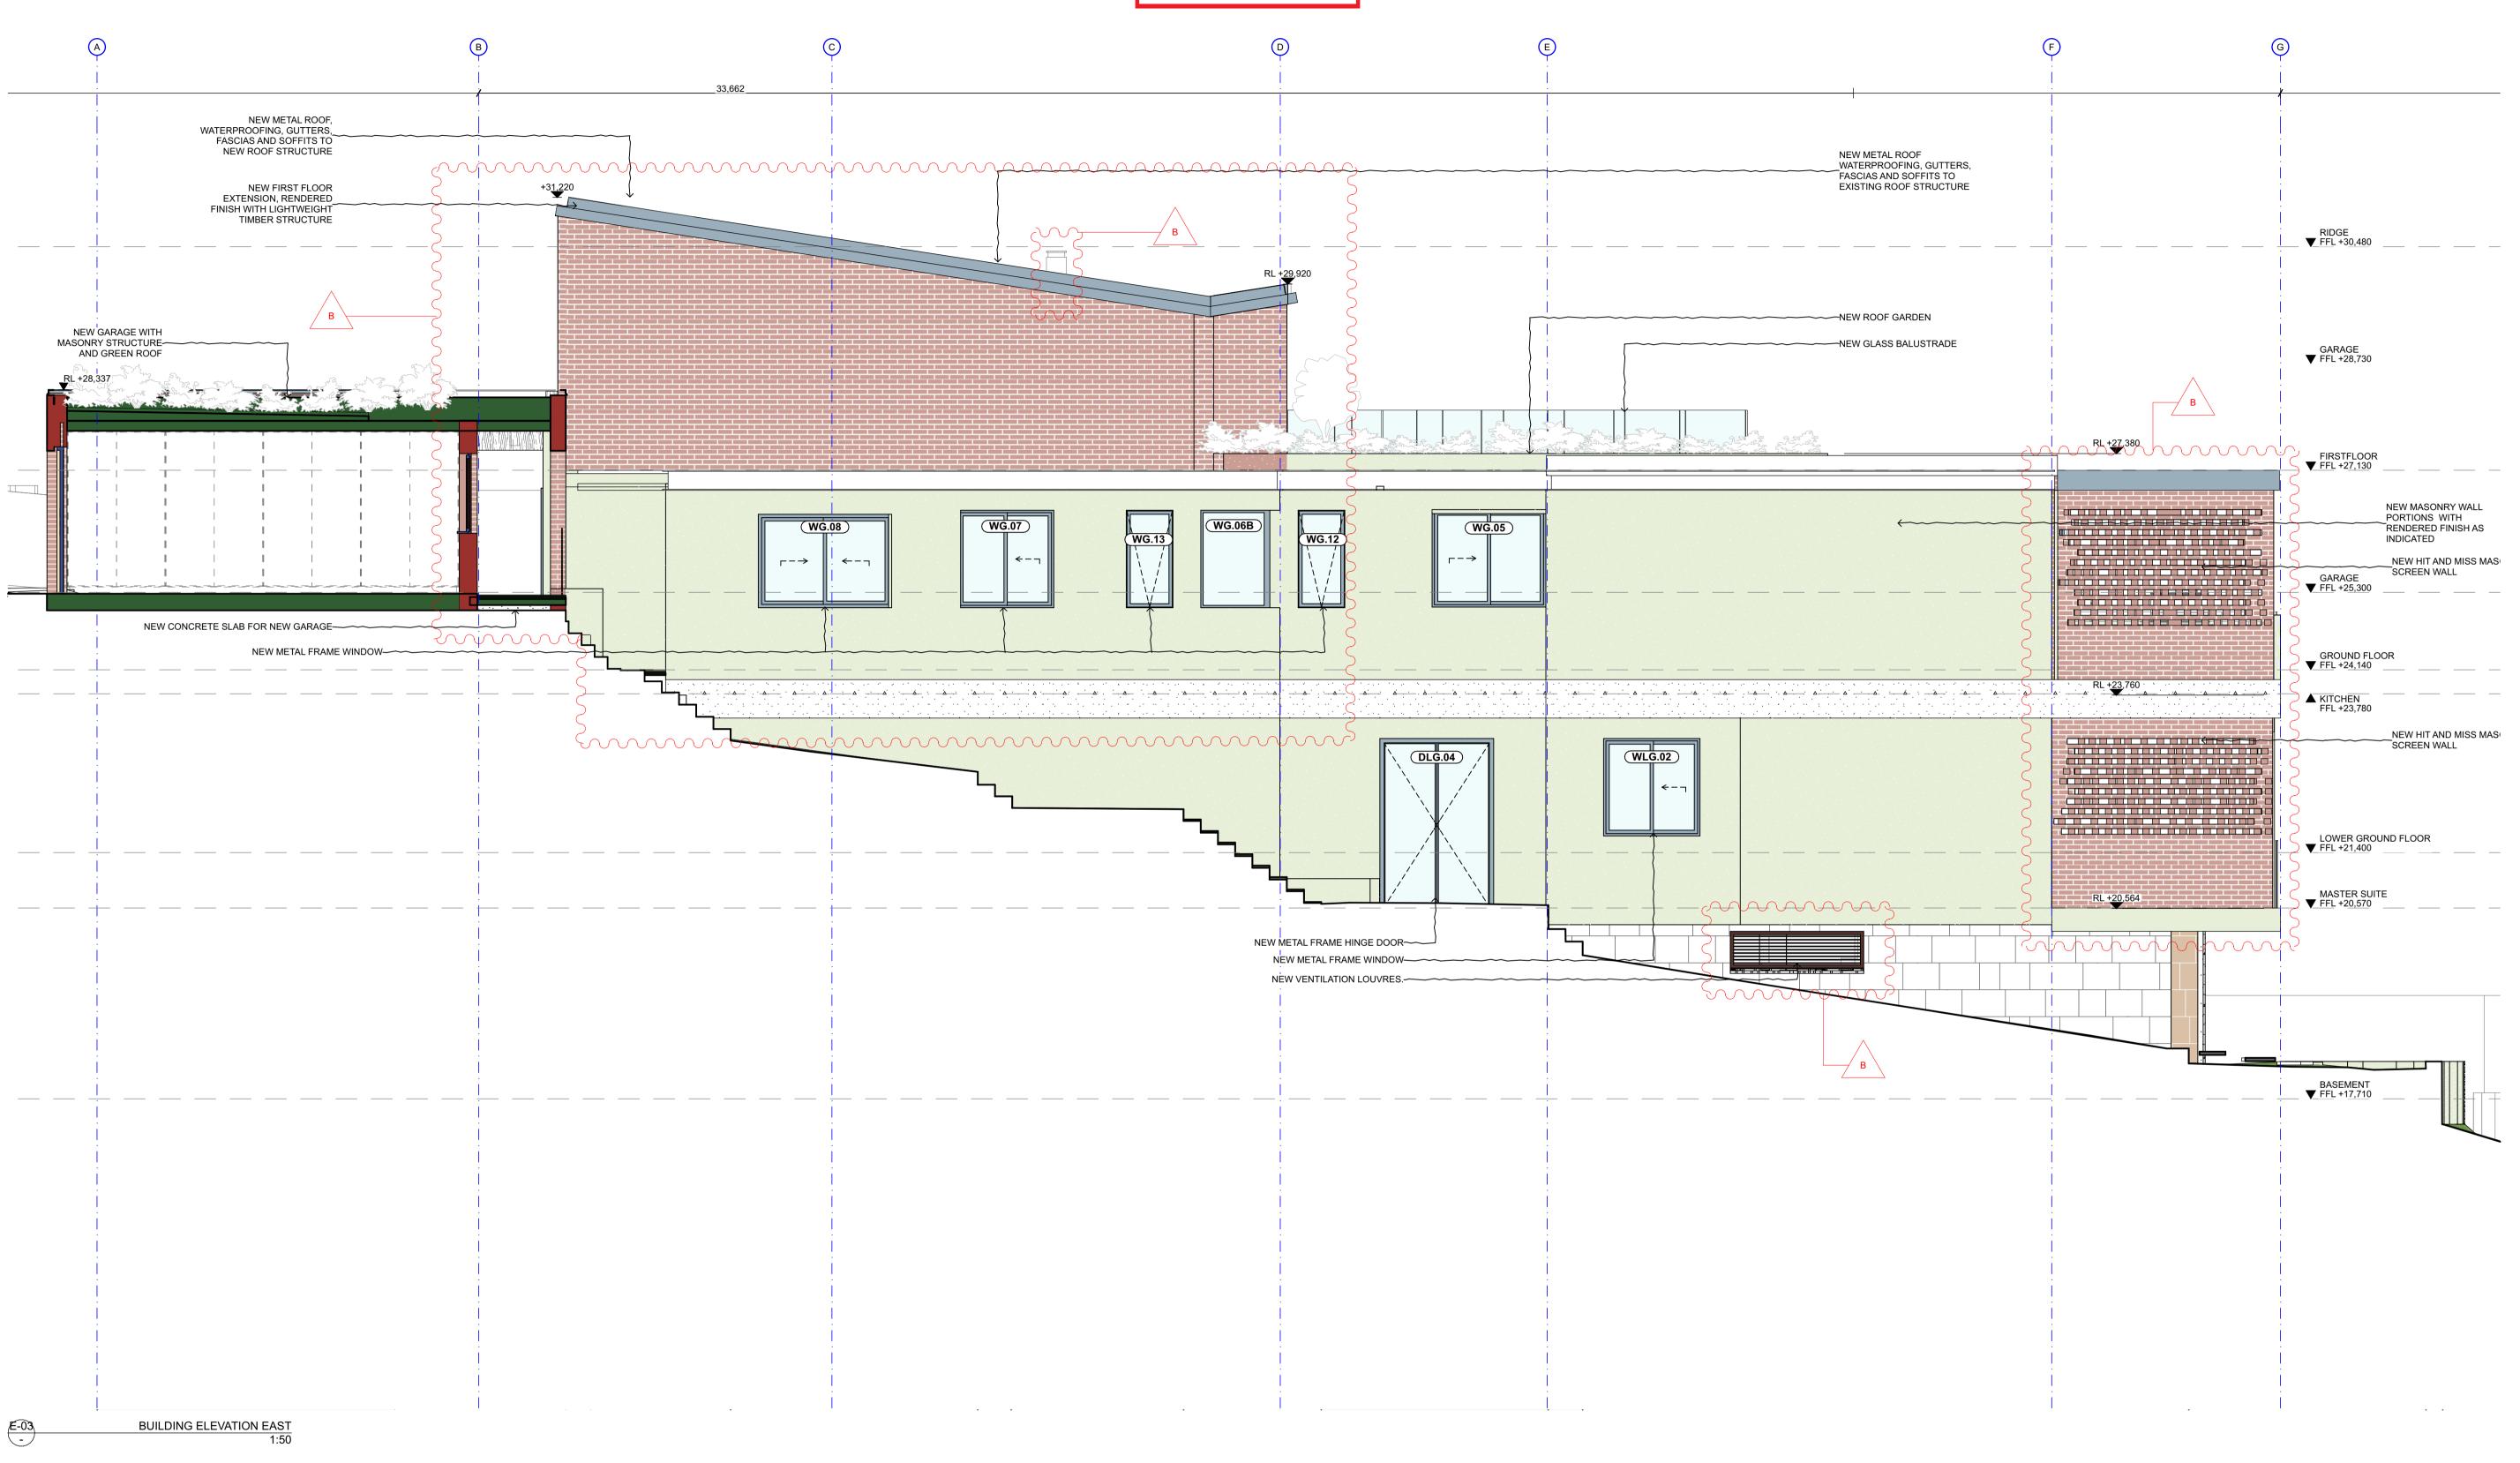

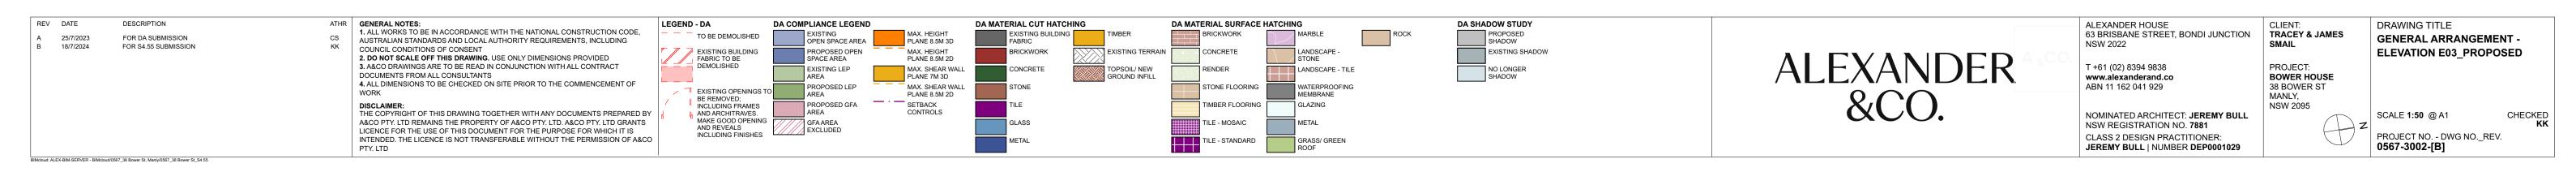

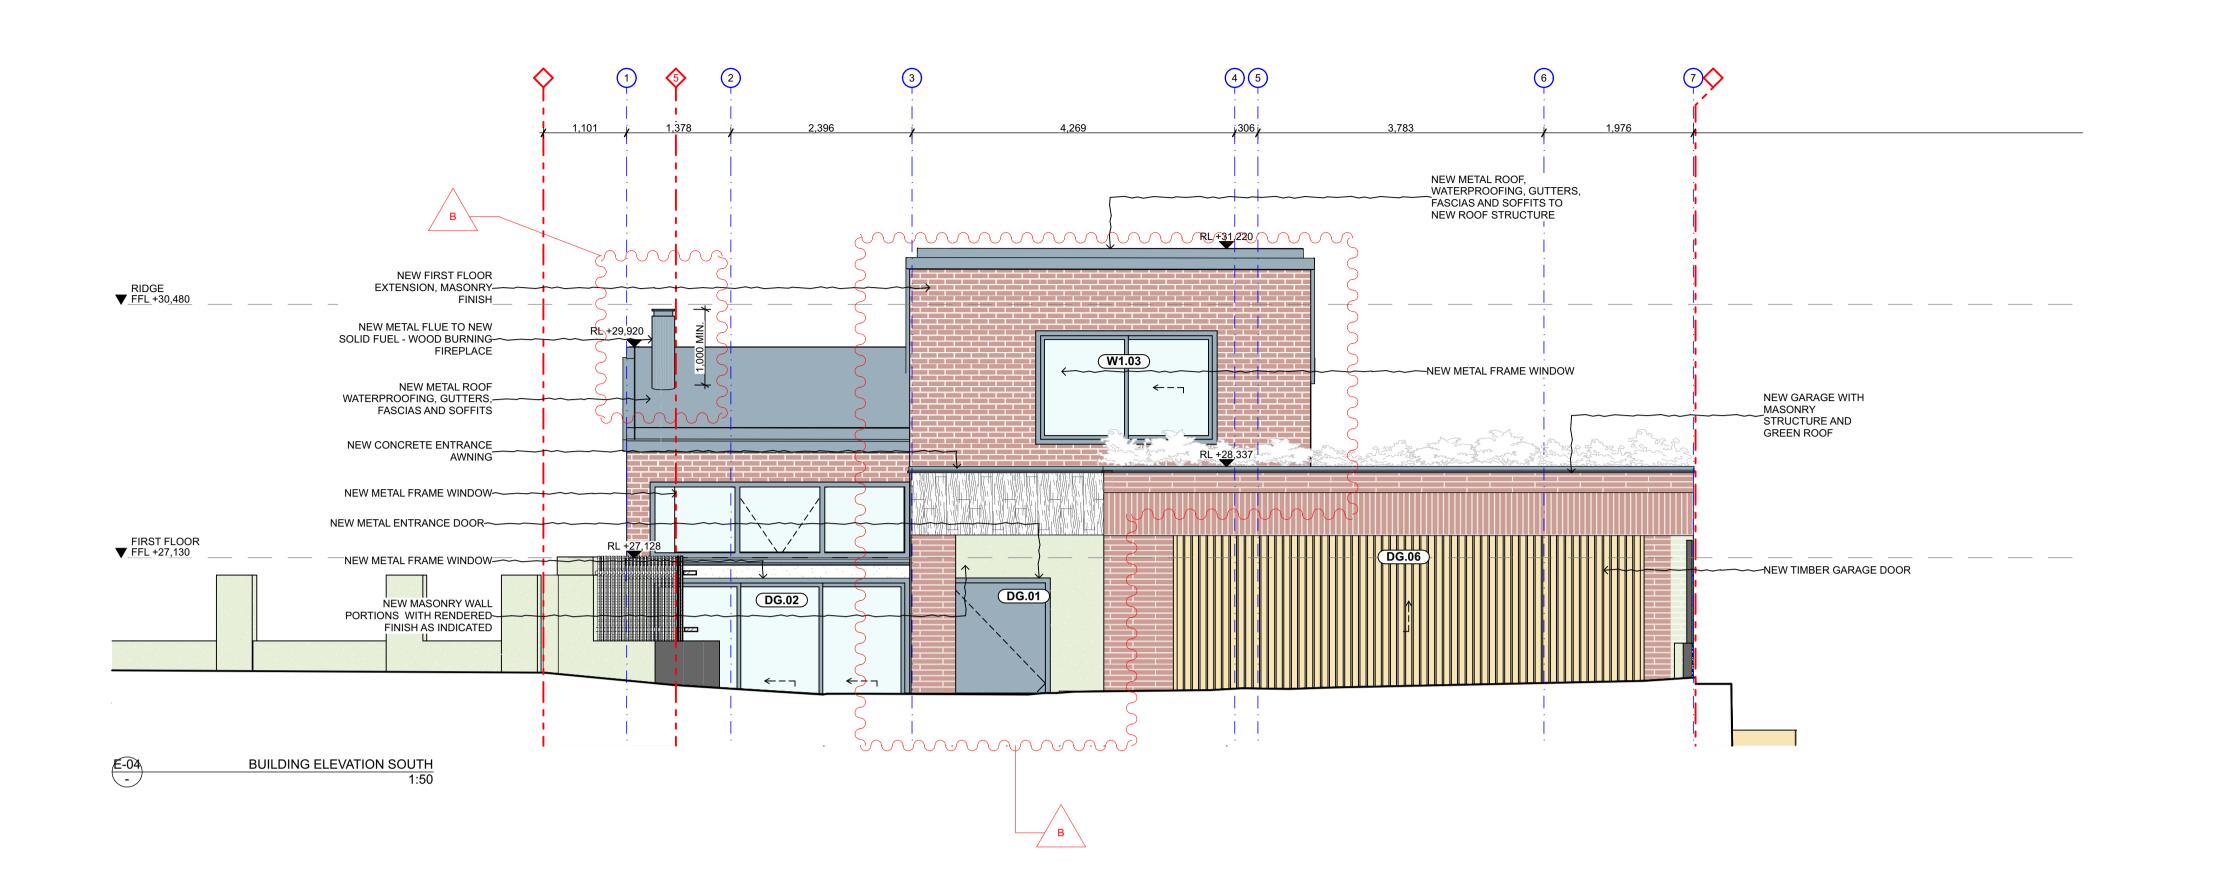

REV DATE DESCRIPTION A 25/7/2023 FOR DA SUBMISSION B 18/7/2024 FOR S4.55 SUBMISSION	ATHR CS KK GENERAL NOTES: 1. ALL WORKS TO BE IN ACCORDANCE WITH THE NATIONAL CONSTRUCTION CODE, AUSTRALIAN STANDARDS AND LOCAL AUTHORITY REQUIREMENTS, INCLUDING COUNCIL CONDITIONS OF CONSENT 2. DO NOT SCALE OFF THIS DRAWING. USE ONLY DIMENSIONS PROVIDED 3. A&CO DRAWINGS ARE TO BE READ IN CONJUNCTION WITH ALL CONTRACT DOCUMENTS FROM ALL CONSULTANTS 4. ALL DIMENSIONS TO BE CHECKED ON SITE PRIOR TO THE COMMENCEMENT OF WORK DISCLAIMER: THE COPYRIGHT OF THIS DRAWING TOGETHER WITH ANY DOCUMENTS PREPARED A&CO PTY. LTD REMAINS THE PROPERTY OF A&CO PTY. LTD. A&CO PTY. LTD GRANT: LICENCE FOR THE USE OF THIS DOCUMENT FOR THE PURPOSE FOR WHICH IT IS INTENDED. THE LICENCE IS NOT TRANSFERABLE WITHOUT THE PERMISSION OF A&CO.	LEGEND - DA TO BE DEMOLISHI FABRIC TO BE DEMOLISHED EXISTING OPENIN BE REMOVED; INCLUDING FRAM AND ARCHITRAVE MAKE GOOD OPE AND REVEALS INCLUDING FINISH	OPEN SPACE AREA PLANE 8.5M 3L PROPOSED OPEN SPACE AREA PLANE 8.5M 3L MAX. HEIGHT PLANE 8.5M 2L MAX. SHEAR W PLANE 7M 3D PROPOSED LEP AREA PLANE 7M 3D MAX. SHEAR W PLANE 7M 3D SETBACK PROPOSED GFA SETBACK	GROUND INFIL	STONE RENDER LANDSCAPE - TILE STONE FLOORING WATERPROOFING MEMBRANE TIMBER FLOORING GLAZING METAL	DA SHADOW STUDY PROPOSED SHADOW EXISTING SHADOW NO LONGER SHADOW	ALEXANDER &CO.	ALEXANDER HOUSE 63 BRISBANE STREET, BONDI JUNCTION NSW 2022 T +61 (02) 8394 9838 www.alexanderand.co ABN 11 162 041 929 NOMINATED ARCHITECT: JEREMY BULL NSW REGISTRATION NO. 7881 CLASS 2 DESIGN PRACTITIONER:	CLIENT: TRACEY & JAMES SMAIL PROJECT: BOWER HOUSE 38 BOWER ST MANLY, NSW 2095	DRAWING TITLE GENERAL ARRANGEMENT - ELEVATION E04 _PROPOSED SCALE 1:50 @ A1 CHECKED KK PROJECT NO DWG NOREV.
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DA MATERIAL SURFACE HATCHING

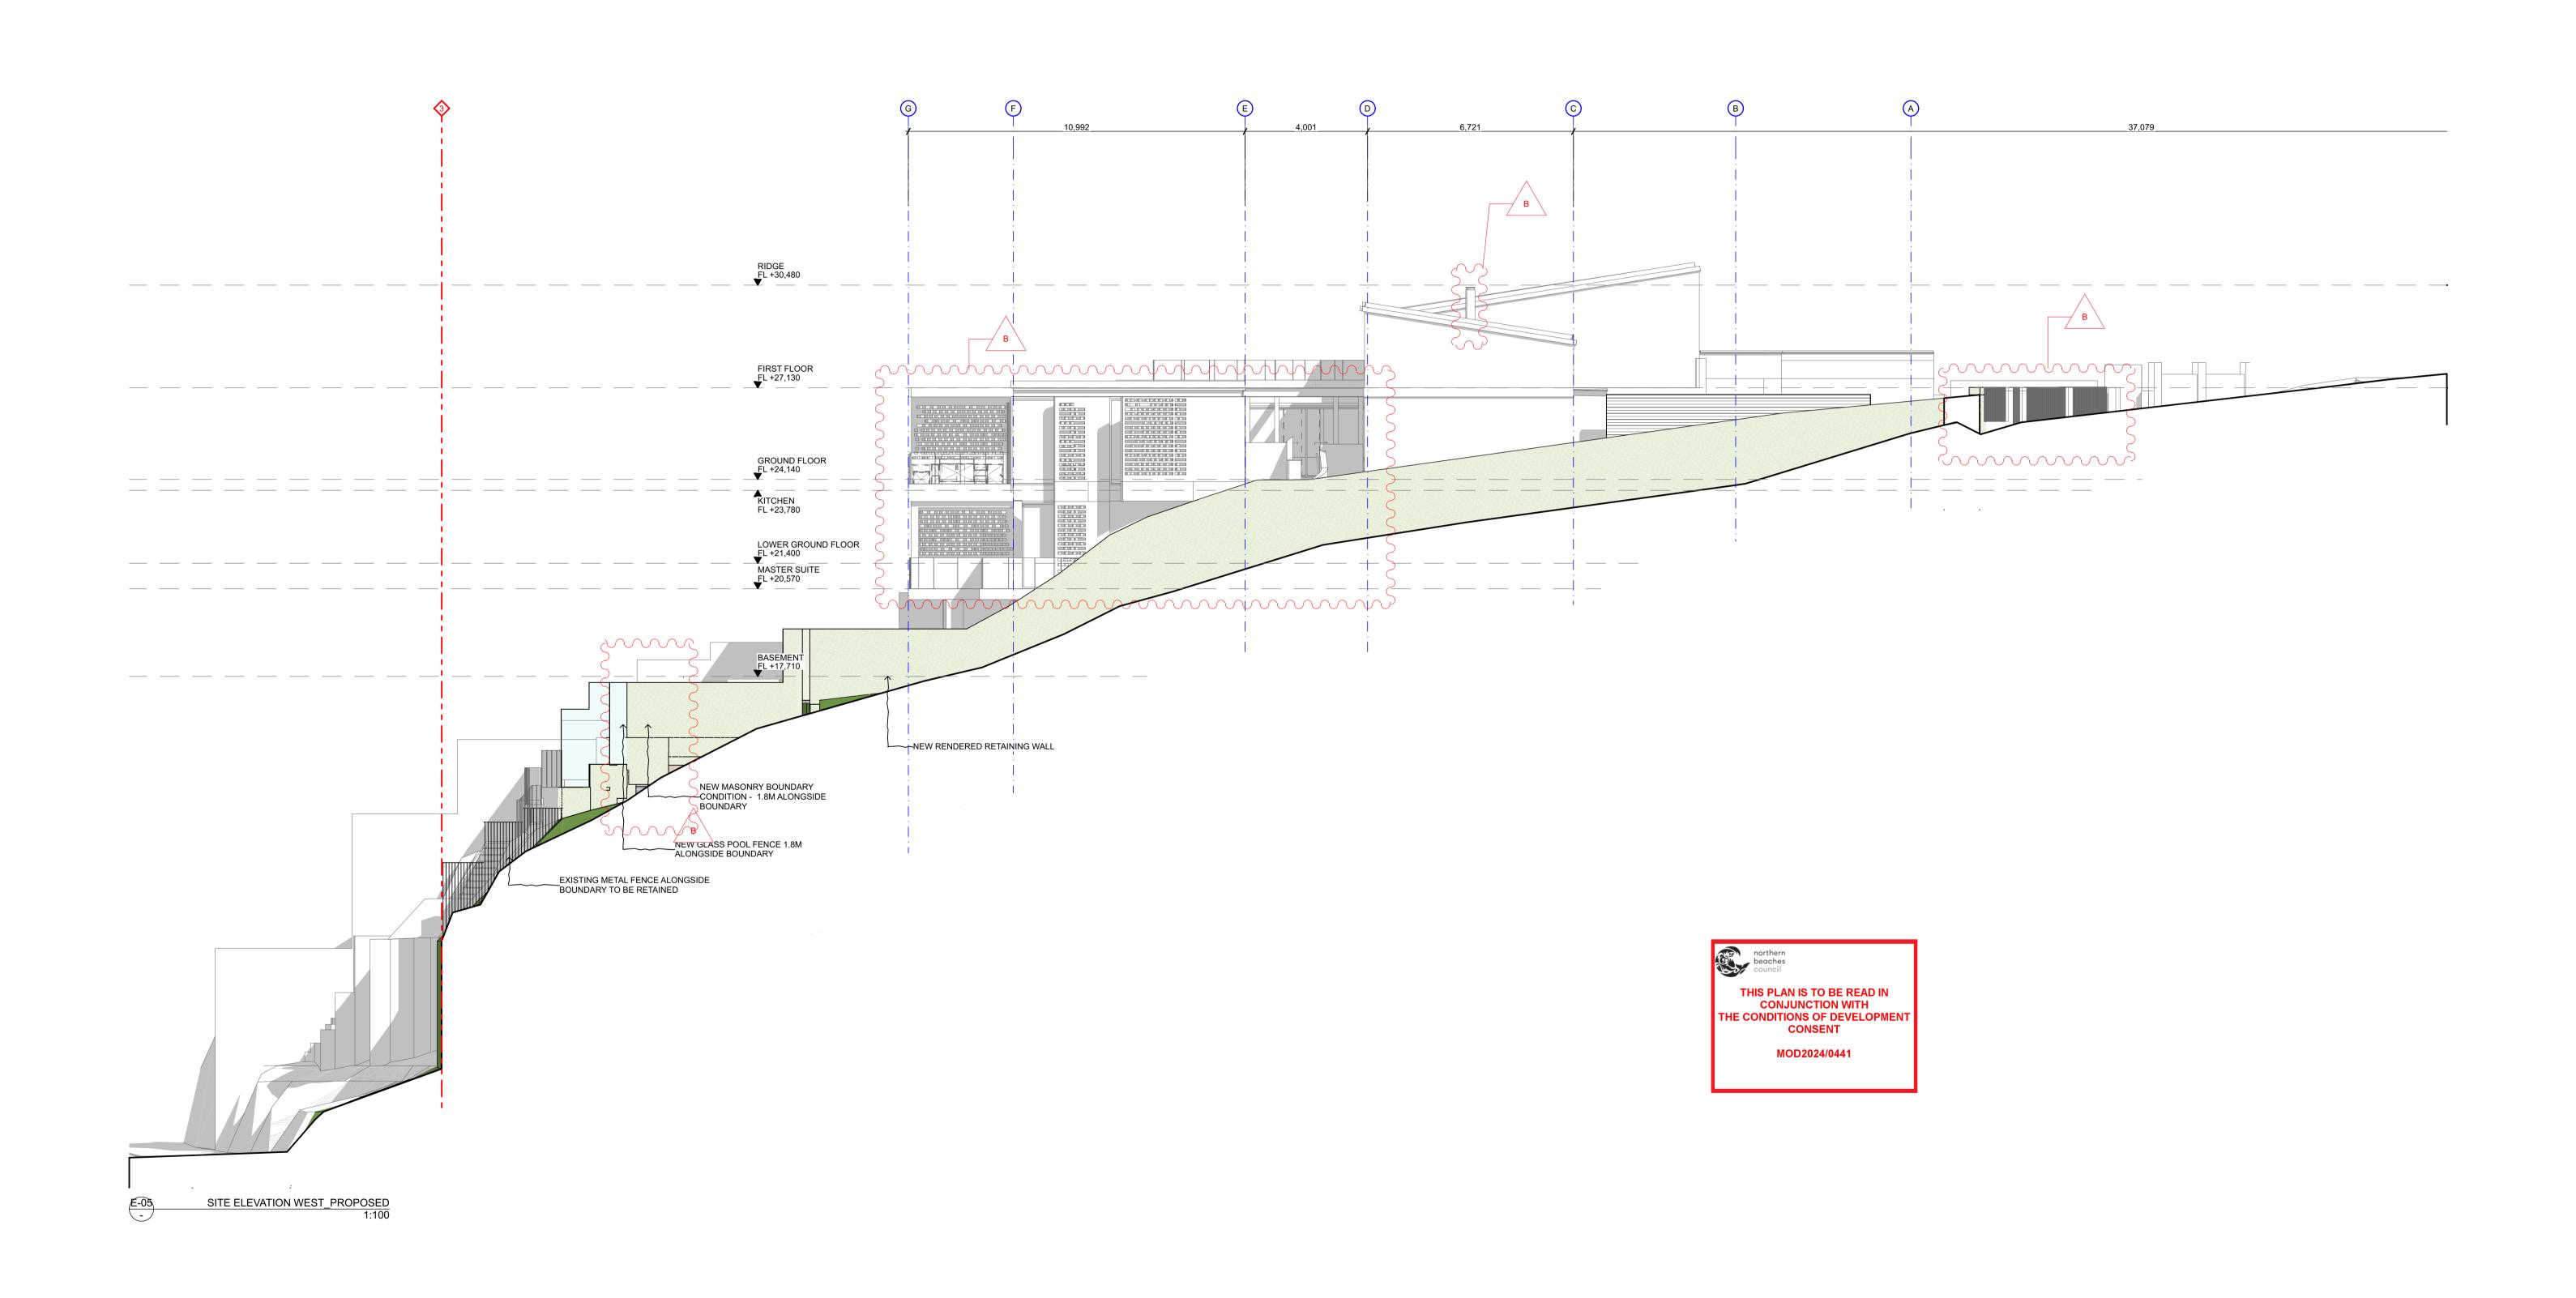LANDSCAPE - TILE

GLAZING

DA SHADOW STUDY

EXISTING SHADOW

ALEXANDER HOUSE
63 BRISBANE STREET, BONDI JUNCTION
NSW 2022

CLIENT:
TRACEY & JAMES
SMAIL

PROJECT:

MANLY,

NSW 2095

BOWER HOUSE 38 BOWER ST

T +61 (02) 8394 9838 www.alexanderand.co ABN 11 162 041 929

NOMINATED ARCHITECT: **JEREMY BULL**

CLASS 2 DESIGN PRACTITIONER: JEREMY BULL | NUMBER DEP0001029

NSW REGISTRATION NO. 7881

ALEXANDER &CO.

DRAWING TITLE

E05_PROPOSED

SCALE 1:100 @ A1

0567-3100-[B]

PROJECT NO. - DWG NO._REV.

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CHECKED **KK**

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DA COMPLIANCE LEGEND

EXISTING OPEN SPACE AREA

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EXISTING LEP AREA

MAX. HEIGHT PLANE 8.5M 3D

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MAX. SHEAR WALL PLANE 8.5M 2D

SETBACK CONTROLS

DA MATERIAL CUT HATCHING

CONCRETE

EXISTING BUILDING

REV DATE

A 25/7/2023 B 18/7/2024


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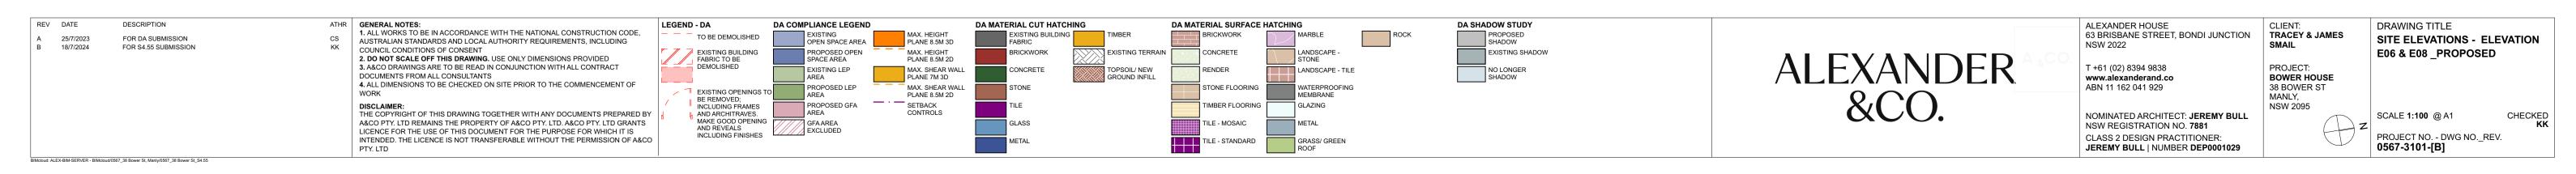
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FOR DA SUBMISSION FOR S4.55 SUBMISSION












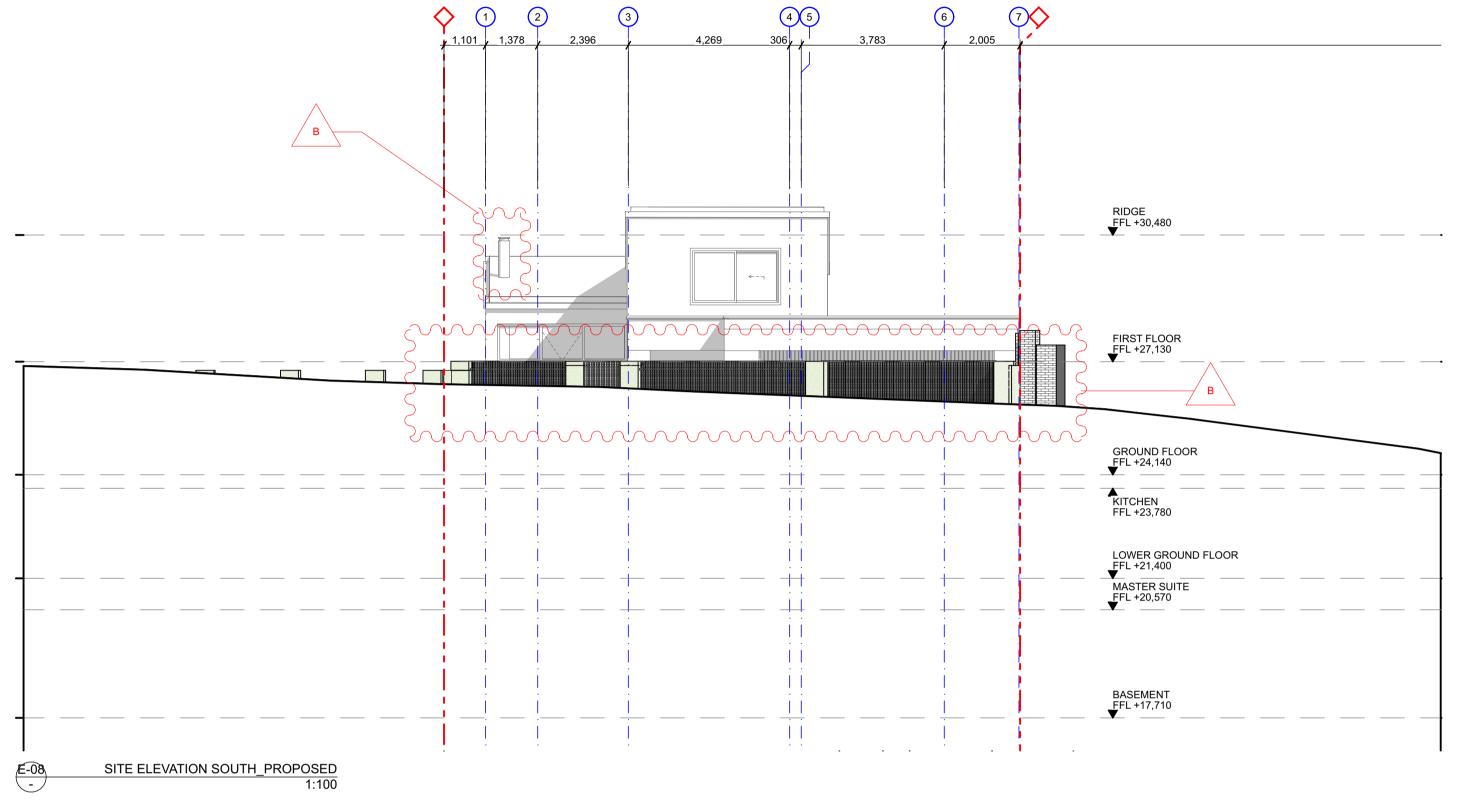

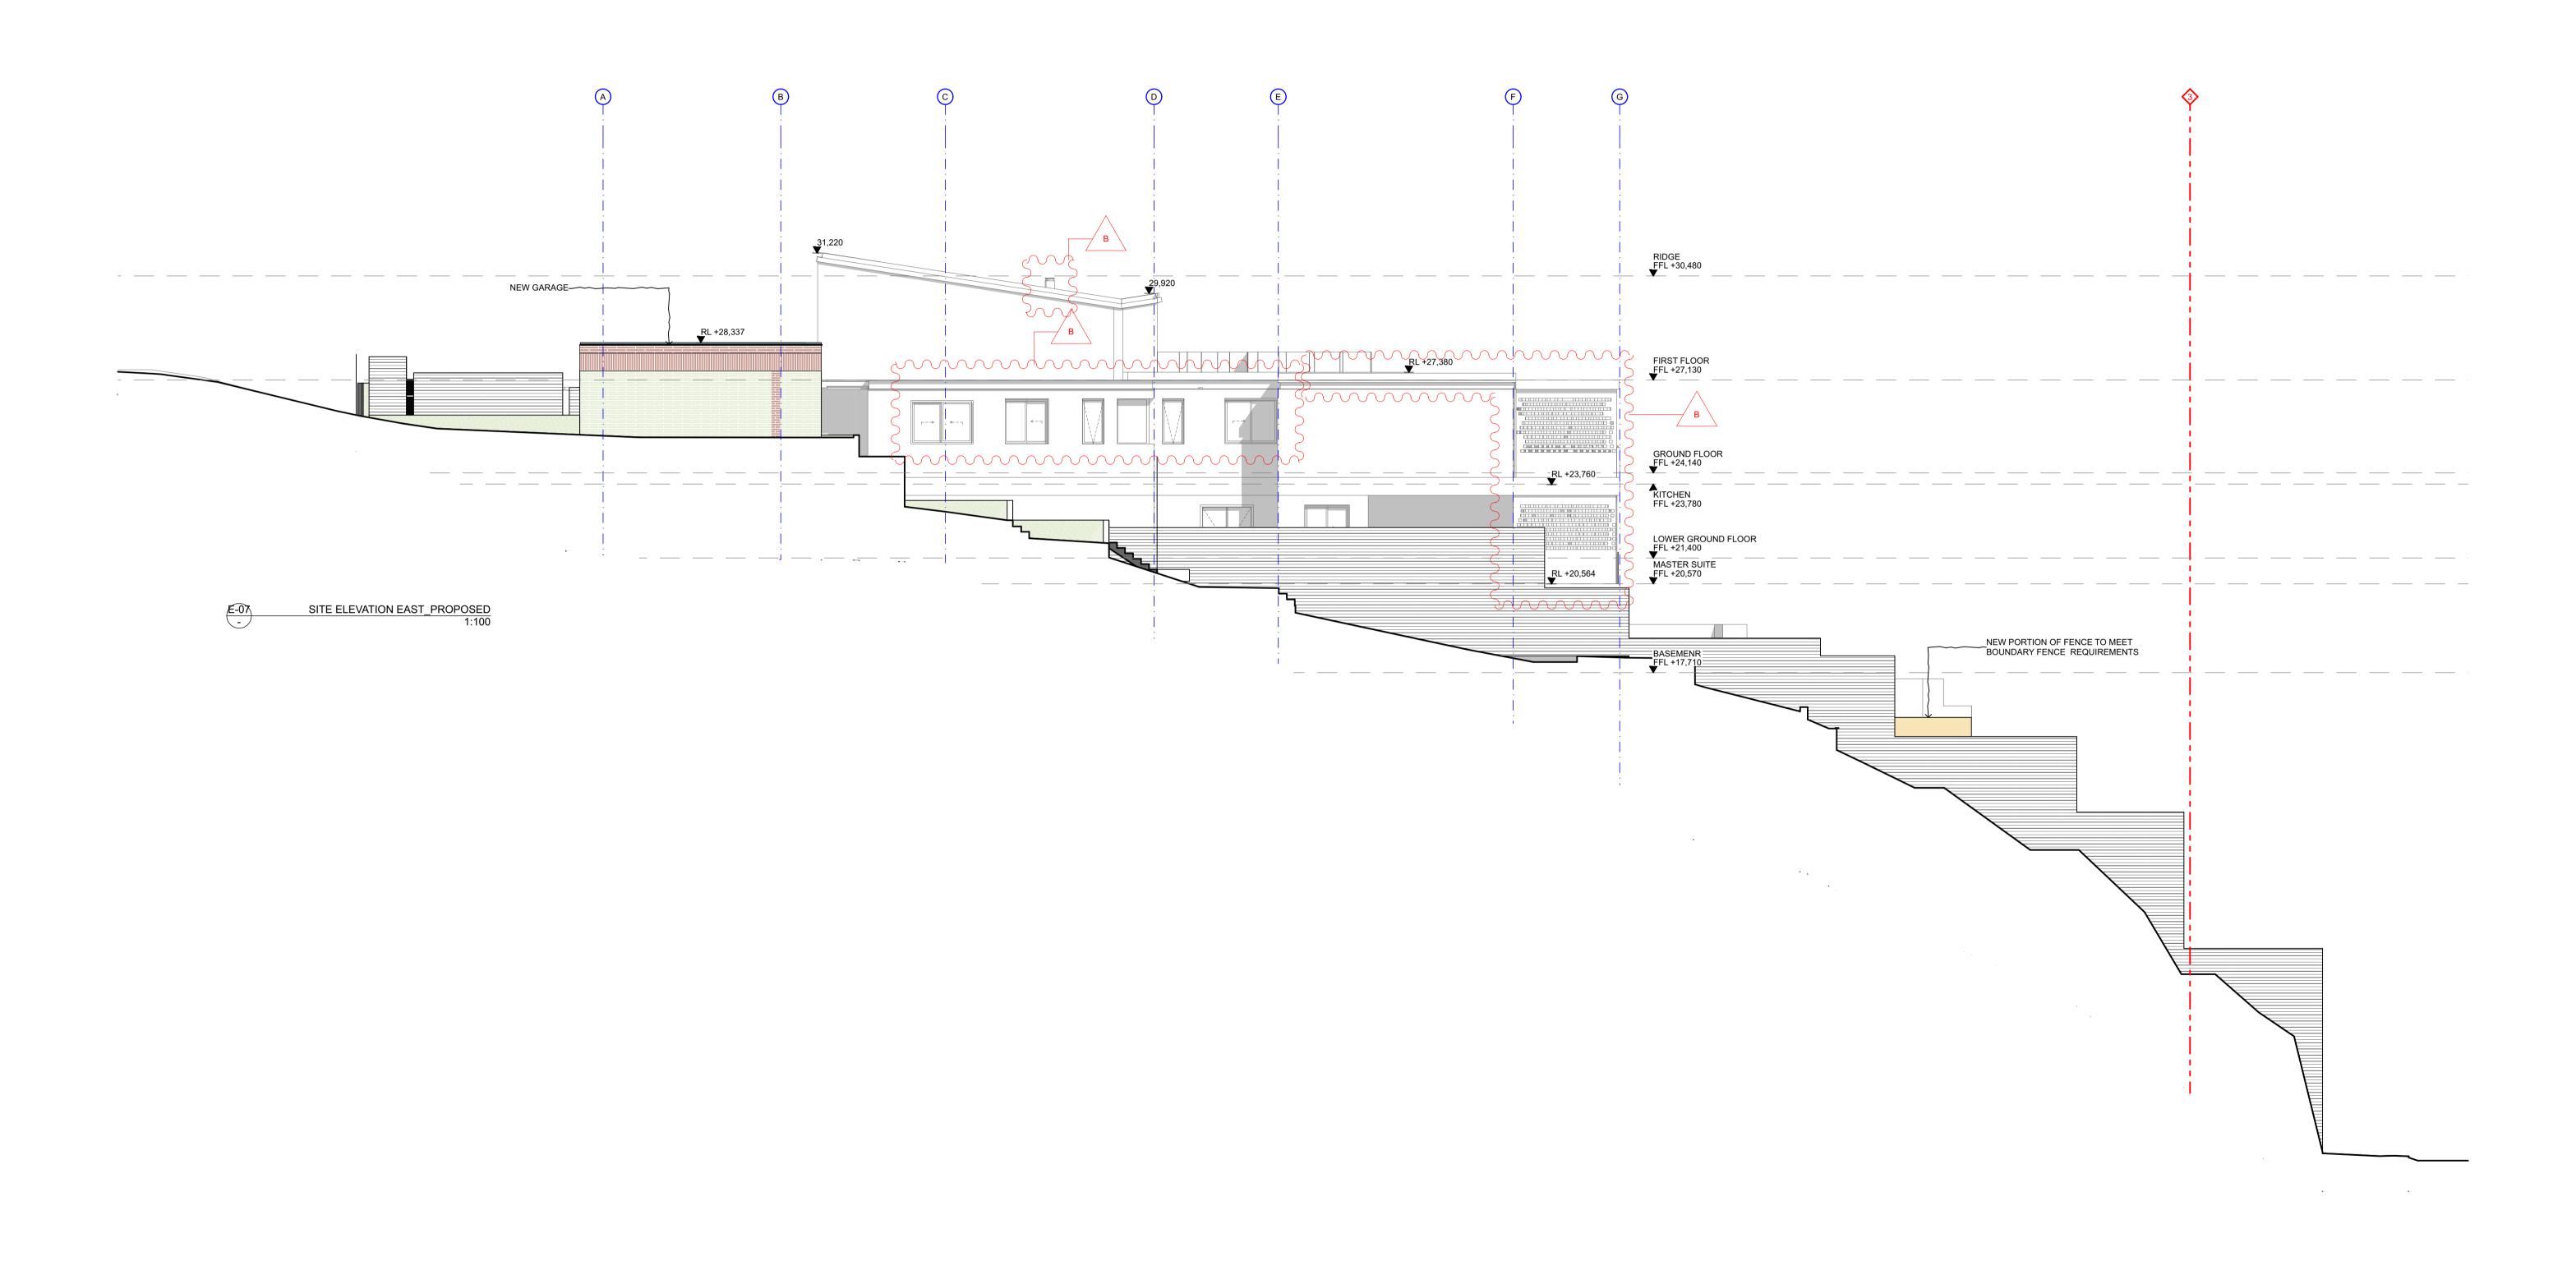

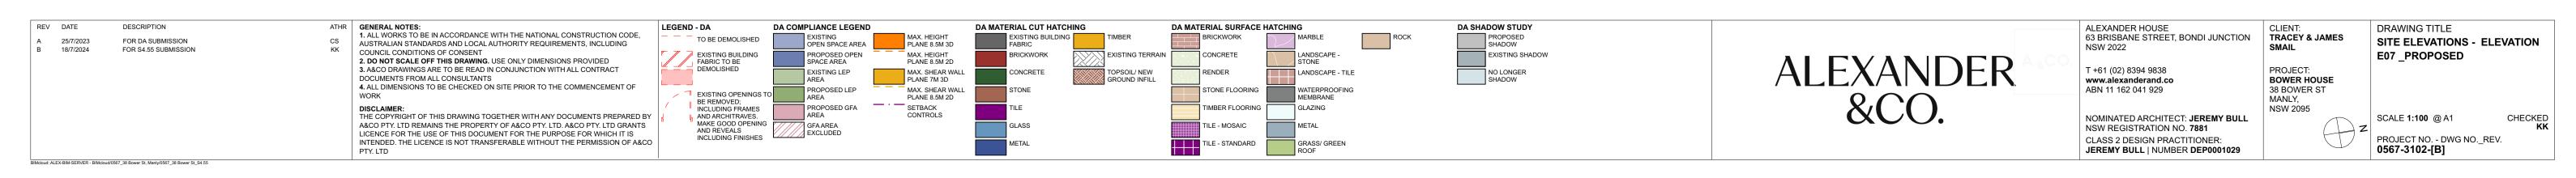

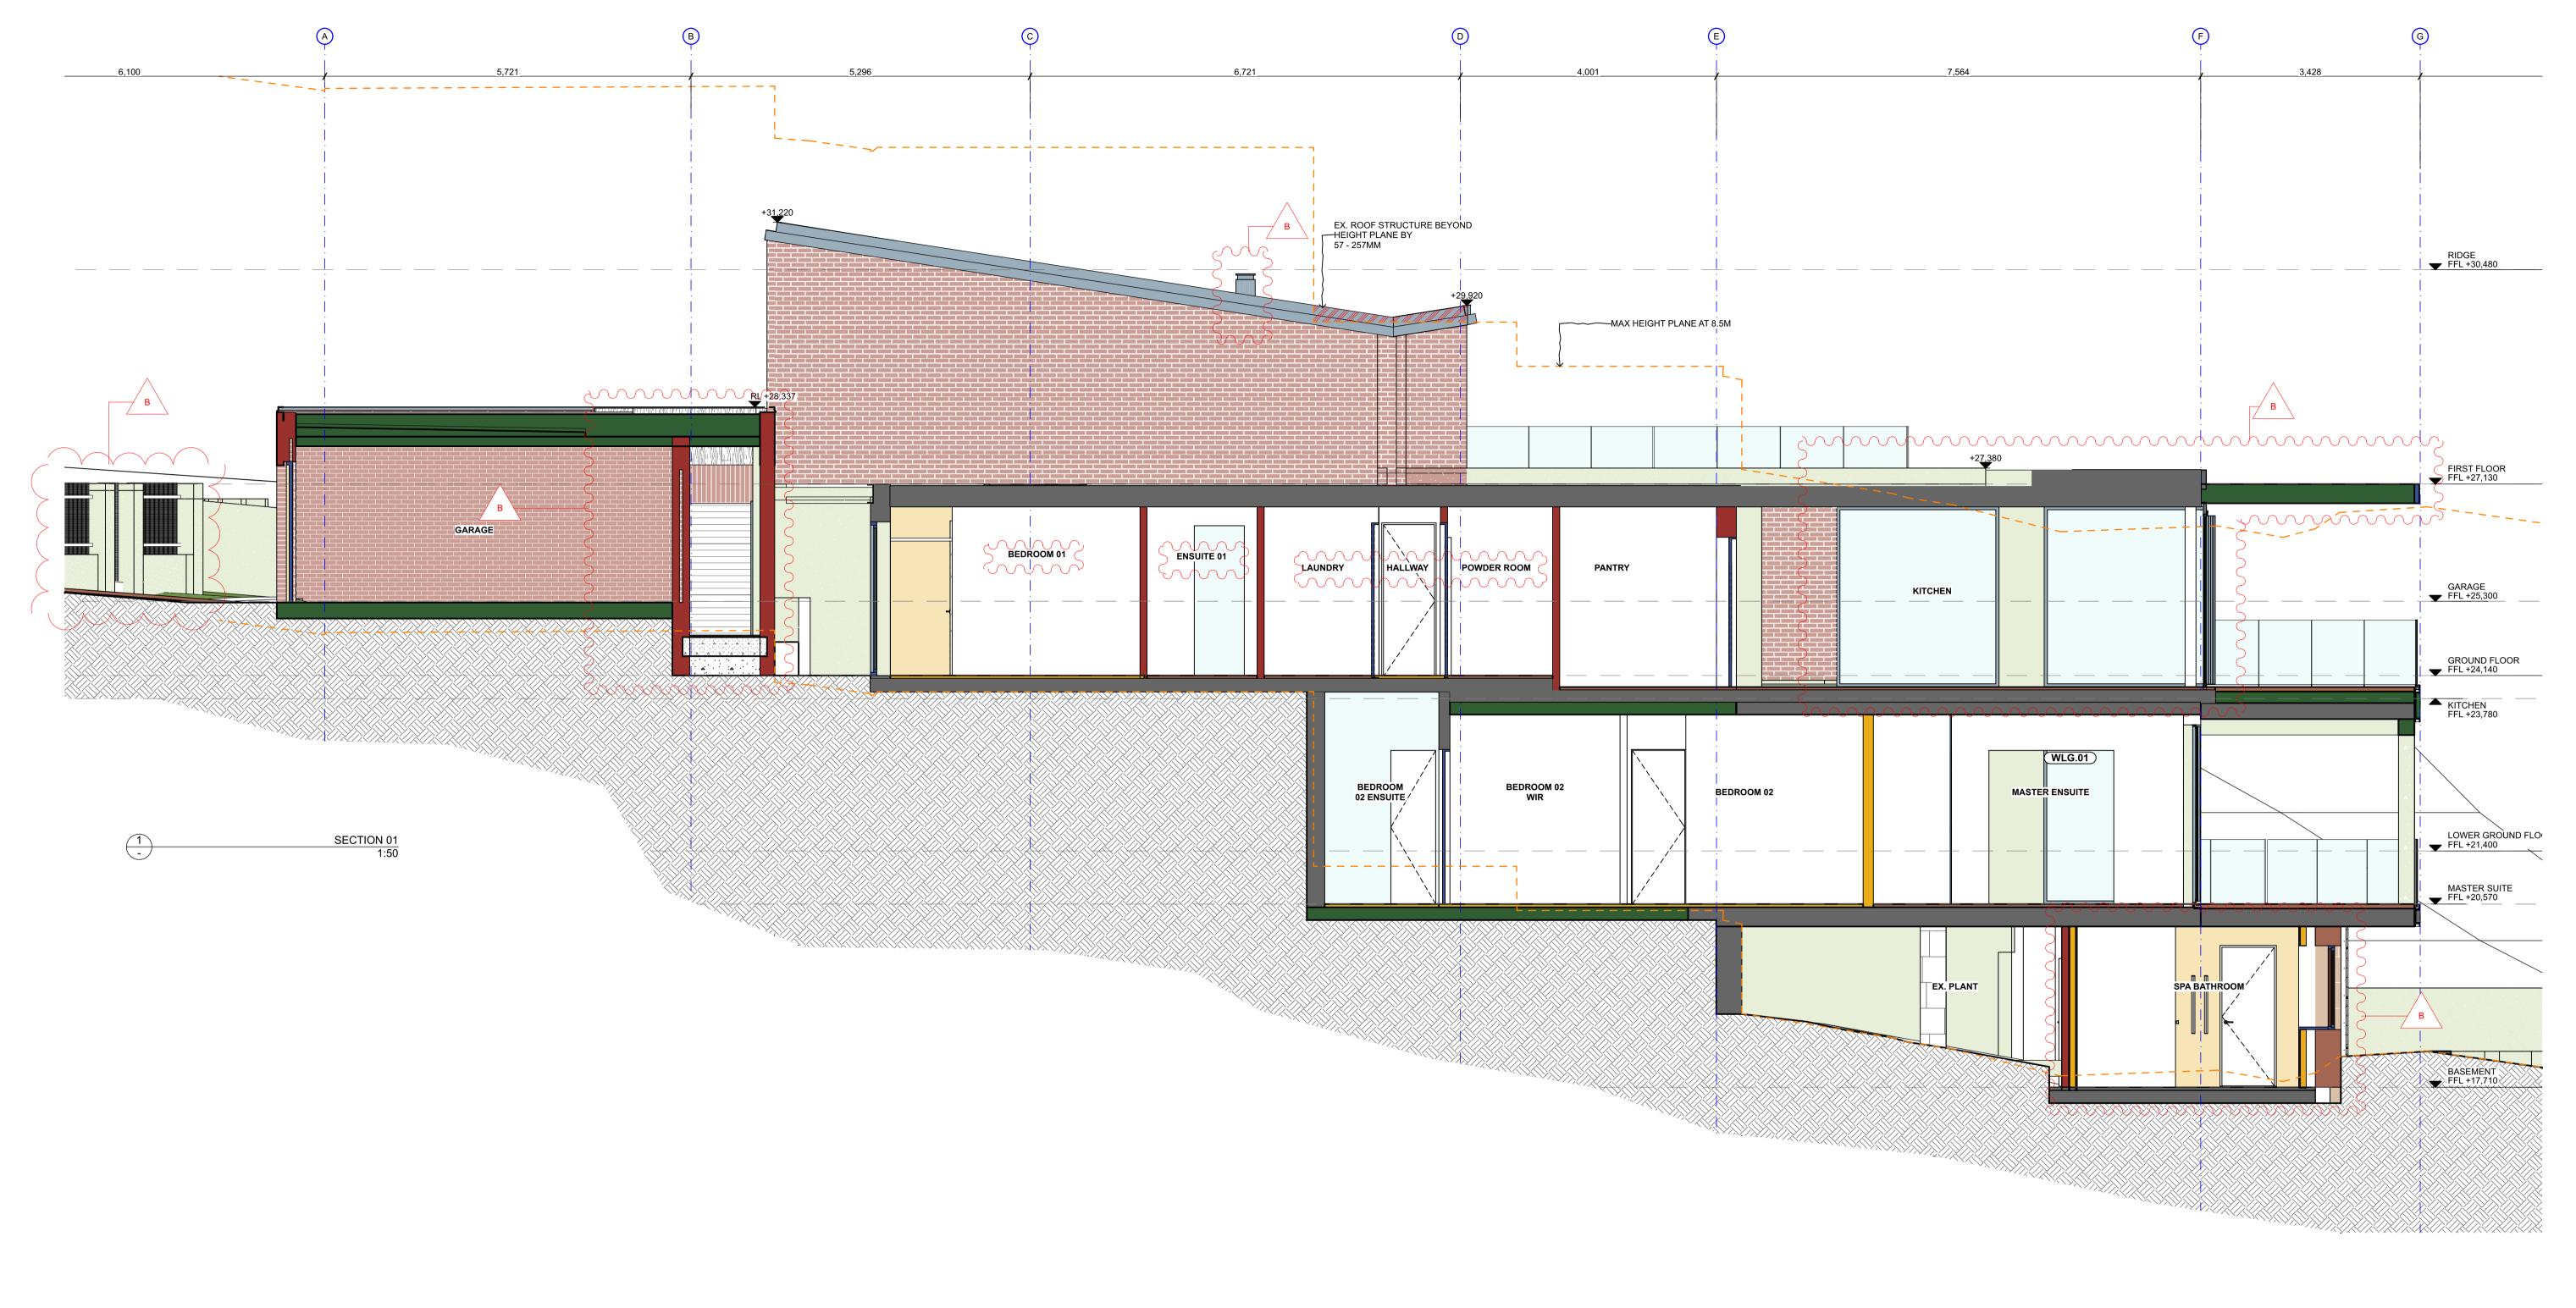




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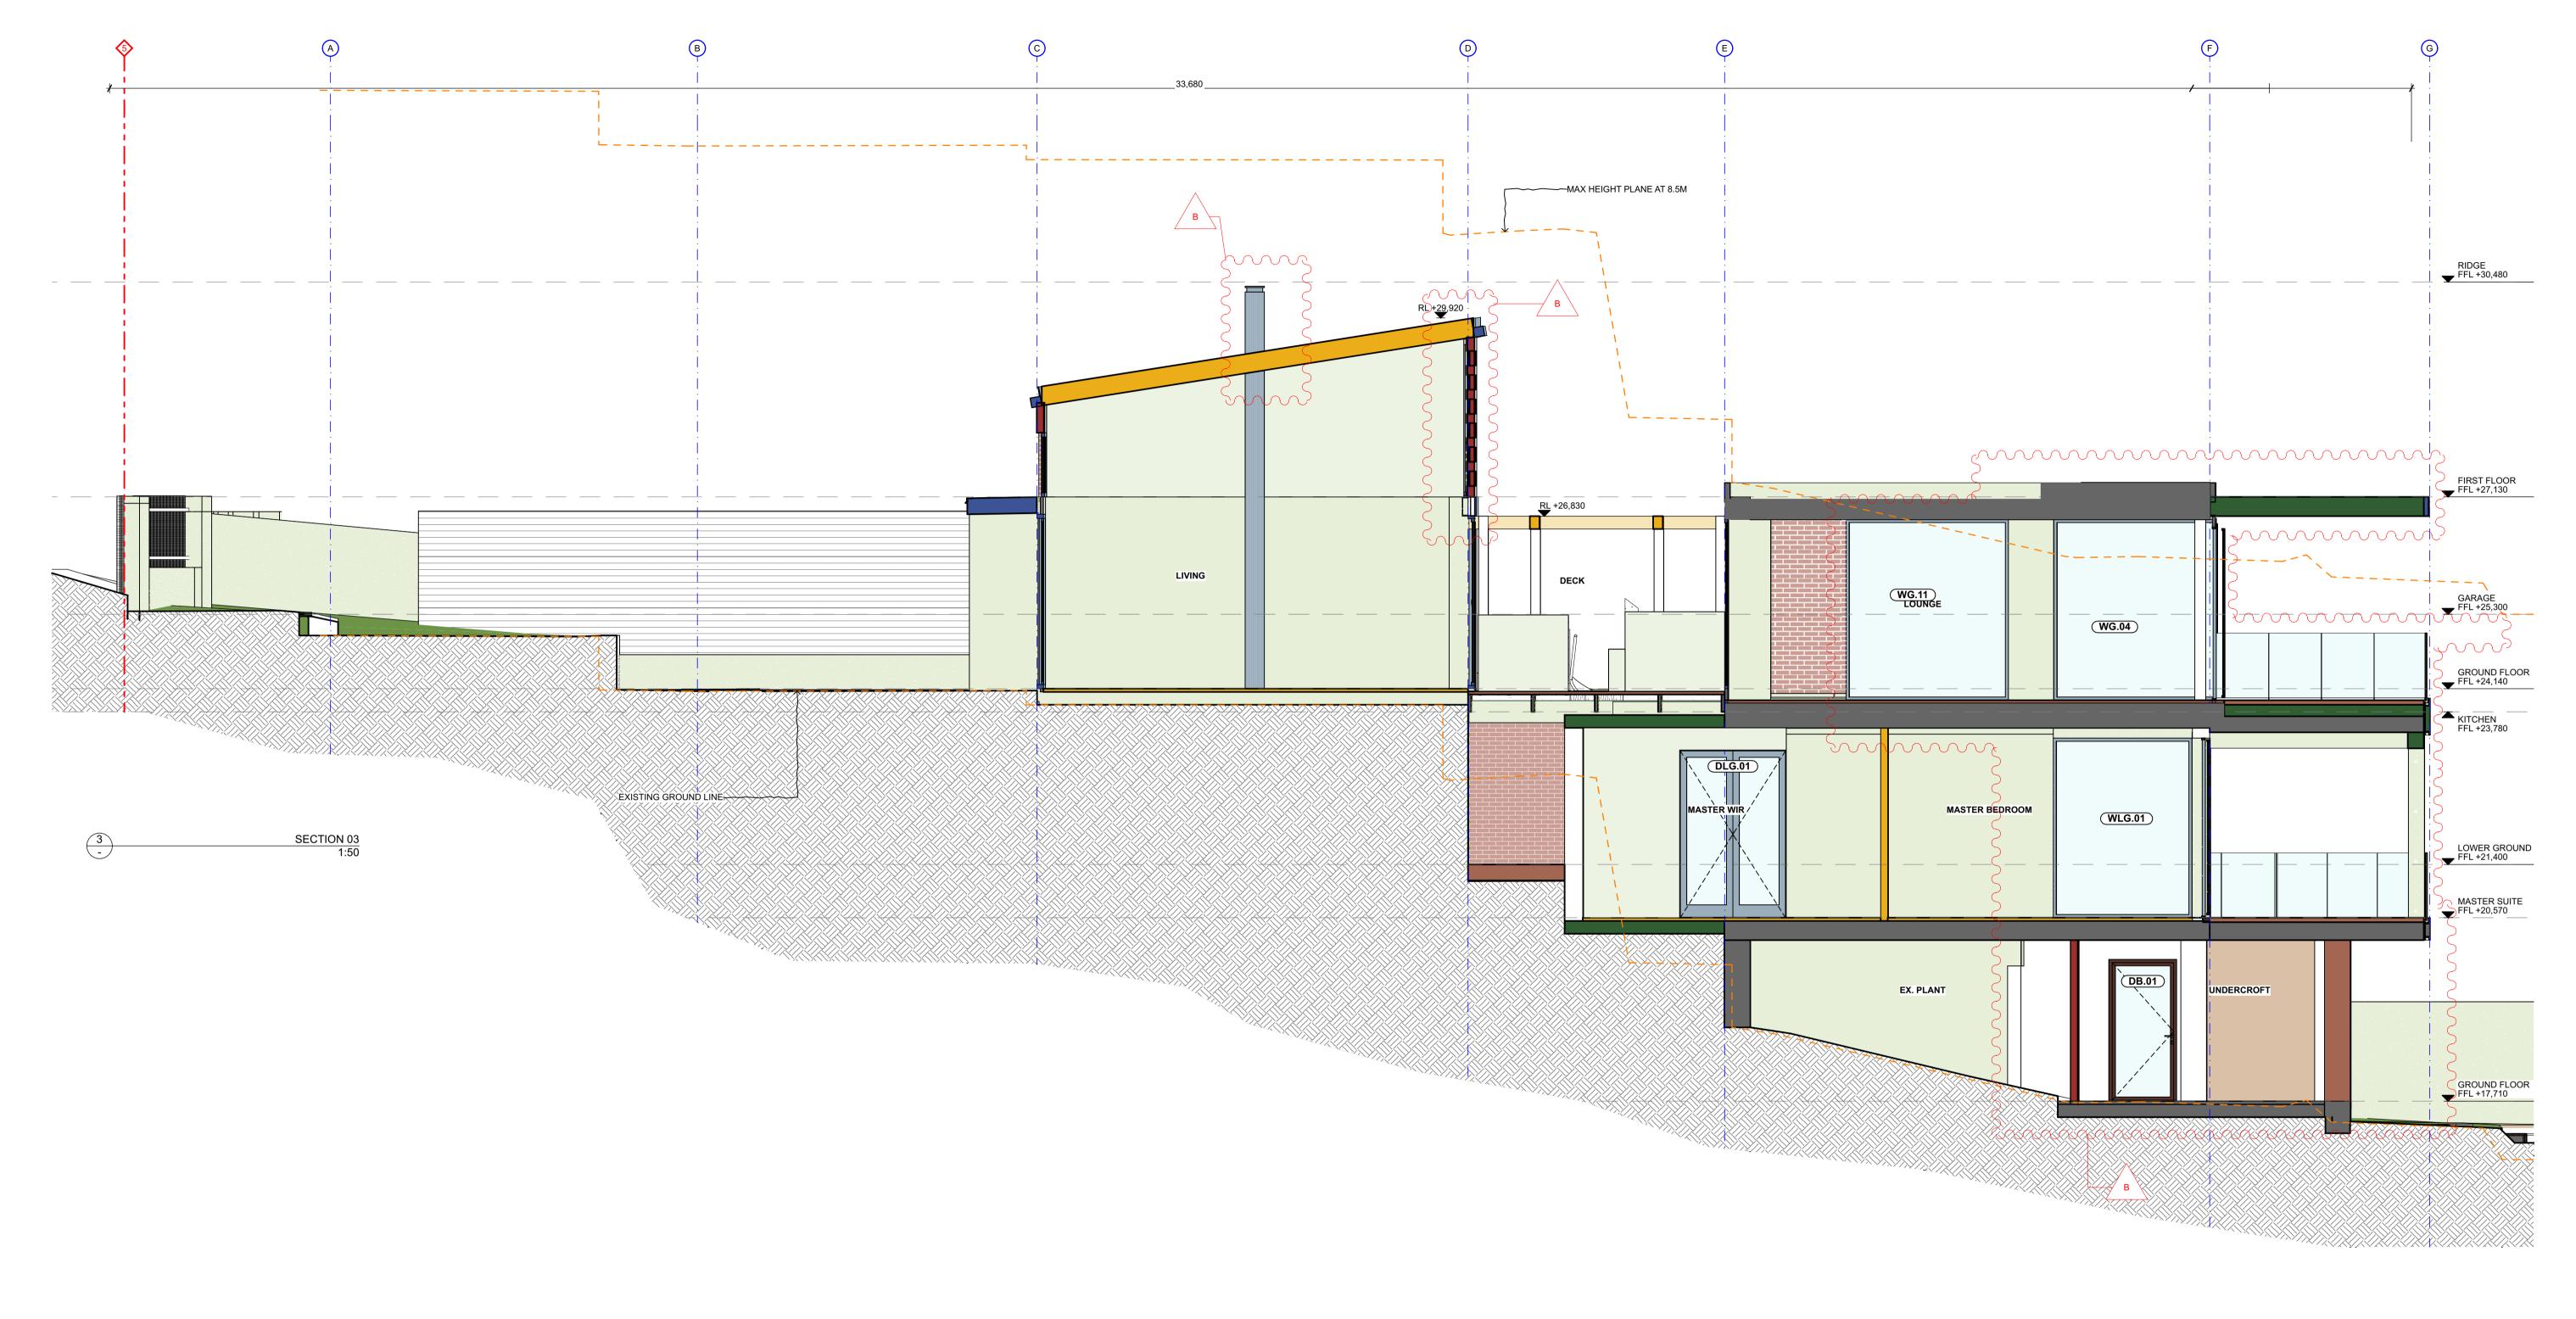
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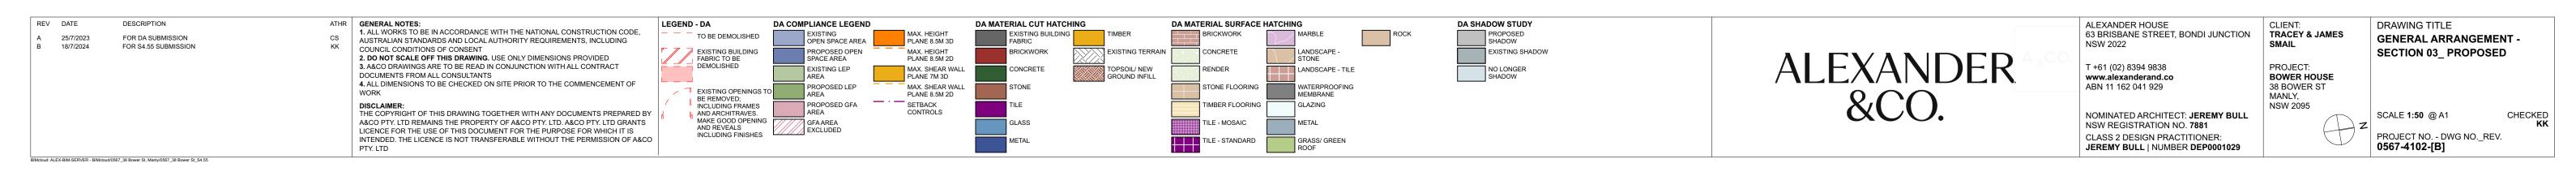




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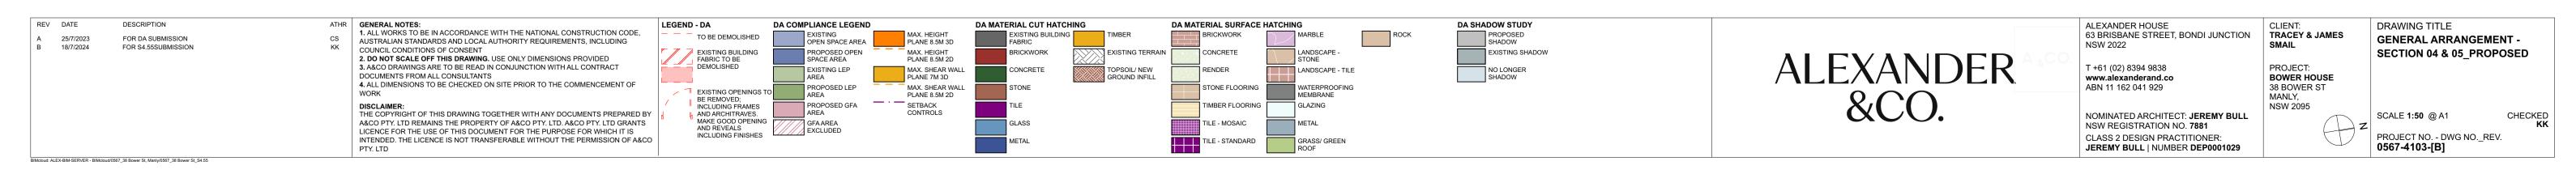








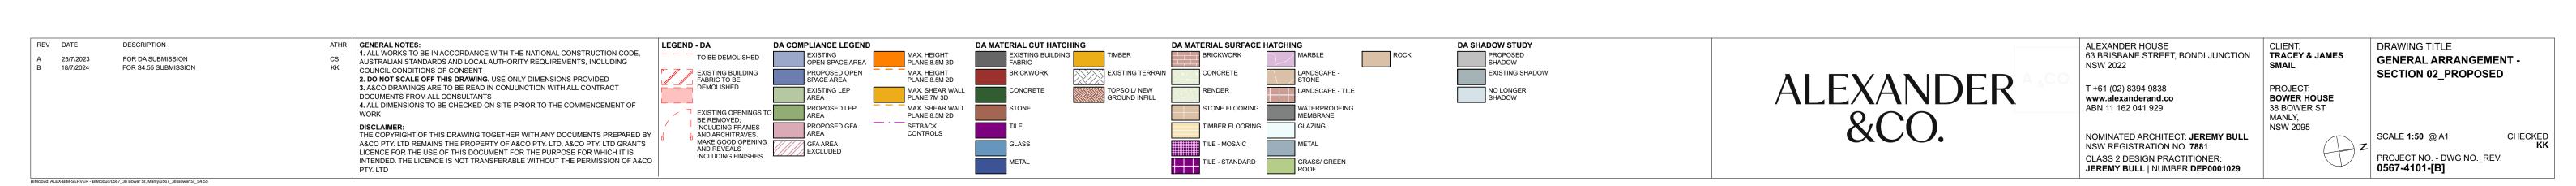






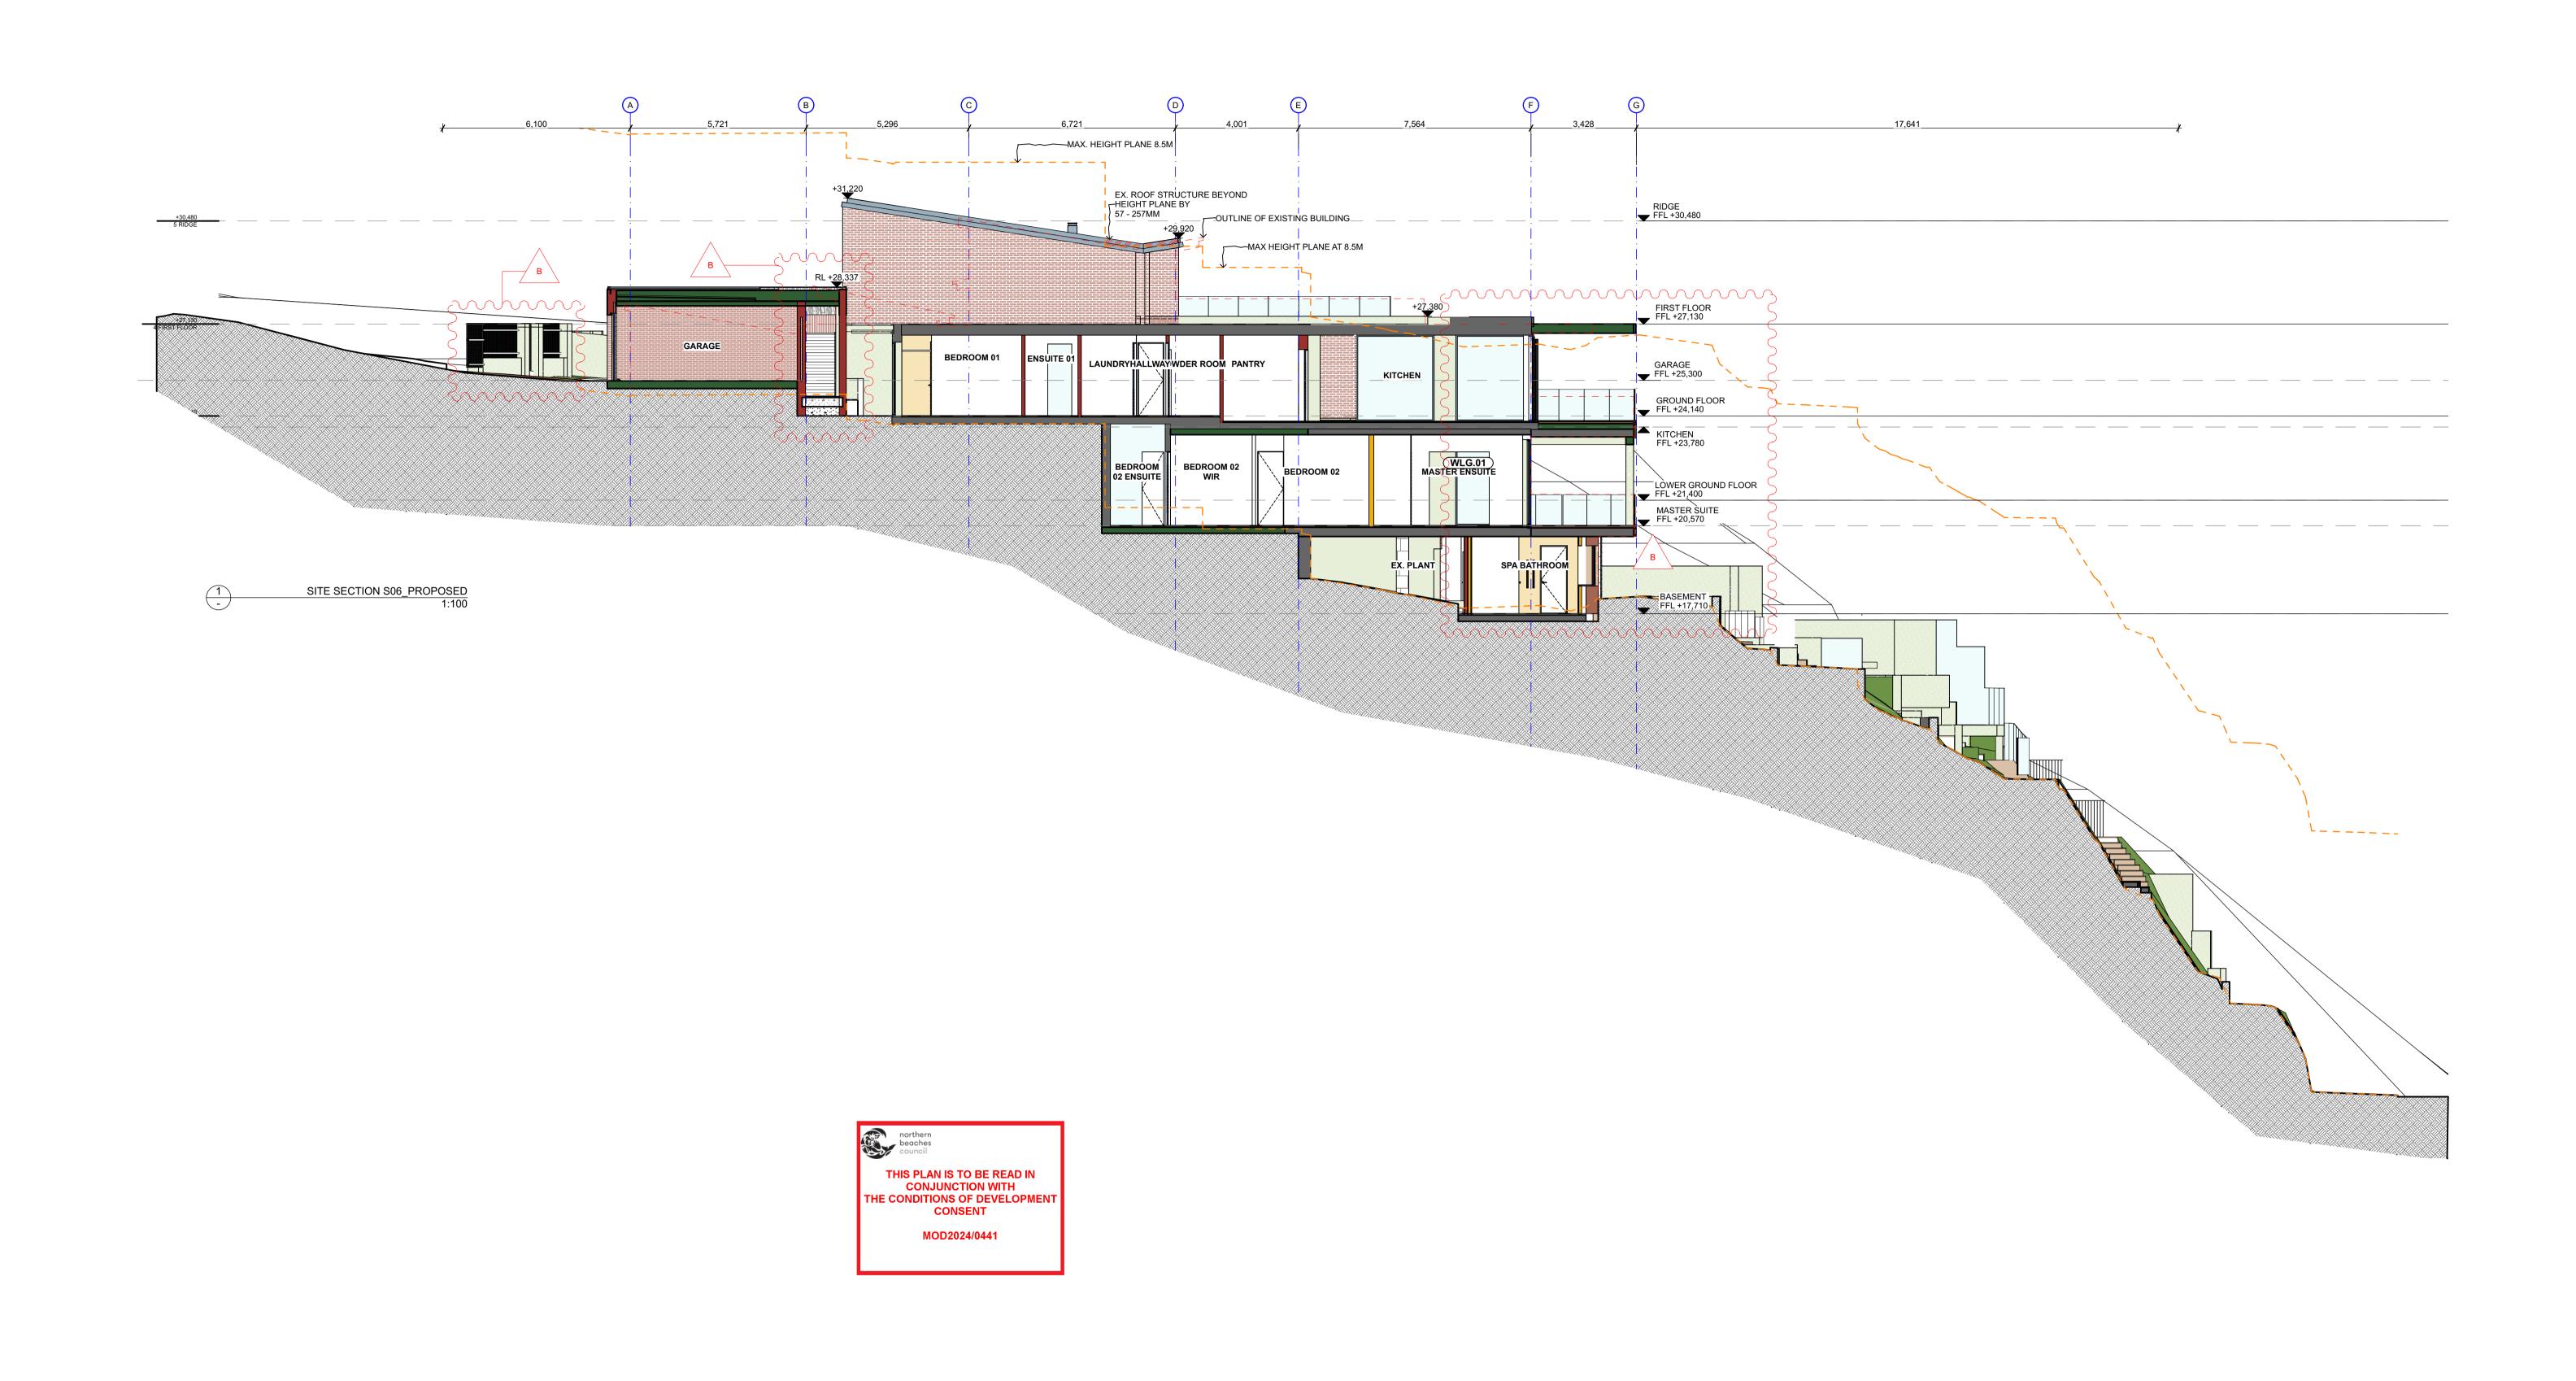


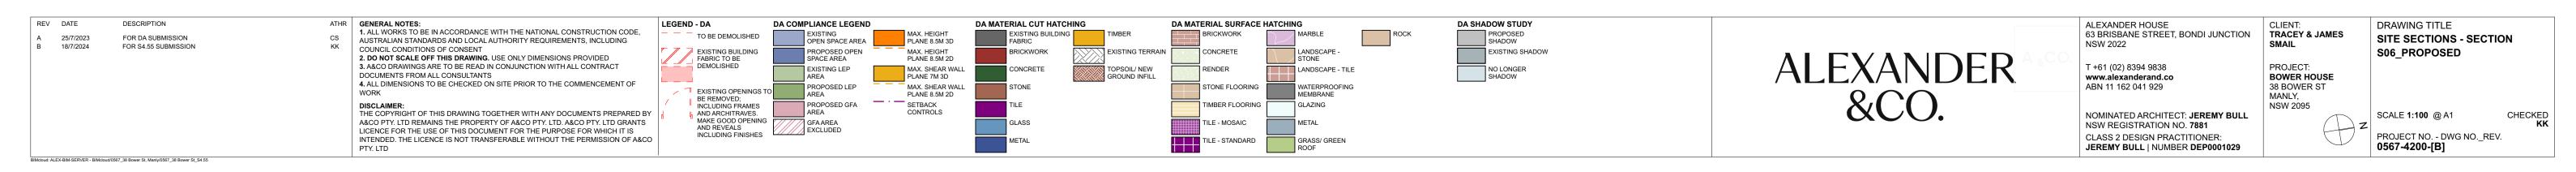





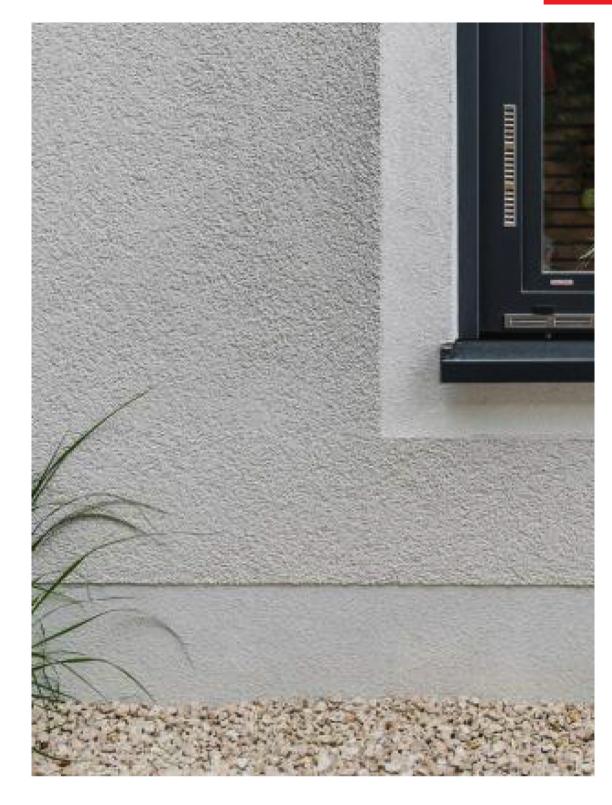

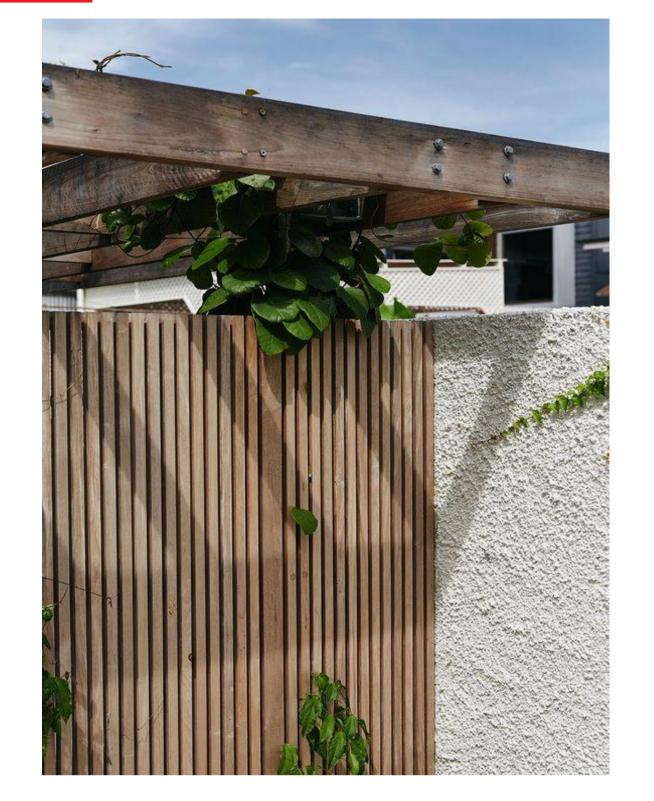






SAND CEMENT RENDER

VERTICAL TIMBER BATTENS



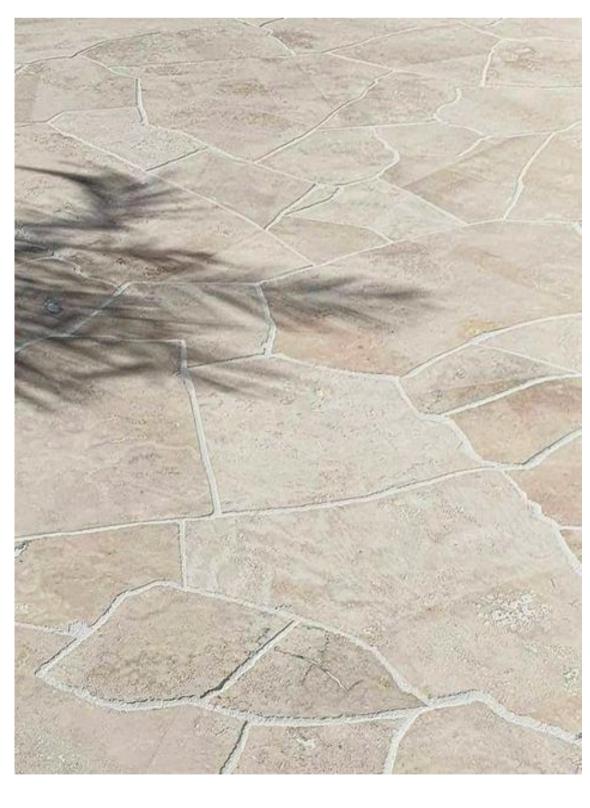

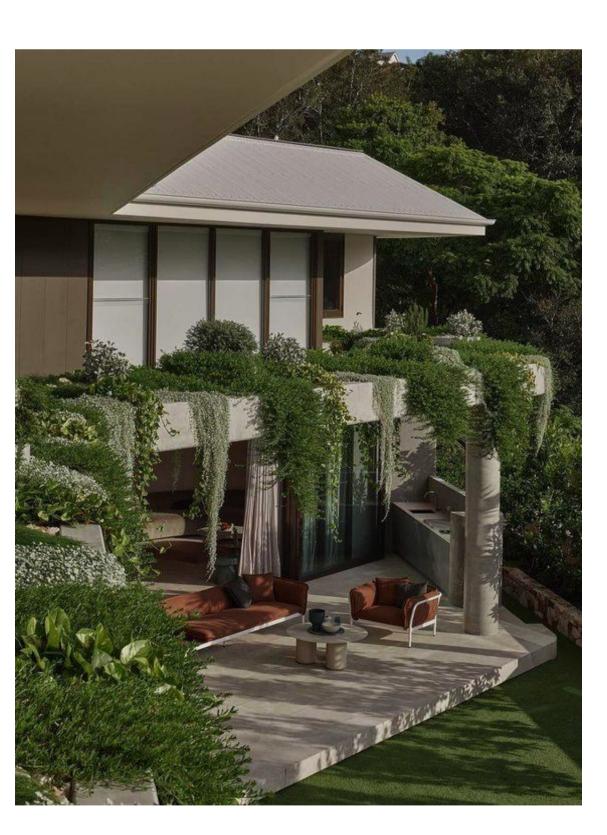

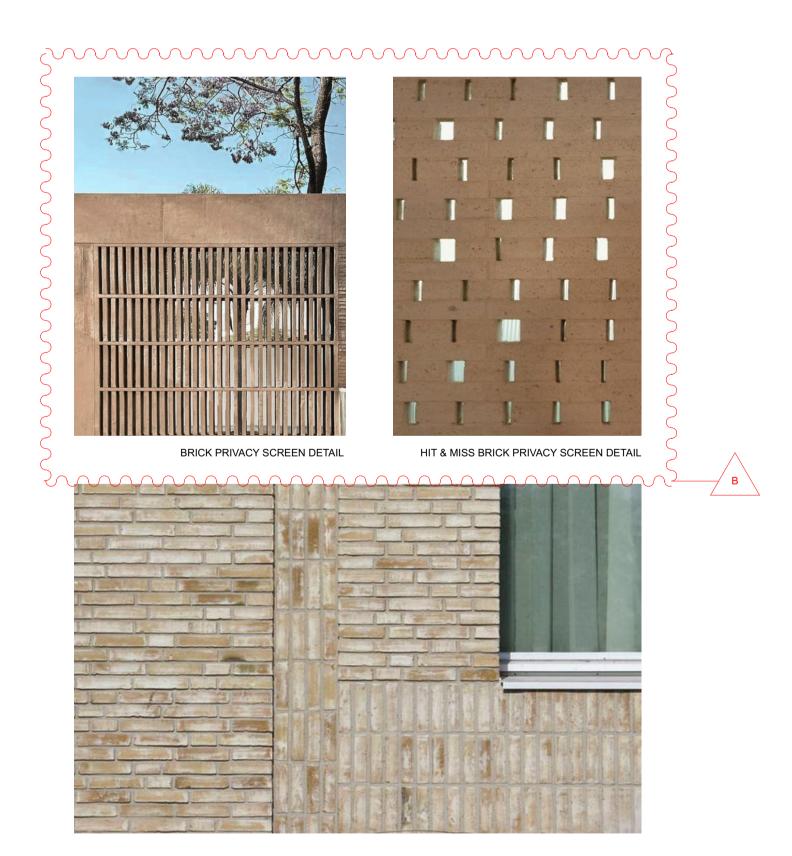

NATURAL STONE

BRONZE FINISH ALUMINIUM WINDOWS AND DOORS

BRICK DETAILS

HANGING PLANTS TO FLAT ROOF SECTIONS

REV DATE DESCRIPTION

A 25/7/2023 FOR DA SUBMISSION

B 18/7/2024 FOR S4.55 SUBMISSION

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MAX. HEIGHT
PLANE 8.5M 2D
MAX. SHEAR WALL
PLANE 7M 3D
MAX. SHEAR WALL
PLANE 8.5M 2D
SETBACK
CONTROLS

DA MATERIAL CUT HATCHING

EXISTING BUILDING
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BRICKWORK

SHEAR WALL
TM 3D

CONCRETE

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TILE

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CONCRETE

TOPSOIL/ NEW GROUND INFILL

STONE FLOORING

TIMBER FLOORING

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TILE - MOSAIC

CONCRETE

CONCRE

MARBLE ROCK PROPOSED SHADOW

LANDSCAPE - STONE

LANDSCAPE - TILE

WATERPROOFING MEMBRANE

GLAZING

METAL

ALEXANDER &CO.

ALEXANDER HOUSE
63 BRISBANE STREET, BONDI JUNCTION
NSW 2022

NOMINATED ARCHITECT: **JEREMY BULL** NSW REGISTRATION NO. **7881**

CLASS 2 DESIGN PRACTITIONER: JEREMY BULL | NUMBER DEP0001029

NSW 2022 SMAIL

T +61 (02) 8394 9838 PROJECT

www.alexanderand.co
ABN 11 162 041 929 38 BOWE
MANLY,
NSW 2022

CLIENT:
TRACEY & JAMES
SMAIL

PROJECT:
BOWER HOUSE
38 BOWER ST

DRAWING TITLE
MATERIAL PALETTE

MANLY, NSW 2095

SCALE @ A1

PROJECT NO. - DWG NO._REV.

0567-8000-[B]

General Hydraulic

- G1. All work shall be carried out in accordance with relevant authority requirements, Council's regulations, Superintendent's approval, Hydraulic Specification and National Plumbing Codes AS.3500, AS.1221, AS.2441 and AS.2419.1.
- G2. This plan shall be read in conjunction with approved architectural, structural, mechanical and electrical plans and specifications.
- G3. Drains to be supported on or from solid ground. Location and depth/invert level of branch shall be verified on site prior to commencement of work.
- G4. Drains under buildings shall be re-tested where directed by superintendent.
- G5. Inspection openings shall be provided:
 - -on the property boundary -on each w.c. or branch
 - -at a max. of 30m intervals, spread equidistant where possible -immediately upstream and downstream of all jump-ups -as required by the authority for inspection and maintenance.
- G6. Existing services have been plotted from supplied data. The Superintendent does not guarantee their accuracy and it is the contractor's responsibility to establish the location of all existing services prior to commencement of any work. Clearances shall be obtained from the relevant authority.
- G7. The contractor shall arrange all survey setouts by a registered
- G8. Contractor shall verify all levels and ensure all falls are attainable prior to commencing work.
- G9. All services that cross pavements, footings etc. shall be backfilled with approved granular material to upgrade level and compacted to 100% standard maximum dry density in accordance with AS.1289.E1.1.
- G10. On completion of pipe installation, all disturbed areas must be restored to original condition including kerbs, footpaths, concrete areas, gravel areas, grassed areas and road pavements.
- G11. Trenches through existing road and concrete areas shall be sawcut to full depth of concrete and a minimum of 50mm in bituminous paving. Reinstate to equivalent of original road and concrete area.
- G12. Where new work abuts existing, the contractor shall ensure that a smooth, even profile, free from abrupt changes, is obtained.
- G13. Care shall be taken when excavating near existing services. No mechanical excavation shall be taken over Telstra or electrical services. Excavate by hand in these areas.
- G14. All pipe penetrations at walls shall be fitted with a puddle flange and made good and watertight.
- G15. All suspended slab pipes shall be supported with adjustable hanging brackets similar to "Abey" in accordance with AS.3500.
- G16. All core hole locations shall be approved by the superintendent prior to commencement of coring.
- G17. Contractor shall allow for all timbering, shoring and shuttering as necessary to construct pipework and include the removal of same upon completion of pipework.
- G18. Provide 80mm compressible material over pipework where clearance to underside of footing is less than 150mm (U.N.O.)
- G19. Contractor shall obtain all authority approvals and pay all fees.
- G20. All uPVC pipe exposed to sunlight shall be DWV.

Amendment or reason for issue

G21. Contractor to allow for all associated fees, charges, applications and inspections (Section 50, Hydraulic Design Assessment etc.) for water, sewer and gas services installations required by

Supplied data

Existing services have been plotted from supplied data. It is the Contractor's responsibility to establish the location of all existing

services prior to commencing any work. Existing services servicing other operational areas must be retained.

is to be used as a guide only.

Contractor to modify/relocate existing services as required. This drawing

Existing Services and Features

- E1. The contractor shall allow for the capping off, excavation and removal if required, of all existing services in areas affected by works within the contract area and as shown on the drawings, unless directed otherwise by the Superintendent.
- E2. The contractor shall ensure that at all times services to all buildings are not affected by the works and are not disrupted.
- E3. Prior to commencement of any works the contractor shall gain approval of his programme for the relocation/construction of temporary services.
- E4. Existing buildings, external structures and trees shown on these drawings are features existing prior to any demolition works.
- E5. Contractor shall construct temporary services to maintain existing supply to buildings remaining in operation during works to the satisfaction and approval of the superintendent. Once diversion is complete and commissioned the contractor shall remove all such temporary services and make good to the satisfaction of the Superintendent.
- E6. Interruption to supply of existing services shall be done so as not to cause any inconvenience to the principal. Contractor to gain approval of Superintendent for time of interruption.

Demolition

- D1. Unless noted otherwise in these hydraulic drawings. refer to Architect's drawings, existing conditions drawings and demolition drawings for extent of demolition works associated with
- D2. Disconnect and remove existing services to and from existing fixtures and plant areas affected by the proposed works.
- D3. Contractor to undertake independent survey of all areas to determine extent of existing services to be disconnected and
- D4. Existing services required for the operation of other buildings are to be diverted/extended as required.

Water, Gas and Fire services

- 1. All pipework to be copper type "B" unless noted otherwise. For fire services, material pipe shall be galvanized steel pipe.
- 2. Piping materials proposed for installation shall be suitable for the soil conditions existing on site. Confirm soil conditions prior to laying metal piping through soils.
- 3. Where piping is concealed in wall or chased in floor, Kemlag insulation to both hot and cold water pipework shall be provided as
- 4. All metal pipework penetrating fire rated elements shall be sealed to maintain required fire rating

Erosion and Sediment Control

General instructions:

- All references to details, testing and procedures are to be followed as specified in the Department of Housing "Managing Urban Stormwater Soils and Construction" manual (March 2004).
- . This plan is to be read in conjunction with the engineering plans and any other plans or written instructions that may be issued and relating to development at the subject site.
- . The contractor will ensure that all soil and water management works are located as shown in this specification.
- . All contractors shall be aware of their responsibilities in minimising the potential for soil erosion and pollution to downslope lands and
- . These plans represent concepts only. the contractor shall be responsible for the establishment and management of a detailed scheme meeting council's approval.

Construction sequence:

- 6. The soil erosion potential on this site shall be minimised. Hence initial works shall be undertaken in the following sequence prior to commencing construction:
 - (a) install all temporary sediment fences and barrier fences. Where fences are adjacent to each other the sediment fence can be incorporated into the barrier fence. (b) construct temporary stabilised site access (c) install sediment traps.
- 7. Undertake site development works so that land disturbance is confined to areas of minimum workable size.

Erosion control:

B. At all times and in particular during windy and dry weather, large, unprotected areas will be kept moist (not wet) by sprinkling with water to keep dust under control.

Sediment control:

- 9. Any sand used in the concrete curing process (spread over the surface) will be removed as soon as possible and within ten working days from placement.
- 10. Water will be prevented from entering the permanent drainage system unless it is relatively sediment free i.e. the catchment area has been permanently landscaped/stabilised and/or any likely sediment has been filtered through an approved structure.
- 1. Temporary soil and water management structures will be removed only after the lands they are protecting are stabilised/rehabilitated.

- 12. Acceptable receptors will be constructed for concrete and mortar slurries, paints, acid washings, light-weight waste materials and litter
- 13. Any existing trees which form part of the final landscaping plan, will be protected from construction activities by:
- (a) protecting them with barrier fencing or similar materials installed outside the drip line. (b) ensuring that nothing is nailed to them.
- (c) prohibiting paving, grading, sediment wash or placing of stockpiles within the drip line except under the following
- (i) encroachment only occurs on one side and no closer to the trunk than either 1.5m or half the distance between the outer edge of the drip line and the trunk, which ever is the
- (ii) a drainage system that allows air and water to circulate through the root zone (e.g. a gravel bed) is placed under all fill layers of more than 300mm depth.
- (iii) care is taken not to cut roots unnecessarily nor to compact the soil around them.

Site inspection and maintenance:

- 14. Allow for grass stabilisation of unstable areas, open channels and rock batters as and where directed.
- 15. Allow for establishment of other erosion protection measures as
- 6. Receptors for concrete and mortar slurries, paints, acid washings, light-weight waste materials and litter are to be emptied as necessary. Disposal of waste shall be in a manner approved by the site
- 7. Erosion and sediment control measures shall be inspected to ensure that they operate effectively immediately after each storm. Repairs and or maintenance shall be undertaken after each event and as required on a weekly basis.
- The contractor shall provide all monitoring controls and testing.

Stormwater

- SW1. All stormwater lines shall be sewer grade uPVC with solvent weld
- SW2. Minimum grade to stormwater lines to be 1% (U.N.O.)
- SW3. Contractor to supply and install all fittings and specials including various pipe adapters to ensure proper connection between dissimilar pipework.
- SW4. All connections to existing drainage pits shall be made in a tradesman-like manner and the internal wall of the pit at the point of entry shall be cement rendered to ensure a smooth finish.
- SW5. Where trenches are in rock, the pipe shall be bedded on a minimum 50mm concrete bed (or 75mm thick bed of 12mm blue metal) under the barrel of the pipe. the pipe collar at no point shall bear on the rock. in other than rock, pipes shall be laid on a 75mm thick sand bed. In all cases backfill the trench with sand to 200mm above the pipe. Where the pipe is under pavements, backfill remainder of trench with approved granular material to subgrade level in 150mm layers compacted to 100% standard maximum dry density. A minimum pavement of 125mm thick dgb20 base and 25mm thick ac10 wearing course shall be provided.
- SW6. Where stormwater lines pass under floor slabs, sewer grade rubber ring joints are to be used.
- SW6 All metal downpipes connecting to gutters are to be separated by non-conducting gasket or similar approved device to prevent electro chemical corrosion.

Minimum grades piping materials

N.B. Alternatives to materials listed hereunder will only be considered by written submission to the Engineer.

<u>Downpipes</u>

225(dia.)mm and under

-uPVC DWV SH to AS.1415

-all exposed downpipes to be in material as specified by architect

-all concealed downpipes to be uPVC to A.S.3500.2.2 Section 2

THIS PLAN IS TO BE READ IN

Abbreviations

At High Level Diameter Approx. Approximately Copper Dia Diameter DN **Nominal Size** DP Downpipe Drg Drawing Ex./Exist. Existing F.F.L. Finished Floor Level F.G.L. Finished Ground Level F.S.L. Finished Surface Level G.L. **Ground Level** HLHigh Level I.L. Invert Level l/sec. Litres per Second m Millitmetre mm N.T.S. Not to Scale OF Overflow PVC Poly Vinyl Chloride

Legend

Existing riser

Existing size

Service type

Service size

Note reference

Dropper

Pipe Riser

End Cap

Pipe Dropper

Continuation

Stop Valve

Hose tap

Direction of overland flow

Temporary sediment fence

Temporary geotextile filter fabric

Sandbag sediment trap

drop inlet sediment trap

Rainwater spreader

Existing dropper

Existing service type

Existing stormwater service

Proposed stormwater service

Pipework

Symbols

----sw----sw----

ExDP

100

 $\leftarrow\sim$

↑↑↑ SPRD

RHS Rectangular hollow section R.L. Reduced Level RRJ Rubber Ring Jointed SPRD Spreader STW Stormwater **SWP** Stormwater Pit TBC To Be Confirmed TOK Top of Kerb U.N.O. **Unless Noted Otherwise**

Ultraviolet

Unplasticised Poly Vinyl Chloride


uPVC


CONJUNCTION WITH THE CONDITIONS OF DEVELOPMENT MOD2024/0441

NOT FOR CONSTRUCTION

ALTERATIONS AND ADDITIONS COVER SHEET AND NOTES. 38 BOWER STR MANLY


Client Project No. TRACEY & JAMES SMAIL Architect A&Co. 23S255 -H01

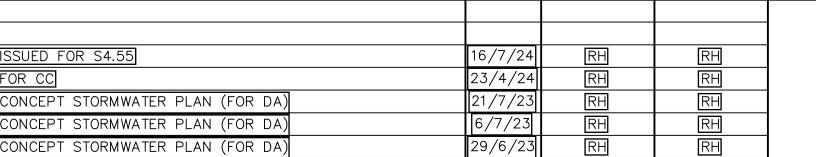


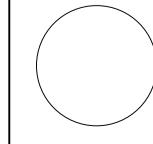





CONSULTING ENGINEERING STRUCTURAL - CIVIL - STORMWATER RADIMHEINZ@GMAIL.COM PH: 0404-770980

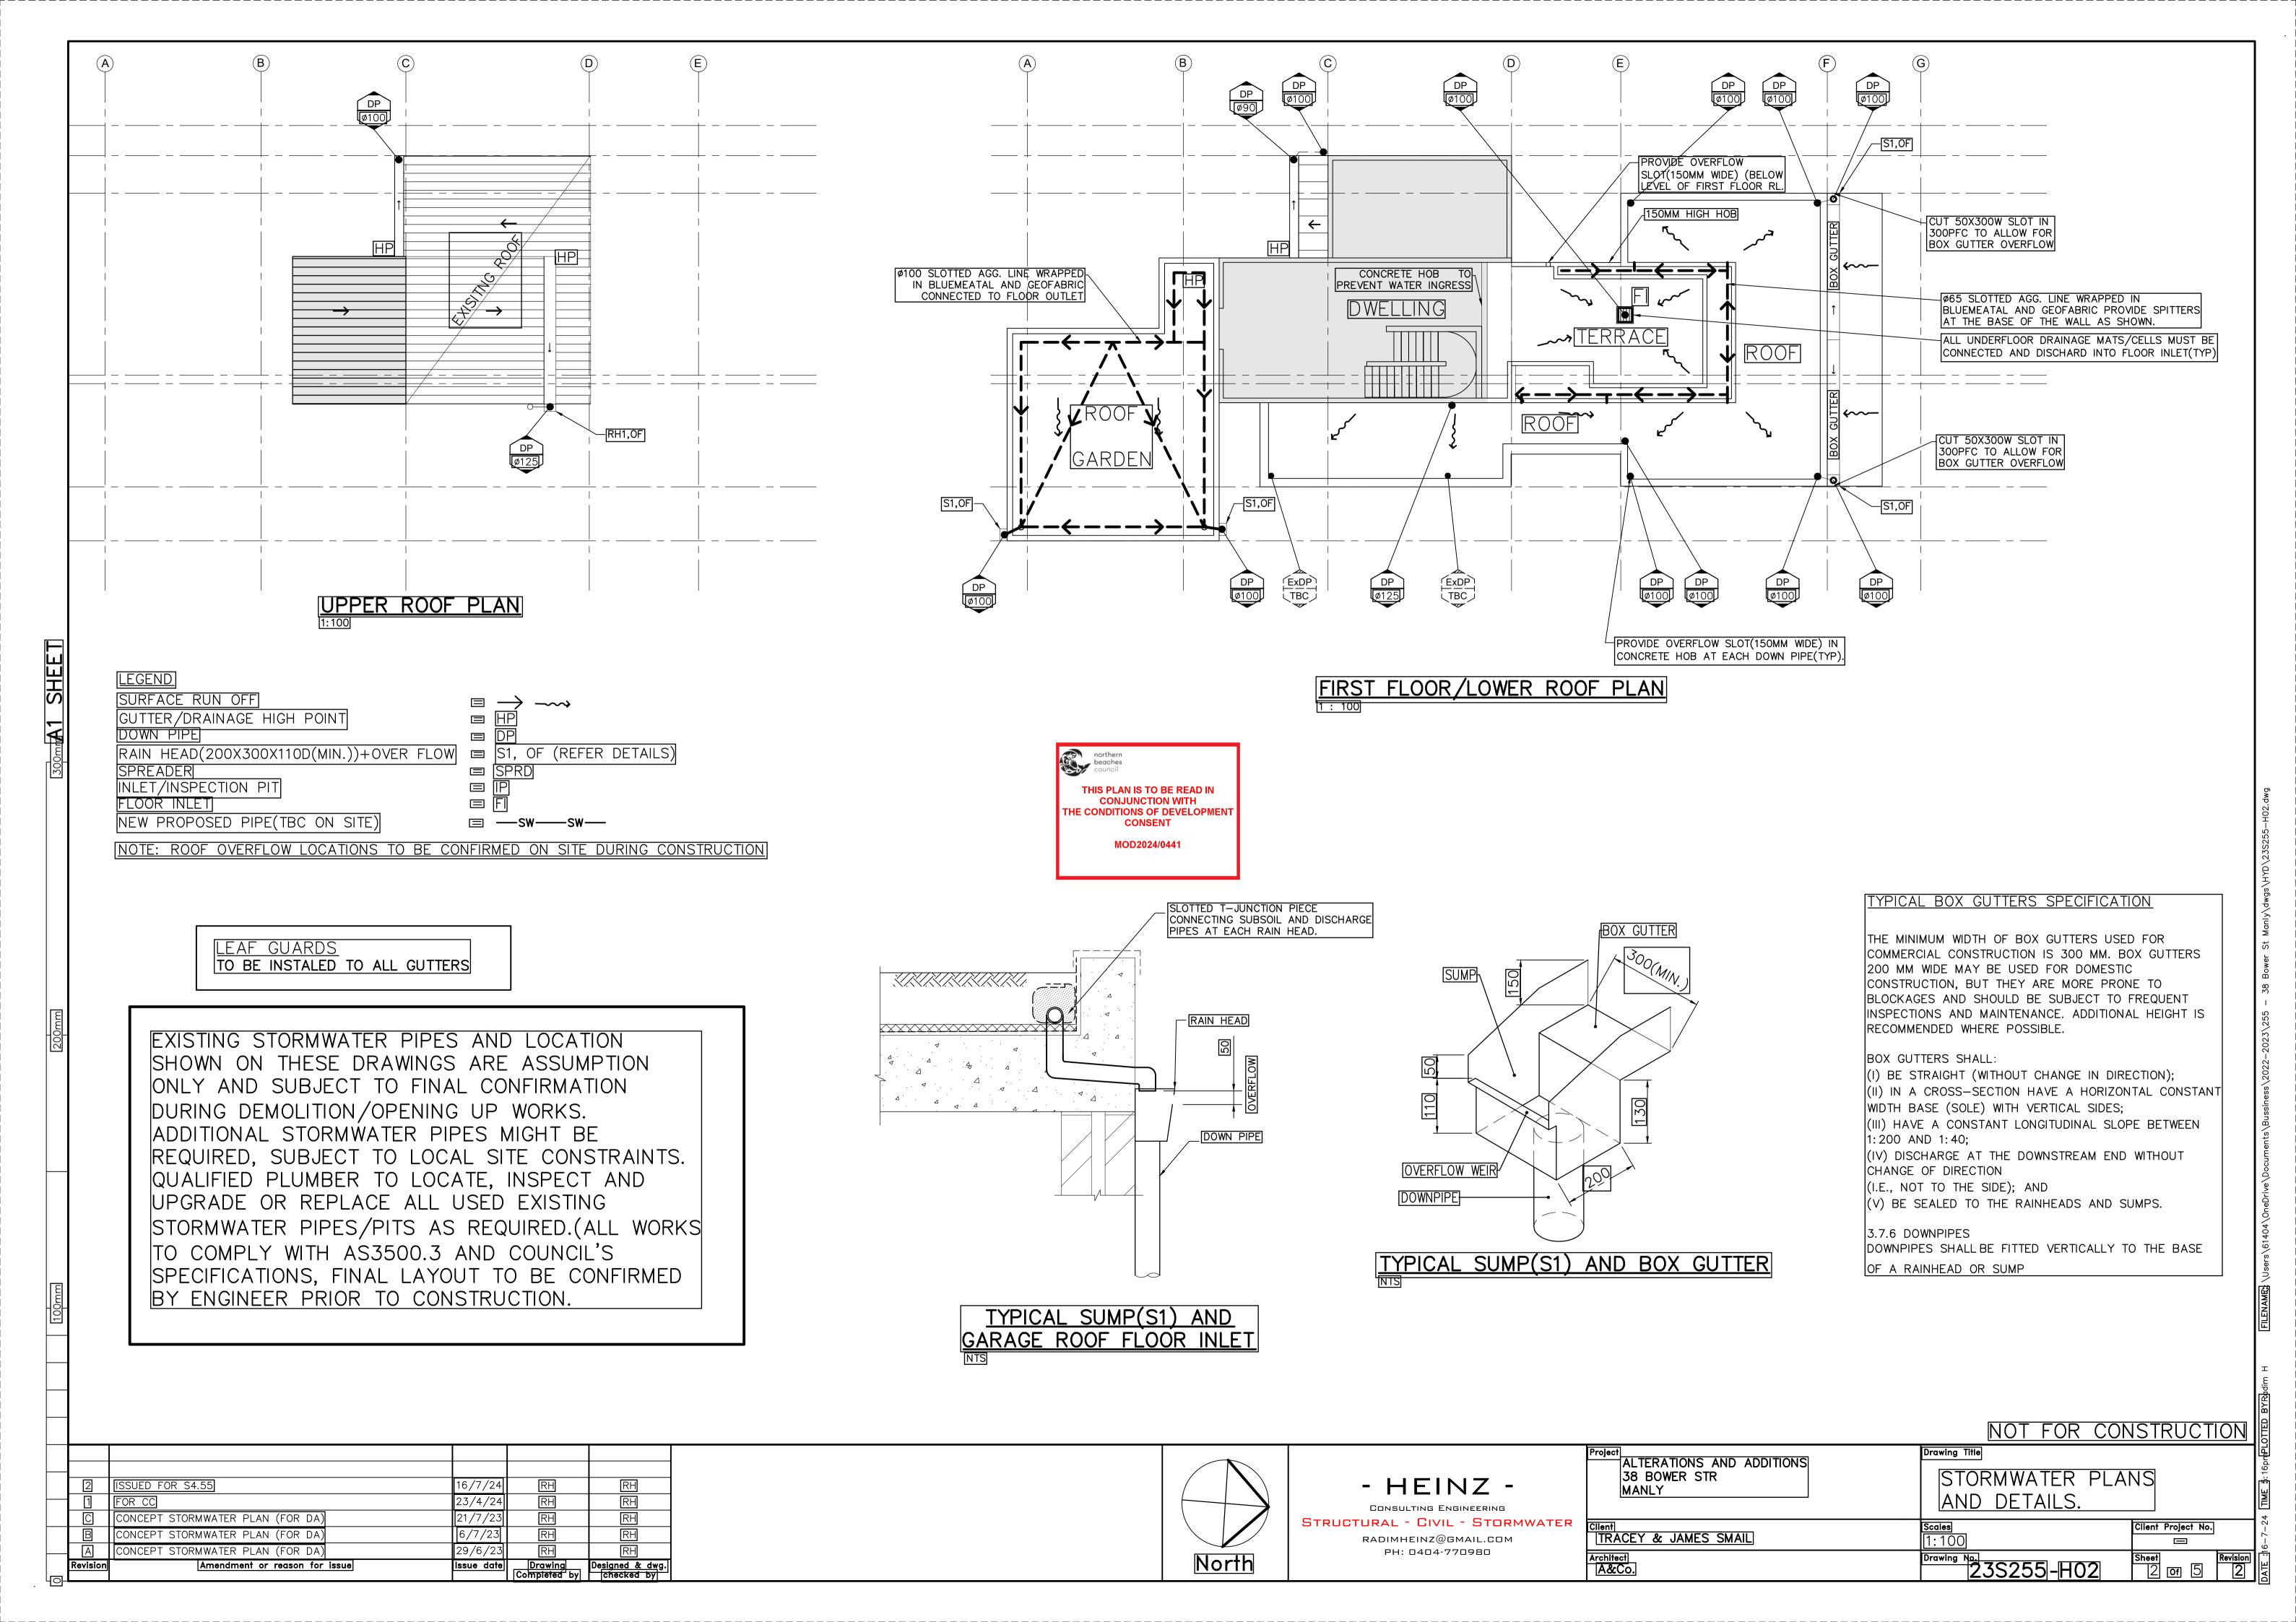

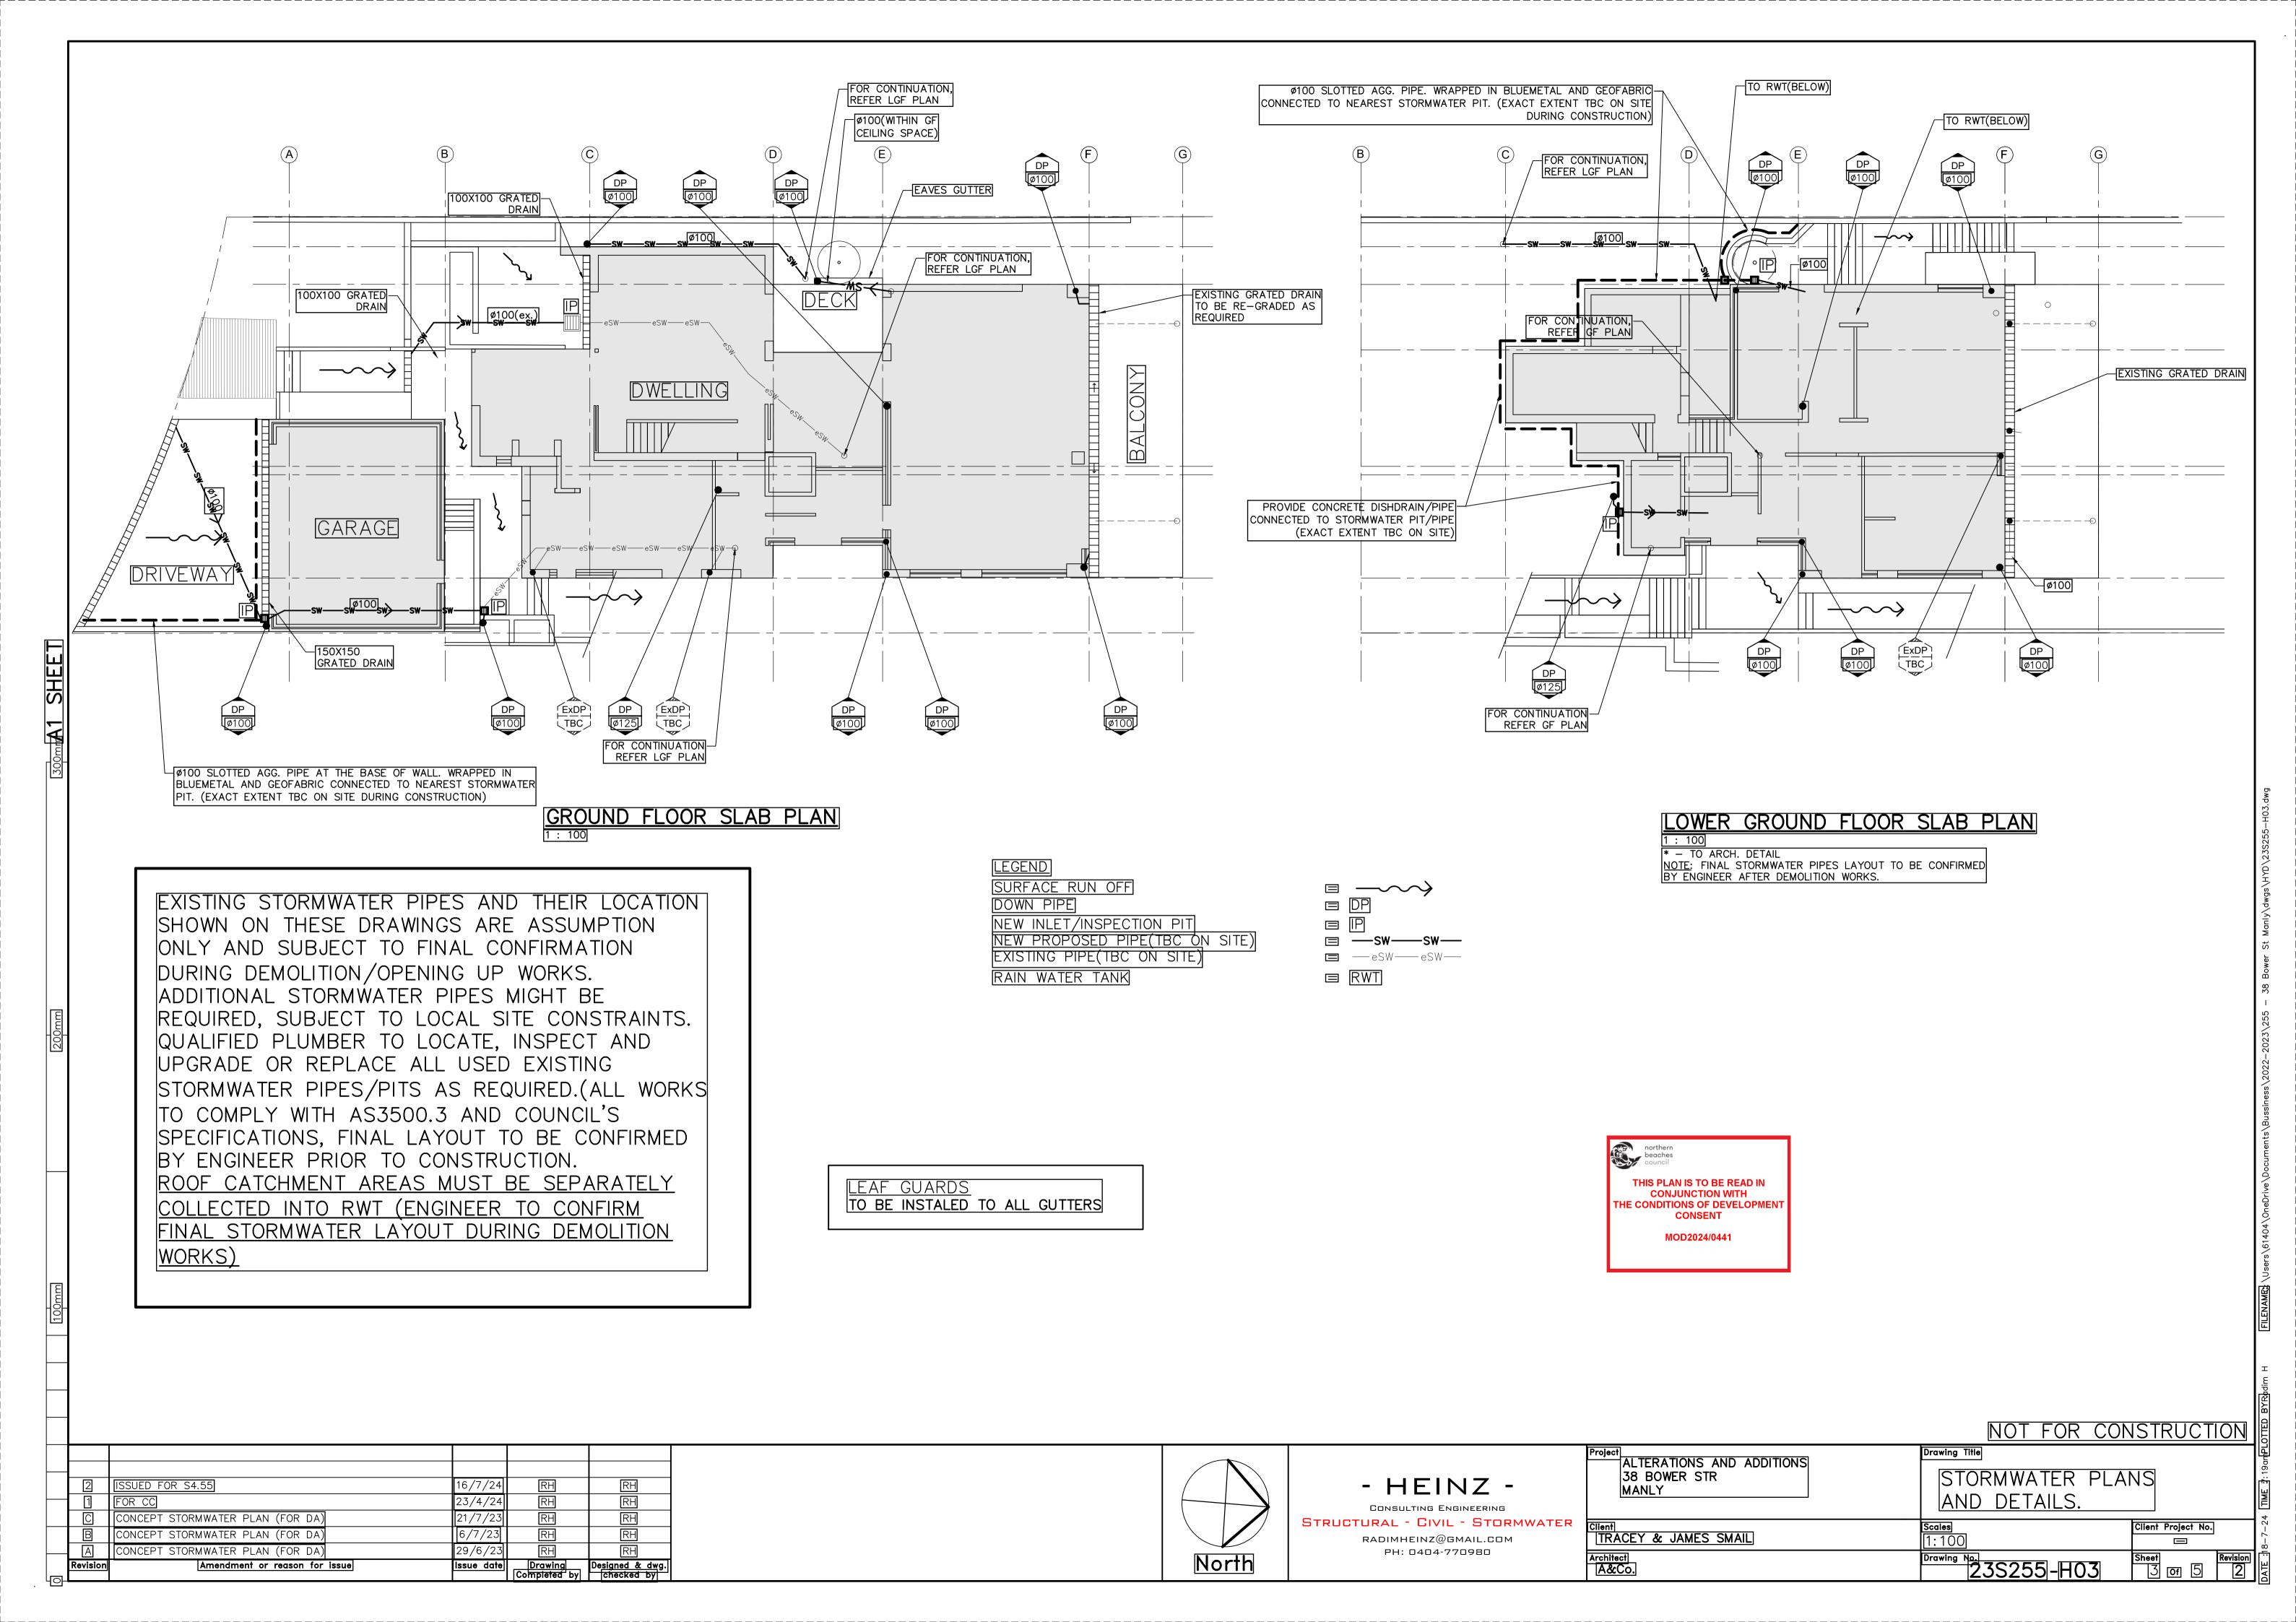

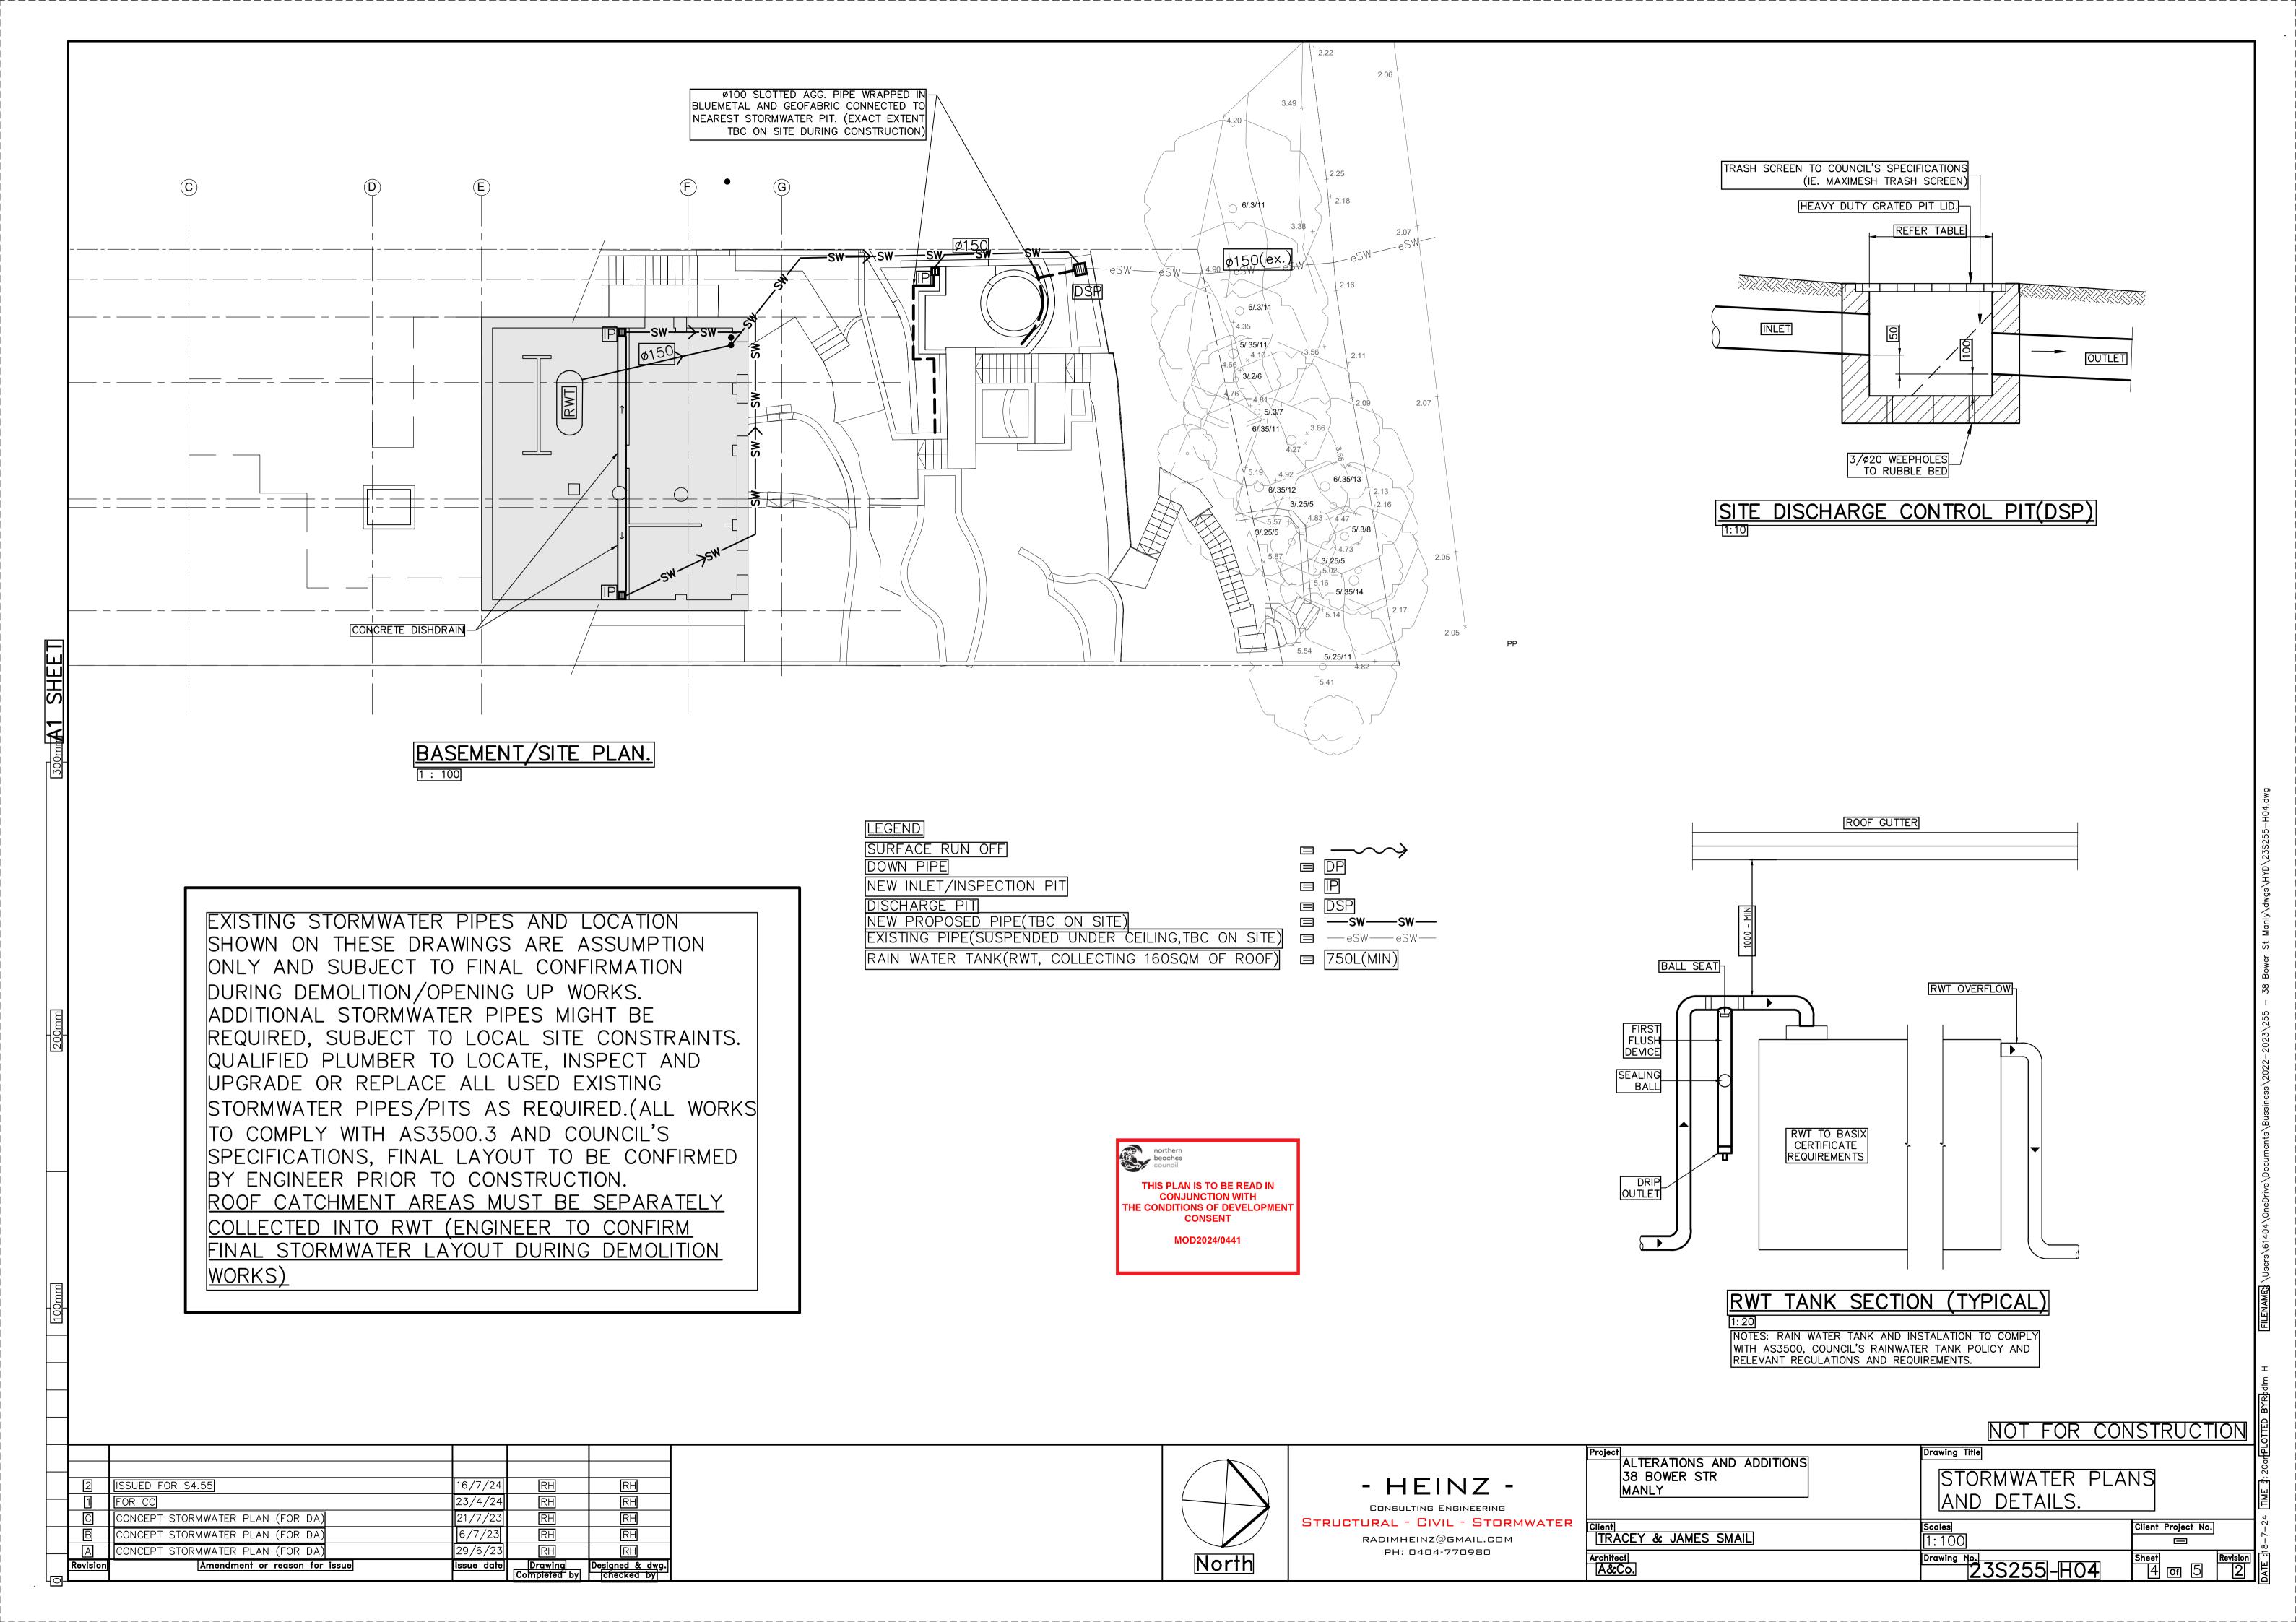

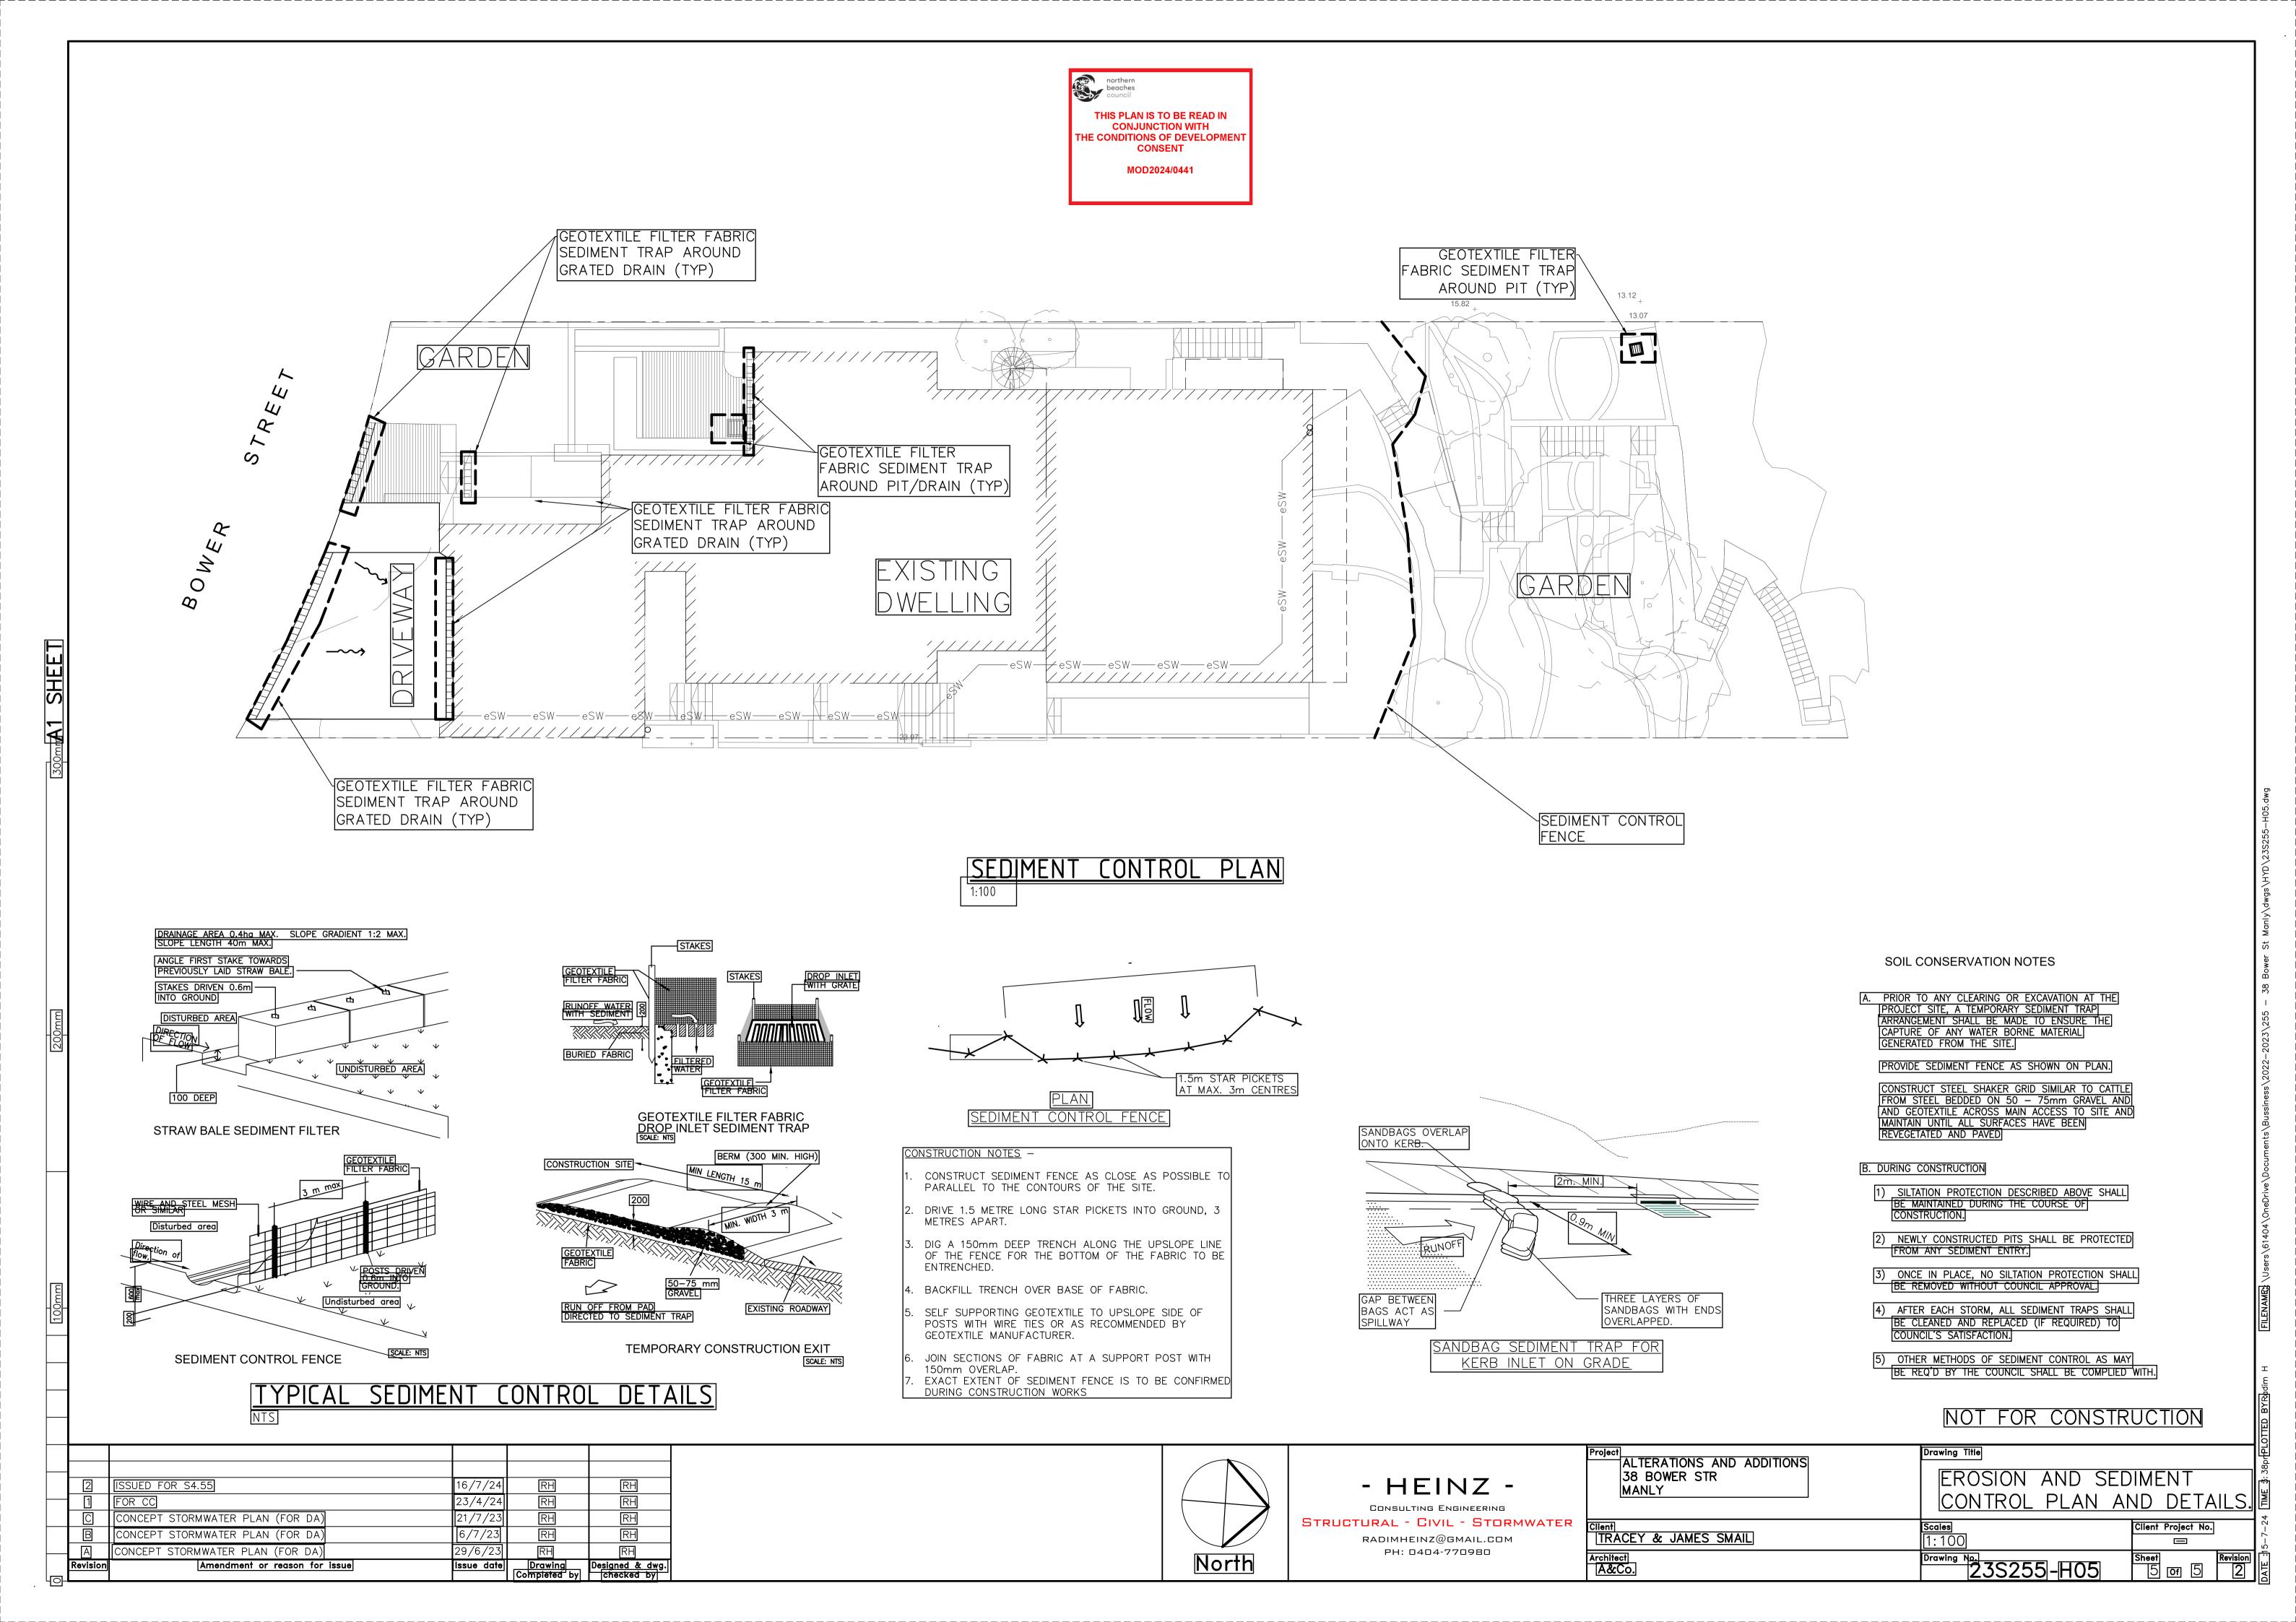

LEGEND

BOUNDARY

northern beaches council


CONJUNCTION WITH

CONSENT

MOD2024/0441

RL +10.00 EXISTING LEVEL

RL +10.00 PROPOSED LEVEL

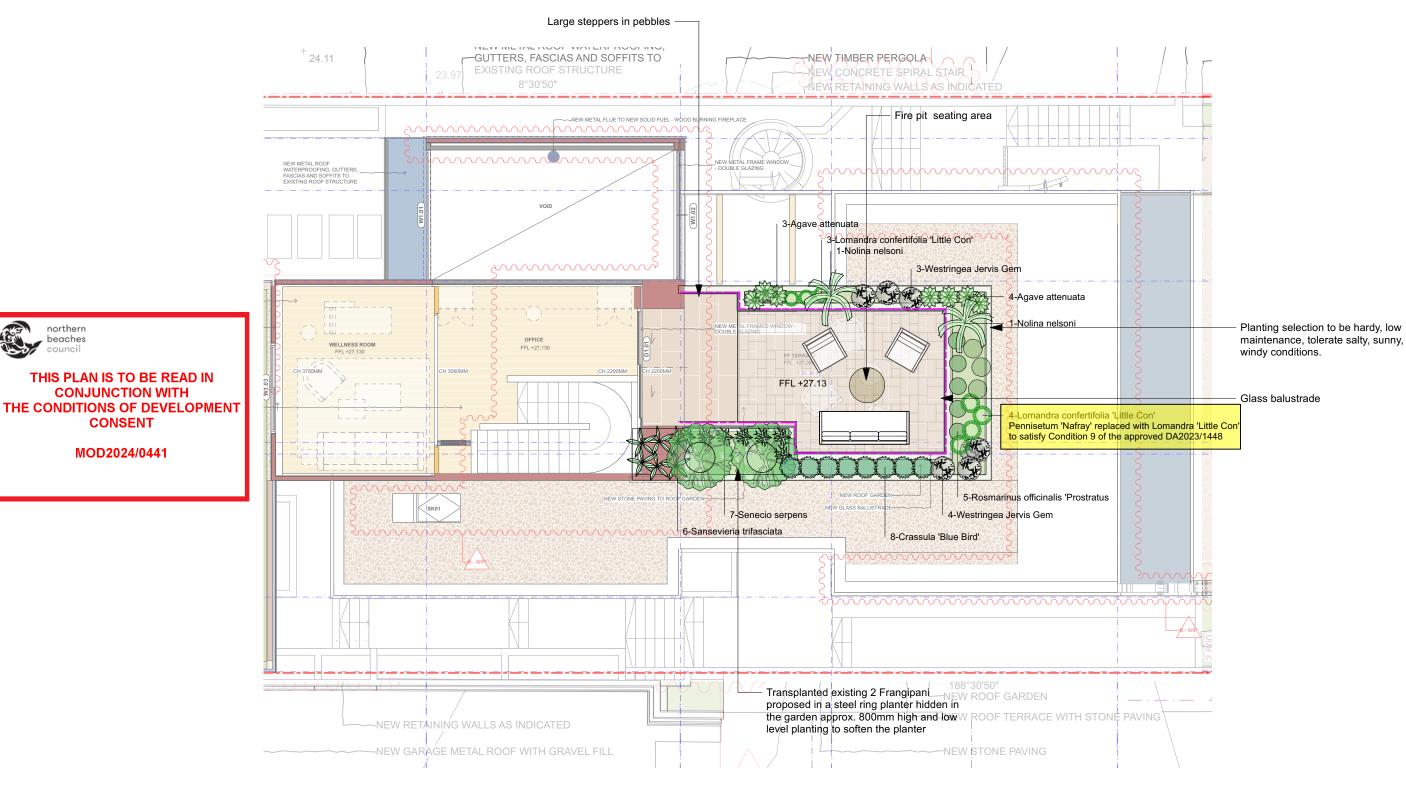

NOTES

Figure dimensions shall take precedence over scale. All figures are to be verified on site. This drawing is protected by copyright.



Landscape Design Consultants edwina@edwinastuart.com www.edwinastuartlandscapedesign.com

EDWINA STUART

Landscape Design

Tracey & James Smail
38 Bower St, Manly

Project:

	Dwg No:	Scale:	Drawn By:	Date:					
	LP 01	ES	16.07.24						
	Title:	REV:							
	LANDSCAPE	В							