
# progressive plans


Residential Dwelling SCOTLAND ISLAND, NSW 2105 18 December 2023 Issue A

Prepared for KERRY & KURT HAMANN

# 43 FLORENCE TERRACE

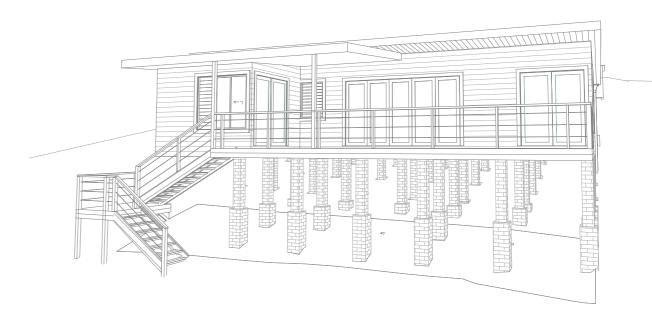

NO:	SHEET NAME	DATE
S4.55 00	TITLE PAGE	18/12/2023
S4.55 01	SHEET INDEX	18/12/2023
S4.55 02	AREA CALCULATIONS	18/12/2023
S4.55 03	SITE ANALYSIS	18/12/2023
S4.55 04	PROPOSED SITE PLAN	18/12/2023
S4.55 05	DA APPROVED LOWER GROUND FLOOR PLAN	18/12/2023
S4.55 06	PROPOSED LOWER GROUND FLOOR PLAN	18/12/2023
S4.55 07	DA APPROVED GROUND FLOOR PLAN	18/12/2023
S4.55 08	PROPOSED GROUND FLOOR PLAN	18/12/2023
S4.55 09	DA APPROVED ROOF PLAN	18/12/2023
S4.55 10	PROPOSED ROOF / CONCEPT STORMWATER PLAN	18/12/2023
S4.55 11	ELEVATIONS - NORTH	18/12/2023
S4.55 12	ELEVATIONS - SOUTH	18/12/2023
S4.55 13	ELEVATIONS - EAST & WEST	18/12/2023
S4.55 14	SECTIONS - A	18/12/2023
S4.55 15	SECTIONS - B & C	18/12/2023
S4.55 16	FINISHES BOARD	18/12/2023
S4.55 17	SHADOW DIAGRAM - JUNE 21ST - 9AM	18/12/2023
S4.55 18	SHADOW DIAGRAM - JUNE 21ST - 12PM	18/12/2023
S4.55 19	SHADOW DIAGRAM - JUNE 21ST - 3PM	18/12/2023
S4.55 20	BASIX REQUIREMENTS	18/12/2023
S4.55 21	BASIX REQUIREMENTS	18/12/2023

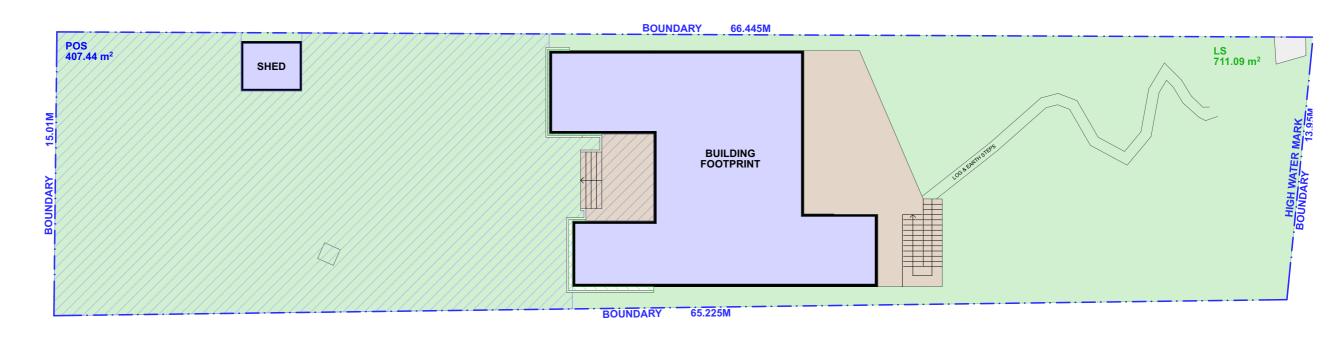

SITE AREA: 951.00m²

BUILDING FOOTPRINT

LANDSCAPE AREA:

 (TOTAL + 6% IMPERVIOUS AREA 57.06m²)

 REQUIRED
 76.00% (722.76 m²)

 DA APPROVED
 80.77% (768.15 m²)

 PROPOSED
 84.02% (799.06 m²)


IMPERVIOUS LANDSCAPED AREA:

AREAS LESS THAN 1m WIDE

PRIVATE OPEN SPACE:

REQUIRED 80.00m<sup>2</sup>
DA APPROVED 407.44m<sup>2</sup>
PROPOSED 430.10m<sup>2</sup>

1 DA APPROVED AREA CALCULATIONS 1:200

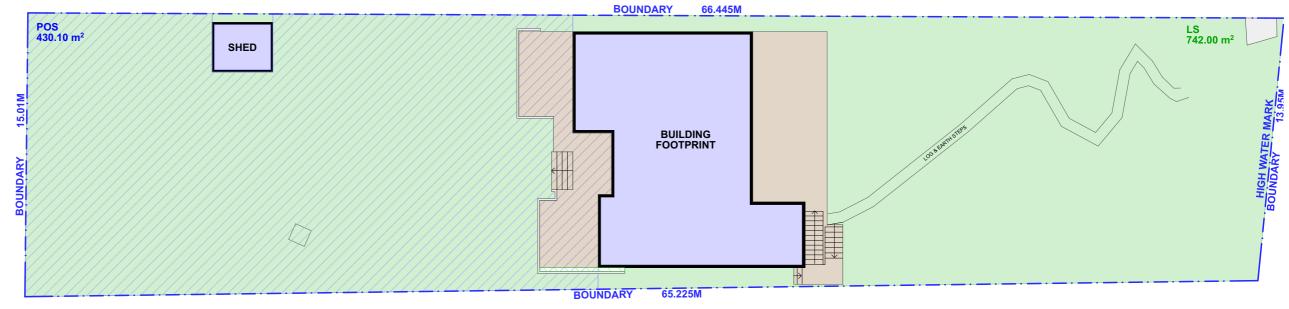

# 2 PROPOSED AREA CALCULATIONS 1:200




progressive plans


0400 699 850 16 BOWLING GREEN LANE AVALON, NSW, 2107 HELLO@PROGRESSIVEPLANS.COM.AU WWW.PROGRESSIVEPLANS.COM.AU THE BUILDER SHALL CHECK AND VERIFY ALL DIMENSIONS AND VERIFY ALL ERROS AND OMISSIONS TO THE DRAFTING OFFICE. DO NOT SCALE THE DRAWING. THE WORK MUST BE VERIFIED BY STRUCTURAL ENGINEER BEFORE WORK COMMENCES.

EV.	NOTES.	INITIAL	DATE	LEGEND
Α	\$4.55 SET	SB	15.12.23	DWELLING WALLS
				CONCRETE / PAVERS
				TIMBER DECK
				POOL / WATER





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AREA CALCULATIONS					
SCALE:	DATE:				
1:200 @A3	18/12/2023				
PROJECT NO:	DRAWING NO:				
4040	04.55.00				
1010	S4.55 02				

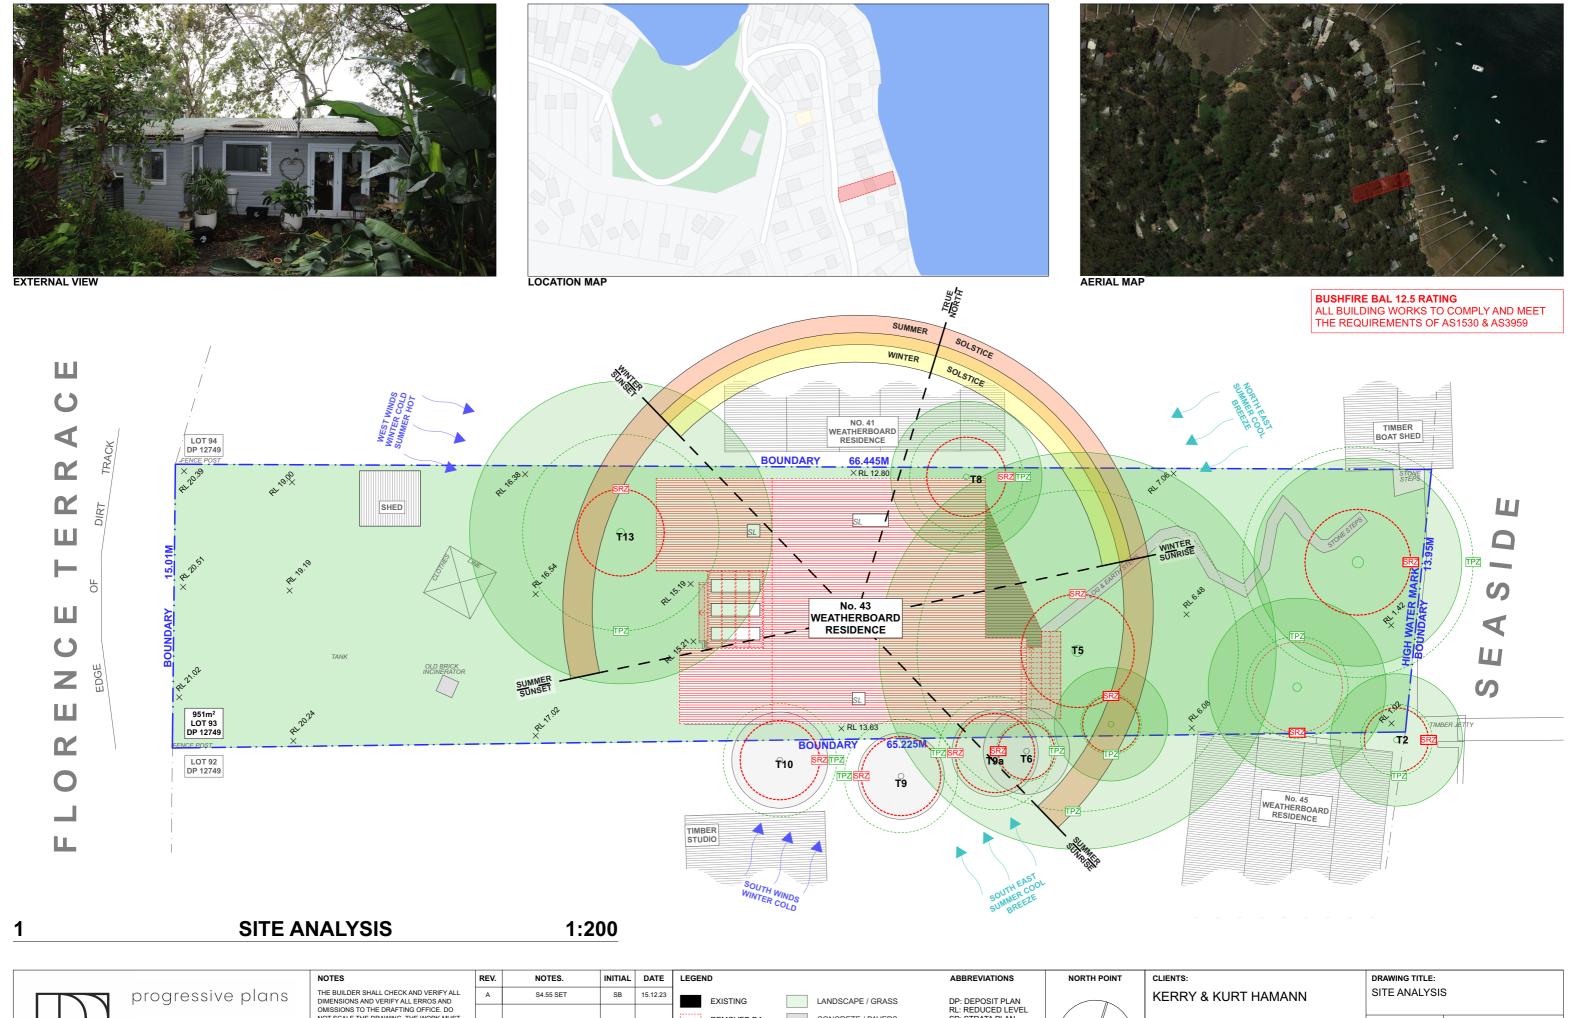

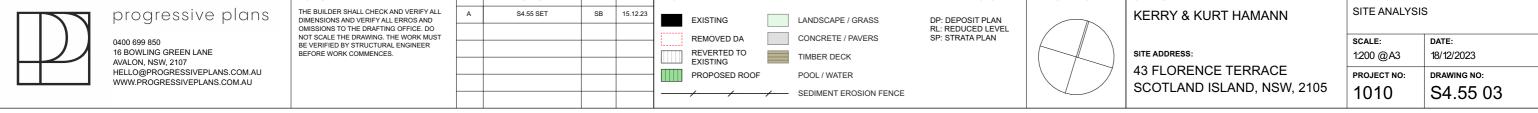




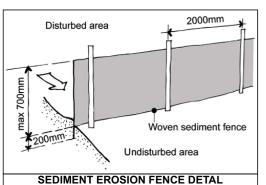

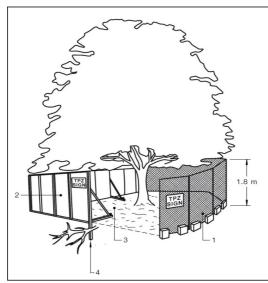

# TREE PROTECTION ZONE (TPZ) FENCING (WHEN POSSIBLE):

- 1. CHAIN WIRE MESH PANELS WITH SHADE CLOTH (IF REQUIRED) ATTACHED, HELD IN PLACE WITH CONCRETE FEET.
- 2. ALTERNATIVE PLYWOOD OR WOODEN PALING FENCE PANELS. THE FENCING MATERIAL ALSO PREVENTS BUILDING MATERIALS OR SOIL ENTERING THE TPZ.
- 3. MULCH INSTALLATION ACROSS SURFACE OF TPZ (AT THE DISCRETION OF THE PROJECT ARBORIST), NO EXCAVATION, CONSTRUCTION ACTIVITY, GRADE CHANGES, SURFACE TREATMENT OR STORAGE OF MATERIALS OF ANY KIND IS PERMITTED WITHIN THE TPZ.
- 4. BRACING IS PERMISSIBLE WITHIN THE TPZ. INSTALLATION OF SUPPORTS TO AVOID DAMAGING ROOTS.

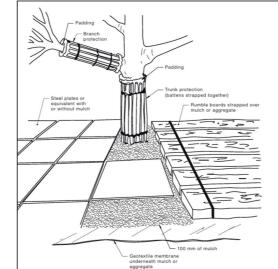

# TREE PROTECTION ZONE (TPZ) FENCING (NOT POSSIBLE):

**BUSHFIRE BAL 12.5 RATING** 

ALL BUILDING WORKS TO COMPLY AND MEET


THE REQUIREMENTS OF AS1530 & AS3959


- 1. FOR TRUNK AND BRANCH PROTECTION USE BOARDS AND PADDING THAT WILL PREVENT DAMAGE TO BARK. BOARDS ARE TO BE STRAPPED TO TREES, NOT NAILED, OR SCREWED.
- 2. RUMBLE BOARDS SHOULD BE OF SUITABLE THICKNESS TO PREVENT SOIL COMPACTION AND ROOT DAMAGE.


NO. 41 TIMBER WEATHERBOARD BOAT SHED LOT 94 DP 12749 RESIDENCE 66.445M ×RL 12.80 18.X SHED WALLS **T13** No. 43 WEATHERBOARD RESIDENCE **T**5 S 951m<sup>2</sup> LOT 93 × RL 13.63 DP 12749 T2 65.225M LOT 92 <del>1</del>10 T9 WEATHERBOARD RESIDENCE TIMBER STUDIO

# 1 PROPOSED SITE PLAN 1:200



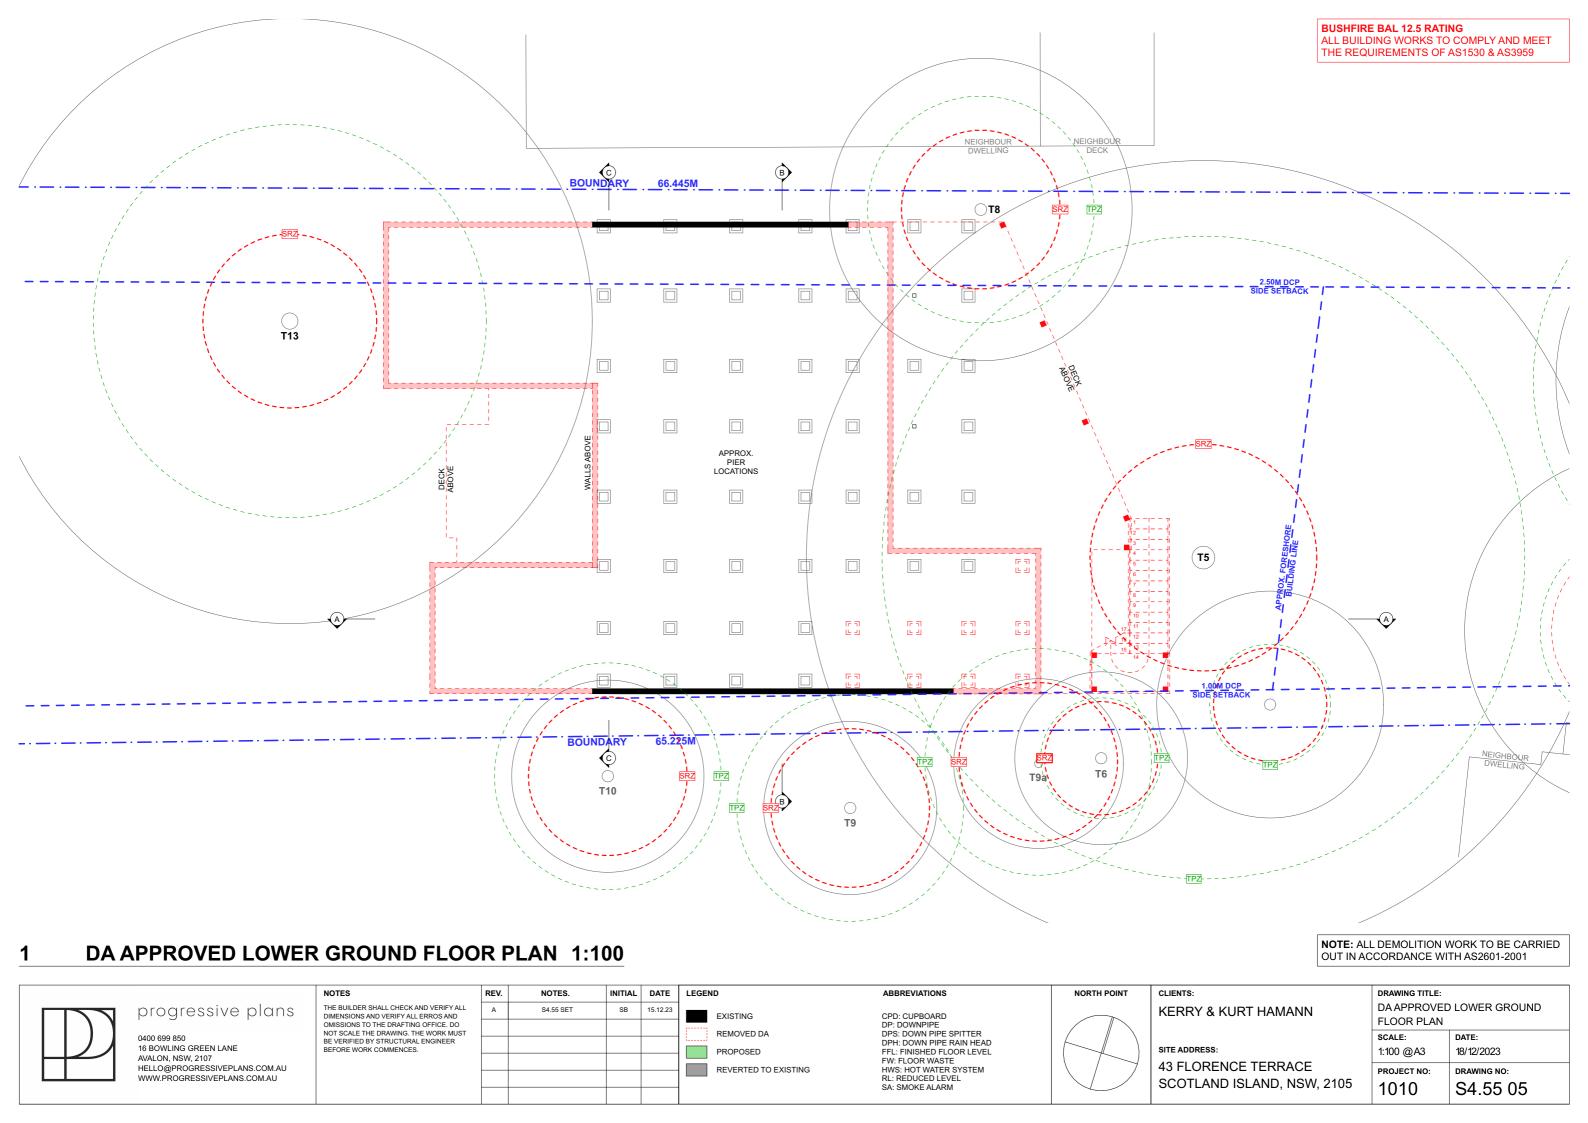

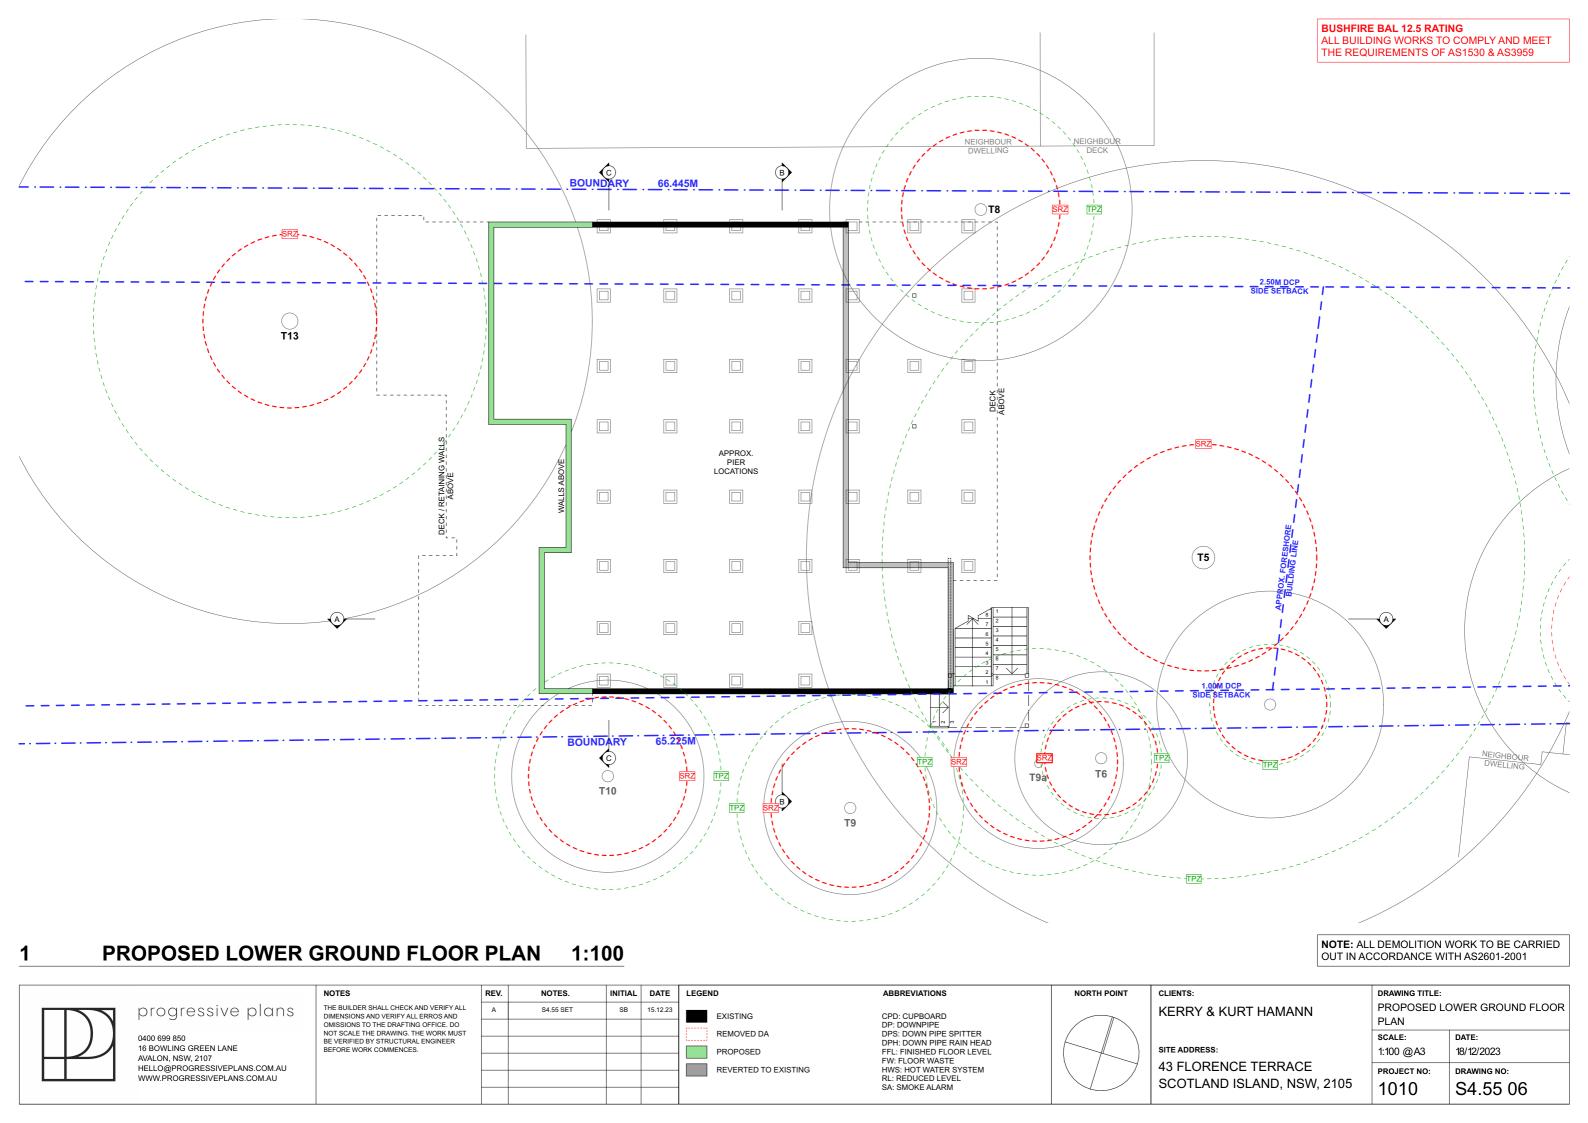

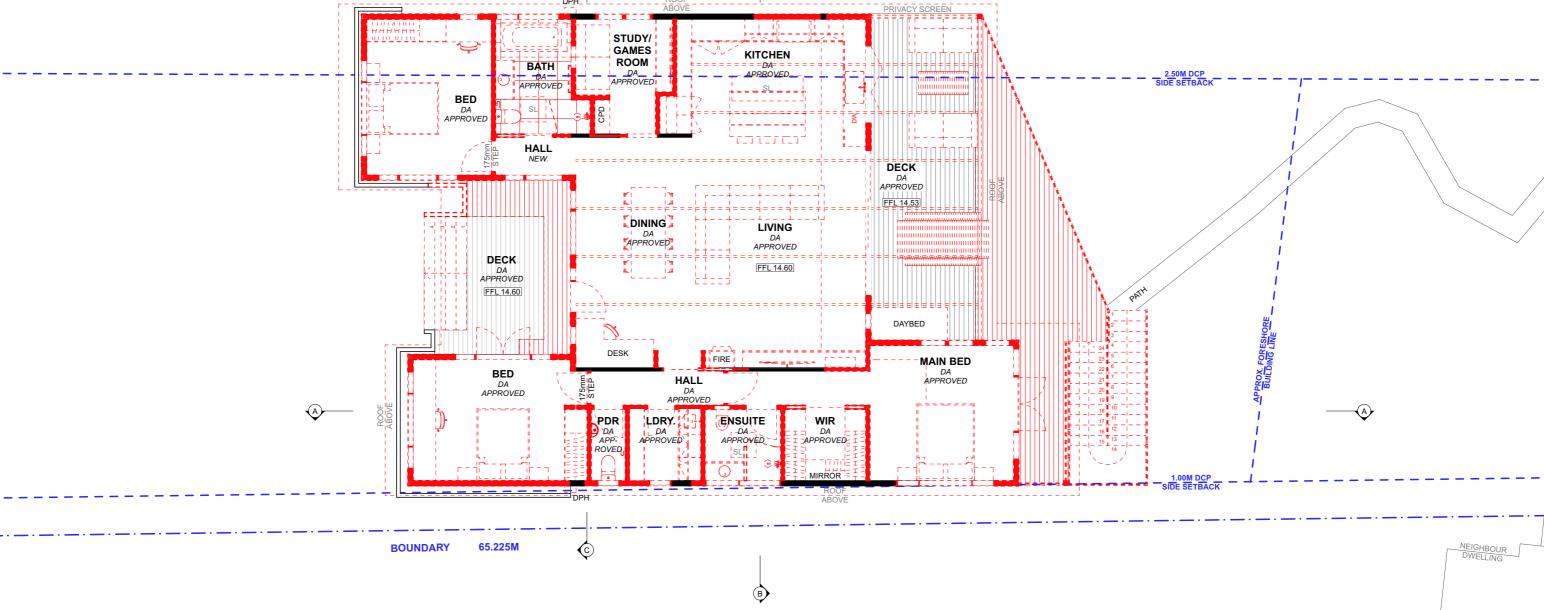

NEIGHBOUR SECONDARY DWELLING

### DA APPROVED GROUND FLOOR PLAN 1:100

NOTE: ALL DEMOLITION WORK TO BE CARRIED OUT IN ACCORDANCE WITH AS2601-2001

DRAWING TITLE:




progressive plans

16 BOWLING GREEN LANE AVALON, NSW, 2107 HELLO@PROGRESSIVEPLANS.COM.AU THE BUILDER SHALL CHECK AND VERIFY ALL DIMENSIONS AND VERIFY ALL ERROS AND OMISSIONS TO THE DRAFTING OFFICE. DO NOT SCALE THE DRAWING. THE WORK MUST BE VERIFIED BY STRUCTURAL ENGINEER BEFORE WORK COMMENCES.

REV.	NOTES.	INITIAL	DATE	LEGEND
Α	\$4.55 SET	SB	15.12.23	EXISTING
				REMOVED DA
				PROPOSED
				REVERTED TO EXISTING
				REVERTED TO EXISTING
				1


CPD: CUPBOARD
DP: DOWNPIPE
DPS: DOWN PIPE SPITTER
DPH: DOWN PIPE RAIN HEAD
FEL: FINISHED FLOOR LEVEL
FW: FLOOR WASTE
HWS: HOT WATER SYSTEM
RL: REDUCED LEVEL
SA: SMOKE ALARM

ABBREVIATIONS

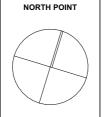



**KERRY & KURT HAMANN** SITE ADDRESS:

DA APPROVED GROUND FLOOR PLAN 1:100 @A3 18/12/2023 43 FLORENCE TERRACE PROJECT NO: SCOTLAND ISLAND, NSW, 2105 1010 S4.55 07

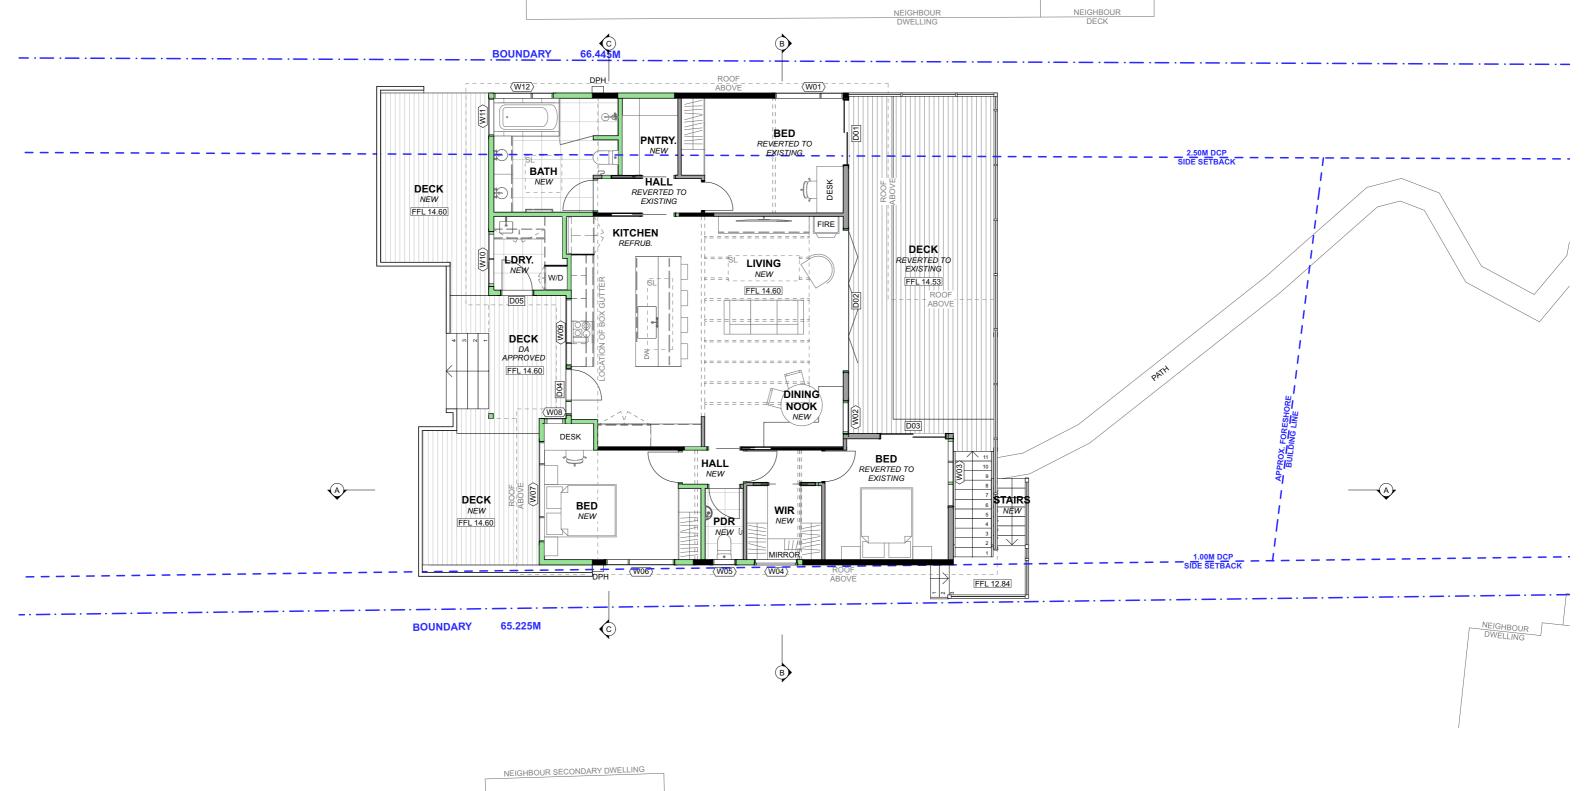

# 1 PROPOSED GROUND FLOOR PLAN 1:100

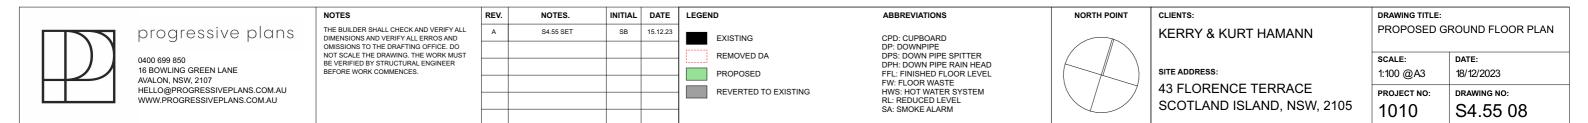

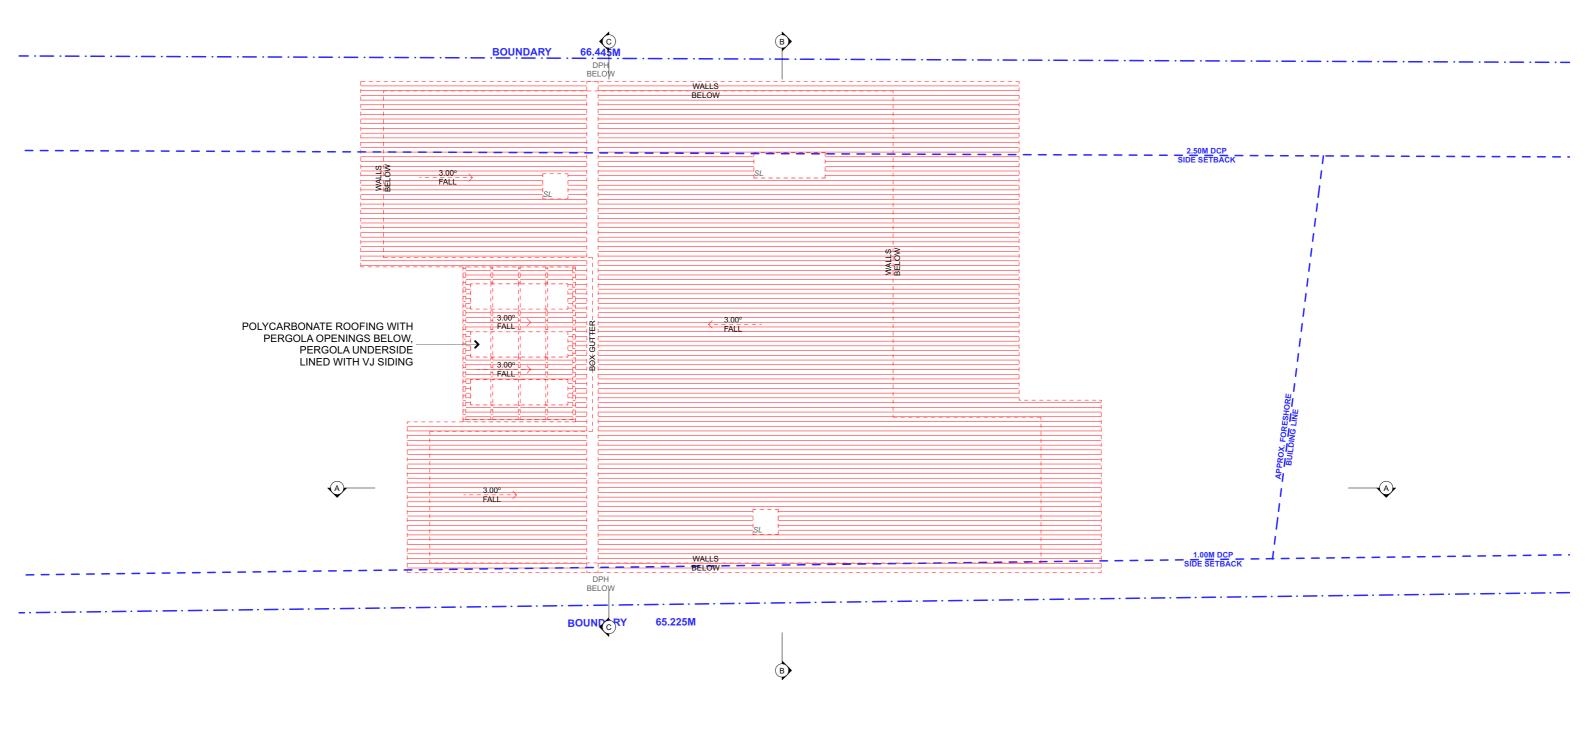

# DA APPROVED ROOF PLAN

1:100

NOTE: ALL DEMOLITION WORK TO BE CARRIED OUT IN ACCORDANCE WITH AS2601-2001




progressive plans

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REV.	NOTES.	INITIAL	DATE	LEGEND
Α	\$4.55 SET	SB	15.12.23	EXISTING
				REMOVED DA
				PROPOSED
				REVERTED TO EXISTING

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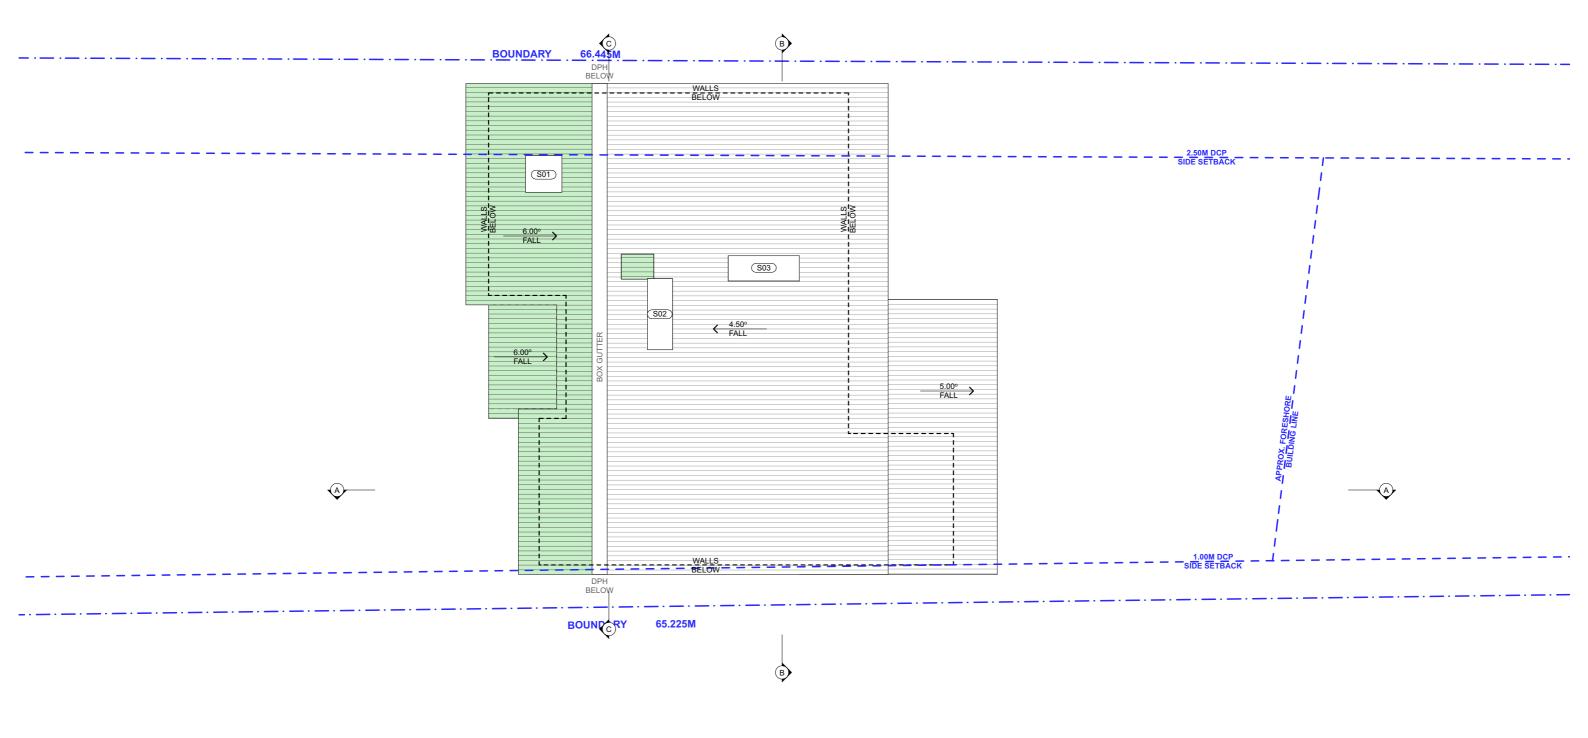
ABBREVIATIONS



CLIENTS:
KERRY & KURT HAMANN
SITE ADDRESS:
43 FLORENCE TERRACE

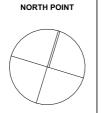SCOTLAND ISLAND, NSW, 2105

DRAWING TITLE: DA APPROVED ROOF PLAN		
SCALE: 1:100 @A3	DATE: 18/12/2023	
PROJECT NO: 1010	DRAWING NO: S4.55 09	



# 1 PROPOSED ROOF / CONCEPT STORMWATER PLAN 1:100

NOTE: PROPOSED DOWNPIPES TO DRAIN INTO EXISTING STORMWATER LINES



progressive plans

0400 699 850


16 BOWLING GREEN LANE
AVALON, NSW, 2107
HELLO@PROGRESSIVEPLANS.COM.AU
WWW.PROGRESSIVEPLANS.COM.AU

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REV.	NOTES.	INITIAL	DATE	LEGEND
Α	\$4.55 SET	SB	15.12.23	EXISTING
				REMOVED DA
				PROPOSED
				REVERTED TO EXISTING


CPD: CUPBOARD
DP: DOWNPIPE
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FFL: FINISHED FLOOR LEVEL
FW: FLOOR WASTE
HWS: HOT WATER SYSTEM
RL: REDUCED LEVEL
SA: SMOKE ALARM


ABBREVIATIONS

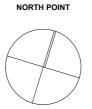


CLIENTS:
KERRY & KURT HAMANN

site address: 43 FLORENCE TERRACE SCOTLAND ISLAND, NSW, 2105

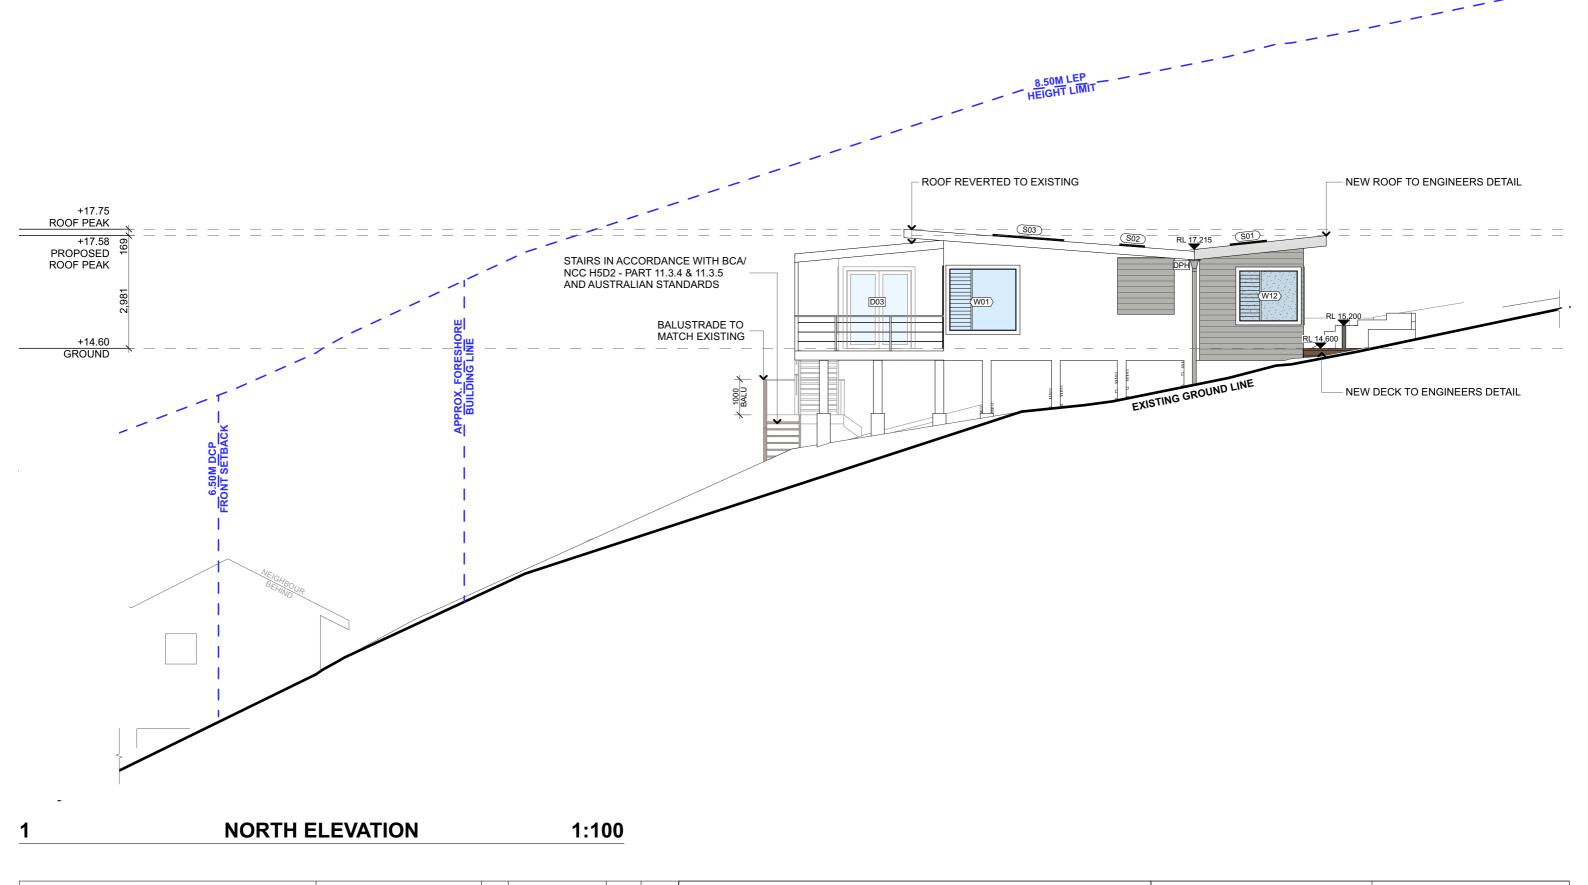

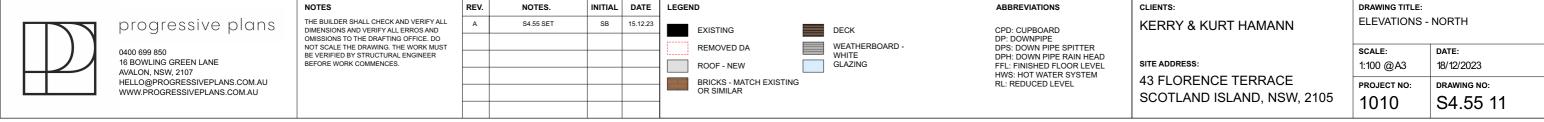

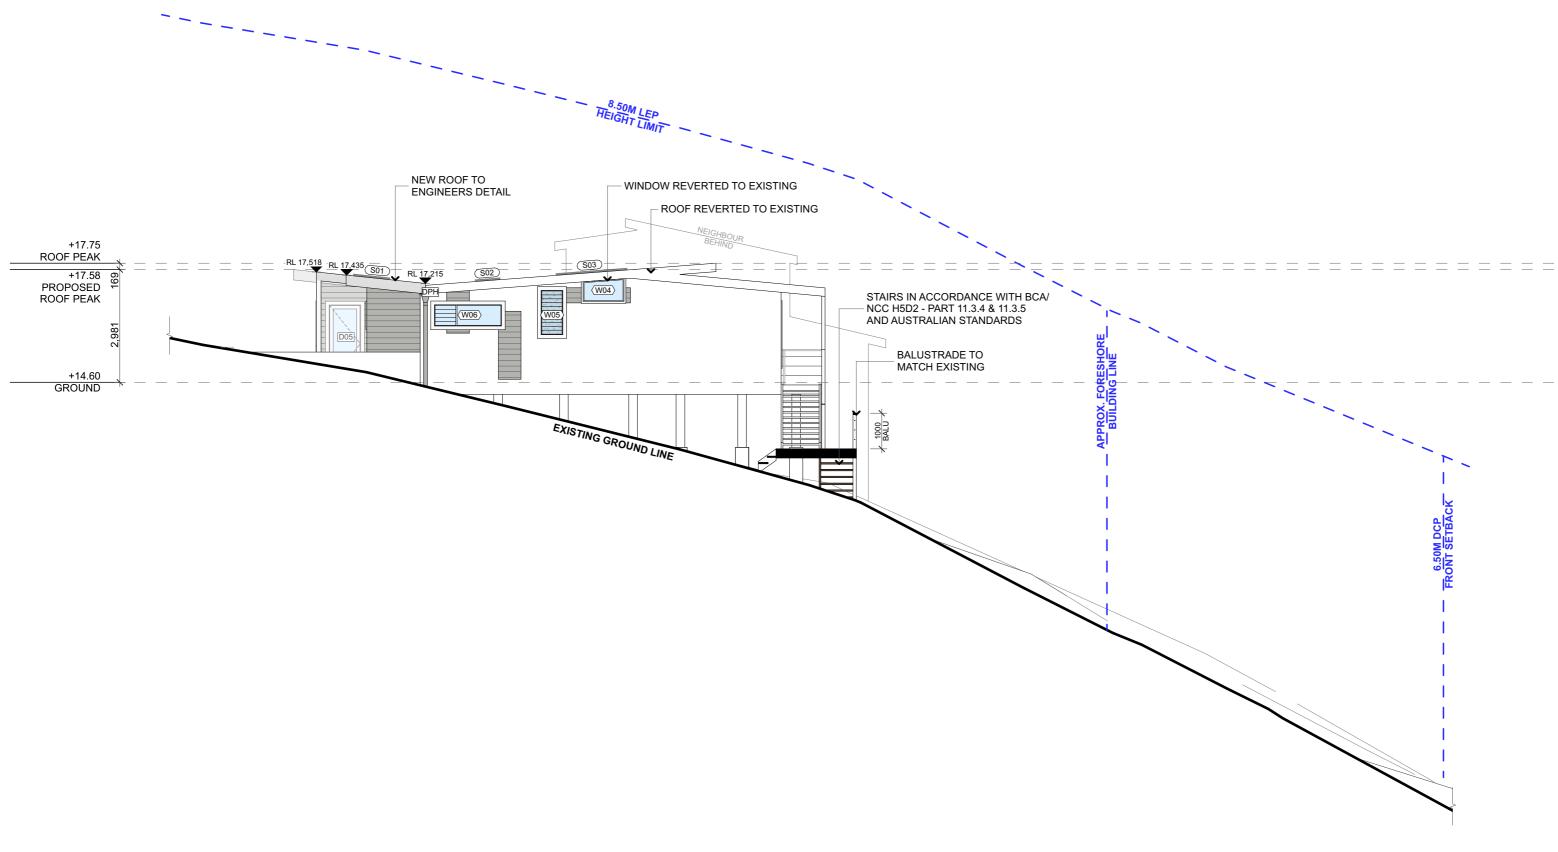

**SOUTH ELEVATION** 1:100



NOTES
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REV.	NOTES.	INITIAL	DATE	LEGEND
Α	\$4.55 SET	SB	15.12.23	EXISTING DECK
				REMOVED DA WEATHERBOARD - WHITE
				ROOF - NEW GLAZING
				BRICKS - MATCH EXISTING OR SIMILAR

CPD: CUPBOARD
DP: DOWNPIPE
DPS: DOWN PIPE SPITTER
DPH: DOWN PIPE RAIN HEAD
FFL: FINISHED FLOOR LEVEL
HWS: HOT WATER SYSTEM
RI · REDUCED I EVEL


ABBREVIATIONS

CLIENTS:
KERRY & KURT HAMANN
SITE ADDRESS:
43 FLORENCE TERRACE
SCOTLAND ISLAND, NSW, 2105

DRAWING TITLE:	DRAWING TITLE:					
ELEVATIONS - SOUTH						
SCALE:	DATE:					
1:100 @A3	18/12/2023					
PROJECT NO:	DRAWING NO:					
1010	S4.55 12					


# BUSHFIRE BAL 12.5 RATING ALL BUILDING WORKS TO COMPLY AND MEET THE REQUIREMENTS OF AS1530 & AS3959


**NOTE**: HEIGHT LIMIT IS RELATIVE TO THE LOCATION OF THE ELEVATION

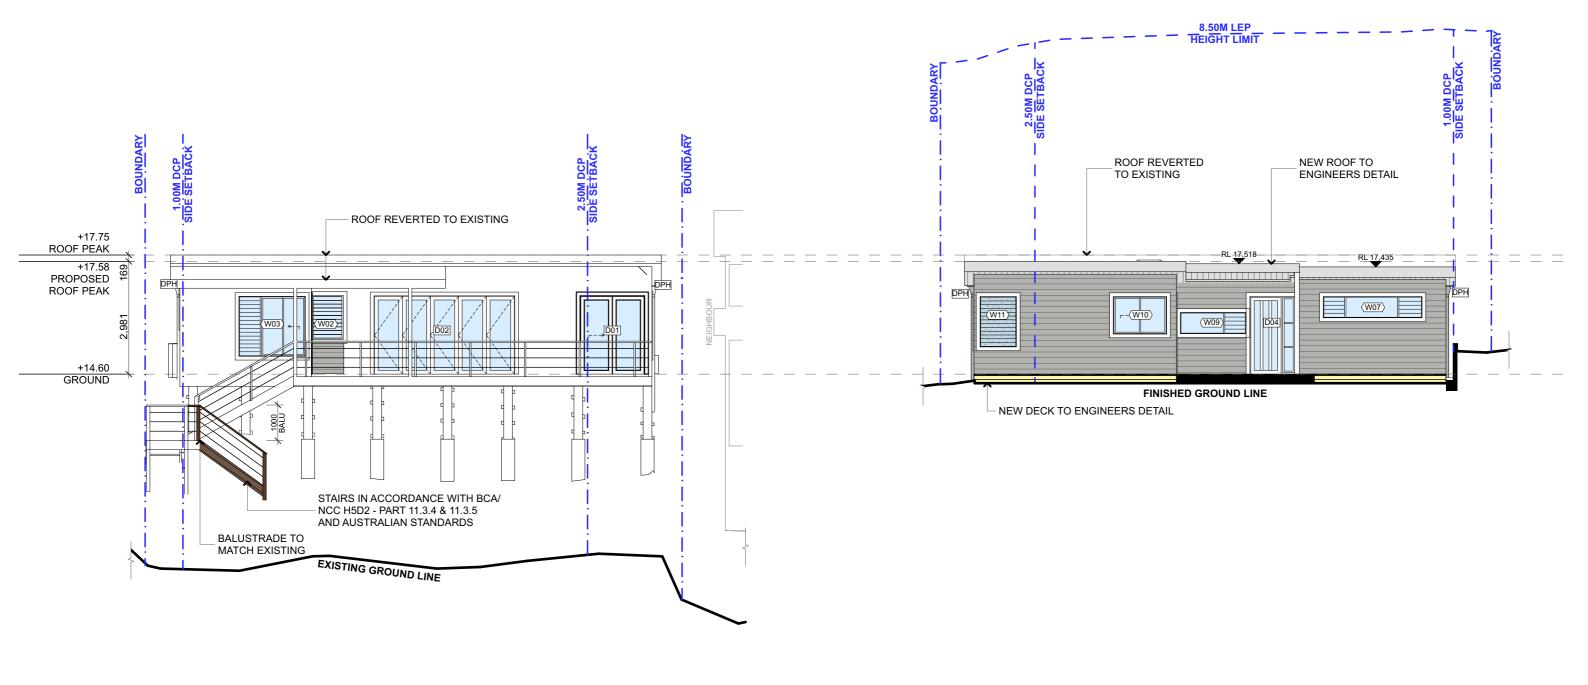


1 EAST ELEVATION 1:100 2 WEST ELEVATION 1:100



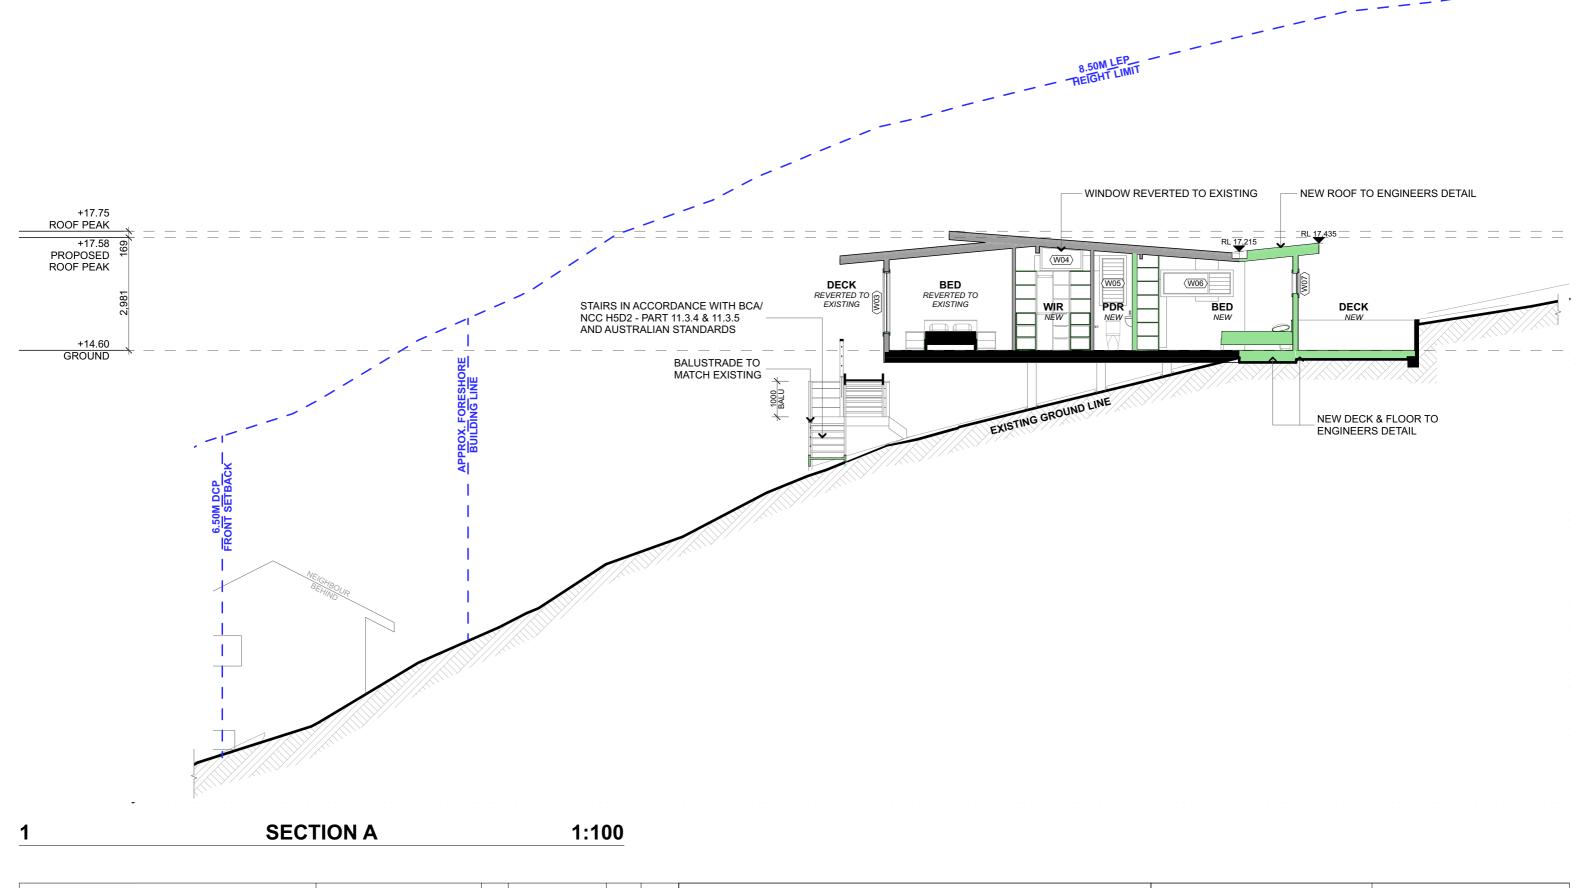

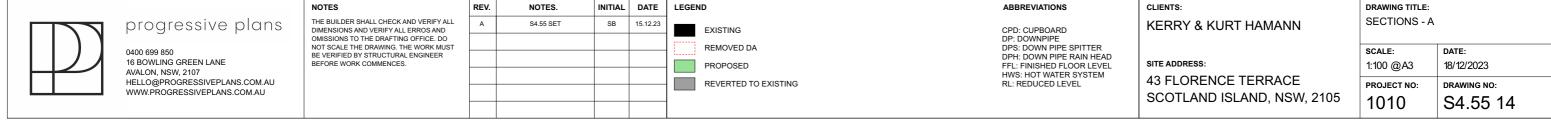

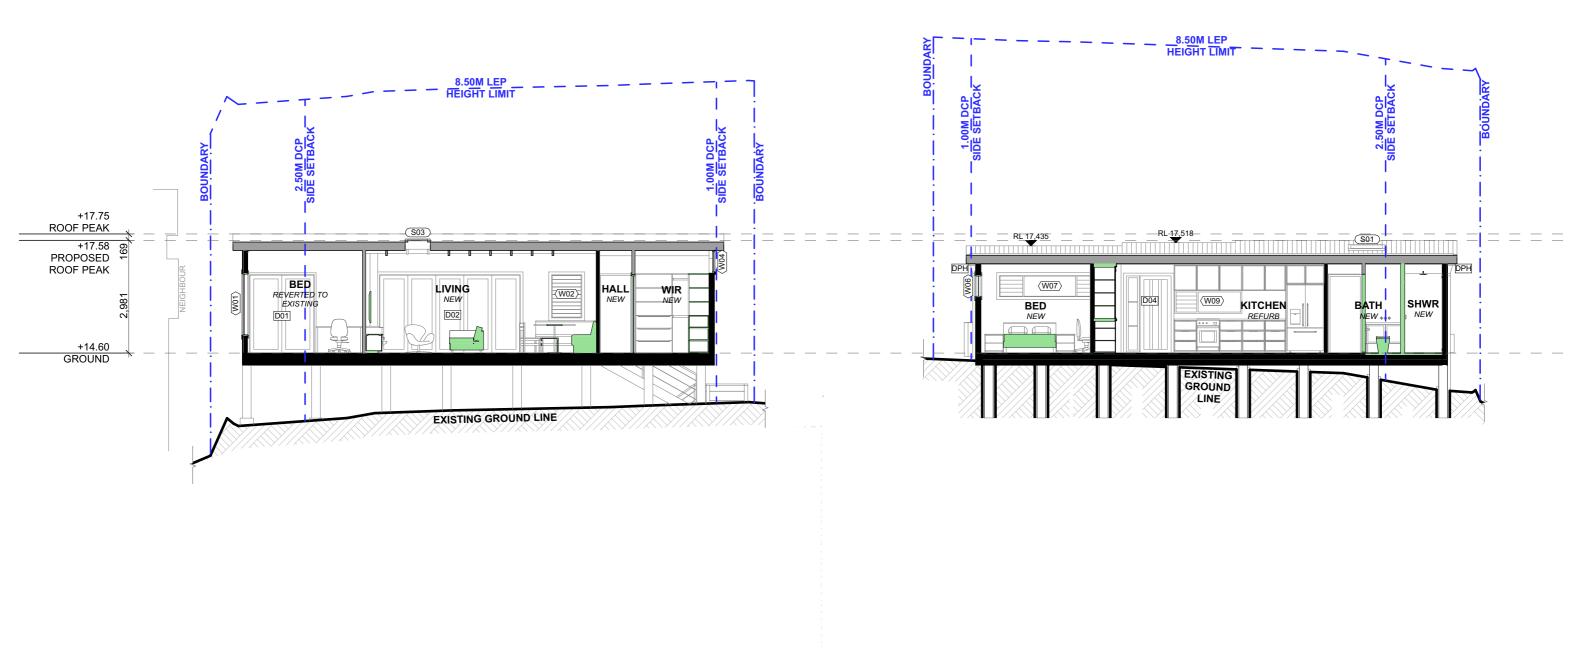


<u>1 SECTION B 1:100</u> <u>2 SECTION C 1:100</u>



NOTES
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REV.	NOTES.	INITIAL	DATE	LEGEND
Α	\$4.55 SET	SB	15.12.23	EXISTING
				,
				REMOVED DA
				PROPOSED
				PROPOSED
				REVERTED TO EXISTING

DRAWING TITLE:						
SECTIONS - B & C						
SCALE:	DATE:					
1:100 @A3	18/12/2023					
PROJECT NO:	DRAWING NO:					
	2.0					
1010	S4.55 15					



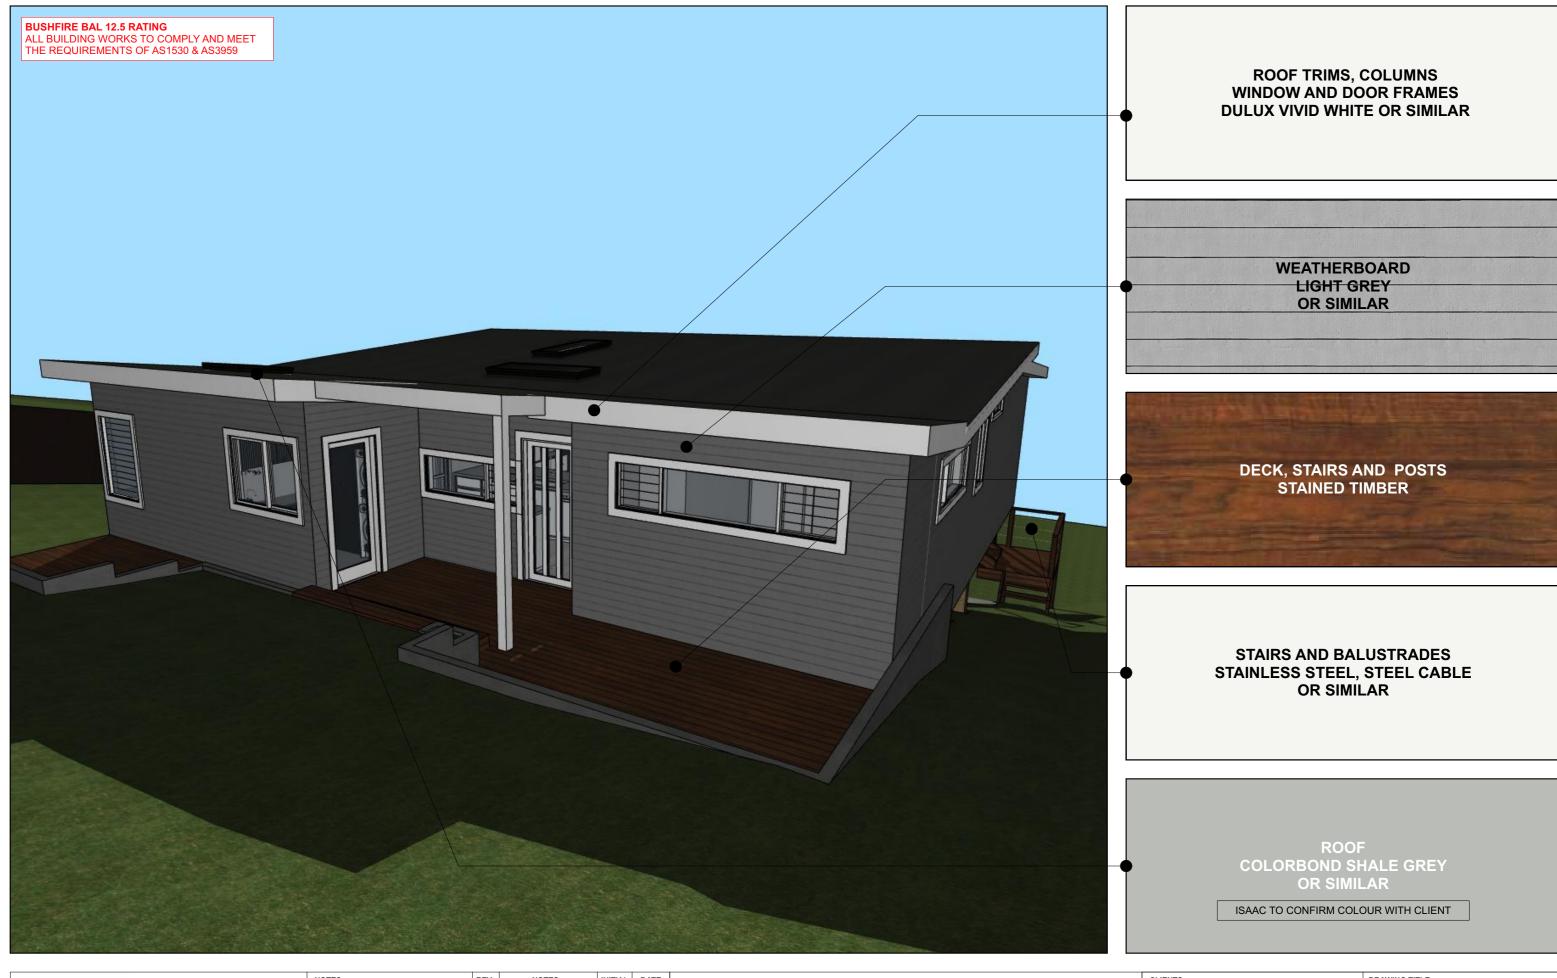

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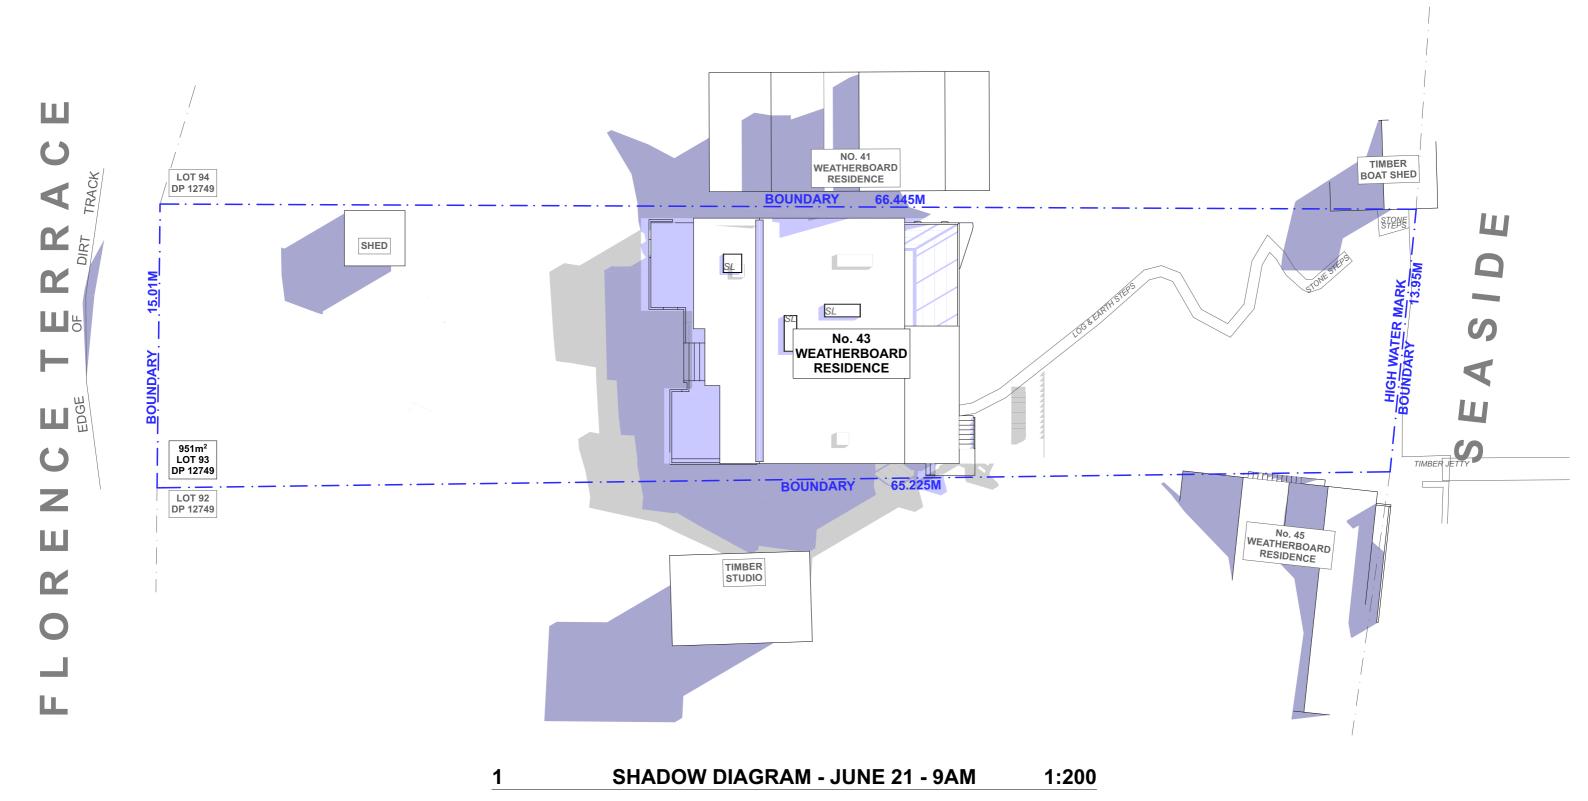
REV.	NOTES.	INITIAL	DAIE	
Α	\$4.55 SET	SB	15.12.23	


**KERRY & KURT HAMANN** 


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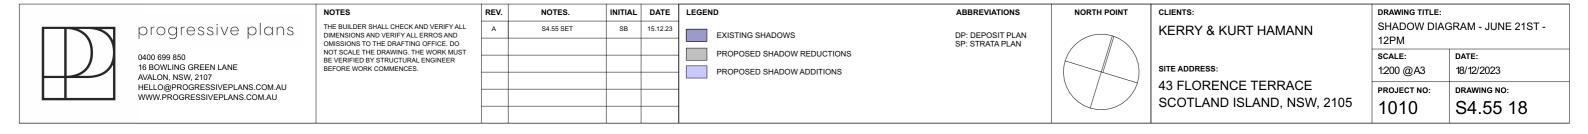
43 FLORENCE TERRACE SCOTLAND ISLAND, NSW, 2105 DRAWING TITLE: FINISHES BOARD


SCALE: NTS 18/12/2023 PROJECT NO: 1010 S4.55 16






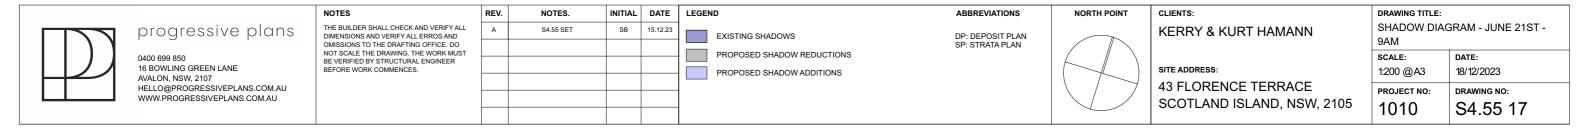

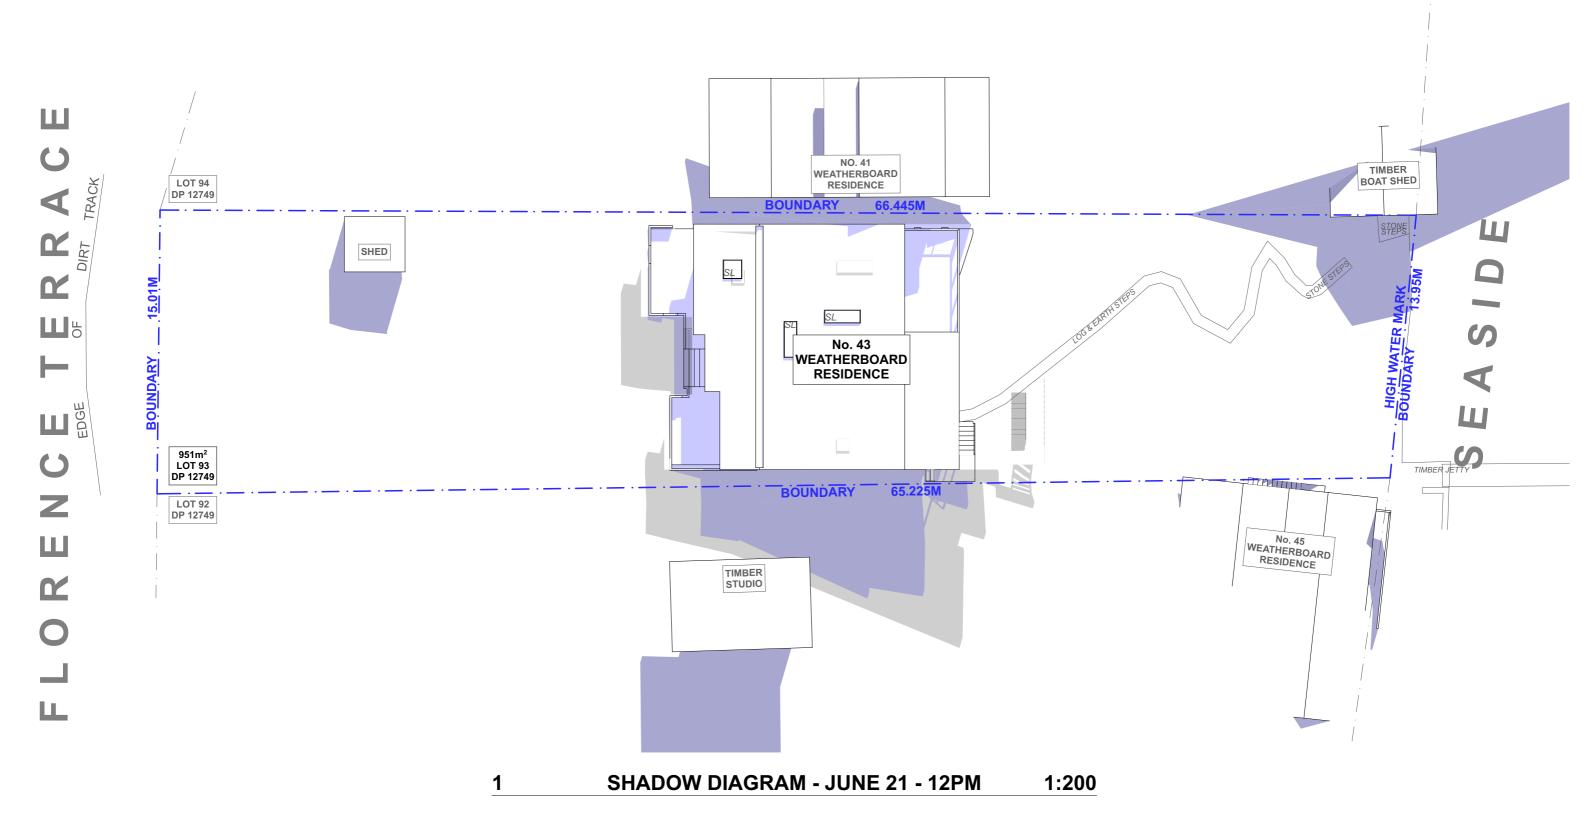

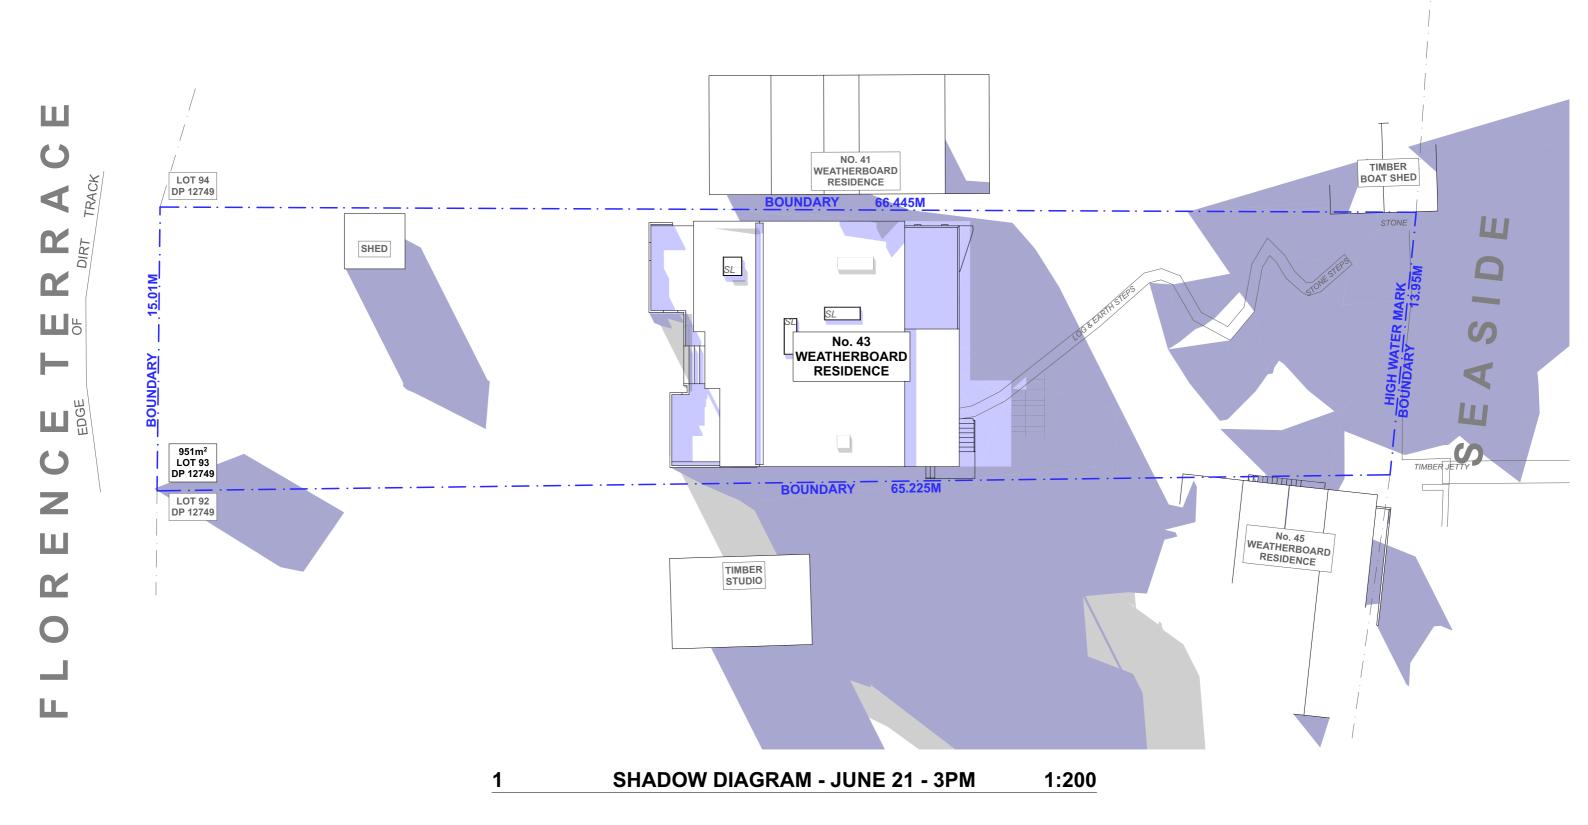

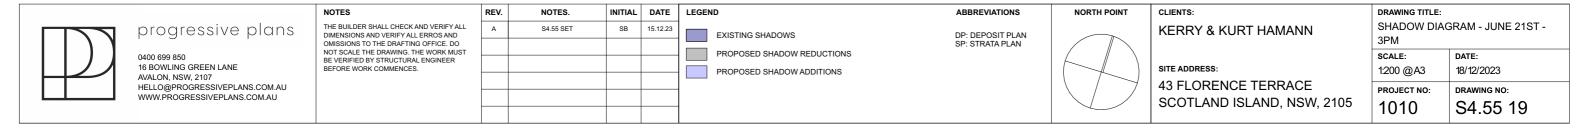



### Alterations and Additions

Certificate number: A1730672

This certificate confirms that the proposed development will meet the NSW government's requirements for sustainability, if it is built in accordance with the commitments set out below. Terms used in this certificate, or in the commitments, have the meaning given by the document entitled "BASIX Definitions" dated 10/09/2020 published by the Department. This document is available at www.basix.nsw.gov.au

Secretary
Date of issue: Monday, 18 December 2023
To be valid, this certificate must be lodged within 3 months of the date of issue.



Name / Company Name: Progressive Plans					
Certificate Prepared by (pleas	se complete before submitting to Council or PCA)				
N/A	My renovation work is valued at \$50,000 or m and does not include a pool (and/or spa).  N/A				
Type of alteration and addition					
Dwelling type	Separate dwelling house				
Project type					
Section number	12749				
Lot number					
Plan type and number	Deposited Plan 93				
Local Government Area	Northern Beaches Council				
Street address	43 FLORENCE TERRACE - SCOTLAND ISLAND 2105				
Project name	SCOTLAND ISLAND - 43 Florence Terrace				

Fixtures and systems			Show on DA Plans	Show on CC/CDC Plans & specs	Certifier Check
Lighting					
The applicant must ensure a minimum of emitting-diode (LED) lamps.		~	~		
Fixtures			`		,
The applicant must ensure new or altered	d showerheads have a flow rate no greater than	9 litres per minute or a 3 star water rating.		~	-
The applicant must ensure new or altered rating.	d toilets have a flow rate no greater than 4 litres	per average flush or a minimum 3 star water		~	~
The applicant must ensure new or altered	d taps have a flow rate no greater than 9 litres pe	er minute or minimum 3 star water rating.		~	
Construction			Show on DA Plans	Show on CC/CDC Plans & specs	Certifie Check
Insulation requirements					
listed in the table below, except that a) a	altered construction (floor(s), walls, and ceilings/ dditional insulation is not required where the are rts of altered construction where insulation alrea	a of new construction is less than 2m2, b)	~	~	~
Construction	Additional insulation required (R-value)	Other specifications			
suspended floor with open subfloor: framed (R0.7).	R0.8 (down) (or R1.50 including construction)	N/A			
external wall: framed (weatherboard, fibro, metal clad)	R1.30 (or R1.70 including construction)				
raked ceiling, pitched/skillion roof: framed	ceiling: R3.00 (up), roof: foil/sarking	medium (solar absorptance 0.475 - 0.70)			
Glazing requirements	Show on DA Plans	Show on CC/CDC Plans & specs	Certifie Check		
Windows and glazed doors					
	lazed doors and shading devices, in accordance ations must be satisfied for each window and gla		~	~	-
The following requirements must also be	satisfied in relation to each window and glazed of	door:		~	~
Each window or glazed door with standar description, or, have a U-value and a So U-values and SHGCs must be calculated		~	~		
Each window or glazed door with improvemust have a U-value and a Solar Heat Gand SHGCs must be calculated in accorprovided for information only. Alternative		~	~		
For projections described in millimetres, 1 500 mm above the head of the window of	~	~	~		
Pergolas with polycarbonate roof or simil		~	~		
			Ι.		
Pergolas with fixed battens must have ba also shades a perpendicular window. Th	e spacing between battens must not be more that			~	

**BUSHFIRE BAL 12.5 RATING** ALL BUILDING WORKS TO COMPLY AND MEET THE REQUIREMENTS OF AS1530 & AS3959



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REV.	NOTES.	INITIAL	DATE
Α	\$4.55 SET	SB	15.12.23

NOTES

1	
	- DOORS, WINDOWS & SKYLIGHTS TO MEET BASIX/NATHERS REQUIREMENTS
	- DOORS, WINDOWS & SKYLIGHTS TO BE ORDERED TO MEASURE BY BUILDER/SUPPL
	NEW WINDOWS TO BEDDOOMS IN ACCORDANCE WITH DART SO SO SENSO

- NEW WINDOWS TO BEDROOMS IN ACCORDANCE WITH PART 3.9.2.6 OF NCC
- NEW WINDOWS TO ROOMS OTHER THAN BEDROOMS IN ACCORDANCE WITH PART 3.9.2.7 OF NCC

KERRY & KURT HAMANN SITE ADDRESS: 43 FLORENCE TERRACE SCOTLAND ISLAND, NSW, 2105

DRAWING TITLE:						
BASIX REQUIREMENTS						
SCALE:	DATE:					
	18/12/2023					
PROJECT NO:	DRAWING NO:					
1010	S4.55 20					

Glazing requirements								Show on CC/CDC Plans & specs	Certifier Check
Windows and glazed doors glazing requirements									
Window/door number	Orientation	Area of glass including frame (m2)	Overshadowing height (m)	Overshadowing distance (m)	Shading device	Frame and glass type			
W01	N	3.01	3.21	1.97	eave/ verandah/ pergola/balcony >=450 mm	standard aluminium, single clear, (or U-value: 7.63, SHGC: 0.75)			
W08	N	0.66	0	0	eave/ verandah/ pergola/balcony >=450 mm	standard aluminium, single clear, (or U-value: 7.63, SHGC: 0.75)			
W12	N	2.15	1.02	1.97	eave/ verandah/ pergola/balcony >=450 mm	standard aluminium, single pyrolytic low-e, (U- value: 5.7, SHGC: 0.47)			
D03	N	3.6	0	0	eave/ verandah/ pergola/balcony >=900 mm	standard aluminium, single clear, (or U-value: 7.63, SHGC: 0.75)			
D01	Е	3.61	0	0	eave/ verandah/ pergola/balcony >=900 mm	standard aluminium, single clear, (or U-value: 7.63, SHGC: 0.75)			
D02	Е	7.94	0	0	eave/ verandah/ pergola/balcony >=900 mm	standard aluminium, single clear, (or U-value: 7.63, SHGC: 0.75)			
W02	Е	1.03	0	0	eave/ verandah/ pergola/balcony >=900 mm	standard aluminium, single clear, (or U-value: 7.63, SHGC: 0.75)			
W03	Е	2.91	0	0	eave/ verandah/ pergola/balcony >=900 mm	standard aluminium, single clear, (or U-value: 7.63, SHGC: 0.75)			
W05	S	0.74	0	0	eave/ verandah/ pergola/balcony >=450 mm	standard aluminium, single clear, (or U-value: 7.63, SHGC: 0.75)			
W06	S	1.08	0	0	eave/ verandah/ pergola/balcony >=450 mm	standard aluminium, single clear, (or U-value: 7.63, SHGC: 0.75)			
D05	S	1.67	0	0	eave/ verandah/ pergola/balcony >=900 mm	standard aluminium, single clear, (or U-value: 7.63, SHGC: 0.75)			
W07	W	1.59	0	0	eave/ verandah/ pergola/balcony >=600 mm	improved aluminium, single pyrolytic low-e, (U- value: 4.48, SHGC: 0.46)			
W09	W	1.06	0	0	eave/ verandah/ pergola/balcony >=900 mm	standard aluminium, single clear, (or U-value: 7.63, SHGC: 0.75)			
W10	W	1.49	15.69	5.09	eave/ verandah/ pergola/balcony >=600 mm	standard aluminium, single clear, (or U-value: 7.63, SHGC: 0.75)			
W11	W	1.37	15.69	5.09	eave/ verandah/ pergola/balcony >=600 mm	standard aluminium, single clear, (or U-value: 7.63, SHGC: 0.75)			

Blazing require	ements						Show on DA Plans	Show on CC/CDC Plans & specs	Certifie Check
Window/door number	Orientation	Area of glass including frame (m2)	Overshadowing height (m)	Overshadowing distance (m)	Shading device	Frame and glass type			
D04	W	2.57	0	0	eave/ verandah/ pergola/balcony >=900 mm	standard aluminium, single clear, (or U-value: 7.63, SHGC: 0.75)			
kylights									
The applicant must install the skylights in accordance with the specifications listed in the table below.						-	<b>✓</b>	-	
The following requirements must also be satisfied in relation to each skylight:							~	~	
Each skylight may either match the description, or, have a U-value and a Solar Heat Gain Coefficient (SHGC) no greater than that listed in the table below.								~	_
kylights glazing	requirements								
Skylight numbe		rea of glazing inc. f	rame Shadin	g device	Frame and	glass type			
S01	0	.95	no shad	ling		ole clear/air fill, (or s, SHGC: 0.5)			
S02	1	.29	no shad	ling	timber, low-E internal/argon fill/clear external, (or U-value: 2.5, SHGC: 0.456)				
S03	1	.29	no shad	ling		E internal/argon ernal, (or U-value: 0.456)			
egend.			· · · · · · · · · · · · · · · · · · ·	_					
these commitme	nts, "applicant" me	eans the person carry	ring out the develop	ment.					
		the "Show on DA plan		shown on the plans	s accompanying the	e development appli	cation for the p	proposed development (	if a
		the "Show on CC/CDo certificate for the prop			wn in the plans and	specifications accor	npanying the a	application for a constru	ction
ommitments iden	tified with a 🗸 in t	the "Certifier check" c	column must be cert	ified by a certifying	authority as having	been fulfilled, befor	e a final occup	ation certificate for the	developm

**BUSHFIRE BAL 12.5 RATING** ALL BUILDING WORKS TO COMPLY AND MEET THE REQUIREMENTS OF AS1530 & AS3959



progressive plans

0400 699 850 16 BOWLING GREEN LANE AVALON, NSW, 2107 HELLO@PROGRESSIVEPLANS.COM.AU WWW.PROGRESSIVEPLANS.COM.AU

THE BUILDER SHALL CHECK AND VERIFY ALL DIMENSIONS AND VERIFY ALL ERROS AND OMISSIONS TO THE DRAFTING OFFICE. DO NOT SCALE THE DRAWING. THE WORK MUST BE VERIFIED BY STRUCTURAL ENGINEER BEFORE WORK COMMENCES.

REV.	NOTES.	INITIAL	DATE	NOTES
Α	\$4.55 SET	SB	15.12.23	- DOORS
				- DOORS - NEW W
				- NEW W

- DOORS, WINDOWS & SKYLIGHTS TO MEET BASIX/NATHERS REQUIREMENTS
- DOORS, WINDOWS & SKYLIGHTS TO BE ORDERED TO MEASURE BY BUILDER/SUPPLIER
- NEW WINDOWS TO BEDROOMS IN ACCORDANCE WITH PART 3.9.2.6 OF NCC
- NEW WINDOWS TO ROOMS OTHER THAN BEDROOMS IN ACCORDANCE WITH PART 3.9.2.7 OF NCC

KERRY & KURT HAMANN

DRAWING TITLE: BASIX REQUIREMENTS DATE: 18/12/2023 DRAWING NO: 1010 S4.55 21

SITE ADDRESS: 43 FLORENCE TERRACE SCOTLAND ISLAND, NSW, 2105