

ACTION PLANS

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SECTION 4.55 DA: 2023/0921

MOD00 COVER MOD01 EXISTING GROUND FLOOR PLAN

MOD02 EXISTING FIRST FLOOR PLAN

MOD03 PROPOSED GROUND FLOOR PLAN

MOD04 PROPOSED FIRST FLOOR PLAN

MOD05 PROPOSED NORTH / FAST FLEVATION

MOD05 PROPOSED NORTH / EAST ELEVATIONS


MOD06 PROPOSED SOUTH / WEST ELEVATIONS

MOD07 PROPOSED CROSS / LONG SECTIONS

ITEM DETAILS	DEVELOPMENT APPLICATION			
ADDRESS	16 WORCESTER ST, COLLAROY NSW,	2097		
LOT & DP/SP	LOT 3 SECTION 19 D.P.12012			
COUNCIL	NORTHERN BEACHS COUNCIL (WARR	INGAH)		
SITE AREA	696.8m²			
FRONTAGE	15.24m			
CONTROLS	PERMISSIBLE / REQUIRED	EXISTING	PROPOSED	COMPLIANCE
	m / m² / %	m / m² / %	m / m² / %	
<u>LEP</u>				
LAND ZONING	R2 – LOW DENSITY RESIDENTIAL	R2	R2	YES
MINIMUM LOT SIZE	600m²	696.8m²	UNCHANGED	YES
MAXIMUM BUILDING HEIGHT	8.5m	8.215m	UNCHANGED	YES
DCP				
WALL HEIGHT	7.2m	5.995m	UNCHANGED	YES
NUMBER OF STOREYS	2	2	UNCHANGED	YES
SIDE BOUNDARY ENVELOPE	4m		UNCHANGED	YES
SIDE BOUNDARY SETBACKS	0.9m	N: 3.616m S: 0.86m	N: 0.212m S: 0.86m	NO
FRONT BOUNDARY SETBACK	6.5m	6.61m	UNCHANGED	YES
REAR BOUNDARY SETBACK	6.0m	17.85m	19.395	YES
LANDSCAPE OPEN SPACE	40% (278.72m²)	20.9% (145.67m²)	38.47% (268.06m²)	NO
PRIVATE OPEN SPACE	60m²	60m²	60m²	YES

16 WORCESTER ST, COLLAROY NSW, 2097



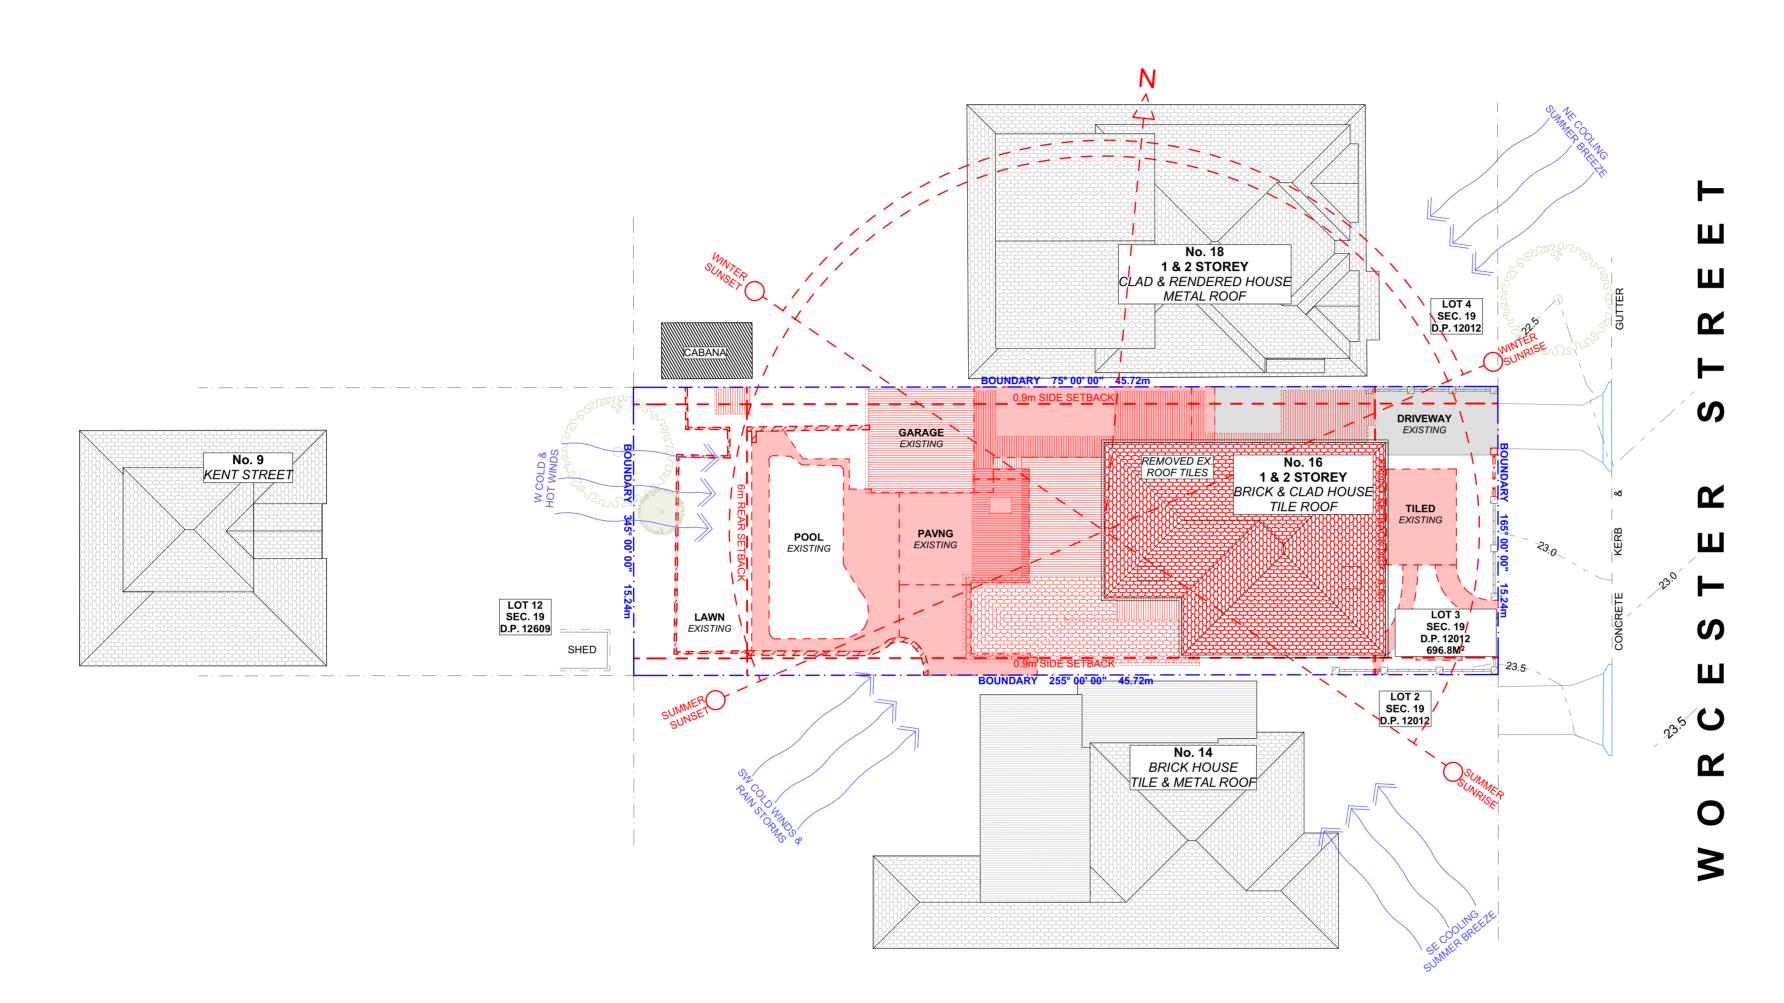





SITE ANALYSIS PLAN - DEMOLITION

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1:200

CLIENT ALEXIS AND DEAN HOUDEN

DRAWING NO. MOD01

DRAWING NAME SITE ANALYSIS

REV. DATE COMMENTS DRWN NOTES

NOTES

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Do not scale measure from drawings. Figured dimensions are to be used only.

The Builder/contractor/owner is to ensure that the approved boundary setbacks and approved levels are confirmed and set out by a registered Surveyor prior to construction, the boundary setbacks take precedence over all other dimensions.

The Builder/Contractor shall check and verify ALL dimensions on site prior to commencement of any work, creation of shop drawings, or fabrication of components.

All errors and omissions are to be verified by the Builder/Contractor/client and referred to the designer prior to the commencement of works.

EXISTING DEMOLISHED PROPOSED S4.55 CHANGES

PROJECT ADDRESS 16 WORCESTER ST, COLLAROY NSW, 2097

DATE Tuesday, 5 March 2024


SCALE 1:200 @A2

NOTE: ALL DEMOLISHED ELEMENTS TO ENG. SPECIFICATIONS AND AS. 2601 - 2001

External Finishes to Roof

The external finish to the roof shall have a medium to dark range (BCA rating M or D) in order to minimise solar reflections to neighbouring properties. Any roof with a metallic steel finish is not permitted. Colours are to be confirmed by the client

Eaves/fascia of the proposed roof to comply with part 3.7.2.7 of the NCC. terrace eaves to be lined in non-combustible fc sheet. Fascia to be timber if >450mm to boundary. Fascia to be non combustible if <450mm from boundary.

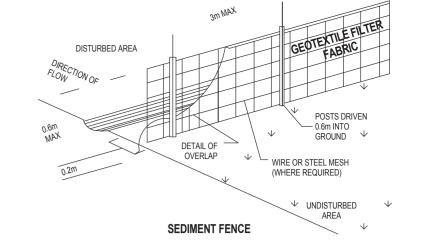

DUST CONTROL :

TO REDUCE DUST GENERATED BY WIND ACTION, THE REMOVAL OF THE TOP SOIL IS TO BE MINIMISED. TO PREVENT DUST GENERATION, WATERING DOWN OF THE SITE, ESPECIALLY DURING THE MOVEMENT OF MACHINERY IS REQUIRED. WHERE EXCAVATING INTO ROCK, KEEP THE SURFACE MOIST TO MINIMISE DUST. CONSTRUCT A GRAVEL ENTRY/EXIT POINT USING BLUE METAL AND RESTRICT ALL VEHICLE MOVEMENTS WITHIN THE SITE TO A MINIMUM. ENSURE WIND BREAKS, SUCH AS EXISTING FENCES ARE MAINTAINED DURING THE CONSTRUCTION PHASE UNTIL NEW LANDSCAPING IS PROVIDED OR REINSTATED. PREVENT DUST BY COVERING STOCKPILES

SEDIMENT NOTE:

1. ALL EROSION AND SEDIMENT CONTROL MEASURES TO BE INSPECTED AND MAINTAINED DAILY BY THE SITE 2. MINIMISE DISTURBED AREAS, REMOVE EXCESS SOIL

FROM EXCAVATEDAREA AS SOON AS POSSIBLE. 3. ALL MATERIAL STOCKPILE TO BE CLEAR FROM DRAINS, GUTTERS AND FOOTPATHS, OR WITHIN SEDIMENT FENCE AREA.

4. DRAINAGE TO BE CONNECTED TO STORMWATER AS SOON AS POSSIBLE. IF STORED ON SITE, IT MUST BE FILTERED BEFORE RELEASING INTO STORMWATER SYSTEM OR WATERWAYS.

5. ROADS AND FOOTPATHS TO BE SWEPT DAILY.

STOCKPILES:

ALL STOCKPILES ARE TO BE KEPT ON-SITE WHERE POSSIBLE. ANY MATERIALS PLACED ON THE FOOTPATHS OR NATURE STRIPS REQUIRE COUNCIL'S PERMISSION

ALL STOCKPILES ARE TO BE PLACED AWAY FROM THE DRAINAGE LINES AND STREET GUTTERS. IT IS BEST TO LOCATE THESE ON THE HIGHEST PART OF THE SITE IF POSSIBLE. PLACE WATERPROOF COVERING OVER STOCKPILES.

IF REQUIRED PROVIDE DIVERSION DRAIN & BANK AROUND STOCKPILES.

GUTTER PROTECTION:

PROVIDE PROTECTION TO DOWNHILL GRATE IN GUTTER BY MEANS OF SAND BAGS OR BLUE METAL WRAPPED IN GEOTEXTILE FABRIC. WHEN SOIL OR SAND BUILDS UP AROUND THIS SEDIMENT BARRIER, THE MATERIAL SHOULD BE RELOCATED BACK TO THE SITE FOR DISPOSAL

> NOTE: ALL PROPOSED STORMWATER TO CONNECT WITH EXISTING

NCC 2022 & AS COMPLIANCES SPECIFICATIONS

STRUCTURE - PART H1 & SECTION 2 OF NCC SITE PREPARATION - PART H1D3 & SECTION 3 OF NCC FOOTINGS & SLABS - PART H1D4 & SECTION 4 OF NCC - MASONRY - PART H1D5 & SECTION 5 OF NCC - FRAMING - PART H1D6 & SECTION 6 OF NCC - ROOF AND WALL CLADDING - PART H1D7 & SECTION 7 OF NCC GLAZING - PART H1D8 & SECTION 8 OF NCC - DAMP & WEATHERPROOFING - PART H2 OF NCC - FIRE SAFETY - PART H3 & SECTION 9 OF NCC - HEALTH & AMENITY - PART H4 & SECTION 10 OF NCC SAFE MOVEMENT & ACCESS - PART H5 & SECTION 11 0F NCC ANCILLARY PROVISIONS - PART H7 & SECTION 12 OF NCC SWIMMING POOLS - PART H7P1 & NSW H7D2 OF NCC CONSTRUCTION IN BUSHFIRE PRONE AREAS - PART NSW H7D4 OF NCC ENERGY EFFICIENCY - PART H6 & SECTION 13 OF NCC POOL FENCING & OTHER PROVISIONS - REGULATIONS, & AS 1926 WATERPROOFING OF WET AREAS TO COMPLY WITH AS 3740:2021 ALL PLUMBING & DRAINAGE WORK TO COMPLY WITH AS 3500:2021 ALL PLASTERBOARD WORK TO COMPLY WITH AS 2588:2018 ALL STRUCTURAL STEEL WORK TO COMPLY WITH AS 4100:2020 & AS 1554.1:2014 ALL CONCRETE WORK TO COMPLY WITH AS 3600:2018 ALL ROOF SHEETING WORK TO COMPLY WITH AS 1562.1:2018 ALL SKYLIGHTS TO COMPLY WITH AS 4285:2019 ALL CERAMIC TILING TO COMPLY WITH AS 3958.1-2007 & 3958.2-1992

ALL GLAZING ASSEMBLIES TO COMPLY WITH AS 2047-2014 & AS 1288:2021 ALL TIMBER RETAINING WALLS ARE TO COMPLY WITH AS 1720, AS 1170


ALL RETAINING WALLS ARE TO COMPLY WITH AS 3700:2018 & AS 3600:2018 ALL CONSTRUCTION IN BUSHFIRE-PRONE AREAS TO COMPLY WITH AS 3959:2018

DRAWING NO. DRAWING NAME

MOD02

SITE / ROOF / SEDIMENT EROSION / WASTE MANAGEMENT /



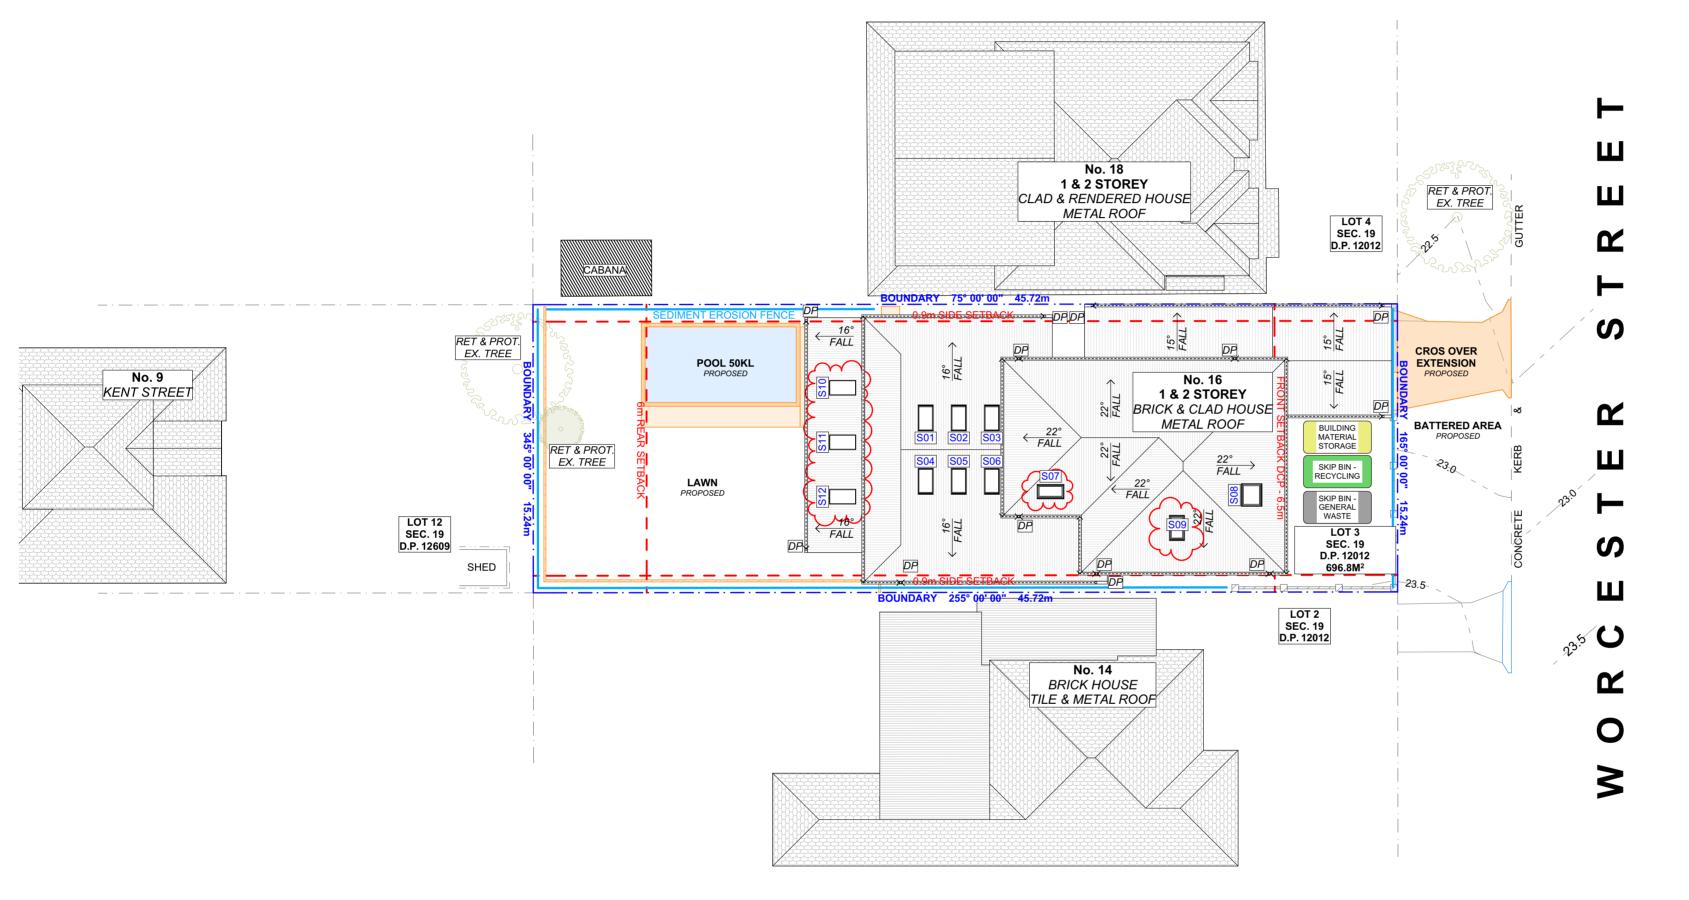


SITE / ROOF / SEDIMENT EROSION / WASTE MANAGEMENT / STORMWATER CONCEPT PLAN 1:200



COMMENTS DRWN NOTES REV. DATE This drawing is the copyright of Action Plans and not be altered, reproduced or transmitted in any form or by any means in part or in whole with the written permission of Action Plans. Do not scale measure from drawings. Figured dimensions are to be used only.

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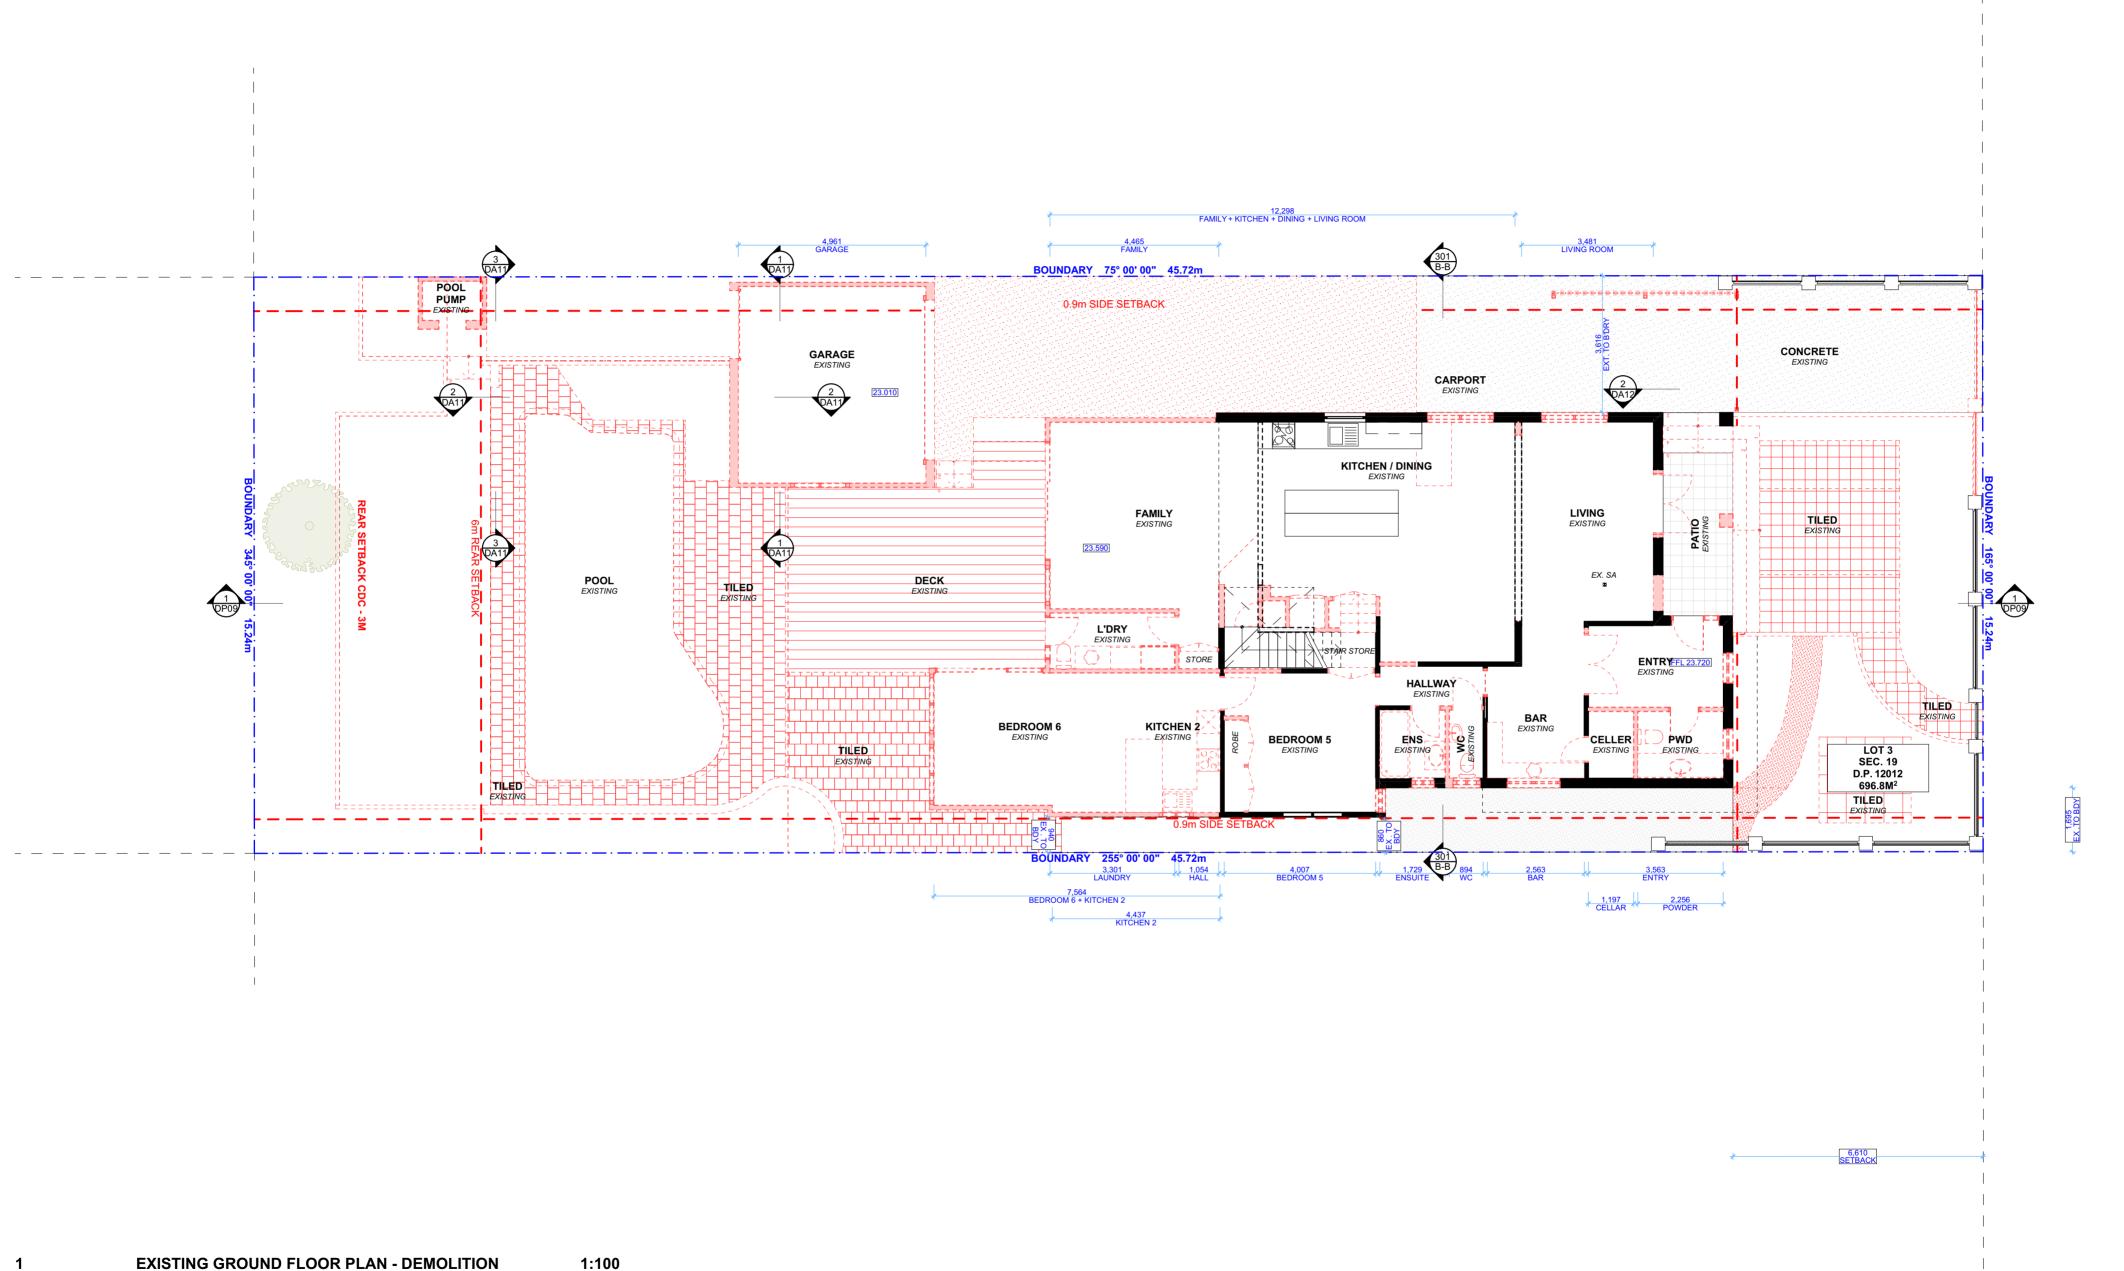
ALEXIS AND DEAN HOUDEN

CLIENT

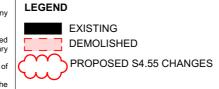PROJECT ADDRESS 16 WORCESTER ST, COLLAROY NSW, 2097 DATE

Tuesday, 5 March 2024 1:200 @A2

STORMWATER CONCEPT PLAN SCALE



EXISTING GROUND FLOOR PLAN - DEMOLITION

REV. DATE COMMENTS DRWN NOTES NOTES

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EXISTING DEMOLISHED PROPOSED S4.55 CHANGES CLIENT

ALEXIS AND DEAN HOUDEN PROJECT ADDRESS

16 WORCESTER ST,


COLLAROY NSW, 2097

DRAWING NO. DRAWING NAME EXISTING GROUND FLOOR PLAN MOD03

SCALE

1:100 @A2

DATE Tuesday, 5 March 2024

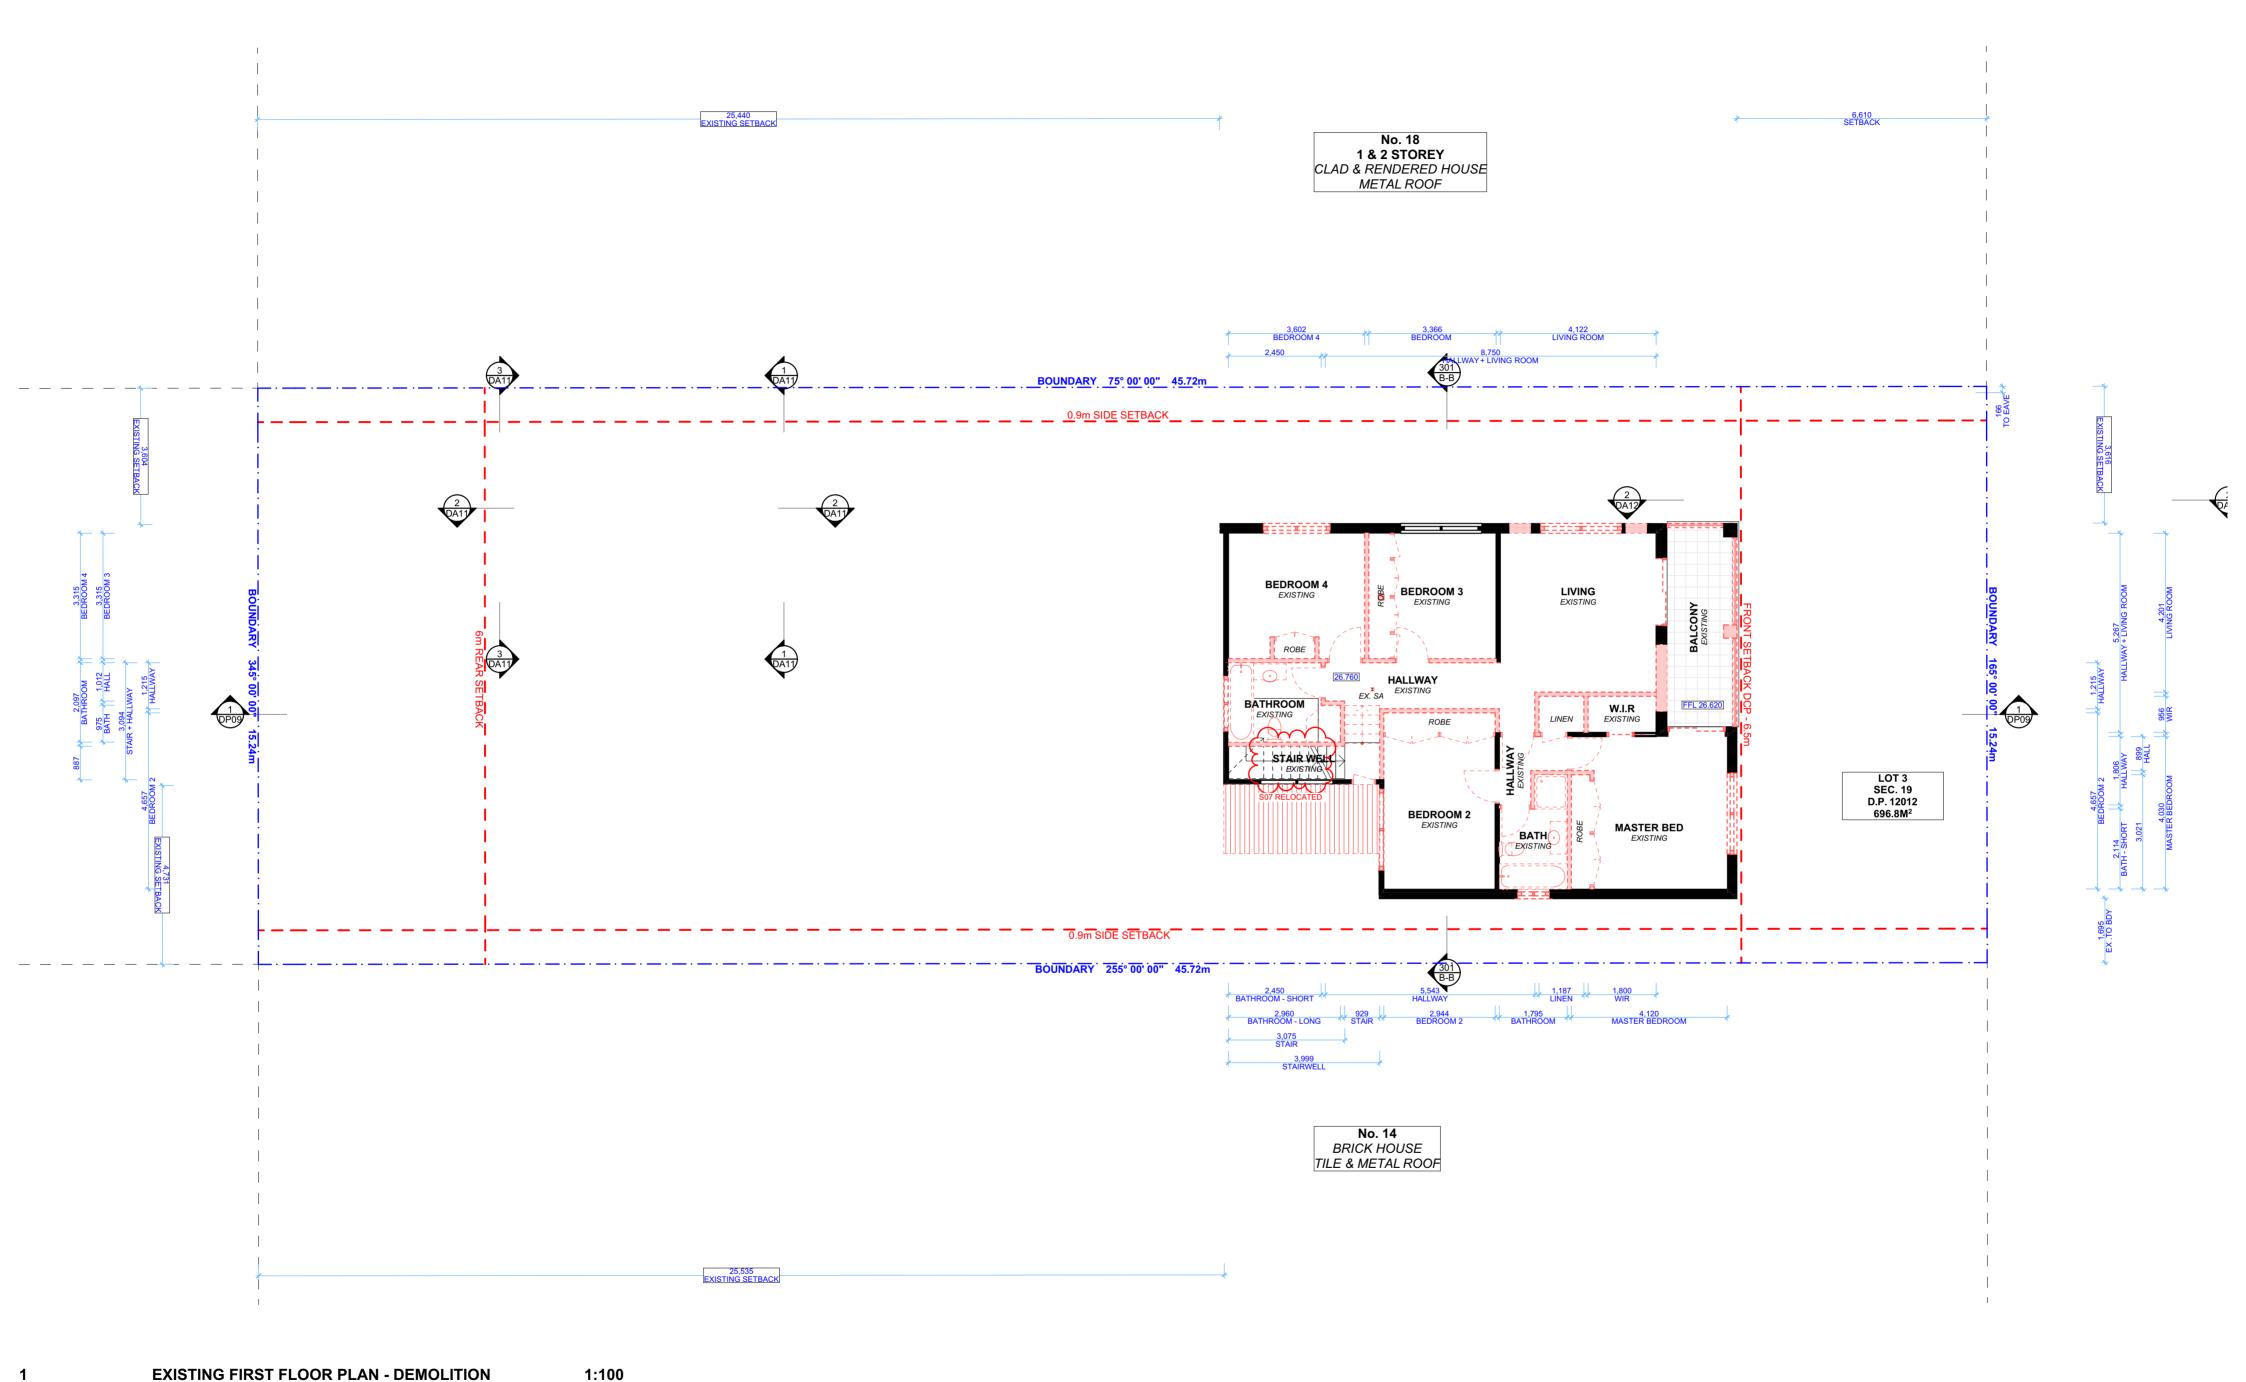

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CLIENT DRAWING NO. ALEXIS AND DEAN HOUDEN

PROJECT ADDRESS

16 WORCESTER ST,


COLLAROY NSW, 2097


MOD04 DATE

DRAWING NAME EXISTING FIRST FLOOR PLAN

SCALE Tuesday, 5 March 2024 1:100 @A2



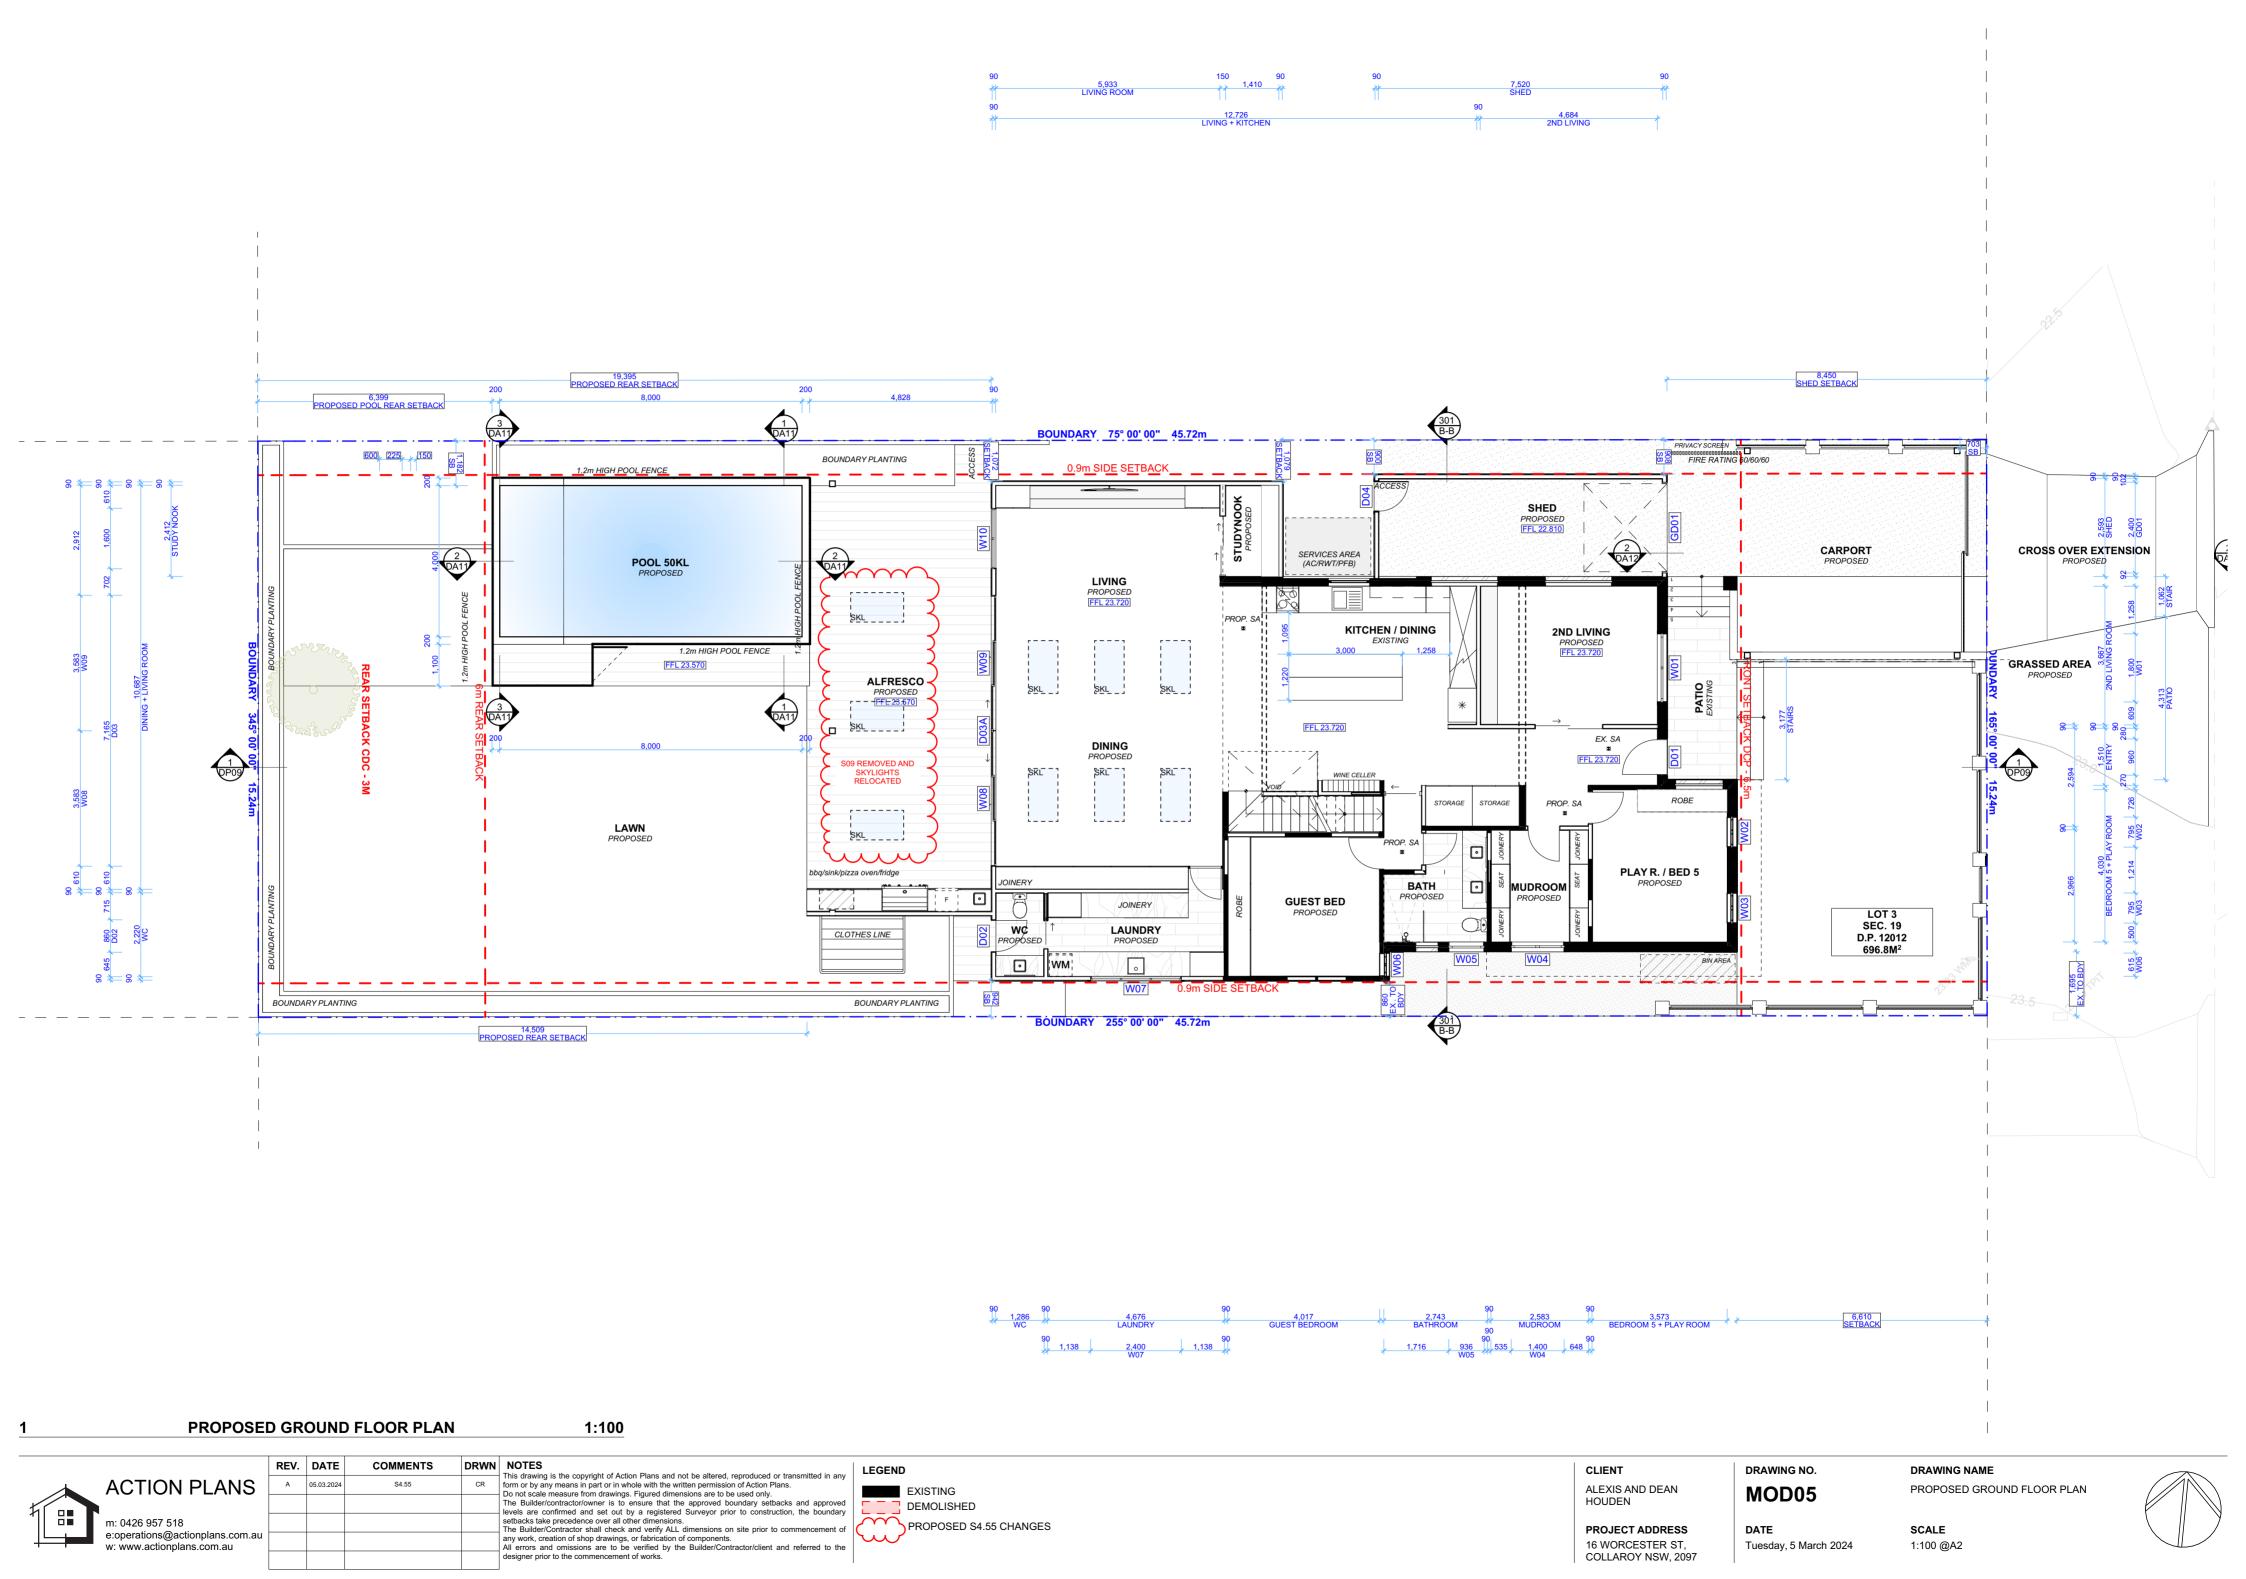

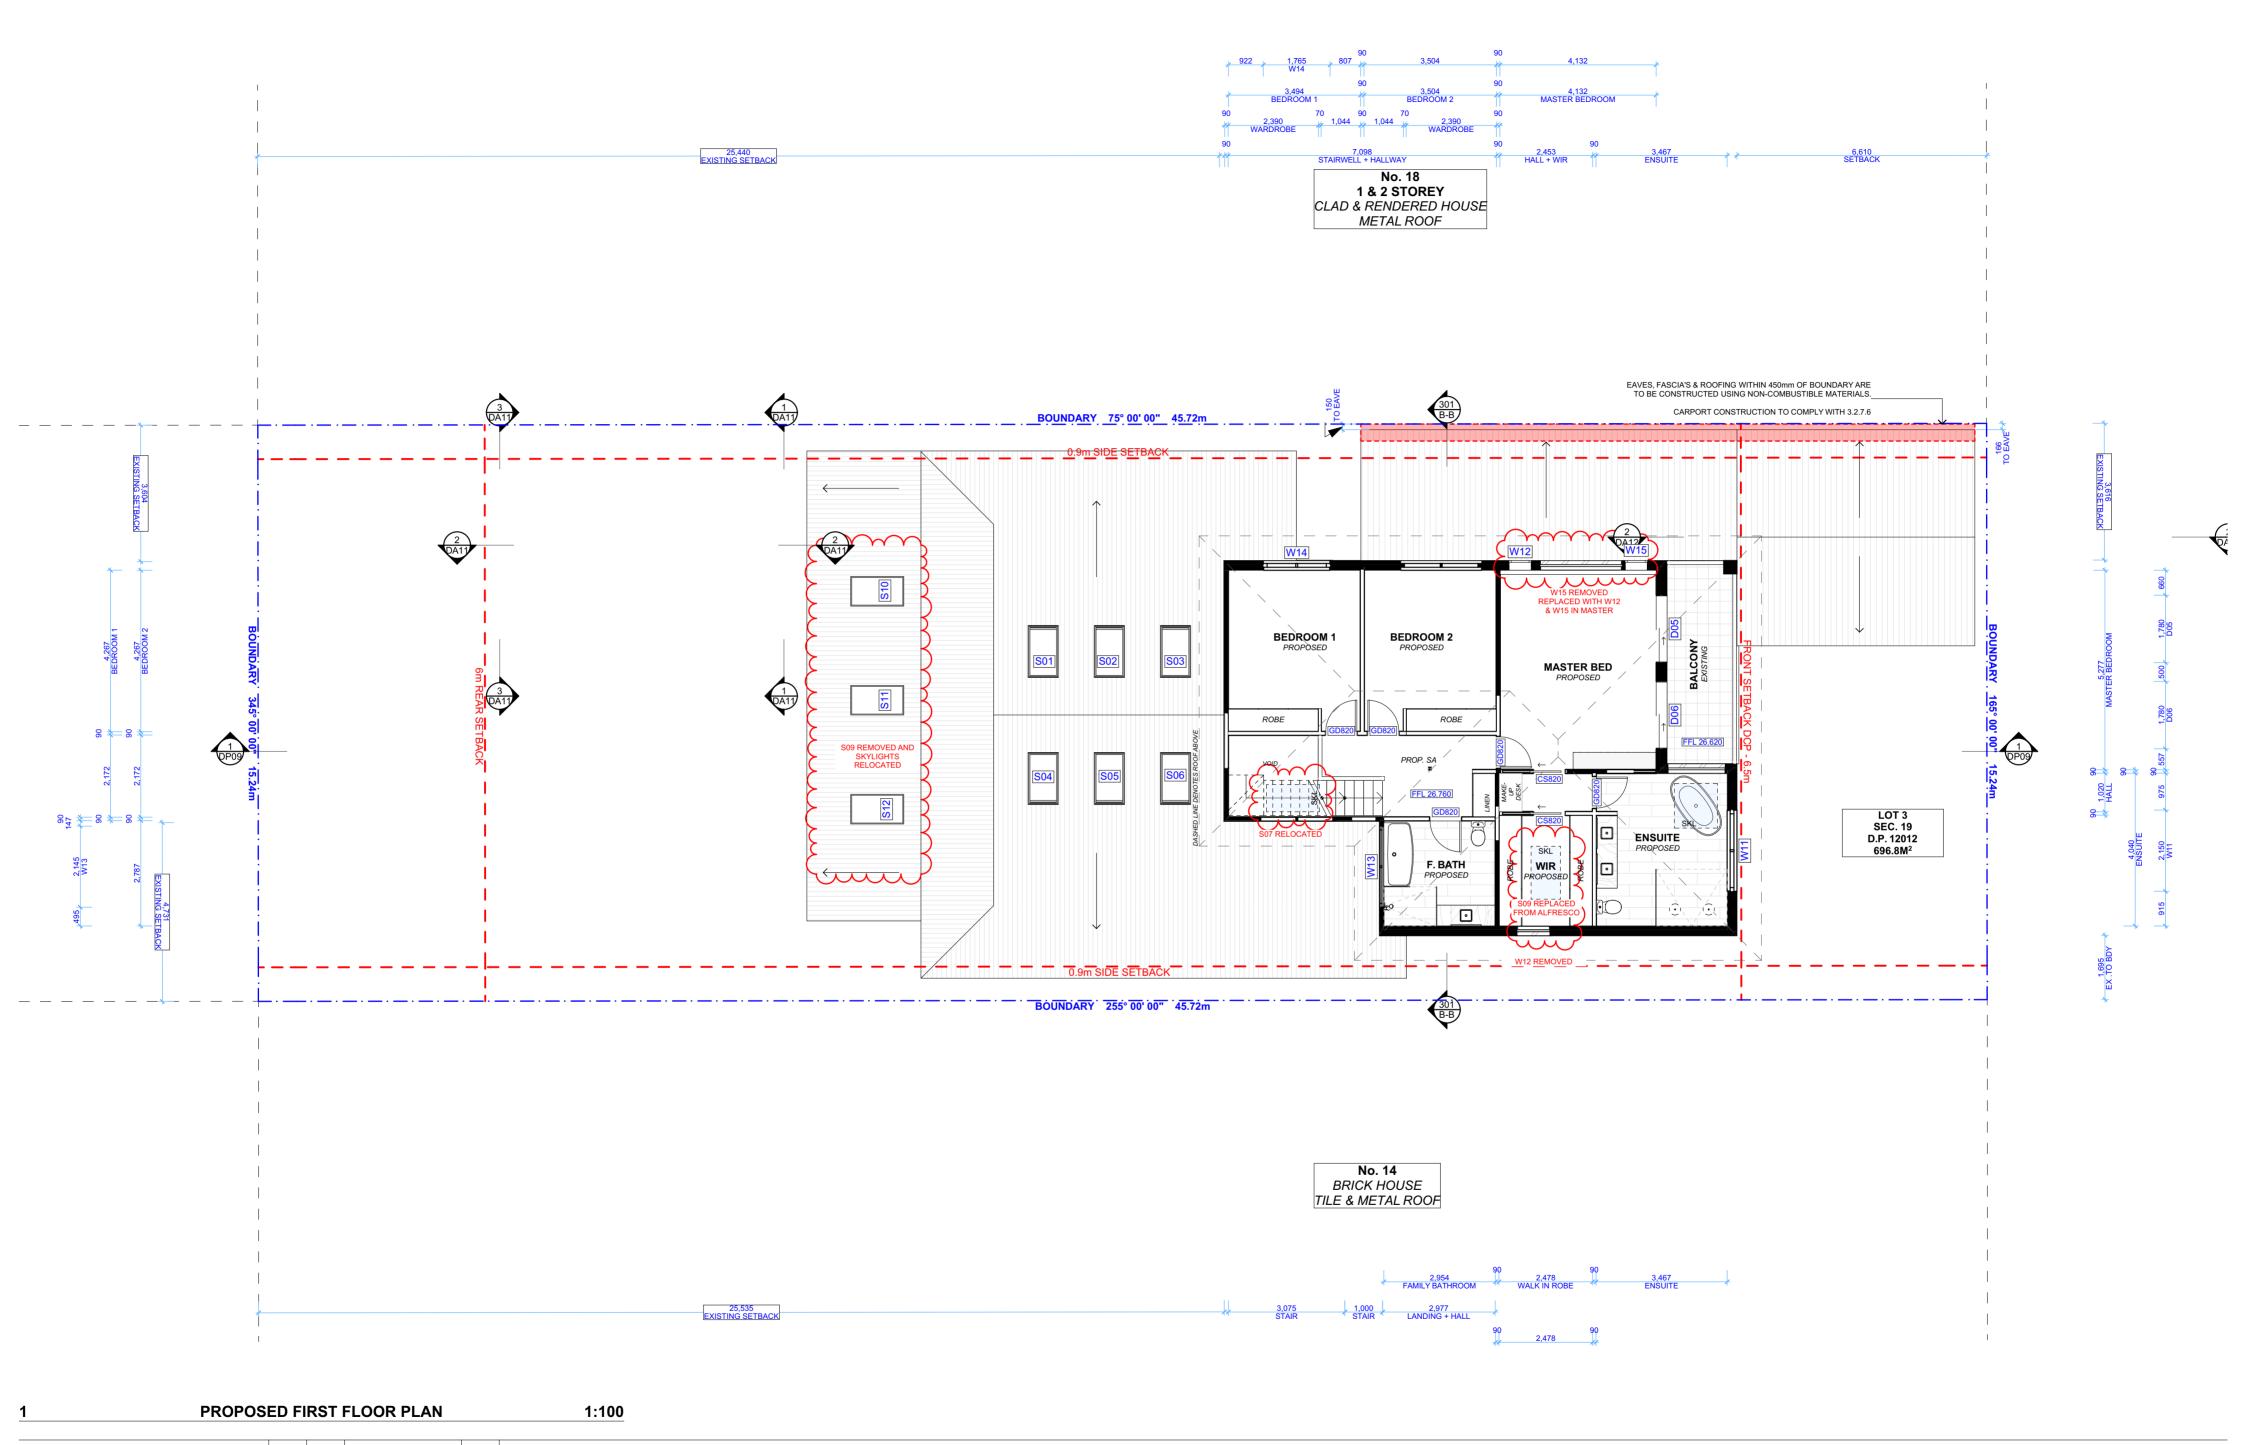

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REV. DATE COMMENTS DRWN

A 05.03.2024 S4.55 CR


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ALEXIS AND DEAN HOUDEN

PROJECT ADDRESS

16 WORCESTER ST,

COLLAROY NSW, 2097

CLIENT

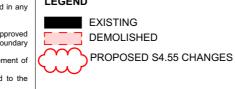MOD06


DRAWING NO.

DRAWING NAMEPROPOSED FIRST FLOOR PLAN

 DATE
 SCALE

 Tuesday, 5 March 2024
 1:100 @A2



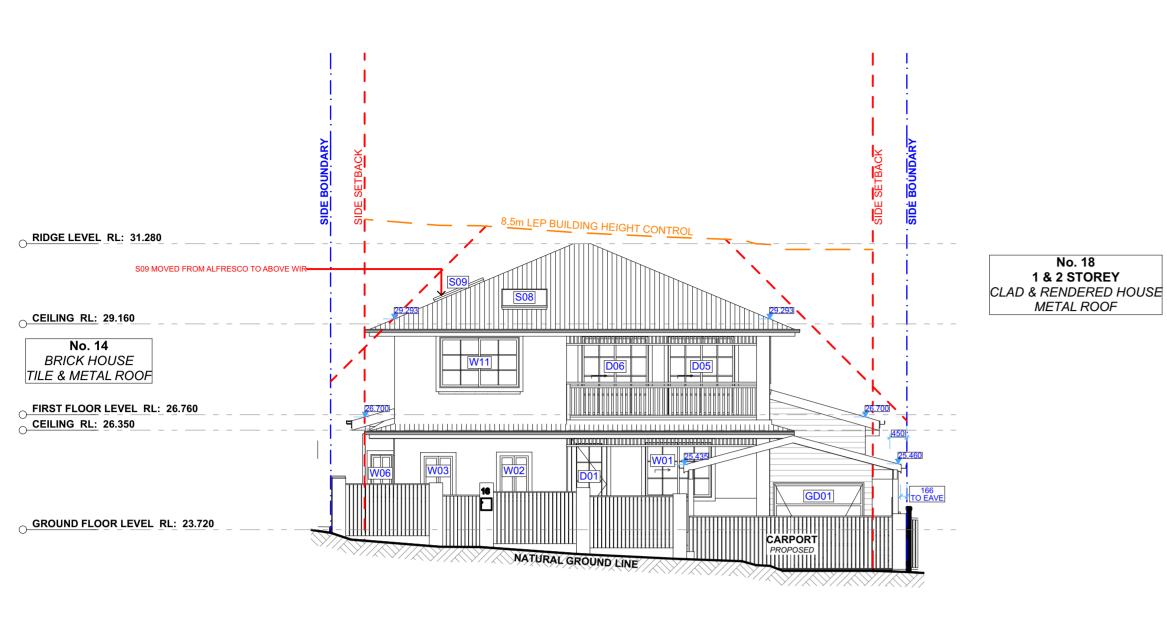

1:100

RIDGE LEVEL RL: 31.280 CEILING RL: 29.160 WINDOW 15 REMOVED AND REPLACED WITH W12 & W1 FIRST FLOOR LEVEL RL: 26.760 **CEILING RL: 26.350** CARPORT


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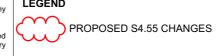
No. 18

NORTH ELEVATION - SIDE 1:100

GROUND FLOOR LEVEL RL: 23.720

EAST ELEVATION - PRIMARY ROAD



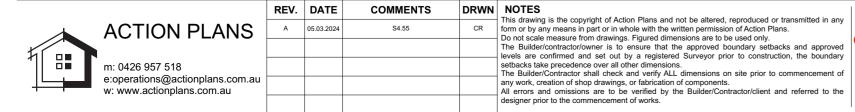

CLIENT ALEXIS AND DEAN HOUDEN

PROJECT ADDRESS

16 WORCESTER ST,

COLLAROY NSW, 2097

DATE Tuesday, 5 March 2024


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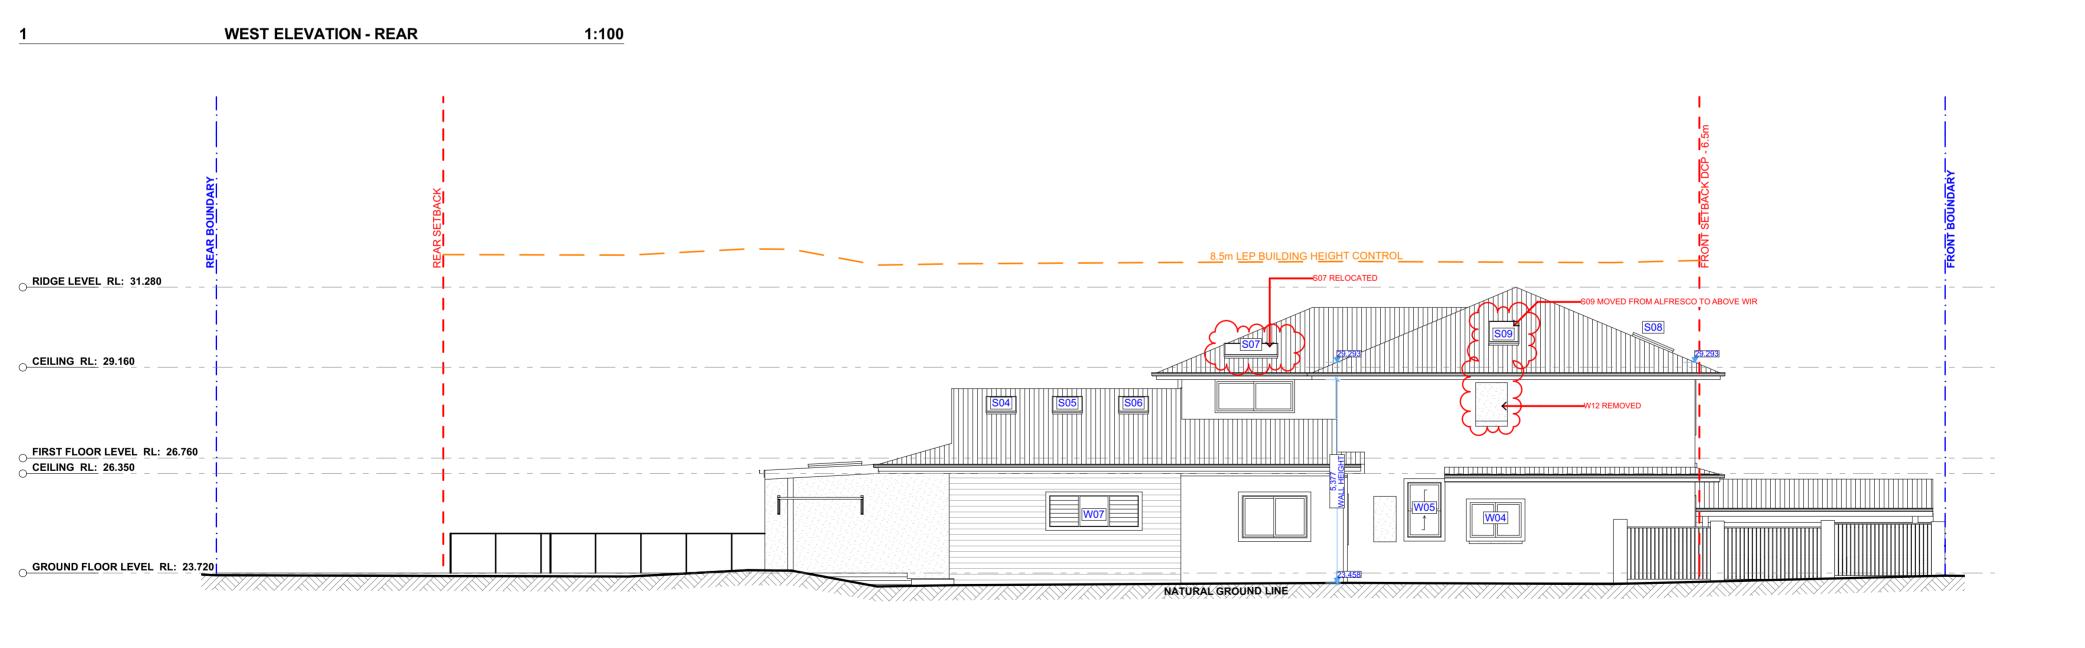
MOD07

DRAWING NAME PROPOSED NORTH / EAST **ELEVATIONS**

SCALE 1:100 @A2





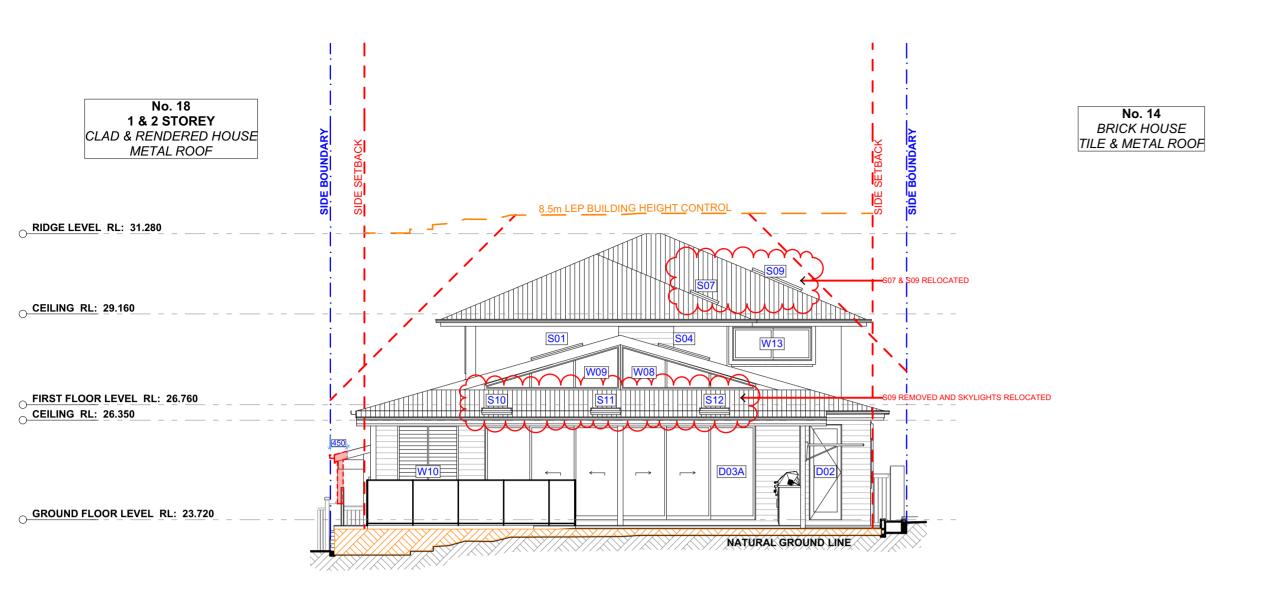

SOUTH ELEVATION - SIDE 1:100

REV. DATE COMMENTS DRWN NOTES NOTES

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CLIENT

PROJECT ADDRESS

16 WORCESTER ST,

COLLAROY NSW, 2097

ALEXIS AND DEAN HOUDEN

DATE Tuesday, 5 March 2024

DRAWING NO.


MOD08

DRAWING NAME PROPOSED SOUTH / WEST **ELEVATIONS**

SCALE

1:100 @A2



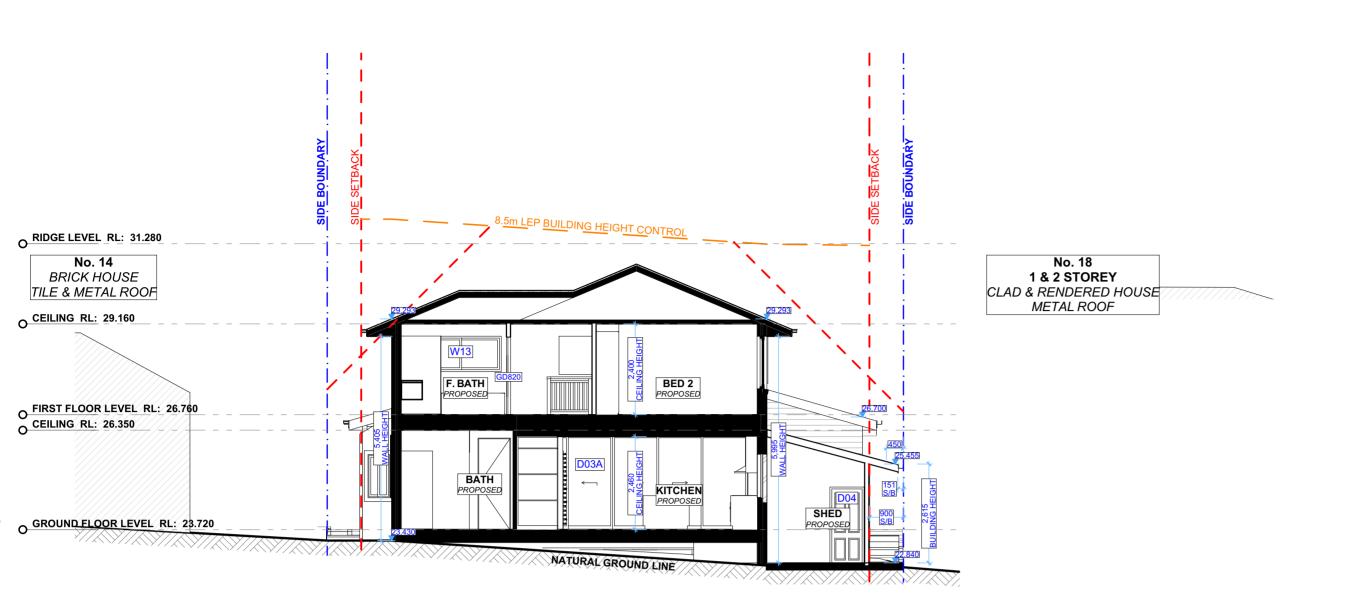

1:100 PROPOSED CROSS SECTION O RIDGE LEVEL RL: 31.280 O CEILING RL: 29.160 MASTER BED PROPOSED BALCONY EXISTING GD820) REPUBLIES HIN PROPOSED S09 REMOVED AND SKYLIGHTS RELOCATED O FIRST FLOOR LEVEL RL: 26.760 CEILING RL: 26.350 ALFRESCO PROPOSED LIVING PROPOSED PROPOSED HALLWAY O GROUND FLOOR LEVEL RL: 23.720

NATURAL GROUND LINE WAS A STATE OF THE STATE

1:100 PROPOSED LONG SECTION

		REV.	DATE	COMMENTS	DRWN	
_	ACTION PLANS	А	05.03.2024	S4.55		This drawing is the copyright of Action Plans and not be altered, reproduced or transmitted in any form or by any means in part or in whole with the written permission of Action Plans. Do not scale measure from drawings. Figured dimensions are to be used only.
#I						The Builder/contractor/owner is to ensure that the approved boundary setbacks and approved levels are confirmed and set out by a registered Surveyor prior to construction, the boundary
^ ==	m: 0426 957 518					setbacks take precedence over all other dimensions. The Builder/Contractor shall check and verify ALL dimensions on site prior to commencement of
	e:operations@actionplans.com.au w: www.actionplans.com.au					any work, creation of shop drawings, or fabrication of components. All errors and omissions are to be verified by the Builder/Contractor/client and referred to the
	p					designer prior to the commencement of works.

LEGEND PROPOSED S4.55 CHANGES CLIENT ALEXIS AND DEAN HOUDEN

PROJECT ADDRESS

16 WORCESTER ST,

COLLAROY NSW, 2097

MOD09 DATE


Tuesday, 5 March 2024


DRAWING NO.

DRAWING NAME PROPOSED CROSS / LONG SECTIONS


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2.07

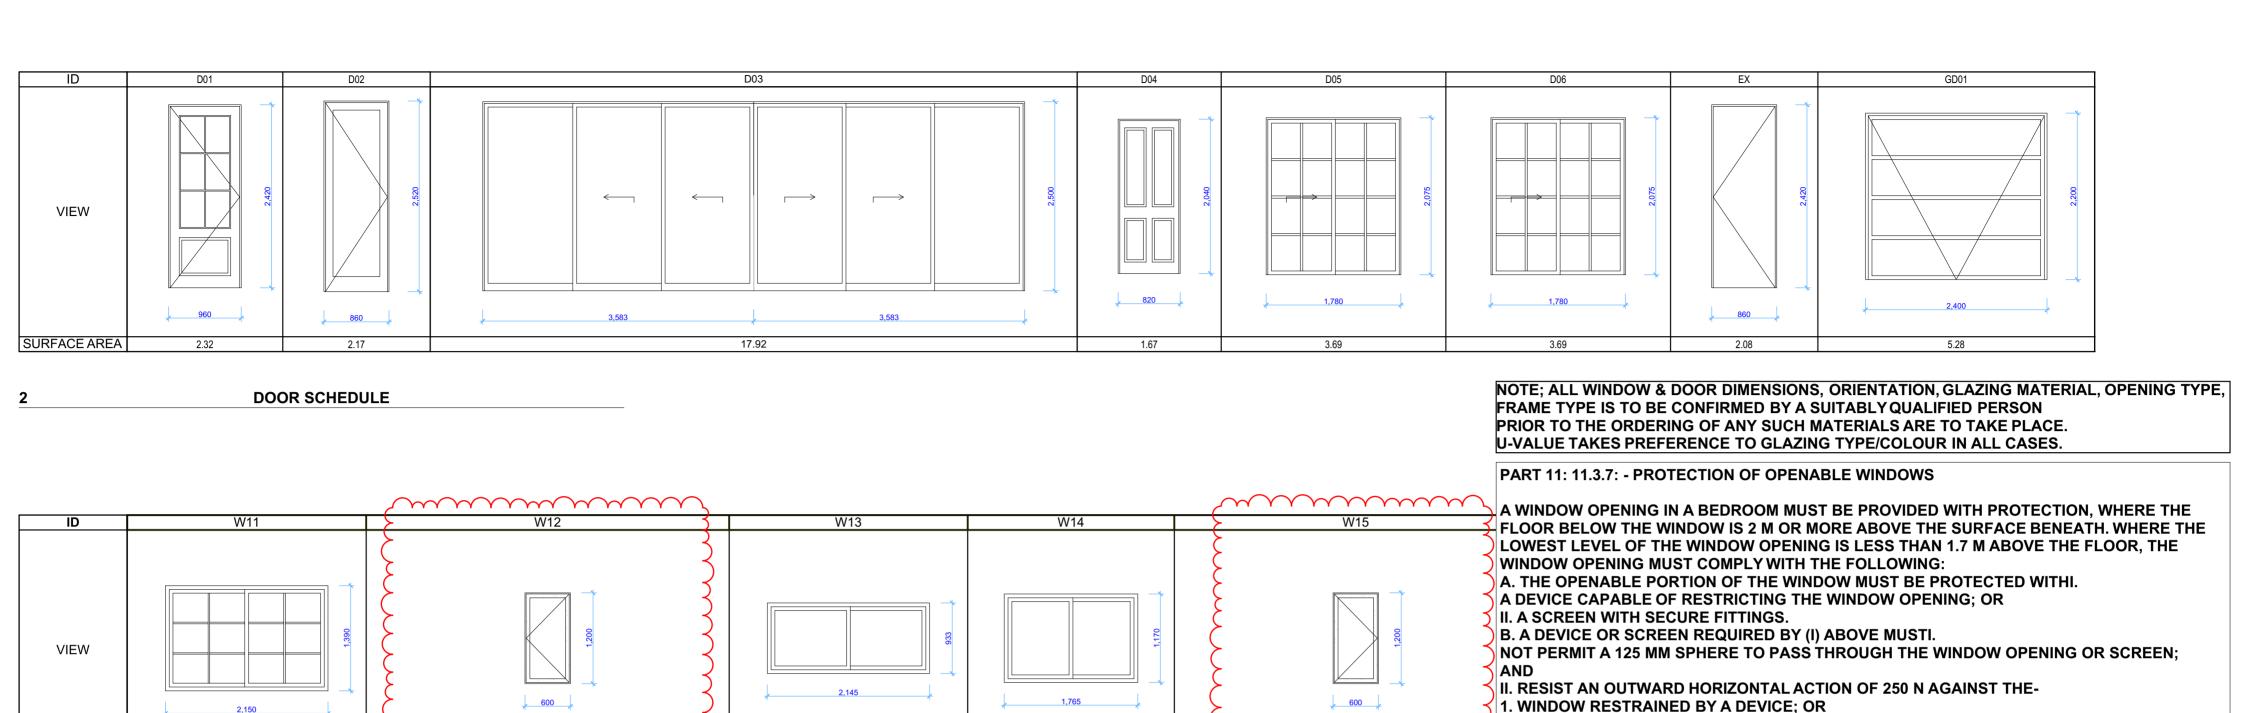


WINDOW SCHEDULE

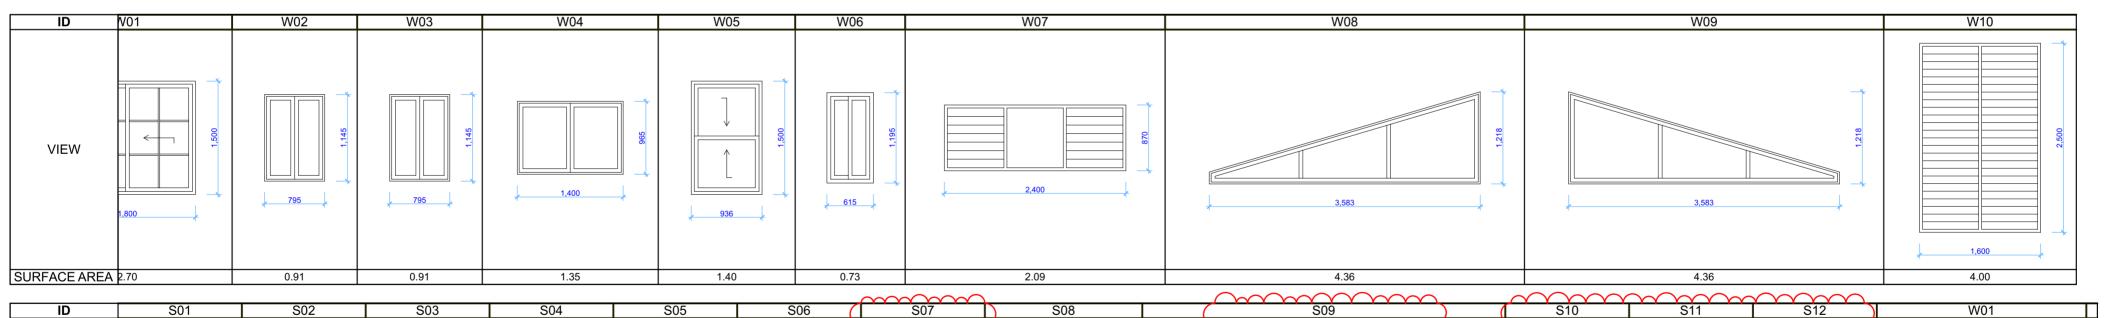2.99

SURFACE AREA

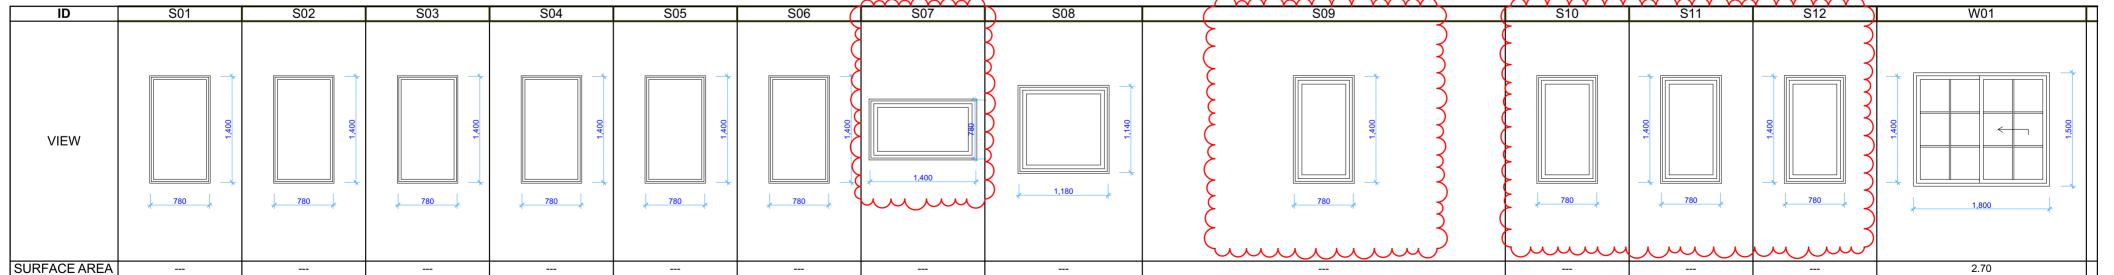			REV.	DATE	COMMENTS	DRWN	NOTES	LEGEND
	_	ACTION PLANS	А	05.03.2024	S4.55	CR	This drawing is the copyright of Action Plans and not be altered, reproduced or transmitted in any form or by any means in part or in whole with the written permission of Action Plans.	EXIS
忆							Do not scale measure from drawings. Figured dimensions are to be used only. The Builder/contractor/owner is to ensure that the approved boundary setbacks and approved levels are confirmed and set out by a registered Surveyor prior to	DEMO
1		m: 0426 957 518					construction, the boundary setbacks take precedence over all other dimensions. The Builder/Contractor shall check and verify ALL dimensions on site prior to commencement of any work, creation of shop drawings, or fabrication of	PROF
Τ,		e:operations@actionplans.com.au w: www.actionplans.com.au					components. All errors and omissions are to be verified by the Builder/Contractor/client and	
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2.00

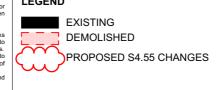CLIENT ALEXIS AND DEAN HOUDEN

PROJECT ADDRESS

16 WORCESTER ST,

COLLAROY NSW, 2097

2. SCREEN PROTECTING THE OPENING; AND

REMOVED, UNLOCKED OR OVERRIDDEN.

0.72

MOD10

DRAWING NO.

DRAWING NAME
WINDOW & DOOR SCHEDULE

DATE S Tuesday, 5 March 2024

SCALE @A2

III. HAVE A CHILD RESISTANT RELEASE MECHANISM IF THE SCREEN OR DEVICE IS ABLE TO BE



Alterations and Additions

Certificate number: A498163_03

This certificate confirms that the proposed development will meet the NSW government's requirements for sustainability, if it is built in accordance with the commitments set out below. Terms used in this certificate, or in the commitments, have the meaning given by the document entitled "BASIX Definitions" dated 10/09/2020 published by the Department. This document is available at www. hasix nsw.gov.au. www.basix.nsw.gov.au

Secretary
Date of issue: Monday, 04 March 2024
To be valid, this certificate must be lodged within 3 months of the date of issue.



	page 1/11
Project address	
Project name	1037_16 WORCESTER ST, COLLAROY_03
Street address	16 WORCESTER STREET - COLLAROY 2097
Local Government Area	Northern Beaches Council
Plan type and number	Deposited Plan 1212
Lot number	3
Section number	19
Project type	
Dwelling type	Separate dwelling house
Type of alteration and addition	My renovation work is valued at \$50,000 or more, and includes a pool (and/or spa).
N/A	N/A
Certificate Prepared by (please	e complete before submitting to Council or PCA)
Name / Company Name: Action Plans P	ty Ltd
ABN (if applicable): 55660046711	

Pool and Spa	Show on DA Plans	Show on CC/CDC Plans & specs	Certifier Check
Rainwater tank			
The applicant must install a rainwater tank of at least 0 litres on the site. This rainwater tank must meet, and be installed in accordance with, the requirements of all applicable regulatory authorities.	~	~	~
The applicant must configure the rainwater tank to collect rainwater runoff from at least 170 square metres of roof area.		~	~
The applicant must connect the rainwater tank to a tap located within 10 metres of the edge of the pool.		~	~
Outdoor swimming pool			
The swimming pool must be outdoors.	~	~	~
The swimming pool must not have a capacity greater than 50 kilolitres.	~	~	~
The swimming pool must have a pool cover.		~	~
The applicant must install a pool pump timer for the swimming pool.		~	~
The applicant must install the following heating system for the swimming pool that is part of this development: solar (electric boosted).		~	~

Fixtures and systems	Show on DA Plans	Show on CC/CDC Plans & specs	Certifier Check
Lighting			
The applicant must ensure a minimum of 40% of new or altered light fixtures are fitted with fluorescent, compact fluorescent, or light-emitting-diode (LED) lamps.		~	~
Fixtures			
The applicant must ensure new or altered showerheads have a flow rate no greater than 9 litres per minute or a 3 star water rating.		~	~
The applicant must ensure new or altered toilets have a flow rate no greater than 4 litres per average flush or a minimum 3 star water rating.		~	~
The applicant must ensure new or altered taps have a flow rate no greater than 9 litres per minute or minimum 3 star water rating.		~	

Construction	Show on DA Plans	Show on CC/CDC Plans & specs	Certifier Check		
nsulation requirements					
listed in the table below, except that a) addit					
Construction	Additional insulation required (R-value)	Other specifications			
suspended floor with enclosed subfloor: framed (R0.7).	R0.60 (down) (or R1.30 including construction)	N/A			
floor above existing dwelling or building.	nil	N/A			
external wall: brick veneer	R1.16 (or R1.70 including construction)				
external wall: framed (weatherboard, fibro, metal clad)	R1.30 (or R1.70 including construction)				
flat ceiling, pitched roof	ceiling: R1.45 (up), roof: foil backed blanket (75 mm)	medium (solar absorptance 0.475 - 0.70)			
raked ceiling, pitched/skillion roof: framed	ceiling: R1.74 (up), roof: foil backed blanket (75 mm)	medium (solar absorptance 0.475 - 0.70)			

Glazing requir	ements						Show on DA Plans	Show on CC/CDC Plans & specs	Certifier Check
Windows and gla	zed doors glazing	requirements							
Window/door number	Orientation	Area of glass including frame (m2)	Overshadowing height (m)	Overshadowing distance (m)	Shading device	Frame and glass type			
W01	E	2.7	0	0	eave/ verandah/ pergola/balcony >=900 mm	standard aluminium, single clear, (or U-value: 7.63, SHGC: 0.75)			
W02	E	0.91	0	0	eave/ verandah/ pergola/balcony >=750 mm	standard aluminium, single pyrolytic low-e, (U- value: 5.7, SHGC: 0.47)			
W03	E	0.91	0	0	eave/ verandah/ pergola/balcony >=750 mm	standard aluminium, single pyrolytic low-e, (U- value: 5.7, SHGC: 0.47)			
W04	s	1.35	0	0	eave/ verandah/ pergola/balcony >=750 mm	standard aluminium, single clear, (or U-value: 7.63, SHGC: 0.75)			
W05	S	1.4	0	0	eave/ verandah/ pergola/balcony >=750 mm	standard aluminium, single clear, (or U-value: 7.63, SHGC: 0.75)			

Certinicate Humber.	M400 100_00						=		paye or i i
Glazing requir	ements						Show on DA Plans	Show on CC/CDC Plans & specs	Certifier Check
Vindows and gla	zed doors glazin	g requirements							
Window/door number	Orientation	Area of glass including frame (m2)	Overshadowing height (m)	Overshadowing distance (m)	Shading device	Frame and glass type			
W01	E	2.7	0	0	eave/ verandah/ pergola/balcony >=900 mm	standard aluminium, single clear, (or U-value: 7.63, SHGC: 0.75)			
W02	E	0.91	0	0	eave/ verandah/ pergola/balcony >=750 mm	standard aluminium, single pyrolytic low-e, (U- value: 5.7, SHGC: 0.47)			
W03	Е	0.91	0	0	eave/ verandah/ pergola/balcony >=750 mm	standard aluminium, single pyrolytic low-e, (U- value: 5.7, SHGC: 0.47)			
W04	S	1.35	0	0	eave/ verandah/ pergola/balcony >=750 mm	standard aluminium, single clear, (or U-value: 7.63, SHGC: 0.75)			
W05	S	1.4	0	0	eave/ verandah/ pergola/balcony >=750 mm	standard aluminium, single clear, (or U-value: 7.63, SHGC: 0.75)			

lazing requir	ements						Show on DA Plans	Show on CC/CDC Plans & specs	Certifi Check
Window/door number	Orientation	Area of glass including frame (m2)	Overshadowing height (m)	Overshadowing distance (m)	Shading device	Frame and glass type			
W06	E	0.73	1.9	2.3	eave/ verandah/ pergola/balcony >=450 mm	standard aluminium, single clear, (or U-value: 7.63, SHGC: 0.75)			
W07	S	2.09	0	0	eave/ verandah/ pergola/balcony >=450 mm	standard aluminium, single clear, (or U-value: 7.63, SHGC: 0.75)			
W08	w	4.36	0	0	none	timber or uPVC, double Lo-Tsol/air gap/clear, (U-value: 2.3, SHGC: 0.19)			
W09	w	4.36	0	0	none	timber or uPVC, double Lo-Tsol/air gap/clear, (U-value: 2.3, SHGC: 0.19)			
W10	W	4	0	0	eave/ verandah/ pergola/balcony >=900 mm	standard aluminium, single clear, (or U-value: 7.63, SHGC: 0.75)			

/indows and gla	zed doors glazing	requirements						
Window/door number	Orientation	Area of glass including frame (m2)	Overshadowing height (m)	Overshadowing distance (m)	Shading device	Frame and glass type		
W11	E	2.99	0	0	eave/ verandah/ pergola/balcony >=750 mm	standard aluminium, single pyrolytic low-e, (U- value: 5.7, SHGC: 0.47)		
W12	N	0.72	0	0	eave/ verandah/ pergola/balcony >=750 mm	standard aluminium, single clear, (or U-value: 7.63, SHGC: 0.75)		
W13	w	2	0	0	eave/ verandah/ pergola/balcony >=750 mm	standard aluminium, single clear, (or U-value: 7.63, SHGC: 0.75)		
W14	N	2.07	0	0	eave/ verandah/ pergola/balcony >=750 mm	standard aluminium, single clear, (or U-value: 7.63, SHGC: 0.75)		
W15	N	0.72	0	0	eave/ verandah/ pergola/balcony >=750 mm	standard aluminium, single clear, (or U-value: 7.63, SHGC: 0.75)		

Glazing requirements					Show on DA Plans	Show on CC/CDC Plans & specs	Certifier Check		
Window/door number	Orientation	Area of glass including frame (m2)	Overshadowing height (m)	Overshadowing distance (m)	Shading device	Frame and glass type			
D01	E	2.32	0	0	eave/ verandah/ pergola/balcony >=900 mm	standard aluminium, single clear, (or U-value: 7.63, SHGC: 0.75)			
D02	W	2.17	0	0	eave/ verandah/ pergola/balcony >=900 mm	standard aluminium, single clear, (or U-value: 7.63, SHGC: 0.75)			
D03	W	17.92	0	0	eave/ verandah/ pergola/balcony >=900 mm	standard aluminium, single clear, (or U-value: 7.63, SHGC: 0.75)			
D05	E	3.69	0	0	eave/ verandah/ pergola/balcony >=900 mm	standard aluminium, single clear, (or U-value: 7.63, SHGC: 0.75)			
D06	E	3.69	0	0	eave/ verandah/ pergola/balcony >=900 mm	standard aluminium, single clear, (or U-value: 7.63, SHGC: 0.75)			

Glazing requirements					Show on CC/CDC Plans & specs	Certifier Check
Skylights						
The applicant must install the skylights in accordance with the specifications listed in the table below.					~	~
The following requirements must also be satisfied in relation to each skylight:					~	~
Each skylight may either match the description, or, have a U-value and a Solar Heat Gain Coefficient (SHGC) no greater than that listed in the table below.					~	~
Skylights glazing requiren	nents					
Skylight number	Area of glazing inc. frame	Shading device	Frame and glass type			
S01-3	(m2) 3.276	no shading	timber, low-E internal/argon fill/clear external, (or U-value: 2.5, SHGC: 0.456)			
S04-6	3.276	no shading	timber, low-E internal/argon fill/clear external, (or U-value: 2.5, SHGC: 0.456)			
S07	1.092	no shading	timber, low-E internal/argon fill/clear external, (or U-value: 2.5, SHGC: 0.456)			
S08-9	2.4	no shading	timber, low-E internal/argon fill/clear external, (or U-value:			

Legend
In these commitments, "applicant" means the person carrying out the development.
Commitments identified with a 🕶 in the "Show on DA plans" column must be shown on the plans accompanying the development application for the proposed development (if a development application is to be lodged for the proposed development).
Commitments identified with a vin the "Show on CC/CDC plans & specs" column must be shown in the plans and specifications accompanying the application for a construction certificate / complying development certificate for the proposed development.
Commitments identified with a 🗸 in the "Certifier check" column must be certified by a certifying authority as having been fulfilled, before a final occupation certificate for the development may be issued.



	REV.	DATE	COMMENTS	DRWN
	А	05.03.2024	\$4.55	CR
J				

DRWN NOTES NOTES

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The Builder/contractor/owner is to ensure that the approved boundary setbacks and approved levels are confirmed and set out by a registered Surveyor prior to construction, the boundary setbacks take precedence over all other dimensions.

The Builder/Contractor shall check and verify ALL dimensions on site prior to commencement of any work, creation of shop drawings, or fabrication of components. All errors and omissions are to be verified by the Builder/Contractor/client and referred to the designer prior to the commencement of works. All window & door dimensions, orientation, glazing materials, opening types, frame types are to be confirmed by a suitably qualified person prior to the ordering of any such materials are to take place. U value takes precedence over glazing type/colour in all cases. all new glazing must meet the BASIX specified frame and glass type, QR meet the ecified U value and SHGC value.

CLIENT

ALEXIS AND DEAN HOUDEN PROJECT ADDRESS

16 WORCESTER ST,

COLLAROY NSW, 2097

DRAWING NO. MOD11

Tuesday, 5 March 2024

DATE

DRAWING NAME BASIX COMMITMENTS