

ACTION PLANS

m: 0426 957 518

e: operations@actionplans.com.au

w: www.actionplans.com.au

DEVELOPMENT APPLICATION 42 REV A

These plans are for Development Approval only.

ITEM DETAILS	DEVELOPMENT APPLICATION			
ADDRESS	42 PACIFIC PARADE, MANLY, NSW, 2095			
LOT & DP/SP	LOT 1 DP 645898			
COUNCIL	NORTHERN BEACHS COUNCIL (MANLY)			
SITE AREA	223.2m²			
FRONTAGE	6.095m			
CONTROLS	PERMISSIBLE / REQUIRED	EXISTING	PROPOSED	COMPLIANCE
	m / m² / %	m / m² / %	m / m² / %	
<u>LEP</u>				
LAND ZONING	R1 – GENERAL RESIDENTIAL	R1	R1	YES
MINIMUM LOT SIZE	250m²	223.2m²	UNCHANGED	YES
FLOOR SPACE RATIO	0:6 : 1 (133.92m²)	0.56 : 1 (125.86m²)	UNCHANGED	YES
MAXIMUM BUILDING HEIGHT	8.5m	6.44m	UNCHANGED	YES
<u>HAZARDS</u>				
ACID SULFATE SOILS	CLASS 4	N/A	N/A	N/A
FLOOD PLANNING	HIGH FLOOD RISK	N/A	N/A	N/A
TERRESTRIAL BIODIVERSITY	NOT IDENTIFIED	N/A	N/A	N/A
RIPARIAN LAND & WATERCOURSE	NOT IDENTIFIED	N/A	N/A	N/A
WETLANDS	NOT IDENTIFIED	N/A	N/A	N/A
LANDSLIP RISK	NOT IDENTIFIED	N/A	N/A	N/A
TERRESTRIAL BIODIVERSITY	NOT IDENTIFIED	N/A	N/A	N/A
FORESHORE SCENIC PRO. AREA	NOT IDENTIFIED	N/A	N/A	N/A
BUSHFIRE	NOT IDENTIFIED	N/A	N/A	N/A
<u>DCP</u>				
RESIDENTIAL OPEN SPACE	AREA OS3			
TOTAL OPEN SPACE (TOS)	55% (122.76m²)	96.37m² (43%)	UNCHANGED	NO
LANDSCAPE AREA	35% OF TOS (55%) : 42.96 m ²	41.88m²	UNCHANGED	NO
OPEN SPACE ABOVE GROUND	MAX. 40% OF TOS (55%) : 49.1m ²	23.1m ²	UNCHANGED	YES
PRINCIPAL PRIVATE OPEN SPACE	18m²	59.5m²	UNCHANGED	YES
FRONT SETBACK	PREVALING BULDING LINE: 6m	6.18m TO DWELLING 4.3m TO POST	UNCHANGED 0.270m	YES
		4.5111 10 1 001	0.270111	NO
REAR SETBACK	8.0m	9.56m	UNCHANGED	YES
SIDE SETBACKS	1/3 WALL HEIGHT 1.9m	E:1.30 W:N/A SEMI	E: UNCHANGED W: N/A SEMI	NO N/A
CAR PARKING SPACES	Required: 1	1	UNCHANGED	YES

SHEET NUMBER	SHEET NAME	DATE PUBLISHED
DA00	COVER	6/11/2019
DA01	NOTATION	6/11/2019
DA02	SITE ANALYSIS	6/11/2019
DA03	SITE / ROOF / SEDIMENT EROSION / WASTE MANAGEMENT / STORMWATER CONCEPT PLAN	6/11/2019
DA04	EXISTING GROUND FLOOR PLAN	6/11/2019
DA05	PROPOSED GROUND FLOOR PLAN	6/11/2019
DA06	EXISTING FIRST FLOOR PLAN	6/11/2019
DA07	PROPOSED FIRST FLOOR PLAN	6/11/2019
DA08	NORTH / EAST ELEVATION	6/11/2019
DA09	SOUTH / WEST ELEVATION	6/11/2019
DA10	LONG / CROSS SECTION	6/11/2019
DA11	AREA CALCULATIONS / SAMPLE BOARD	6/11/2019
DA12	WINTER SOLSTICE 9 AM	6/11/2019
DA13	WINTER SOLSTICE 12 PM	6/11/2019
DA14	WINTER SOLSTICE 3 PM	6/11/2019

42 PACIFIC PARADE, **MANLY 2095**



NCC & AS COMPLIANCES SPECIFICATIONS

- EARTHWORKS - PART 3.1.1 OF NCC

- EARTH RETAINING STRUCTURES - PART 3.1.2 OF NCC - DRAINAGE - PART 3.1.3 OF NCC

- TERMITE-RISK MANAGEMENT - PART 3.1.4 OF NCC

- FOOTINGS & SLAB - PART 3.2 OF NCC INCLUDING AS2870

- MASONRY - PART 3.3 OF NCC INCLUDING AS3700

- FRAMING - PART 3.4 OF NCC

- SUB FLOOR VENTILATION - PART 3.4.1 OF NCC - ROOF CLADDING AND WALL-CLADDING - PART 3.5 OF NCC

- GLAZING - PART 3.6 OF NCC INCLUDING AS1288 - FIRE SAFETY - PART 3.7 OF NCC

- FIRE SEPERATION - PART 3.7.2 OF NCC

- FIRE PROTECTION OF SEPERATING WALLS AND FLOORS- PART 3.7.3 OF NCC

- SMOKE ALARMS - PART 3.7.5 OF NCC

- WET AREAS AND EXTERNAL WATERPROOFING - PART 3.8.1 OF NCC

- ROOM HEIGHTS - PART 3.8.2 OF NCC

- FACILITIES - PART 3.8.3 OF NCC

- LIGHT - PART 3.8.4 OF NCC

- VENTILATION - PART 3.8.5 OF NCC

- SOUND INSULATION - PART 3.8.6 OF NCC

- STAIRWAYAND RAMP CONSTRUCTION - PART 3.9.1 OF NCC

- BARRIERS AND HANDRAILS - PART 3.9.2 OF NCC

- SWIMMING POOLS - PART 3.10.1 OF NCC

- CONSTRUCTION IN BUSHFIRE PRONE AREAS - PART 3.10.5 OF NCC

- FENCING & OTHER PROVISIONS - REGS & AS1926

- DEMOLITION WORKS - AS2601-1991 THE DEMOLITION OF STRUCTURES.

- ALL WATERPROOF MEMBRANES TO COMPLY WITH WITH AS 3740-2010 - ALL PLUMBING & DRAINAGE WORK TO COMPLY WITH AS 3500

- SITE CLASSIFICATION AS TO AS 2870

- ALL PLASTERBOARD WORK TO COMPLY WITH AS 2588-1998

- ALL STRUCTURAL STEEL WORK TO COMPLY WITH AS 4100 & AS 1554

- ALL CONCRETE WORK TO COMPLY WITH AS 3600

- ALL ROOF SHEETING WORK TO COMPLY WITH AS 1562-1992

- ALL SKYLIGHTS TO COMPLY WITH WITH AS 4285-2007

- ALL CERAMIC TILING TO COMPLY WITH AS 3958.1-2007 & 3958.2-1992 - ALL GLAZING ASSEMBLIES TO COMPLY WITH AS2047 & 1288


- ALL TIMBER RETAINING WALLS ARE TO COMPLY WITH AS 1720.1-2010,

AS 1720.2-2006, AS 1720.4-2006, AS 1170.1-1989 & AS 1170.4-2007


- ALL RETAINING WALLS ARE TO COMPLY WITH 3700 - 2011 & AS 3600 -2009 - ALL CONSTRUCTION TO COMPLY TO AS3959- 2009

NOTES

- APPROVED MEANS BY THE 'RELEVANT LOCAL AUTHORITY' OR COUNCIL
- THE OWNER WILL DIRECTLY PAYTHE FEES ASSOCIATED WITH THE FOLLOWING:
- BUILDING APPROVAL FROM COUNCIL, FOOTPATH AND KERB DEPOSITS WITH THE LOCAL COUNCIL, INSURANCE FEE TO BUILDING SERVICES CORPORATION, LONG SERVICE LEAVE SERVICE LEVY FEE AND APPROVAL FEE BY WATER AND SEWERAGE AUTHORITY. ALL OTHER FEES ARE TO BE PAID BY THE BUILDER. THE AMOUNT OF ANY LOCAL AUTHORITY DEPOSITS WHICH ARE FORFEITED DUE TO DAMAGE OR OTHER CAUSE WILL BE DEDUCTED FROM THE PAYMENTS DUE TO THE BUILDER.
- THE BUILDER IS TO PROVIDE AT HIS/HER OWN EXPENSE ADEQUATE PUBLIC RISK INSURANCE AND ARRANGE INDEMNIFICATION UNDER THE WORKERS COMPENSATION ACT. WORKS INSURANCE TO BE STATED IN THE CONTRACT CONDITIONS.
- ALL WORK TO BE CARRIED OUT IN A TRADESMEN LIKE MANNER AND IN ACCORDANCE WITH THE STANDARDS CODES AND REGULATIONS OF THE STANDARDS ASSOCIATION OF AUSTRALIA, BUILDING CODE OF AUSTRALIA AND ANY STATUTORY AUTHORITY HAVING JURISDICTION OVER THE WORK.
- ALL TENDERERS ARE TO VISIT THE SITE TO SATISFY THEMSELVES AS TO THE NATURE AND EXTENT OF THE WORKS, FACILITIES AVAILABLE AND DIFFICULTIES ENTAILED IN THE WORKS AS VARIATIONS WILL NOT BE ALLOWED DUE TO WORK ARISING OWING TO NEGLECT OF THIS CLAUSE.
- ALL WORK AND MATERIALS TO COMPLY WITH THE CURRENT AUSTRALIAN STANDARDS AT THE TIME OF COMMENCEMENT WERE APPLICABLE.
- THESE DRAWINGS SHALL BE READ IN CONJUNCTION WITH ALL STRUCTURAL AND OTHER CONSULTANTS DRAWINGS AND SPECIFICATIONS AND WITH ANY SUCH WRITTEN INSTRUCTIONS AS MAY BE ISSUED DURING THE COURSE OF THE CONTRACT.
- SET OUT DIMENSIONS SHOWN ON THIS DRAWING SHALL BE VARIFIED BY THE BUILDER ON SITE BEFORE COMMENCEMENT OF ANY WORK. DIMENSIONS SHOULD NOT BE OBTAINED BY SCALING THE DRAWINGS. USE ONLY FIGURED DIMENSIONS. ALL DIMENSIONS ARE IN MILLIMETRES.
- THE BUILDER IS TO ENSURE ALL CONSTRUCTION. LEVELS AND OTHER ITEMS COMPLY WITH THE CONDITIONS OF THE BUILDING APPROVAL.
- THE BUILDER IS TO COMPLY WITH ALL ORDINANCES, LOCAL AUTHORITY REGULATIONS AND THE REQUIREMENTS OF ALL SERVICES SUPPLY AUTHORITIES HAVING JURISDICTION OVER THE WORKS.
- ALL PLUMBING AND DRAINAGE WORK TO BE INSTALLED AND COMPLETED BY A LICENCED TRADESMAN AND IN ACCORDANCE WITH THE STATUTORY BODY HAVING AUTHORITY OVER THE WORKS. CONNECT ALL WASTE TO SYDNEY WATER SEWER LINE
- ALL NEW DOWNPIPES ARE TO BE CONNECTED TO THE EXISTING STORM WATER SYSTEM.
- ALL POWER AND STORMWATER OUTLET LOCATIONS SHALL BE DETERMINED ONSITE BY THE OWNER.
- SMOKE DETECTOR ALARM TO BE INSTALLED IN ACCORDANCE WITH AS3786 AND THE BUILDING CODE OF AUSTRALIA.
- ELECTRICAL WORK TO BE IN ACCORDANCE WITH SAA WIRING RULES AND BE DONE BY A LICENCED TRADESMAN
- ANY DETAILING IN ADDITION TO WHAT IS SUPPLIED SHALL BE RESOLVED BETWEEN THE OWNER AND THE BUILDER TO THE OWNERS APPROVAL, EXCEPT FOR ANY STRUCTURAL DETAILS OR DESIGN WHICH IS SUPPLIED BY THE ENGINEER.
- ALL TIMBER SIZES AND CONCRETE DETAILS TO BE CONFIRMED BY THE BUILDER PRIOR TO COMMENCEMENT OF ANY WORK.
- ALL STRUCTURAL WORK IS TO BE IN ACCORDANCE WITH THE STRUCTURAL DETAILS PREPARED BY A STRUCTURAL ENGINEER (i.e.) PIERS, FOOTINGS, CONCRETE SLABS, RETAINING WALLS, STEELWORK, FORMWORK, UNDERPINNING, ADDITIONAL STRUCTURAL LOADS, TIMBER FRAMING, WIND BRACING AND ASSOCIATED CONNECTIONS. BUILDER TO OBTAIN PRIOR TO FINALISING TENDER.
- ANY WORK INDICATED ON THE PLANS BUT NOT SPECIFIED, AND ANY ITEM NOT SHOWN ON THE PLAN WHICH IS OBVIOUSLY NECESSARY AS A PART OF CONSTRUCTION AND/OR FINISH IS TO BE CONSIDERED AS SHOWN AND SPECIFIED, AND IS TO BE DONE AS PART OF THE CONTRACT. VARIATIONS WILL NOT BE PERMITTED WITHOUT THE WRITTEN CONSENT OF THE OWNER.
- THE BUILDER SHALL PROVIDE SEDIMENT AND SILTRATION CONTROL MEASURES AS REQUIRED BY COUNCIL AND MAINTAIN THEM THROUGH THE DURATION OF THE WORKS.
- A LEGIBLE COPY OF THE PLANS BEARING APPROVAL STAMPS MUST BE MAINTAINED ON THE JOB AT ALL TIMES. HOURS OF CONSTRUCTION WILL BE RESTRICTED TO THE TIMES AS REQUIRED BY THE BUILDING APPROVAL.
- THE BUILDER IS TO ARRANGE FOR ALL INSPECTIONS REQUIRED BY THE AUTHORITIES AND LENDING INSTITUTIONS TO THEIR REQUIREMENTS.
- THE BUILDER IS TO OBTAIN APPROVAL FOR INTERUPTIONS TO EXISTING SERVICES AND MINIMISE THE DURATION AND NUMBER OF INTERUPTIONS. ANY INTERRUPTIONS WITH EXISTING SERVICES AND EQUIPMENT TO BE ATTENDED TO BY THE APPROPRIATELY SKILLED TRADESMEN.
- THE BUILDER SHALL RESTORE, REINSTATE OR REPLACE ANY DAMAGE CAUSED TO EXISTING STRUCTURES OR LANDSCAPING BY CONSTRUCTION WORK OR WORKMEN. PROVIDE PROTECTION TO EXISTING TREES TO REMAIN AS REQUIRED BY APPROVAL CONDITIONS.
- ALL BRICKWORK IS TO BE SELECTED BY OWNER AND IS TO COMPLY WITH AS1640
- ALL MASONRY TO COMPLY WITH AS3700
- ALL METALWORK AND FLASHING ITEMS NECESSARY TO SATISFACTORY COMLPETE WORK SHALL BE PROVIDED.
- ALL GUTTERS, DOWNPIPES TO BE COLORBOND.
- ALL TIMBER CONSTRUCTION TO BE IN ACCORDANCE WITH THE AUSTRALIAN STANDARD 1684 "TIMBER FRAMING CODE"
- ALL GLAZING INSTALLED TO COMPLY WITH AS1288, 2047 AND IN ACCORDANCE WITH MANUFACTURERS RECOMMENDATION
- ALL WALL AND CEILING LININGS TO BE PLASTERBOARD OR CEMENT RENDER AS SELECTED AND VILLA BOARD IN WET AREAS, TO COMPLY WITH THE RELEVANT AUSTRALIAN STANDARDS OR INSTALLED IN ACCORDANCE WITH MANUFACTURERS SPECIFICATION.
- ALL BATHROOMS AND WET AREAS TO BE ADEQUATELY WATERPROOFED TO MANUFACTURERS SPECIFATION AND AS3740 AND PART 3.8.1 OF THE BUILDING CODE OF AUSTRALIA HOUSING PROVISIONS
- STAIRS AND BALUSTRADES TO COMPLYWITH PART 3.9.1 & 3.9.2 OF THE BUILDING CODE OF AUSTRALIA HOUSING PROVISION.
- TERMITE PROTECTION MEASURES TO COMPLY WITH AS 3660 AND BE INSTALLED TO MANUFACTURERS SPECIFICATION.
- ANY DETAILING ADDITIONAL TO THAT SUPPLIED, SHALL BE RESOLVED BETWEEN THE OWNER AND THE BUILDER TO THE OWNERS APPROVAL. EXCEPT FOR ANY STRUCTURAL DETAILS OR DESIGN WHICH IS TO BE SUPPLIED BY THE STRUCTURAL ENGINEER.

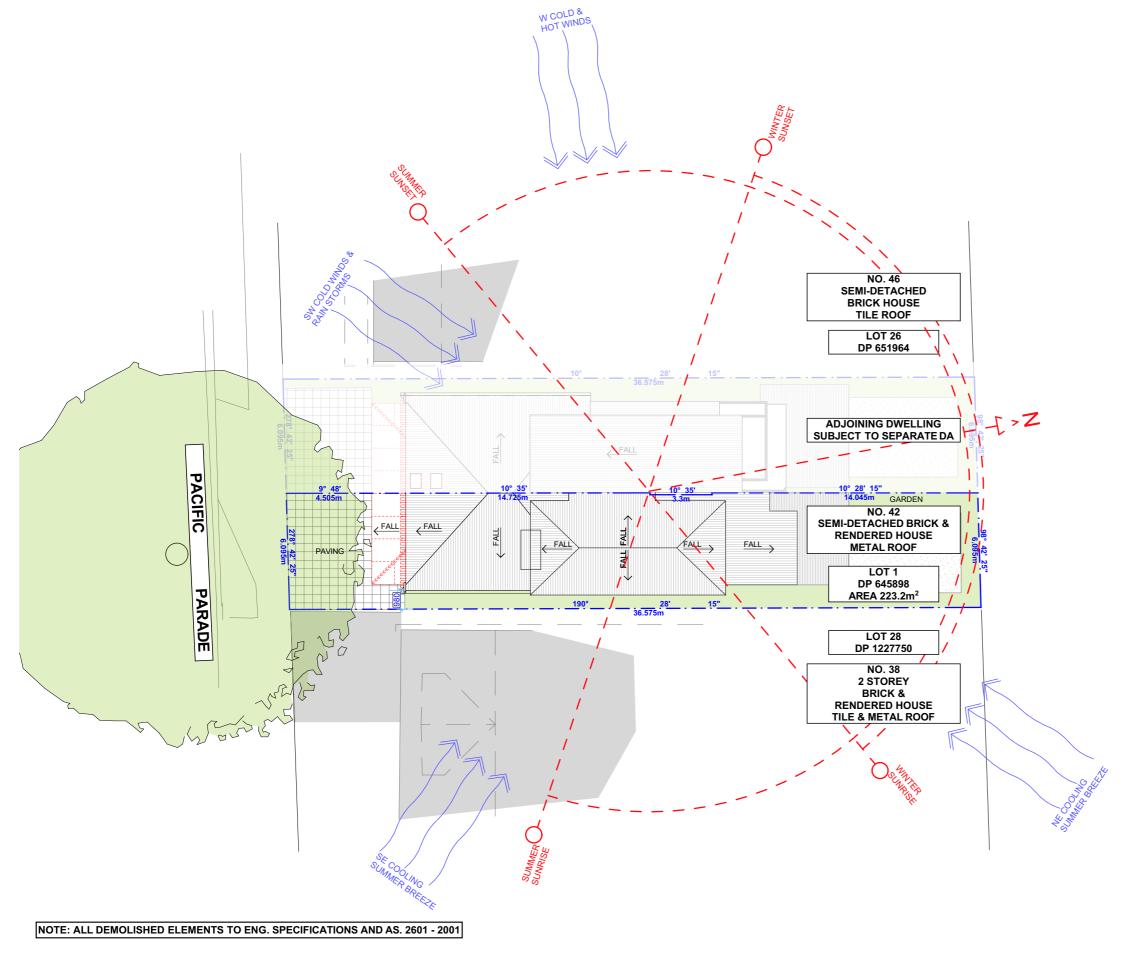



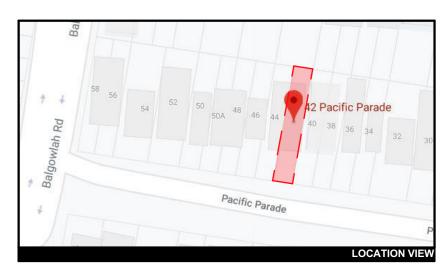





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	REV.	DATE	COMMENTS	DRWN	N
	А	190625	INITIAL DESIGN PLAN	LRP	a
	В	190724	FIRST DESIGN AMENDMENT	RNA	A
u	С	190827	DA DOCUMENTATION	LRP	a
	D	191106	DA REV A	LRP	d
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LEGEND			

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ALEX & KERRIE RALEC

PROJECT ADDRESS

42 PACIFIC PARADE, MANLY 2095 DRAWING NO.

November 2019

DA02


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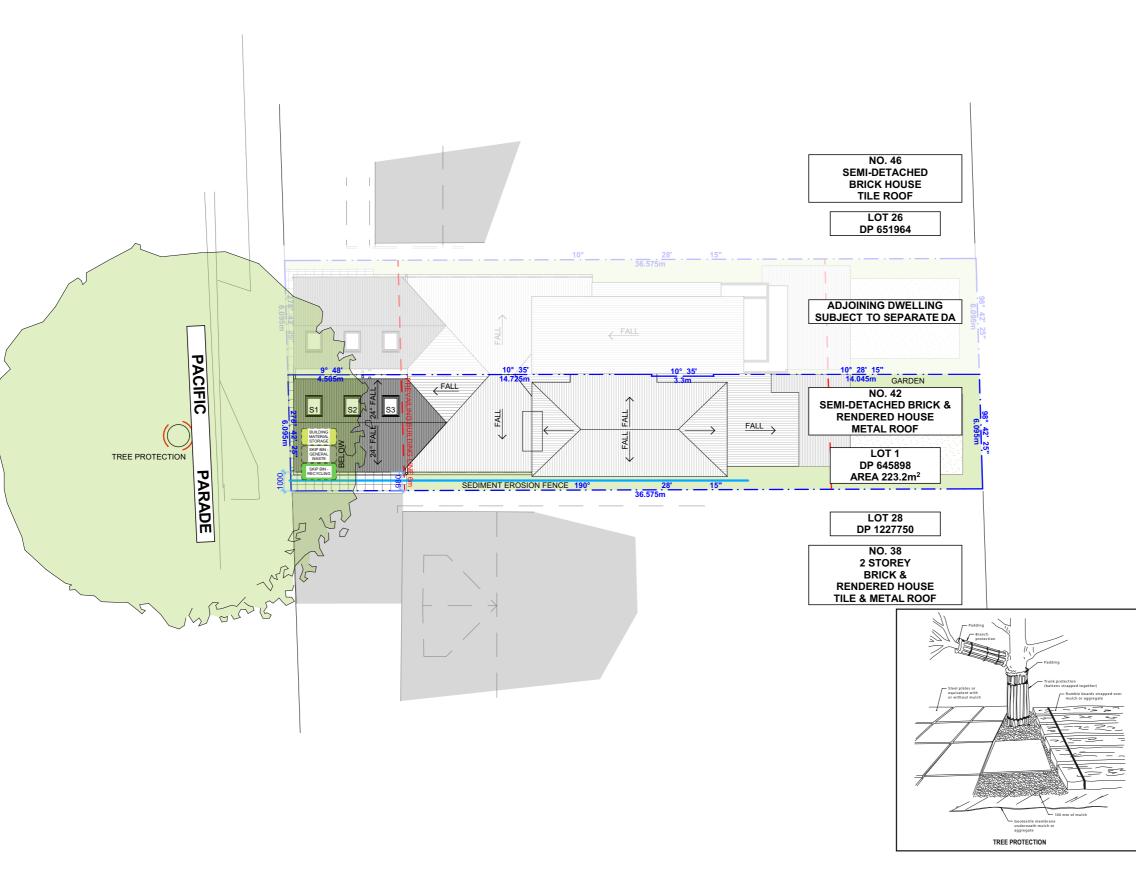
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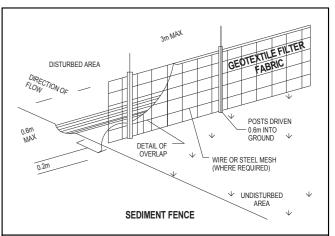
SCALE 1:200 @A3

DRAWING NAME

SITE ANALYSIS





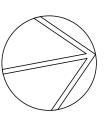

DUST CONTROL:

TO REDUCE DUST GENERATED BY WIND ACTION, THE REMOVAL OF THE TOP SOIL IS TO BE MINIMISED. TO PREVENT DUST GENERATION, WATERING DOWN OF THE SITE, ESPECIALLY DURING THE MOVEMENT OF MACHINERY IS REQUIRED. WHERE EXCAVATING INTO ROCK, KEEP THE SURFACE MOIST TO MINIMISE DUST. CONSTRUCT A GRAVEL ENTRY/EXIT POINT USING BLUE METAL AND RESTRICT ALL VEHICLE MOVEMENTS WITHIN THE SITE TO A MINIMUM. ENSURE WIND BREAKS, SUCH AS EXISTING FENCES ARE MAINTAINED DURING THE CONSTRUCTION PHASE UNTIL NEW LANDSCAPING IS PROVIDED OR REINSTATED. PREVENT DUST BY COVERING STOCKPILES

SEDIMENT NOTE :

- 1. ALL EROSION AND SEDIMENT CONTROL MEASURES TO BE INSPECTED AND MAINTAINED DAILY BY THE SITE MANAGER.
- 2. MINIMISE DISTURBED AREAS, REMOVE EXCESS SOIL FROM EXCAVATEDAREA AS SOON AS POSSIBLE.
 3. ALL MATERIAL STOCKPILE TO BE CLEAR FROM DRAINS, GUTTERS AND FOOTPATHS, OR WITHIN SEDIMENT FENCE AREA.
- 4. DRAINAGE TO BE CONNECTED TO STORMWATER AS SOON AS POSSIBLE. IF STORED ON SITE, IT MUST BE FILTERED BEFORE RELEASING INTO STORMWATER SYSTEM OR WATERWAYS.
- 5. ROADS AND FOOTPATHS TO BE SWEPT DAILY.

STOCKPILES

ALL STOCKPILES ARE TO BE KEPT ON-SITE WHERE POSSIBLE. ANY MATERIALS PLACED ON THE FOOTPATHS OR NATURE STRIPS REQUIRE COUNCIL'S PERMISSION.

ALL STOCKPILES ARE TO BE PLACED AWAY FROM THE DRAINAGE LINES AND STREET GUTTERS. IT IS BEST TO LOCATE THESE ON THE HIGHEST PART OF THE SITE IF POSSIBLE. PLACE WATERPROOF COVERING OVER STOCKPILES.

IF REQUIRED PROVIDE DIVERSION DRAIN & BANK AROUND STOCKPILES.

GUTTER PROTECTION:


PROVIDE PROTECTION TO DOWNHILL GRATE IN GUTTER BY MEANS OF SAND BAGS OR BLUE METAL WRAPPED IN GEOTEXTILE FABRIC. WHEN SOIL OR SAND BUILDS UP AROUND THIS SEDIMENT BARRIER, THE MATERIAL SHOULD BE RELOCATED BACK TO THE SITE FOR DISPOSAL.

NOTE: ALL PROPOSED STORMWATER TO CONNECT WITH EXISTING


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	А	190625	INITIAL DESIGN PLAN	LRP
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	С	190827	DA DOCUMENTATION	LRP
ı	D	191106	DA REV A	LRP



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42 PACIFIC PARADE, Wed Nov

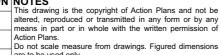DRAWING NO.

DA03

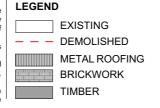DATE


Wednesday, 6 November 2019


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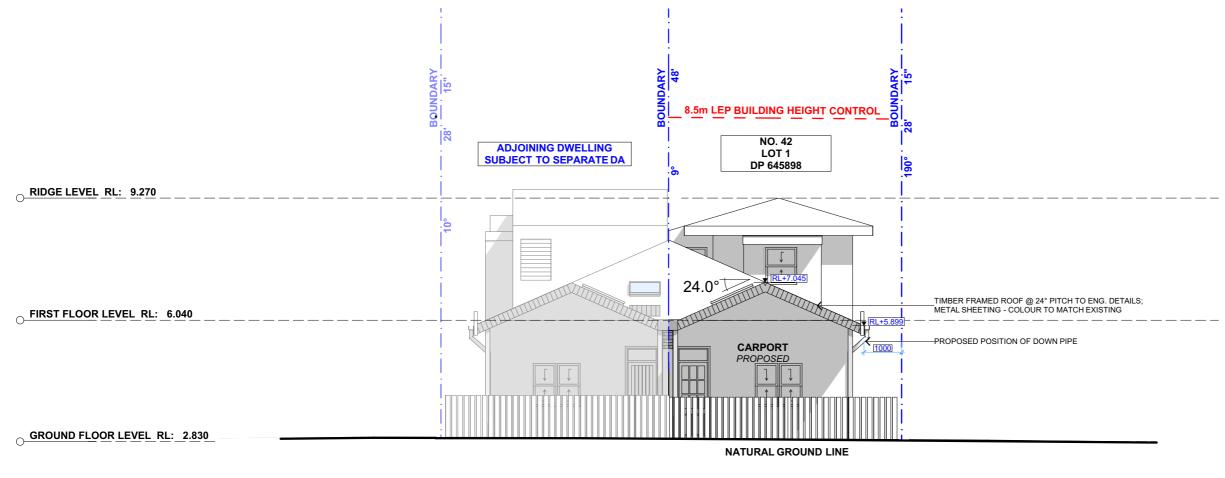
SITE / ROOF / SEDIMENT EROSION / WASTE MANAGEMENT / STORMWATER CONCEPT PLAN

SCALE

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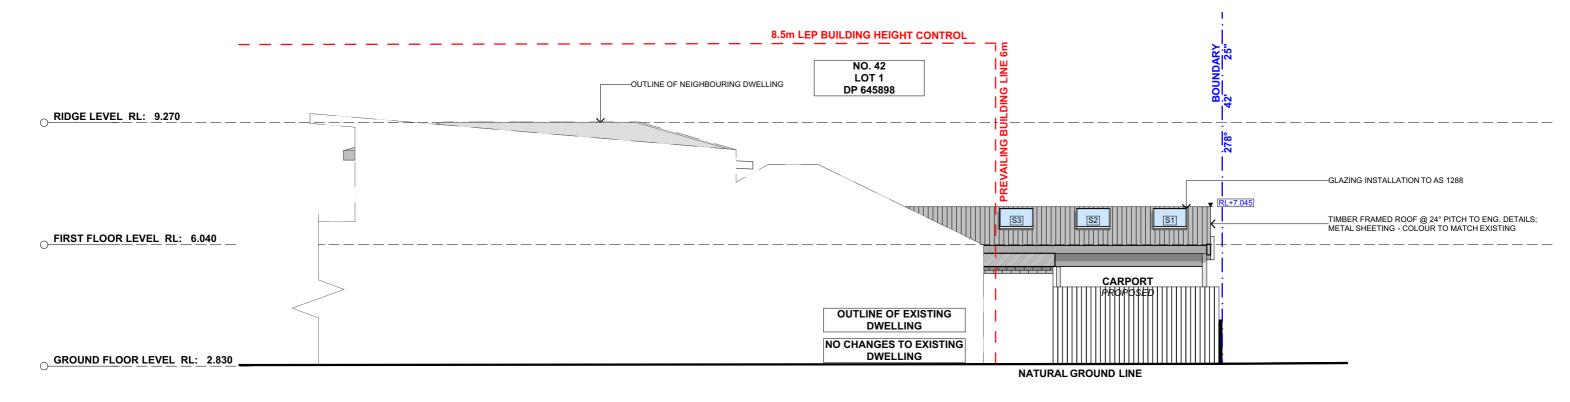




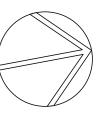

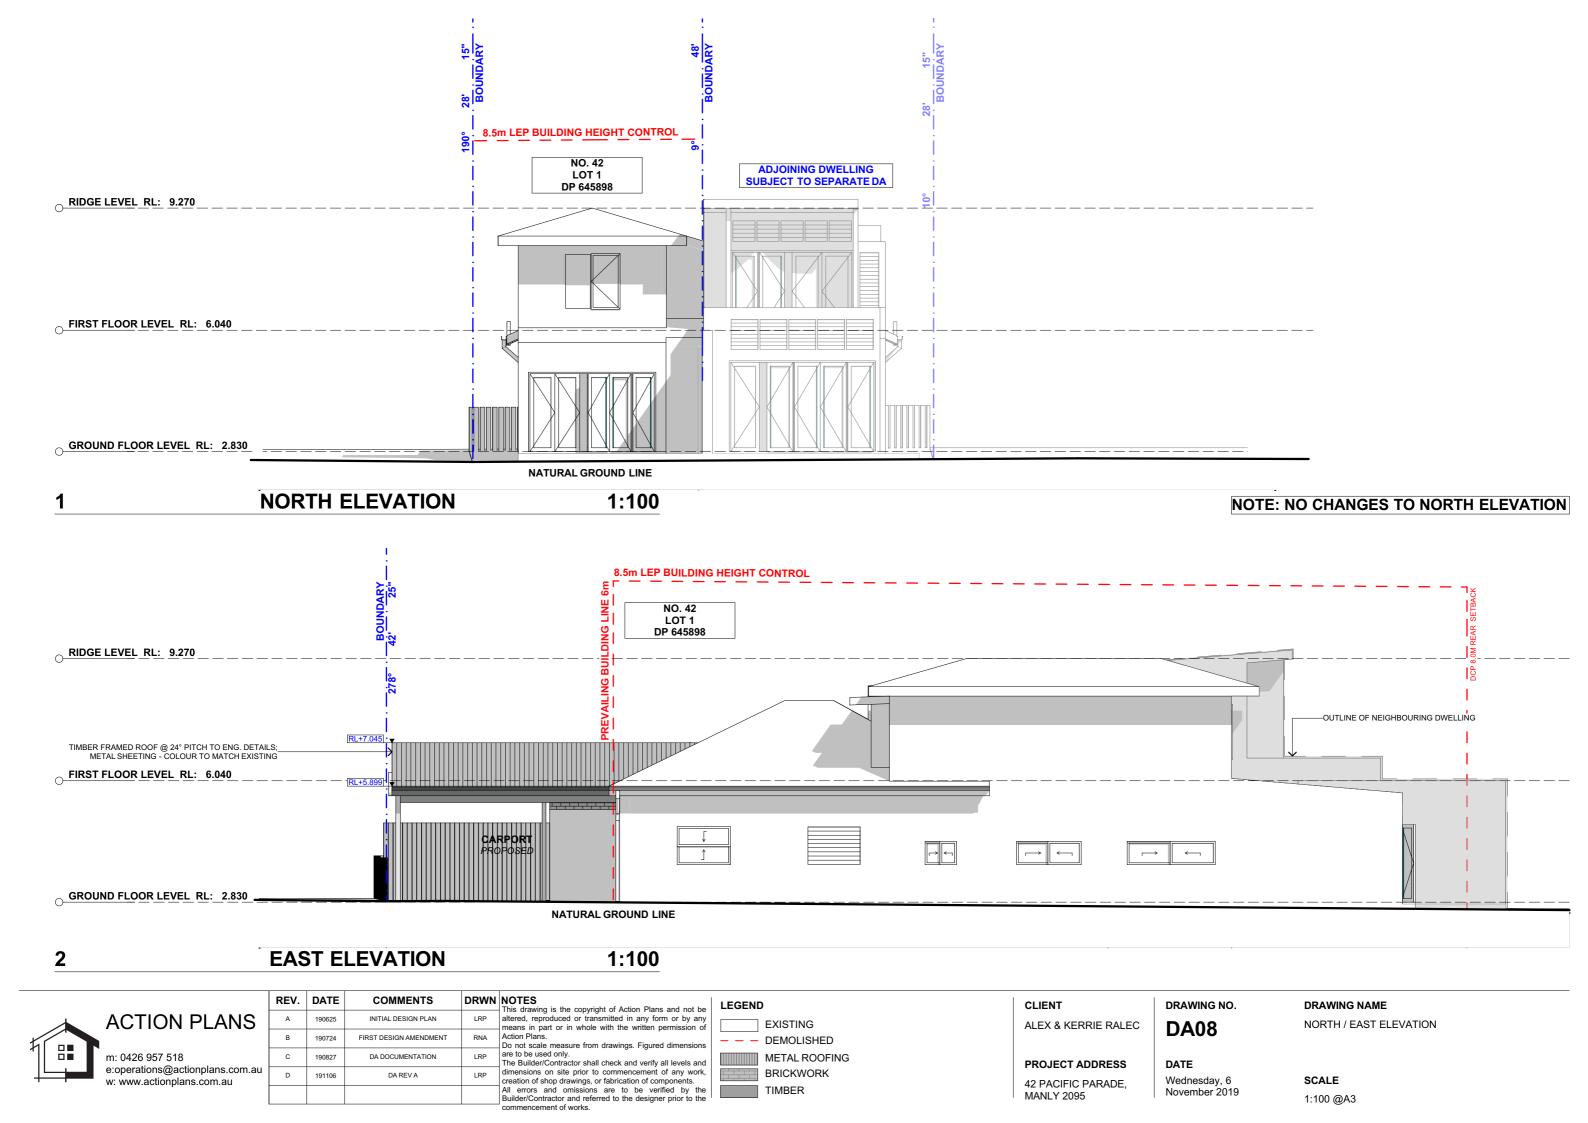SOUTH ELEVATION

1:100



WEST ELEVATION 1:100



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	В	190724	FIRST DESIGN AMENDMENT	RNA	Action Plans. Do not scale measure from dr
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PROJECT ADDRESS


42 PACIFIC PARADE, MANLY 2095

DA09	
DATE	
Wednesday, 6	

November 2019

DRAWING NAME SOUTH / WEST ELEVATION

SCALE 1:100 @A3

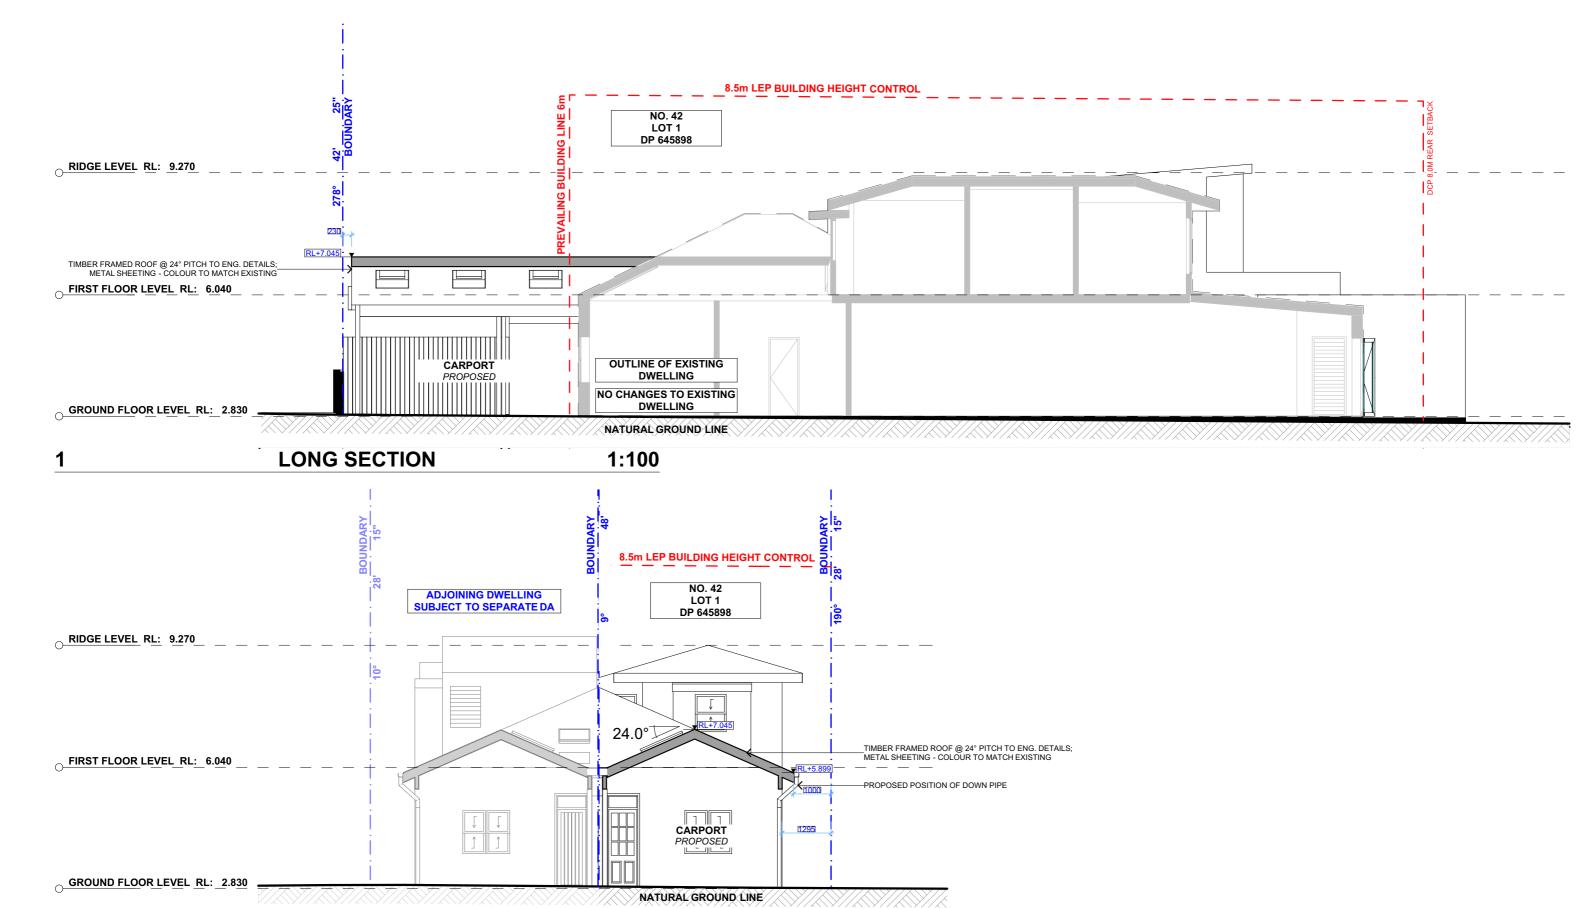

CROSS SECTION 1:100



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PROJECT ADDRESS 42 PACIFIC PARADE, MANLY 2095 DA10

0 LONG / CROSS SECTION

DATE
Wednesday, 6
November 2019

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DRAWING NAME




COLOURBOND METAL ROOF SHEETING POWDERCOAT FINISH 'MANOR RED' OR SIMILAR WHERE MARKED ON ELEVATION.





FSL-01 - FIXED VELUX SKYLIGHT WINDOW WHERE MARKED ON ELEVATION.

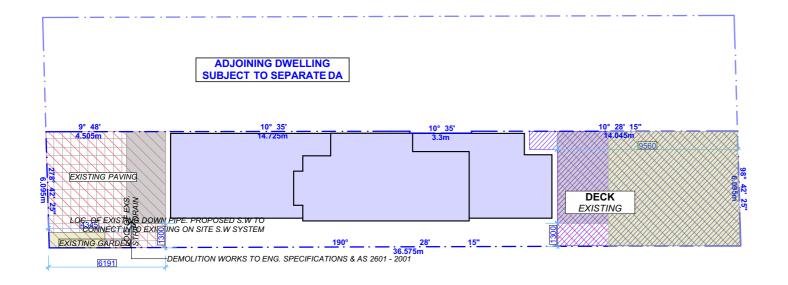

SITE AREA 223.2m ²	CONTROL TABLE	=			
	REQUIRED	EXISTING	PROPOSED		
FLOOR SPACE RATIO	0:6 : 1 (133.92m²)	0.56 : 1 (125.86m²)	UNCHANGED		
TOTAL OPEN SPACE	55% (122.76m ²)	96.37m ²	UNCHANGED		
LANDSCAPE	35% TOS 42.96m ²	41.88m²	UNCHANGED		
OPEN SPACE ABOVE GROUND	40% OF TOS 49.1m ²	23.1m ²	UNCHANGED		
PRIVATE OPEN SPACE	18m ²	59.5m ²	UNCHANGED		


1:200 **EXISTING AREA CALCULATIONS**




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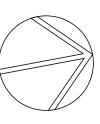
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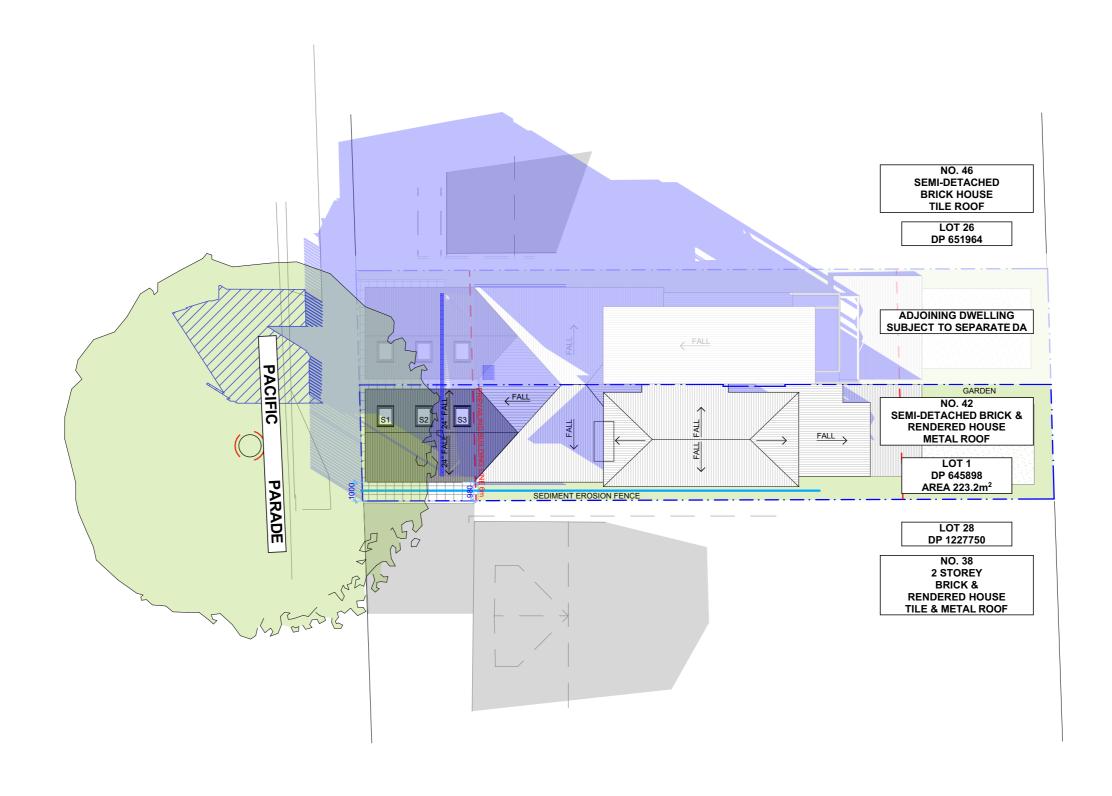
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DRAWING NO. **DA11**

DATE Wednesday, 6 November 2019 DRAWING NAME AREA CALCULATIONS / SAMPLE BOARD

SCALE 1:200 @A3

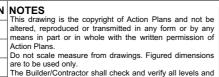


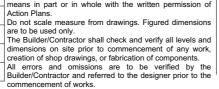




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commencement of works.

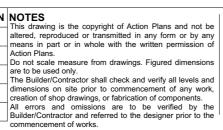

CLIENT

ALEX & KERRIE RALEC

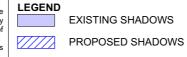PROJECT ADDRESS

42 PACIFIC PARADE, MANLY 2095

DA12

DATE


Wednesday, 6 November 2019


DRAWING NO.

DRAWING NAME

WINTER SOLSTICE 9 AM

SCALE 1:200 @A3

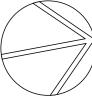


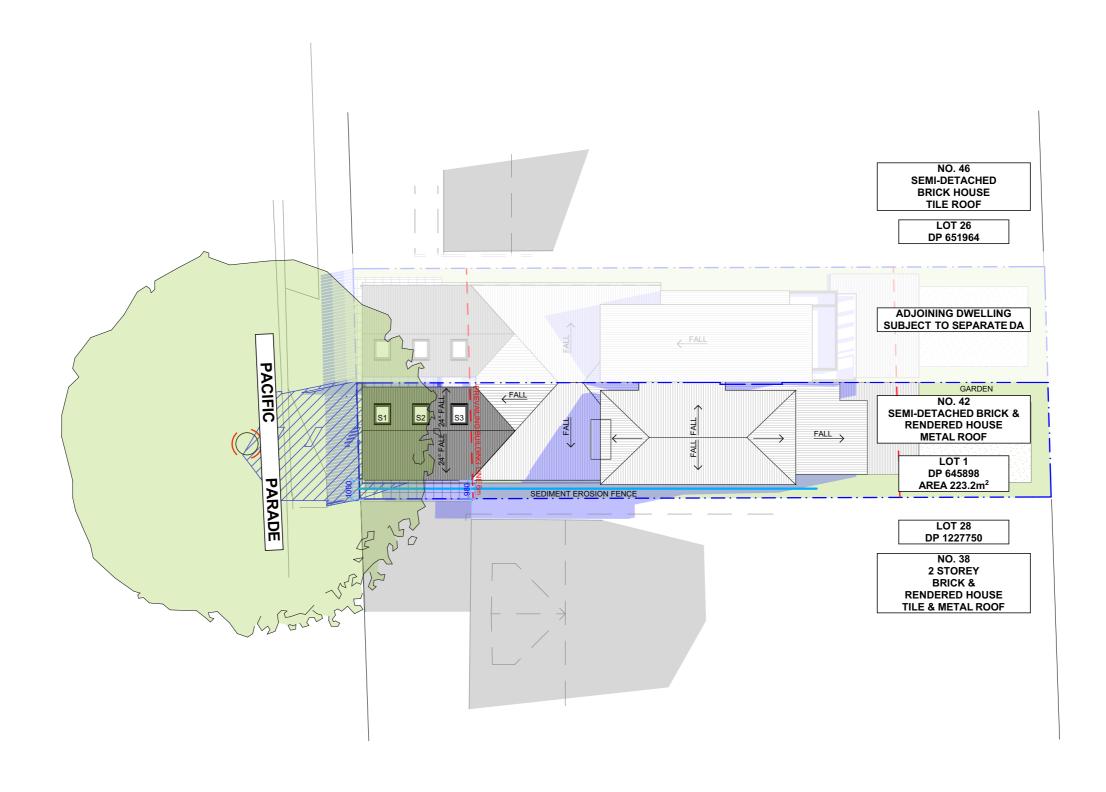




w: www.actionplans.com.au

	REV.	DATE	COMMENTS	DRWN	NOTES This drawing is the copyrig
	Α	190625	INITIAL DESIGN PLAN	LRP	altered, reproduced or tran
	В	190724	FIRST DESIGN AMENDMENT	RNA	Action Plans. Do not scale measure from
	С	190827	DA DOCUMENTATION	LRP	are to be used only. The Builder/Contractor shal
1	D	191106	191106 DA REV A	LRP	dimensions on site prior to creation of shop drawings, of
					All errors and omission Builder/Contractor and ref commencement of works.

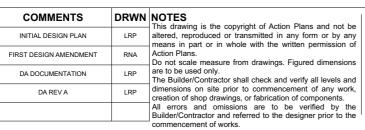

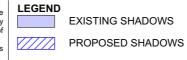

CLIENT

ALEX & KERRIE RALEC

PROJECT ADDRESS

42 PACIFIC PARADE, MANLY 2095

DA13

DATE


Wednesday, 6 November 2019


DRAWING NO.

DRAWING NAME WINTER SOLSTICE 12 PM

SCALE

1:200 @A3

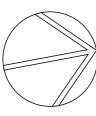


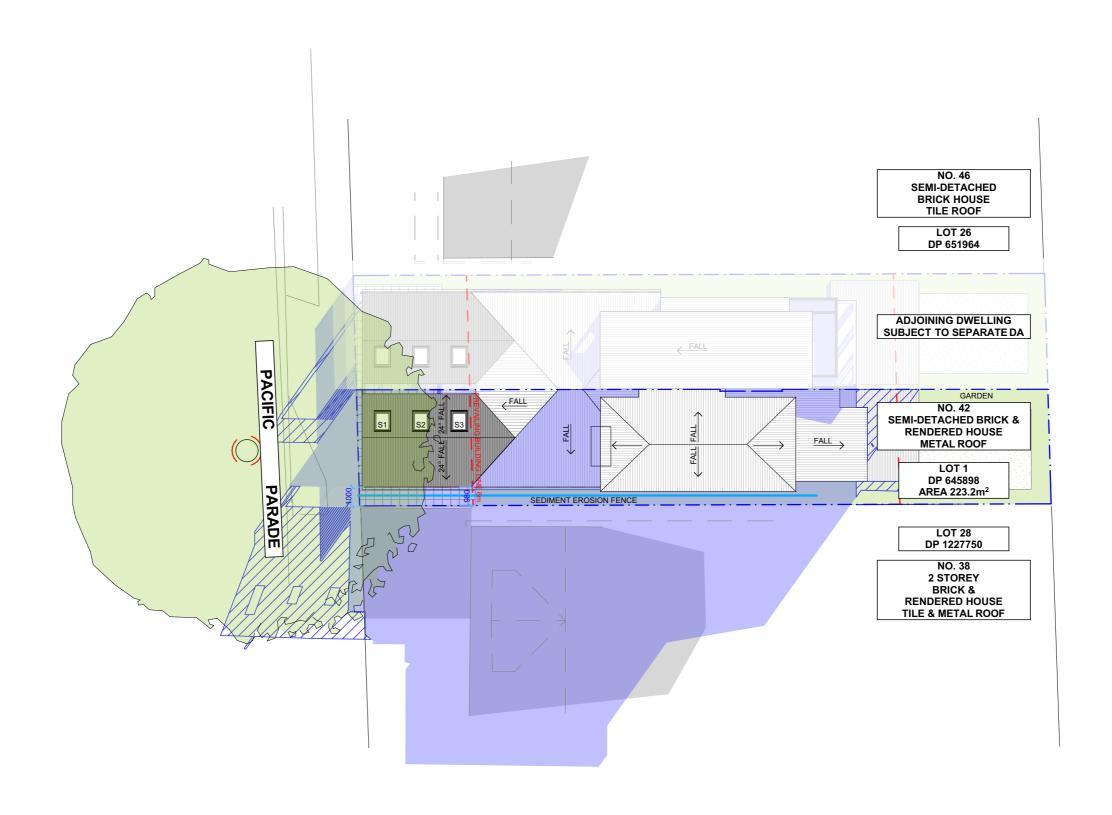



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REV.	DATE	COMMENTS	DRWN	NOTES This drawing is the copyrig
А	190625	INITIAL DESIGN PLAN	LRP	altered, reproduced or tran- means in part or in whole
В	190724	FIRST DESIGN AMENDMENT	RNA	Action Plans. Do not scale measure from
С	190827	DA DOCUMENTATION	LRP	are to be used only. The Builder/Contractor shal
D	191106	DA REV A	LRP	dimensions on site prior creation of shop drawings
				All errors and omissions Builder/Contractor and refer commencement of works.

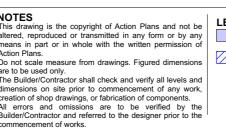

LEGEND EXISTING SHADOWS

PROPOSED SHADOWS

CLIENT

ALEX & KERRIE RALEC

PROJECT ADDRESS

42 PACIFIC PARADE, MANLY 2095 DRAWING NO.

DA14

November 2019

DATEWednesday, 6

DRAWING NAME
WINTER SOLSTICE 3 PM

SCALE 1:200 @A3

