STORMWATER MANAGEMENT PLAN

88 BOWER STREET MANLY



Con Katsoulas
BE (Civil), MIEAust, CPEng No. 449924

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SHEET No.	TITLE	AMMENDMENT No.
1	INDEX SHEET	0
2	STORMWATER DETAIL PLAN	0
3	LOWER GROUND FLOOR PLAN	0
4	LEVEL 1 PLAN	0
5	ENTRY LEVEL PLAN	0
6	ROOF PLAN	0
7	RAINWATER TANK DETAIL & DRIVEWAY LONG SECTION	0
8	DRIVEWAY LONG SECTION	0
9	EROSION AND SEDIMENT CONTROL PLAN	0

LEGEND IL 0.00 PIT/PIPE INVERT LEVEL **FLOWPATH** TK 0.00 TOP OF KERB LEVEL FS-1 FLOW SPREADER AND DOWNPIPE TYPE 1 + 00.00 EXISTING SURFACE LEVEL + 00.00 PROPOSED SURFACE LEVEL PROPOSED SEALED WATER TIGHT PIT SEALED INSPECTION OPENING ● DP-1 DOWNPIPE - TYPE 1 PROPOSED STORMWATER PIPE - GRAVITY PROPOSED V-DRAIN PROPOSED STORMWATER PIPE - CHARGED PROPOSED RISING MAIN (PRESSURE PIPE) PROPOSED SUBSOIL DRAIN BASIX ROOF AREA DRAINING TO RAINWATER TANK PROPOSED BUILDING - GROUND FLOOR PROPOSED BUILDING - FIRST FLOOR AREA BYPASSING ON-SITE DETENTION TANK PROPOSED CONTOURS


NOTES

- ALL PROPOSED PITS TO BE 450 x 450 CAST IN-SITU OR PRECAST PITS UNLESS SHOWN OTHERWISE.
- 2. ALL CHARGED LINE PIPES TO BE 100Ø uPVC SEWER CLASS UNLESS SHOWN OTHERWISE
- OTHERWISE SHOWN
- ALL NON-PRESSURE STORMWATER PIPES TO BE 100Ø uPVC UNLESS SHOWN OTHERWISE
- ALL GRATED DRAINS TO BE MINIMUM 150 WIDE GALVANIZED HEAVY DUTY GRATES.
- 6. ALL NON-TRAFFICABLE PITS TO BE LIGHT DUTY. PITS IN TRAFFICABLE AREAS TO BE HEAVY DUTY.
- 7. ALL WORK SHALL BE CARRIED OUT IN ACCORDANCE WITH COUNCILS SPECIFICATIONS.
- 8. ALL PITS GREATER THAN 1.2m DEPTH SHALL INCLUDE STEP IRONS AND HAVE MINIMUM CLEAR DIMENSIONS OF 600 x 600.
- 9. ALL PITS ARE TO BE BENCHED TO ALLOW SMOOTH FLOW
 OF WATER THROUGH PITS
- ALL DOWNPIPES SHALL CONFORM TO AS/NZS 1866 FOR ALUMINIUM PIPES AND AS 1254, AS/NZS 1260, AS 1273, AS/NZS 1477, AS/NZS 2179.2 AND AS 2032 FOR uPVC PIPES
- 11. ALL BOX GUTTERS SHALL COMPLY WITH AS/NZS 2179.112. ALL BOX GUTTERS SHALL BE CONSTRUCTED WITH A
- MINIMUM 1:200 GRADE TO SUMP/DOWNPIPES


 13. ALL DRAINAGE WORKS SHALL BE IN ACCORDANCE WITH
- ALL DRAINAGE WORKS SHALL BE IN ACCORDANCE WITH AS 3500.3.2

DOWNPIPE TYPE	DOWNPI	PE SIZES
DOWNPIPE I TPE	ROUND	RECTANGULAR
1	90Ø	100 X 75
2	100Ø	100 X 75
3	125Ø	100 X 100
4	150Ø	150 X 150

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								ABN 67 115 216 496	NOEL & PAULINE CARROL	INDEX	DESIGNED:	CK	1	SCALE: AS SHOWN
ARCHITECT								49 FLORA ST			-		f	
SQUILLACE								ROSELANDS, NSW 2196	PROJECT:		CHECKED:	C.K.		DATUM: AHD
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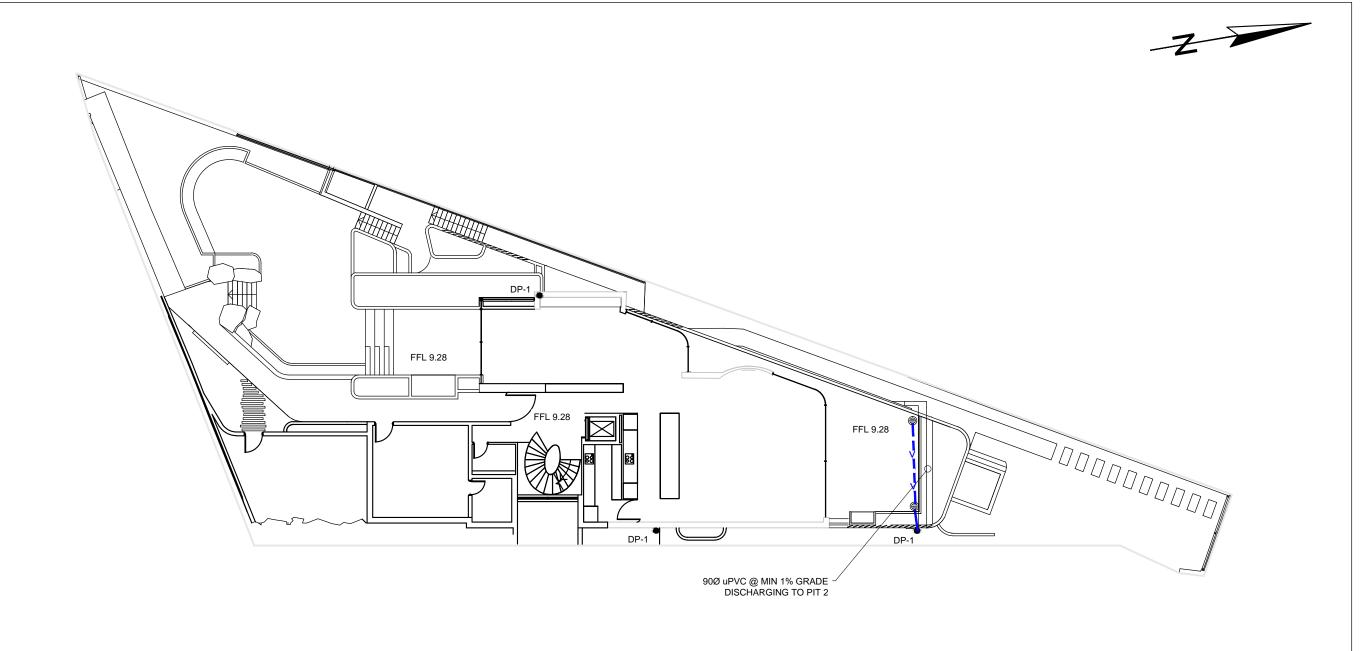


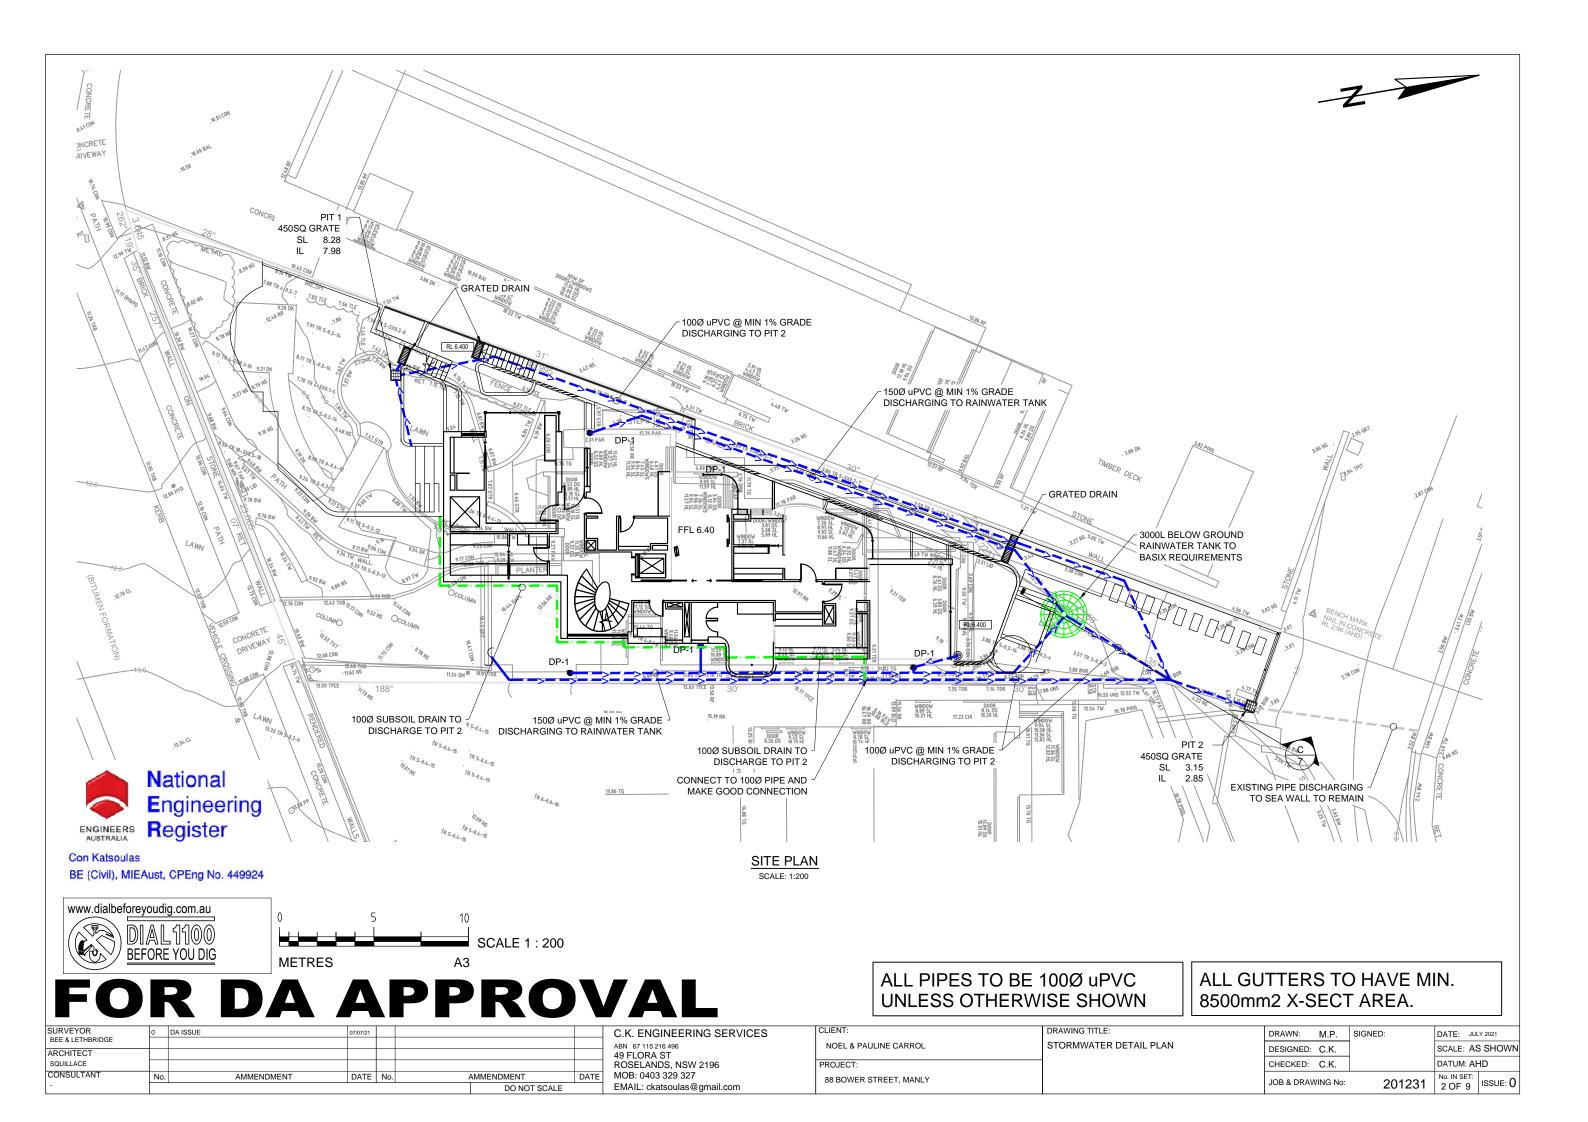LOWER GROUND FLOOR PLAN

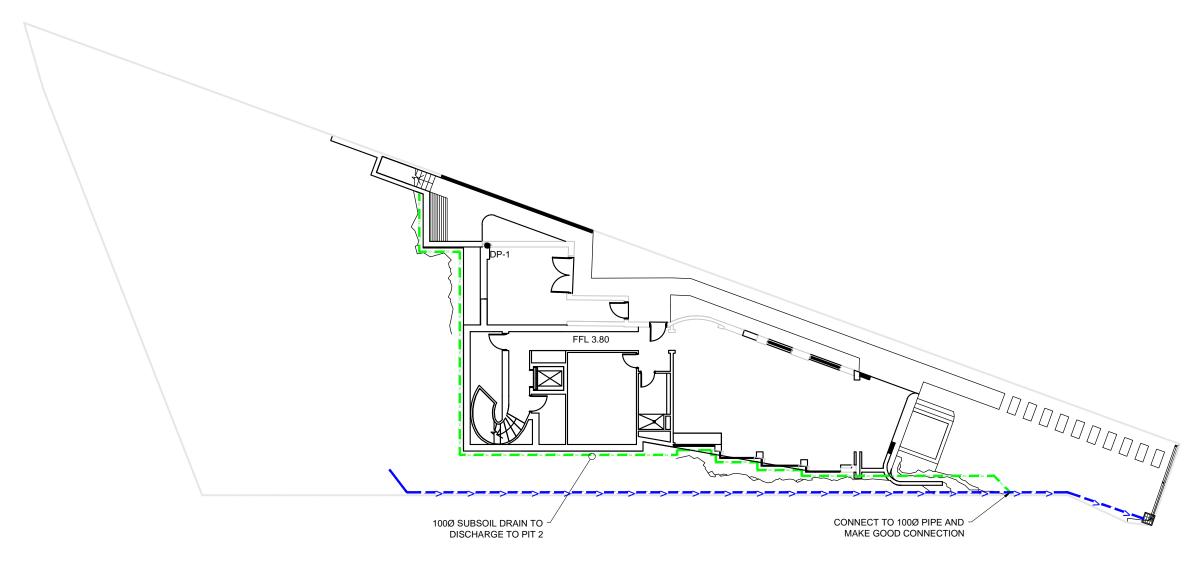

Con Katsoulas BE (Civil), MIEAust, CPEng No. 449924

SURVEYOR	0	D.	A ISSUE	07/07/21				C.K. ENGINEERING SERVICES	CLIENT:	DRAWING TITLE:	DRAWN:	M.P.	SIGNED:	DATE: JULY	Ý 2021
ARCHITECT	JGE							ABN 67 115 216 496	NOEL & PAULINE CARROL	FIRST FLOOR PLAN	DESIGNED	: C.K.		SCALE: AS	SHOWN
SQUILLACE								49 FLORA ST ROSELANDS, NSW 2196	PROJECT:		CHECKED:	C.K.		DATUM: AH	ıD
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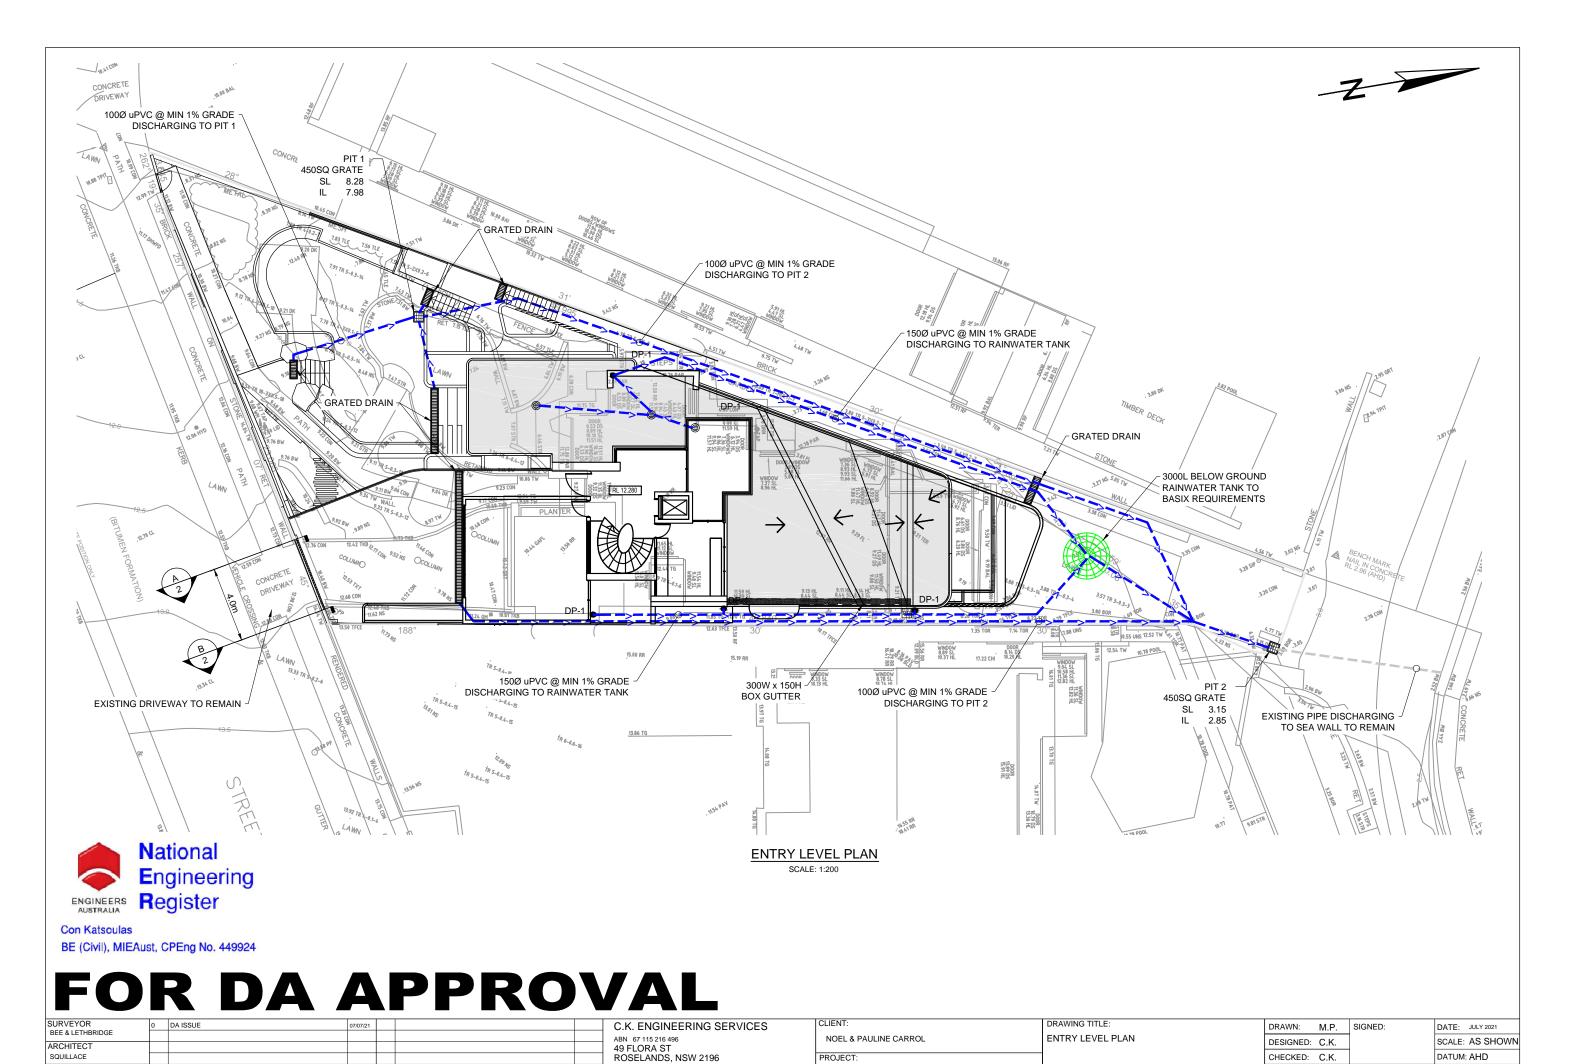


LEVEL 1 PLAN
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SURVEYOR		DA ISSUE		07/07/21				C.K. ENGINEERING SERVICES	CLIENT:	DRAWING TITLE:	DRAWN:	M.P.	SIGNED:	DATE: JULY 2021
BEE & LETHBRII	DGE							ABN 67 115 216 496	NOEL & PAULINE CARROL	LEVEL 1 PLAN	DESIGNED:	CK	_	SCALE: AS SHOWN
ARCHITECT								49 FLORA ST			DESIGNED.	U.N.		
SQUILLACE								ROSELANDS, NSW 2196	PROJECT:		CHECKED:	C.K.		DATUM: AHD
CONSULTANT	Ī	No.	AMMENDMENT	DATE	No.	AMMENDMENT	DATE	MOB: 0403 329 327	88 BOWER STREET, MANLY		JOB & DRA	MINIC No:	004004	No. IN SET:
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88 BOWER STREET, MANLY

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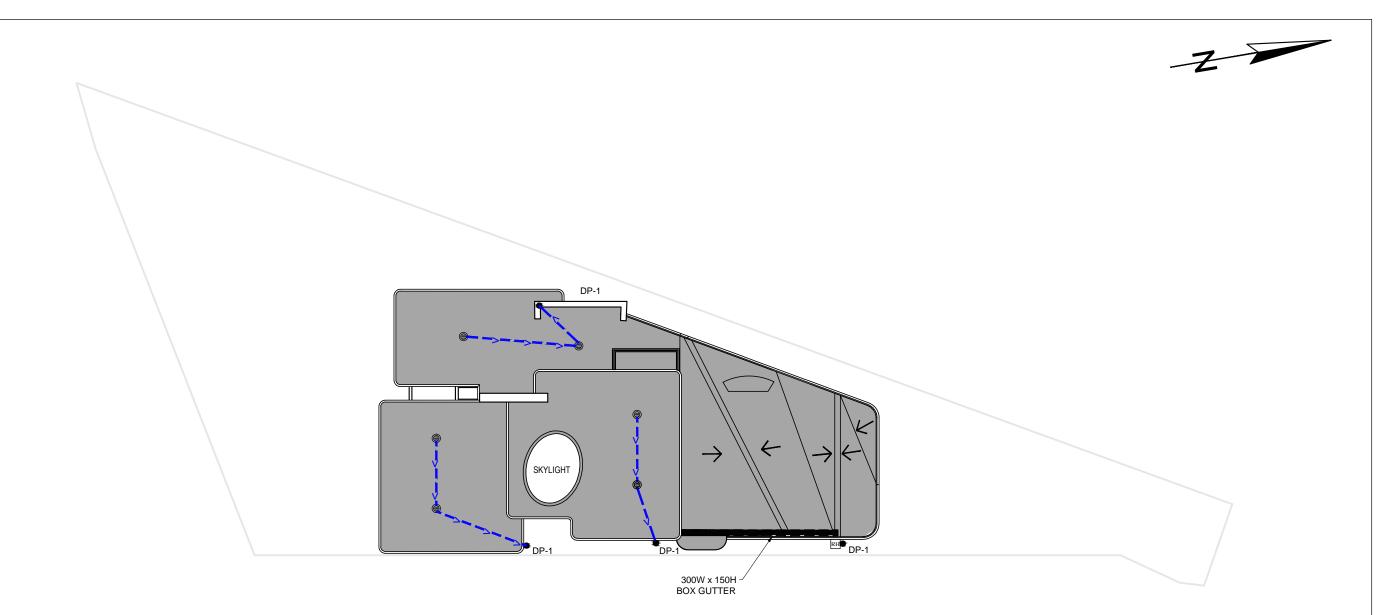
EMAIL: ckatsoulas@gmail.com

AMMENDMENT

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CONSULTANT

AMMENDMENT









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SURVEYOR		DA ISSUE		07/07/21				C.K. ENGINEERING SERVICES	CLIENT:	DRAWING TITLE:	DRAWN:	M.P.	SIGNED:	DATE: JULY 2021
BEE & LETHBRIDG	GE							ABN 67 115 216 496	NOEL & PAULINE CARROL	ROOF PLAN	DESIGNED:	CK	†	SCALE: AS SHOWN
ARCHITECT								49 FLORA ST			DESIGNED.	U.N.	4	
SQUILLACE								ROSELANDS, NSW 2196	PROJECT:		CHECKED:	C.K.		DATUM: AHD
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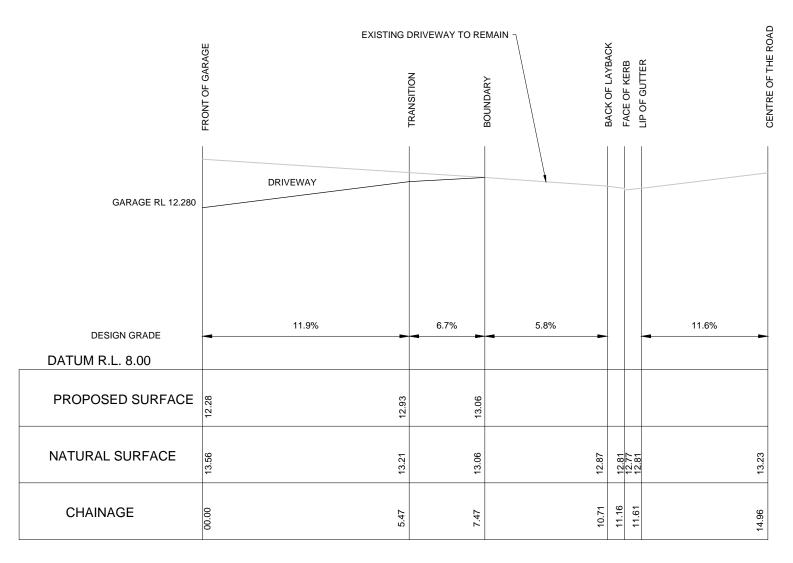
3000L UNDERGROUND RAINWATER TANK SECTION DETAIL C
SCALE: N.T.S. 2



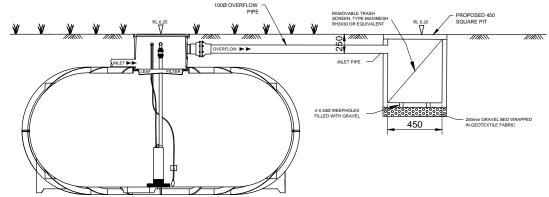

Con Katsoulas BE (Civil), MIEAust, CPEng No. 449924 DRIVEWAY CROSS SECTION A
SCALE: 1:100 2

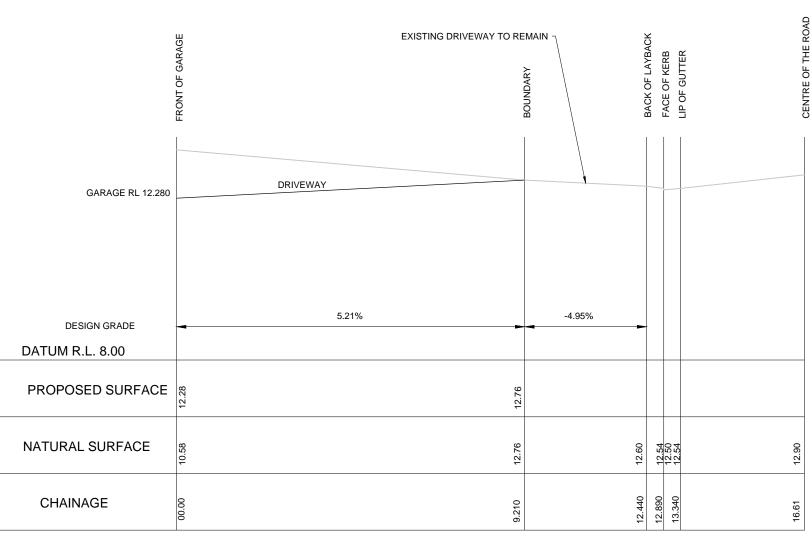SURVEYOR	0	DA ISSUE	07/07/21				C.K. ENGINEERING SERVICES	CLIENT:	DRAWING TITLE:	DRAWN:	M.P.	SIGNED:	DATE: JUL	LY 2021
BEE & LETHBRIDGE							ABN 67 115 216 496	NOEL & PAULINE CARROL	RAINWATER TANK DETAIL & DRIVEWAY LONG	DEGLOVIED		-	SCALE: AS	C CLIOVA/N
ARCHITECT							49 FLORA ST	THOSE AT THE STATE OF THE STATE	SECTION	DESIGNED	: C.K.		SCALE: AS	3 SHOWN
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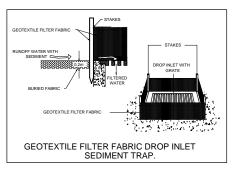



DRIVEWAY CROSS SECTION B
SCALE: 1:100 2




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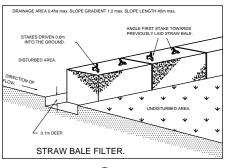
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BEE & LETHBRIDGE						ABN 67 115 216 496	NOEL & PAULINE CARROL	DRIVEWAY LONG SECTION		0.14		
ARCHITECT						49 FLORA ST	NOCE AT NOCENCE OF WINDE	Bravewar Edito deditor	DESIGNED:	C.K.		SCALE: AS SHOWN
SQUILLACE						ROSELANDS, NSW 2196	PROJECT:	1	CHECKED:	C.K.		DATUM: AHD
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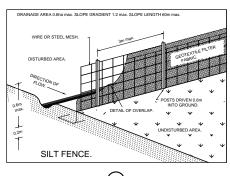




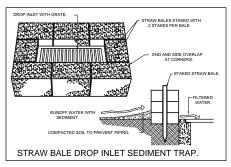

DETAIL (3)

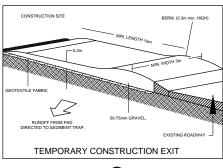










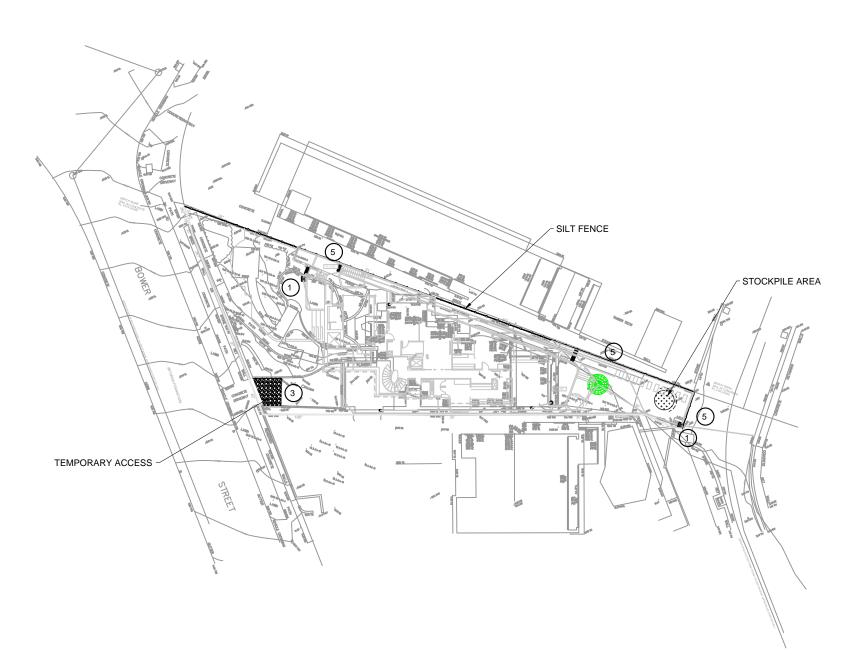



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EROSION CONTROL NOTES:

- ALL WORK SHALL BE CARRIED OUT IN ACCORDANCE WITH COUNCIL'S
 STANDARD SPECIFICATIONS AND TO THE SATISFACTION OF COUNCIL'S
 ENGINEER
- 2. EROSION AND SEDIMENTATION CONTROLS SHALL BE CONSTRUCTED AS SHOWN ON SHEET 2 AND 3 OF THIS PLAN AND/OR WHERE DIRECTED BY COUNCIL'S ENGINEER
- 3. SEDIMENTATION AND EROSION CONTROL DEVICES SHALL BE IMPLEMENTED PRIOR TO OR IN CONJUNCTION WITH THE FIRST PHASE OF EARTHWORKS AND SHALL BE REMOVED ONLY WHEN THE AREAS ABOVE IT HAVE BEEN STABILISED. EACH SEDIMENTATION AND EROSION CONTROL DEVICE SHALL BE INSPECTED AFTER EACH STORM FOR STRUCTURAL DAMAGE OR CLOGGING BY SILT AND OTHER DEBRIS AND PROMPTLY DESILTED, REPAIRED OR REPLACED IF
- TOPSOIL STOCKPILES SHALL BE LOCATED OUTSIDE HAZARD AREAS SUCH AS DRAINAGE DEPRESSIONS.
- 5. ALL AREAS NOT SUBJECT TO CONSTRUCTION WORKS SHALL BE RETAINED FREE FROM DISTURBANCE OR DAMAGE FOR THE DURATION OF THE WORKS.
- TREES TO BE RETAINED SHALL BE PROTECTED DURING SITE WORKS AND CONSTRUCTION BY THE ERECTION OF SOLID BARRICADES AT THE DRIP LINE OR AS SPECIFIED BY COUNCIL'S ENGINEER.
- 7. THE DEVELOPER OR CONTRACTOR WILL TAKE ALL MEASURES TO PREVENT DAMAGE TO TREES AND ROOT SYSTEMS DURING SITE WORKS AND CONSTRUCTION ACTIVITIES INCLUDING THE PROVISION OF WATER, SEWERAGE AND STORMWATER DRAINAGE SERVICES. IN PARTICULAR, WORKS, ERECTION OF STRUCTURES, EXCAVATION OR CHANGES TO SOIL LEVELS WITHIN 4 METRES OF THE TRUNKS OF TREES TO BE RETAINED ARE NOT PERMITTED UNLESS PART OF THE DEVELOPMENT AS APPROVED, AND THE STORAGE OF SPOIL, BUILDING MATERIALS, SOILS OR THE DRIVING OR PARKING OF ANY VEHICLE OR MACHINERY WITHIN 4 METRES OF THE TRUNK OF A TREE TO BE RETAINED, IS NOT PERMITTED.
- 8. WETTING OF THE SITE SHOULD BE CARRIED OUT AS OFTEN AS NECESSARY AS A FORM OF DUST CONTROL.
- 9. SILT FENCES TO BE CONSTRUCTED WHERE EVER NATURAL SURFACE SLOPES AWAY FROM DISTURBED AREAS OR WHERE DIRECTED BY THE ENGINEER.

SURVEYOR	0	DA	A ISSUE	07/07/21				C.K. ENGINEERING SERVICES	CLIENT:	DRAWING TITLE:	DRAWN:	M.P.	SIGNED:	DATE: JULY 2	2021
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ARCHITECT								49 FLORA ST			DESIGNED:	C.K.			
SQUILLACE								ROSELANDS, NSW 2196	PROJECT:		CHECKED:	C.K.		DATUM: AHD	ا د
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