

NO.

ACTION PLANS

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DEVELOPMENT APPLICATION

DRAWING NAME

These plans are for Complying Development Certificate Approval only.

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Clifford Avenue, FAIRLIGHT

Property Address Unit Western, Upper

hstar.com.au/QR/Generate?p=JMDuvbDmU

NSW,2094



48 Upper Clifford Ave Fairlight NSW 2094



ITEM DETAILS		DEVELO	DEVELOPMENT APPLICATION						
ADDRESS		48 Upper	48 Upper Clifford Ave Fairlight NSW 2094						
LOT & DP/SP		LOT 23 S	LOT 23 SEC. I DP 3212						
COUNCIL		NORTHE	RN BEACHS COUN	CIL (MANLY)					
SITE AREA		566.6m²							
FRONTAGE		14.085m							
CONTROLS	PERMISSIBLE / REQUIRED	EXISTING	PROPOSED PARENT LOT	PROPOSED WESTERN LOT	PROPOSED EASTERN LOT	COMPLIANCE			
	m / m² / %	m / m² / %	m / m² / %	m / m² / %	m / m² / %				
<u>LEP</u>									
LAND ZONING	R1 – GENERAL RESIDENTIAL	R1	UNCHANGED	UNCHANGED	UNCHANGED	YES			
MINIMUM LOT SIZE	450m²	566.6m²	566.6m ²	283.35m²	283.35m²	YES			
FLOOR SPACE RATIO	0:65 : 1 (368.29m²)	278.59m²	64.92% (367.86m²)	0.33 : 1 (183.93m²)	0.33 : 1 (183.93m ²)	YES			
MAXIMUM BUILDING HEIGHT	9.5m	8.899m	N/A	8.2m	7.8m	YES			
DCP									
RESIDENTIAL OPEN SPACE	AREA OS3								
TOTAL OPEN SPACE (TOS)	55% (311.63m²)	46.35% (262.66m²)	32.67% (185.14m²)	92.23m²	92.91m²	YES			
OPEN SPACE ABOVE GROUND	MAX. 40% OF TOS (55%) : 124.652m ²	4.52% 14.11m²	40% (124.652m²)	62.326m²	62.326m²	YES			
COMBINED TOS & TOS ABOVE		48.84% (276.77m²)	54.67% (309.792m²)	54.54% (154.556m²)	54.78% (155.236m²)	-			
LANDSCAPE AREA	35% OF TOS (55%) : 109.07m ²	40.15% (125.15m²)	71.54% (132.46m²)	42.71% (66.57m²)	42.28% (65.89m²)	YES			
PRINCIPAL PRIVATE OPEN SPACE	18m²	-	85.06m2	42.53m²	42.53m²	YES			
FRONT SETBACK	AVERAGE FRONT SETBACK	8.437m	-	4.392m	4.426m	YES			
REAR SETBACK	8.0m	8.989m		12.062m	12.062m	YES			
SIDE SETBACKS	1/3 WALL HEIGHT	E: 1.04m W:1.125m	-	1.161m	1.161m	YES			
CAR PARKING SPACES	Required: 1	1	T -	2	2	YES			

EASTERN LOT AREA: 283.35M²

GFA - 0.65:1 (184.1775M²)
GARAGE LEVEL: 11.19M²
GROUND FLOOR: 110.05M²
FIRST FLOOR: 62.69M²
TOTAL PROPOSED GFA: 183.83M²

TOTAL OPEN SPACE 55% (155.84M²)
PROPOSED TOS: (92.91M²)
TOS ABOVE GROUND: (62.326M²)
TOTAL OPEN SPACE: 54.78%(155.236M²)
TOS LESS THAN 3m (26.97M²)
TOS INCLUDING AREA

LANDSCAPE AREA 35% OF T.O.S (54.54M²)
PROPOSED: 42.28% (65.89M²)

64.3%(182.206M²)

LESS THAN 3m

WESTERN LOT A AREA: 283.35M² GFA - 0.65:1 (184.1775M²) GARAGE LEVEL: 11.19M² GROUND FLOOR: 110.05M² FIRST FLOOR: 62.69M² TOTAL PROPOSED GFA: 183.83M² TOTAL OPEN SPACE 55% (155.84M²) PROPOSED TOS: (92.23M²)TOS ABOVE GROUND: $(62.326M^2)$ 54.54%(154.556M²) TOTAL OPEN SPACE: TOS LESS THAN 3m (26.90M²) TOS INCLUDING AREA LESS THAN 3m 64.03%(181.456M²) LANDSCAPE AREA 35% OF T.O.S (54.54M²)

42.71% (66.57M²)

PROPOSED:

IMPORTANT NOTATION FOR BUILDERS

- All dimensions are to be confirmed on-site by the builder/subcontractor, any incongruencies must be reported to the Designer in writing before the commencement of any work.

- No Survey has been made on the boundaries. All bearings, distances, and areas have been taken from the contour survey plan. A Survey must be carried out to confirm the exact boundary locations.

- No construction work shall commence until a site survey confirming the site boundaries has been completed. The contractor is to ensure that the approved boundary setbacks are confirmed and used, the boundary setbacks take precedence over all other dimensions. The Survey work must be performed by a registered Surveyor.

In the event of encountering any discrepancies on these drawings, specification, or subsequent instructions issued, the Builder/Subcontractor shall contact the designer in writing before proceeding further with any work.

The builder/subcontractor is responsible to ensure that all materials installed on-site are fit for purpose and comply with

the NCC and relevant Australian Standards. The builder is to obtain written confirmation of material selection by the Client prior to ordering.

- All construction, control joints, and expansion joints in the walls, floors, and other locations shall be in strict accordance with the structural engineering details. No joints or breaks other than specified are allowed without written

permission from the Engineer - Measurements for the fabrication of secondary components such as windows, doors, internal frames, structural steel components, and the like, are not to be taken from these documents. Measurements must be taken on-site to suit the

- All structural components shall be in strict accordance with details and specifications as prepared by a suitably

qualified structural engineer

- All existing structures need to be examined for structural adequacy, and it is the Contractor's responsibility to ensure that a certificate of structural adequacy is available prior to the start of any work

SPECIFICATION

- "Approval" - obtained by either an 'Accredited Certifying Authority' or 'Local Council'.

The Owner will directly pay all fees associated with the following: -

Building approval from council or accredited certifier, any footpath and kerb deposits with the local council, insurance fees to Building Services Corporation, Long Service Leave levy fees and approval fees by water and sewerage authority. All other fees are to be paid by the builder. The amount of any local authority deposits which are forfeited due to damage or other causes, will be deducted from payments due to the builder.

-The Builder is to provide at his/her own expense adequate Public Risk Insurance and arrange indemnification under

the Workers Compensation Act. Works insurance to be as stated in the contract conditions - All tenderers are to visit the site to satisfy themselves as to the nature and extent of the Works, facilities available and difficulties entailed in the works as Variations will not be allowed due to work arising owing to neglect of this clause.

- These drawings shall be read in conjunction with all structural and other consultant's drawings and specifications and with any such written instructions as may be issued during the course of the contract. Set out dimensions shown on this drawing shall be verified by the builder on site before commencement of any work.

Dimensions shall not be obtained by scaling the drawings, use figured dimensions. All dimensions are in millimetres. - The Builder is to ensure all construction, levels and other items comply with the conditions of the Building Approval. - Any detailing additional to that which is supplied shall be resolved between the Owner and the Builder, to the Owner's

approval. Except for any structural details or design, which is to be supplied by the Engineer - All work to be carried out in a tradesman like manner and in accordance with the standards, codes and regulations of Standards Australia, the National Construction Code and any statutory authority having jurisdiction over the works. - All structural work is to be in accordance with the structural details prepared by a suitably qualified structural engineer,

including but not limited to all piers, footings, concrete slabs, retaining walls, steelworks, formwork, underpinning, additional structural loads, timber framing, wind bracing and associated connections. Builder to obtain prior to finalising the tender, unless previously obtained by owners.

- All brickwork is to be selected by the Owner, and is to comply with AS 1640

- All masonry is to comply with AS 3700.

- Provide all metalwork and flashings necessary to satisfactorily complete the works.

- All timber construction to be in accordance with AS 1684 - Residential timber-framed construction. Level and grade where necessary under timber floors to provide a minimum clearance of 300mm under bearers or 400mm under inists Adequate precautions shall be taken to ensure that the surface and/or seepage water does not collect or remain under

- Sustainable timbers, and not rainforest or old growth timber will be used. Recycled timber or second hand timbers are

to be sourced and used in preference to plantation timbers, if available and suitable.

- All glazing installation is to comply with AS 1288, AS 2047 and in accordance with manufacturers recommendations - All wall and ceiling linings in wet areas to be plasterboard and villaboard, or equal. A breathable wall wrap is to be provided to all external walls. Timber cladding is to be battened out from timber frame to provide an 'air' gap to prevent condensation. Workmanship is to comply with the relevant Australian Standards or installed in accordance with

manufacturer's specifications. All bathrooms and wet areas to be waterproofed with a flexible membrane to manufacturer's specifications and to AS 3740, Part H4D2 and Section 10; Part 10.2 of the 2022 NCC. - All Architraves and skirtings to the profile as selected by owner, and painted or stain finish as selected.

- All plumbing and drainage work to be installed and completed by a licensed tradesman and in accordance with the statutory body having authority over the works. Connect all waste to Sydney Water sewer line - Connect all stormwater to existing system or street drainage system in accordance with AS 3500, Part H2D2 and

Section 3: Part 3.3 of the 2022 NCC - Smoke detector alarms are to be installed in accordance with AS 3786, Part H3D6 and Section 9; Part 9.5 of the 2022

- If a member which provides structural support to the works is subject to termite attack, management measures are to

comply with AS 3660 and Section 3; Part 3.4 of the 2022 NCC. Termite management system to be installed to manufacturer's specifications. - Stairs and Balustrades to comply with Part H5D2, H5D3 and Section 11; Part 11.2 and 11.3 of the 2022 NCC. Provide a handrail along the full length of the flight and a slip resistant finish to the edge of the nosings to comply with 3.9.1 and 3.9.2 of the NCC. No horizontal elements to facilitate climbing between 150mm and 760mm where floor to level below

is more than 4m. - Electrical works to be in accordance with SAA wiring rules and be done by a licenced tradesperson. Obtain electrical layout prior to proceeding. All electrical power (GPO's) and light outlets to be determined by the Owner. - Painting: All paints or other coatings shall be of the best quality materials & of approved manufacture. All priming

materials shall be of an approved brand acceptable to the manufacturer of the finishing coats to be used. External ioinery intended to be painted shall be primed on all faces at the place of assembly. Where new work or alteration work adjoins existing painted surfaces allow for repainting existing surfaces to provide uniform appearance. - ZERO-VOC or LOW-VOC paints and primers only are to be used.

- Any work indicated on the plans but not specified and any item not shown on the plans which is obviously necessary as part of proper construction and/or finish, is to be considered as shown and specified and is to be undertaken as part of the contract. Variations will not be permitted without prior written approval by the owners

- The Builder shall provide sediment and siltration control measures as required by Council, and maintain them throughout the duration of the works.

- A legible copy of the plans bearing approval stamps, must be maintained on the job site at all times. Hours of construction shall be restricted to the times as required by the building approval.

- The Builder is to arrange for all inspections required by the relevant authorities and/or lending institutions, to their

- The Builder is to obtain approval for interruptions to existing services and minimise the duration and number of interruptions. Any interruptions to existing services and equipment is to be undertaken by appropriately qualified

- The Builder shall restore, reinstate or replace any damage to existing structures or landscaping caused by the construction works or workmen

Provide protection to existing trees to remain, or as required by the Approval Conditions.

GENERAL NOTATION

- Approved means by the 'relevant local authority' or council?

- All work and materials to comply with the current Australian standards at the time of commencement, where

- The builder is to comply with all ordinances, local authority regulations and the requirements of all services supply

authorities having jurisdiction over the works. - All new downpipes are to be connected to the existing stormwater system.

- All timber sizes and concrete details to be confirmed by the builder prior to commencement of any work. - All autters, downpipes to be colorbond.

- All wall and ceiling linings to be plasterboard or cement render as selected, and villa board in wet areas. To comply with relevant Australian standards, and installed in accordance with manufacturers specification

NCC 2022 & AS COMPLIANCES SPECIFICATIONS

- Structure - Part H1 & Section 2 of NCC

Structural Provisions - PART H1D2 & PART 2.2 of NCC

- Site Preparation - Part H1D3 & Section 3 of NCC

- Earthworks - Part 3.2 of NCC

Drainage - Part 3.3 of NCC

- Termite Risk Management - Part 3.4 of NCC

- Footings & Slabs - Part H1D4 & Section 4 of NCC - Footings, Slabs & Associated Elements - Part 4.2 of NCC

- Masonry - Part H1D5 & Section 5 of NCC - Masonry Veneer - Part 5.2 of NCC - Cavity Masonry - Part 5.3 of NCC - Unreinforced Single Leaf Masonry - Part 5.4 of NCC

- Isolated Piers - Part 5.5 of NCC - Masonry Components & Accessories - Part 5.6 of NCC

- Waetherproofing of Masonry - Part 5.7 of NCC

- Framing - Part H1D6 & Section 6 of NCC - Sub Floor Ventilation - Part 6.2 of NCC

- Structural Steel Members - Part 6.3 of NCC - Roof & Wall Cladding - Part H1D7 & Section 7 of NCC

- Sheet Roofing - Part 7.2 of NCC

- Roof Tiles & Shingles - Part 7.3 of NCC - Gutters & Downpipes - Part 7.4 of NCC

- Timber & Composite Wall Cladding - Part 7.5 of NCC

- Glazing - Part H1D8 & Section 8 of NCC

- Windows & External Glazed Doors - Part 8.2 of NCC

- Glass - Part 8.3 of NCC Glazing Human Impact - Part 8.4 of NCC

- Damp & Weatherproofing - Part H2 of NCC

- Fire Safety - Part H3 & Section 9 of NCC

- Fire Separation of External Walls - Part 9.2 of NCC

- Fire Protection of Separating Walls & Floors - Part 9.3 of NCC - Fire Protection of Garage Top Dwellings - Part 9.4 of NCC

- Smoke Alarms & Evacuation Lighting - Part 9.5 of NCC

- Health & Amenity - Part H4 & Section 10 of NCC - Wet Area Waterproofing - Part 10.2 of NCC

- Room Heights - Part 10.3 of NCC - Facilities - Part 10.4 of NCC

- Light - Part 10.5 of NCC

- Ventilation - Part 10.6 of NCC - Sound Insulation - Part 10.7 of NCC

Condensation Management - Part 10.8 of NCC

- Safe Movement & Access - Part H5 & Section 11 of NCC

- Stairway & Ramp Construction - Part 11.2 of NCC - Barriers & Handrails - Part 11.3 of NCC

- Ancillary Provisions - Part H7 & Section 12 of NCC - Construction in Alpine Areas - Part 12.2 of NCC

Attachment of Framed Decks & Balconies to External Walls of Buildings Using a Waling Plate - Part 12.3 of NCC Heating Appliances, Fireplaces, Chimneys & Flues - Part 12.4 of NCC

- Swimming Pools - Part H7P1 & NSW H7D2 of NCC

- Construction in Bushfire Prone Areas - Part NSW H7D4 of NCC

- Energy Efficiency - Part H6 & Section 13 of NCC

- Building Fabric - Part 13.2 of NCC

- External Glazing - Part 13.3 of NCC

- Building Sealing - Part 13.4 of NCC - Ceiling Fans - Part 13.5 of NCC

- Whole of Home Energy Usage - Part 13.6 of NCC - Services - Part 13.7 of NCC

- Pool Fencing & other provisions - Regulations, & AS 1926 - Demolition Works to comply with AS $\check{\mathbf{2}}\mathbf{601}\text{-}\mathbf{2001}$ The Demolition of Structures.

- Waterproofing of Wet Areas to comply with AS 3740:2021 - All plumbing & drainage work to comply with AS 3500:2021

All plasterboard work to comply with AS 2588:2018

- All structural steel work to comply with AS 4100:2020 & AS 1554.1:2014 - All concrete work to comply with AS 3600:2018

- All roof sheeting work to comply with AS 1562.1:2018

- All skylights to comply with AS 4285:2019 - All ceramic tiling to comply with AS 3958.1-2007 & 3958.2-1992

- All glazing assemblies to comply with AS 2047-2014 & AS 1288:2021

- All timber retaining walls to comply with AS 1720, AS 1170

- All retaining walls to comply with AS 3700:2018 & AS 3600:2018 - All construction in bushfire-prone areas to comply with AS 3959:2018

THIS SET OF DRAWING SHOULD BE READ & KEPT IN ITS ENTIRETY. NO INDIVIDUAL PAGE SHOULD BE SEPARATED FROM THE REST OF THE SET. EACH NOTATION LISTED ON THIS PAGE APPLY TO ALL PAGES OF THIS SET.

SAFTEY NOTES

THESE NOTES MUST BE READ AND UNDERSTOOD BY ALL INVOLVED IN THE PROJECT. THIS INCLUDES (but is not excluded to): OWNER, BUILDER, SUB-CONTRACTORS, CONSULTANTS. RENOVATORS, OPERATORS, MAINTENORS, DEMOLISHERS.

1. FALLS, SLIPS, TRIPS

a) WORKING AT HEIGHTS

DURING CONSTRUCTION

Wherever possible, components for this building should be prefabricated off-site or at ground level to minimise the risk of workers falling more than two metres. However, construction of this building will require workers to be working at heights where a fall in excess of two metres is possible and injury is likely to result from such a fall. The builder should provide a suitable barrier wherever a person is required to work in a situation where falling more than two metres is a

DURING OPERATION OR MAINTENANCE

For houses or other low-rise buildings where scaffolding is appropriate: Cleaning and maintenance of windows, walls, roof or other components of this building will require persons to be situated where a fall from a height in excess of two metres is possible. Where this type of activity is required, scaffolding, ladders or trestles should be used in accordance with relevant codes of practice, regulations or legislation. For buildings where scaffold, ladders, trestles are not appropriate: Cleaning and maintenance of windows, walls, roof or other components of this building will require persons to be situated where a fall from a height in excess of two metres is possible. Where this type of activity is required, scaffolding, fall barriers or Personal Protective Equipment (PPE) should be used in accordance with relevant codes of practice, regulations or legislation.

b) SLIPPERY OR UNEVEN SURFACES

FLOOR FINISHES Specified

If finishes have been specified by designer, these have been selected to minimise the risk of floors and paved areas becoming slippery when wet or when walked on with wet shoes/ feet. Any changes to the specified finish should be made in consultation with the designer or, if this is not practical, surfaces with an equivalent or better slip resistance should be chosen.

FLOOR FINISHES By Owner

If designer has not been involved in the selection of surface finishes. the owner is responsible for the selection of surface finishes in the pedestrian trafficable areas of this building. Surfaces should be selected in accordance with AS HB 197:1999 and AS/ NZ 4586:2004.

STEPS, LOOSE OBJECTS AND UNEVEN SURFACES

Due to design restrictions for this building, steps and/ or ramps are included in the building which may be a hazard to workers carrying objects or otherwise occupied. Steps should be clearly marked with both visual and tactile warning during construction, maintenance, demolition and at all times when the building operates as a workplace. Building owners and occupiers should monitor the pedestrian access ways and in particular access to areas where maintenance is routinely carried out to ensure that surfaces have not moved or cracked so that they become uneven and present a trip hazard. Spills, loose material, stray objects or any other matter that may cause a slip or trip hazard should be cleaned or removed from access ways. Contractors should be required to maintain a tidy work site during construction, maintenance or demolition to reduce the risk of trips and falls in the workplace. Materials for construction or maintenance should be stored in designated areas away from access ways and work areas.

2. FALLING OBJECTS

LOOSE MATERIALS OR SMALL OBJECTS

Construction, maintenance or demolition work on or around this building is likely to involve persons working above ground level or above floor levels. Where this occurs one or more of the following measures should be token to ovoid objects falling from the area where the work is being carried out onto persons below. 1. Prevent or restrict access to areas below where the work is

being carried out

2. Provide toeboards to scaffolding or work platforms.

3. Provide protective structure below the work area. 4. Ensure that all persons below the work area have Personal

Protective Equipment (PPE).

BUILDING COMPONENTS During construction, renovation or demolition of this building, parts of the structure including fabricated steelwork, heavy panels and many other components will remain standing prior to or after supporting parts are in place. Contractors should ensure that temporary bracing or other required support is in place at all times when collapse which may injure persons in the area is a possibility. Mechanical lifting of materials and components during construction, maintenance or demolition presents a risk of falling objects. Contractors should ensure that appropriate lifting devices are used, that loads are properly secured and that access to areas below the load is prevented or restricted.

3. TRAFFIC MANAGEMENT

For building on a major road, narrow road or steeply sloping road: Parking of vehicles or loading/ unloading of vehicles on this roadway may cause a traffic hazard. During construction, maintenance or demolition of this building designated parking for workers and loading areas should be provided. Trained traffic management personnel should be responsible for the supervision of these areas. For building where on-site loading/ unloading is restricted: Construction of this building will require loading and unloading of materials on the roadway. Deliveries should be well planned to ovoid congestion of loading areas and trained traffic management personnel should be used to supervise loading/unloading areas. For all buildings: Busy construction and demolition sites present a risk of collision where deliveries and other traffic are moving within the site. A traffic management plan supervised by trained traffic management personnel should be adopted for the work site.

4. SERVICES

Rupture of services during excavation or other activity creates a variety of risks including release of hazardous material. Existing services are located on or around this site. Where known, these ore identified on the plans but the excel location and extent of services may vary from that indicated. Services should be located using on appropriate service (such as Dial Before You Dig), appropriate excavation practice should be used and, where necessary, specialist contractors should be used. Locations with underground powers Underground power lines MAY be located in or around this site. All underground power lines must be disconnected or carefully located and adequate warning signs used prior to any construction, maintenance or demolition commencing. Locations with overhead power lines: Overhead power lines MAY be near or on this site. These pose a risk of electrocution if struck or approached by lifting devices or other plant and persons working above ground level. Where there is a danger of this occurring, power lines should be, where practical, disconnected or relocated. Where this is not practical adequate warning in the form of bright coloured tape or signage should be used or a protective barrier provided.

5. MANUAL TASKS

Components within this design with a moss in excess of 25kg should be lifted by two or more workers or by mechanical lifting device. Where this is not practical, suppliers or fabricators should be required to limit the component mass. All material packaging, building and maintenance components should clearly show the total moss of packages and where practical all items should be stored on site in a way which minimises bending before lifting. Advice should be provided on safe lifting methods in all areas where lifting may occur. Construction, maintenance and demolition of this building will require the use of portable tools and equipment. These should be fully maintained in accordance with manufacturer's specifications and not used where faulty or (in the case of electrical equipment) not carrying a current electrical safety tag. All safety quards or devices should be regularly checked and Personal Protective Equipment should be used in accordance with manufacturer's specification.

6. HAZARDOUS SUBSTANCES

ASBESTOS

For alterations to a building constructed prior to 1990:

If this existing building was constructed prior to: 1990 - it therefore may contain asbestos

1986 - it therefore is likely to contain asbestos

either in cladding material or in fire retardant insulation material. In either case, the builder should check and, if necessary, take appropriate action before demolishing, culling, sanding, drilling or otherwise disturbing the existing

Many materials used in the construction of this building con cause harm if inhaled in powdered form. Persons working on or in the building during construction, operational maintenance or demolition should ensure good ventilation and wear Personal Protective Equipment including protection against inhalation while using powdered material or when sanding, drilling, cutting or otherwise disturbing or creating powdered material.

TREATED TIMBER The design of this building may include provision for the inclusion of treated limber within the structure. Dust or fumes

or demolition should ensure good ventilation and wear Personal Protective Equipment including protection against inhalation of harmful material when sanding, drilling, cutting or using treated timber in any way that may cause harmful material lo be released. Do not burn treated timbe **VOLATILE ORGANIC COMPOUNDS**

from this material can be harmful. Persons working on or in the building during construction, operational maintenance

Many types of glue, solvents, spray packs, paints, varnishes and some cleaning materials and disinfectants have dangerous emissions. Areas where these are used should be kept well ventilated while the material is being used and for a period after installation. Personal Protective Equipment may also be required. The manufacturer's recommendations for use must be carefully considered at all times.

SYNTHETIC MINERAL FIBRE

Fibreglass, rockwool, ceramic and other material used for thermal or sound insulation may contain synthetic mineral fibre which may be harmful if inhaled or if it comes in contact with the skin, eyes or other sensitive parts or the body. Personal Protective Equipment including protection against inhalation of harmful material should be used when installing, removing or working near bulk insulation material.

TIMBER FLOORS

This building may contain timber floors which have an applied finish. Areas where finishes are applied should be kept well ventilated during sanding and application and for a period after installation. Personal Protective Equipment may also be required. The manufacturer's recommendations for use must be carefully considered at all times.

7. CONFINED SPACES

EXCAVATION

Construction of this building and some maintenance on the building will require excavation and installation of items within excavations. Where practical, installation should be carried out using methods which do not require workers to enter the excavation. Where this is not practical, adequate support for the excavated area should be provided to prevent collapse. Warning signs and barriers to prevent accidental or unauthorised access to all excavations should be

ENCLOSED SPACES

For buildings with enclosed spaces where maintenance or other access may be required: Enclosed spaces within this building may present a risk to persons entering for construction, maintenance or any other purpose. The design documentation calls for warning signs and

For buildings with small spaces where maintenance or other access may be required: Some small spaces within this

building will require access by construction or maintenance workers. The design documentation calls for warning signs

parriers to unauthorised access. These should be maintained throughout the life of the building. Where workers are required to enter enclosed spaces, air testing equipment and Personal Protective Equipment should be provided.

and barriers to unauthorised access. These should be maintained throughout the life of the building. Where workers are required to enter small spaces they should be scheduled so that access is for short periods. Manual lifting and other manual activity should be restricted in small spaces.

8. PUBLIC ACCESS Public access to construction and demolition sites and lo areas under maintenance causes risk to workers and public. Warning signs and secure barriers to unauthorised access should be provided. Where electrical installations

9. OPERATIONAL USE OF BUILDING RESIDENTIAL BUILDINGS

excavations, plant or loose materials are present they should be secured when not fully supervised.


This building has been designed as a residential building. If it, at a later date, it is used or intended to be used as a workplace, the provisions of the Work Health and Safely Act 2011 or subsequent replacement Act should be applied to

NON-RESIDENTIAL BUILDINGS


For non-residential buildings where the end-use has not been identified:This building has been designed to requirements of the classification identified on the drawings. The specific, use of the building is not known at the time of the design and a further assessment of the workplace health and safety issues should be undertaken at the time of fitout for the end-user. For non-residential buildings where the end-use is known: This building has been designed for the specific use as identified on the drawings. Where a change of use occurs at a later dale a further assessment of the workplace health and safety issues should be undertaken.

10. OTHER HIGH RISK ACTIVITY

All electrical work should be carried out in accordance with Code of Practice: Managing Electrical Risks at the Workplace, AS/ NZ 3012 and all licensing requirements. All work using Plant should be carried out in accordance with Code of Practice: Managing Risks of Plant at the Workplace. All work should be carried out in accordance with Code of Practice: Managing Noise and Preventing Hearing Loss at Work. Due to the history of serious incidents it is recommended that particular care be exercised when undertaking work involving steel construction and concrete placement. All the above applies.

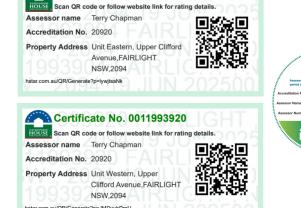


Certificate No. 0011993904

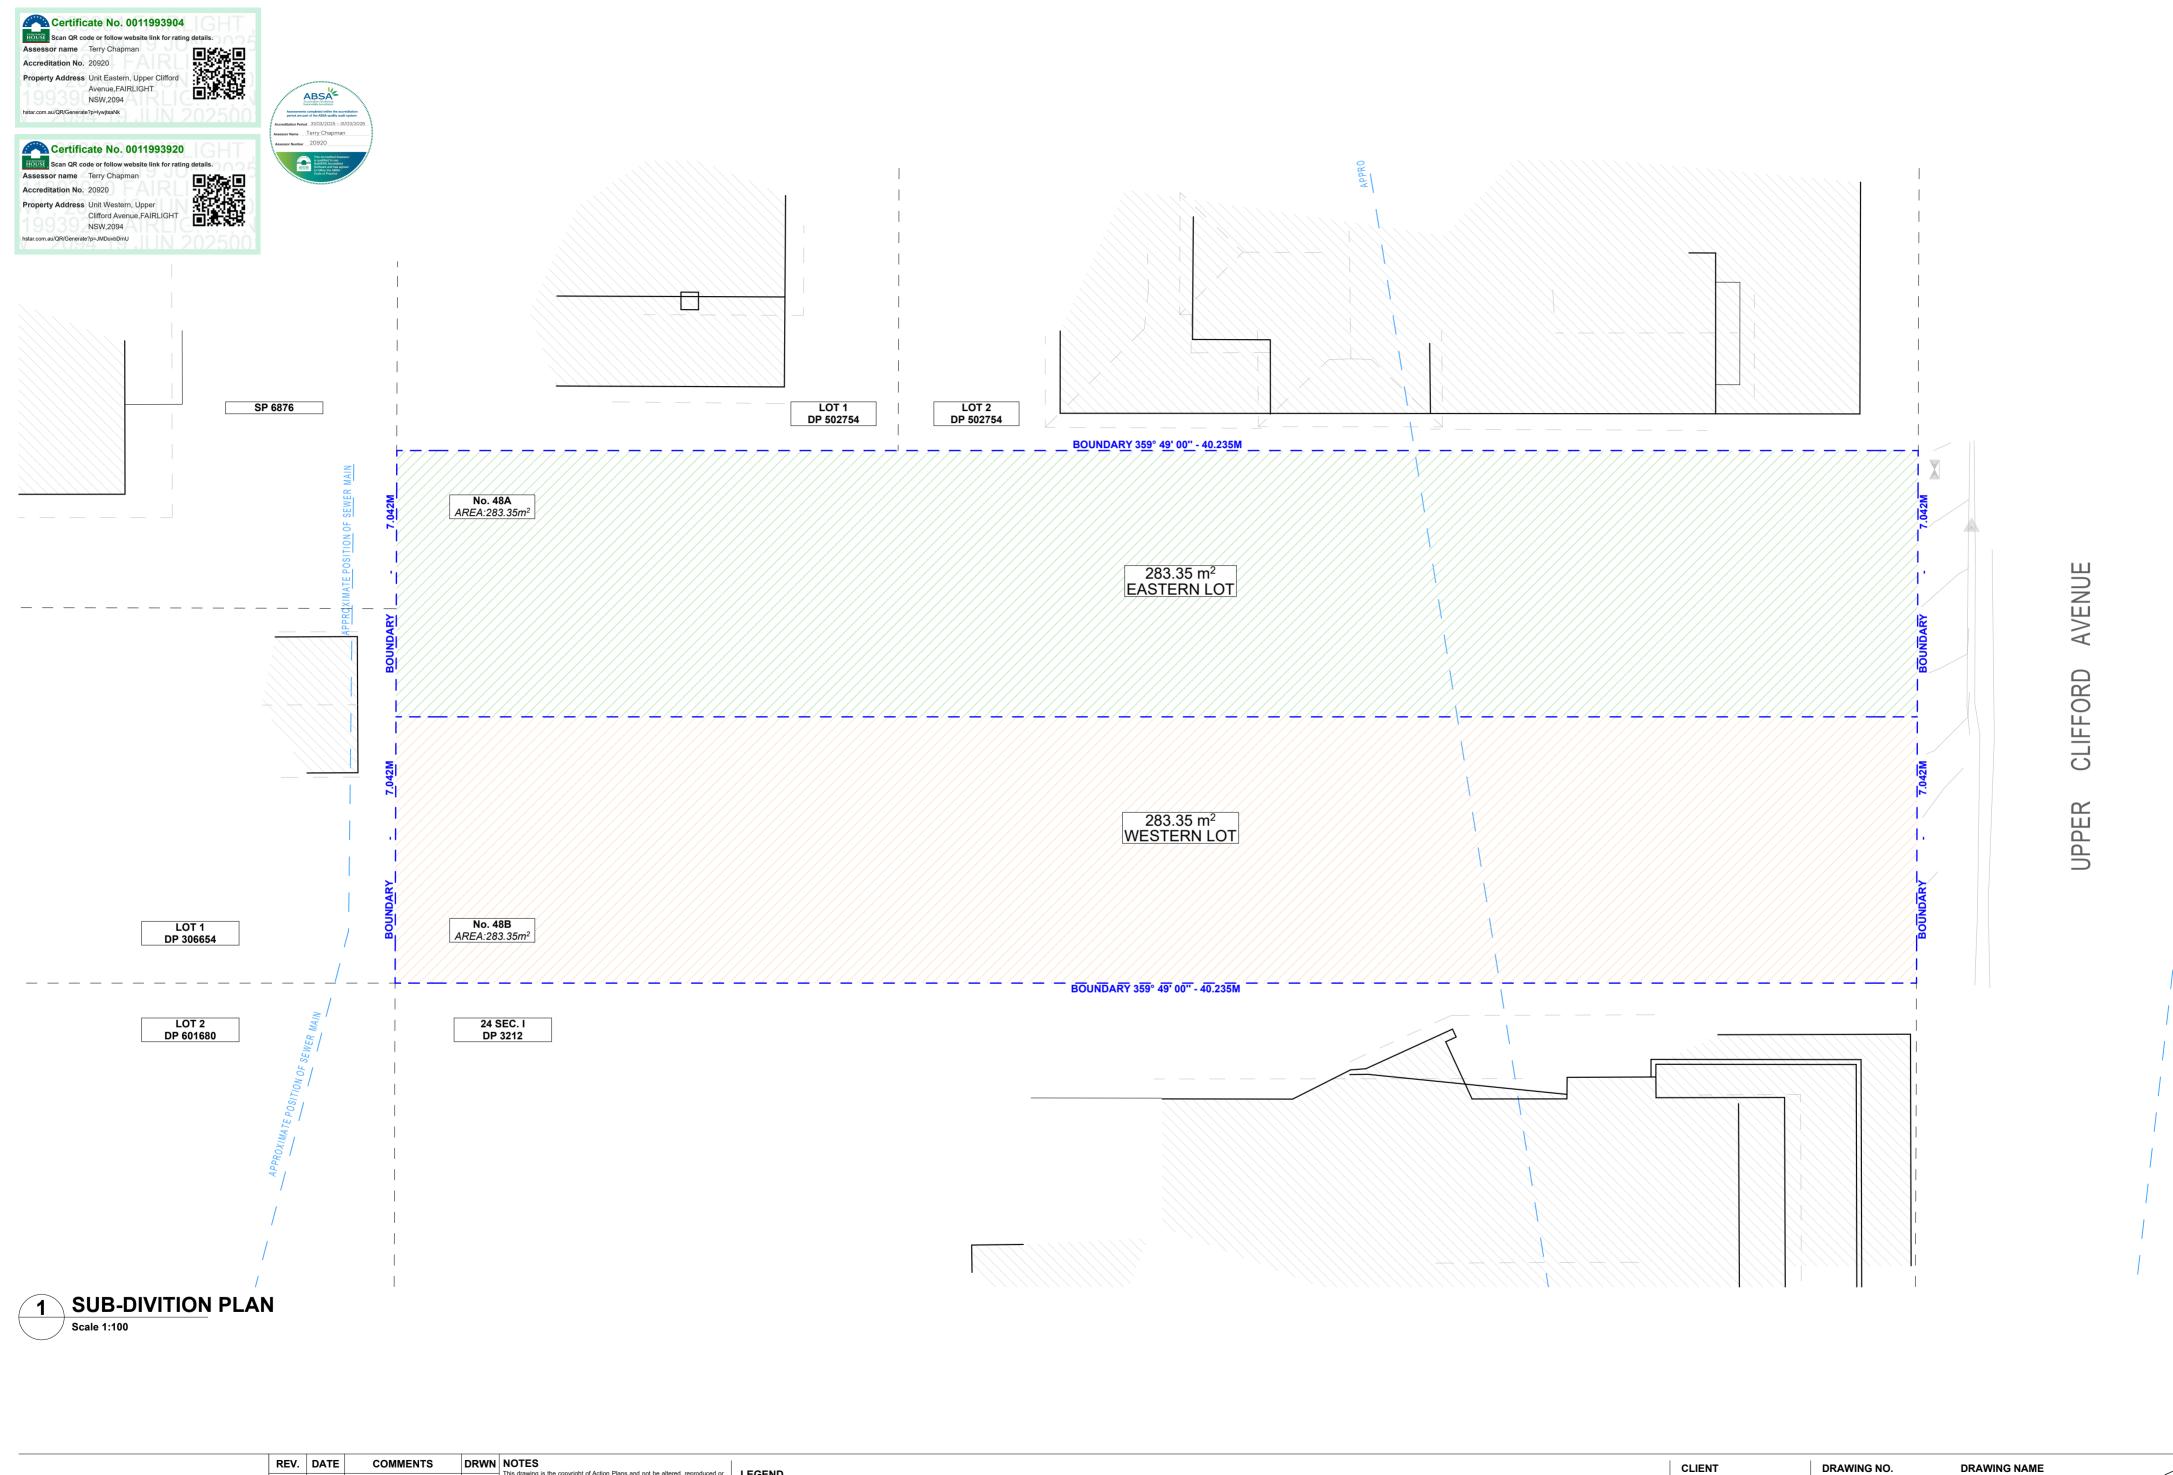



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Nicholas & April Allen

PROJECT ADDRESS
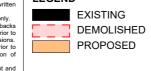
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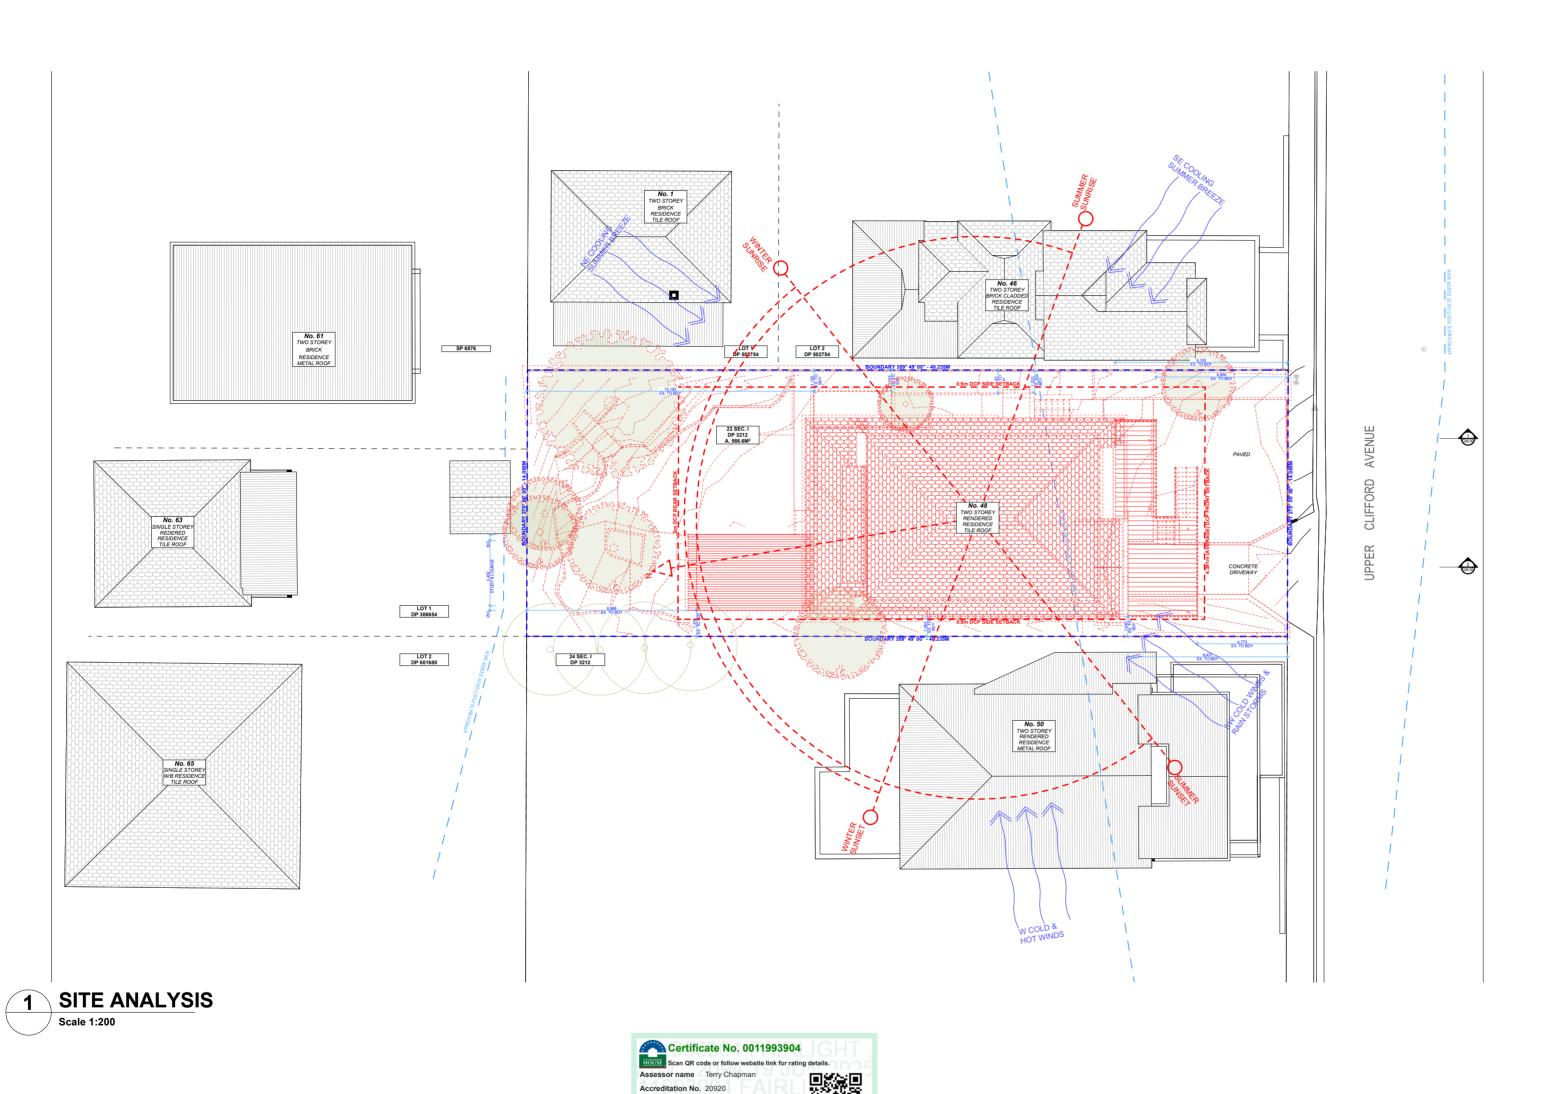
Fairlight NSW 2094

DATE Friday, 13 June 2025

DA02

DRAWING NAME
PROPOSED SUB-DIVISION
PLAN

SCALE 025 1:100 @A2









NOTE: ALL DEMOLISHED ELEMENTS TO ENG. SPECIFICATIONS AND AS. 2601 - 2001

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REV. DATE COMMENTS DRWN NOTES NOTES

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EXISTING DEMOLISHED PROPOSED

Clifford Avenue,FAIRLIGHT

Property Address Unit Eastern, Upper Clifford Avenue,FAIRLIGHT NSW,2094

Certificate No. 0011993920

hstar.com.au/QR/Generate?p=lywjtsaNk

Assessor name Terry Chapman Accreditation No. 20920 Property Address Unit Western, Upper

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NSW,2094

+EXISTING RL PROPOSED RL


CLIENT Nicholas & April Allen DRAWING NO. DA03

DRAWING NAME SITE ANALYSIS


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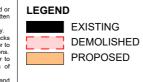
PROJECT ADDRESS DATE 48 Upper Clifford Ave Fairlight NSW 2094 Friday, 13 June 2025


SCALE



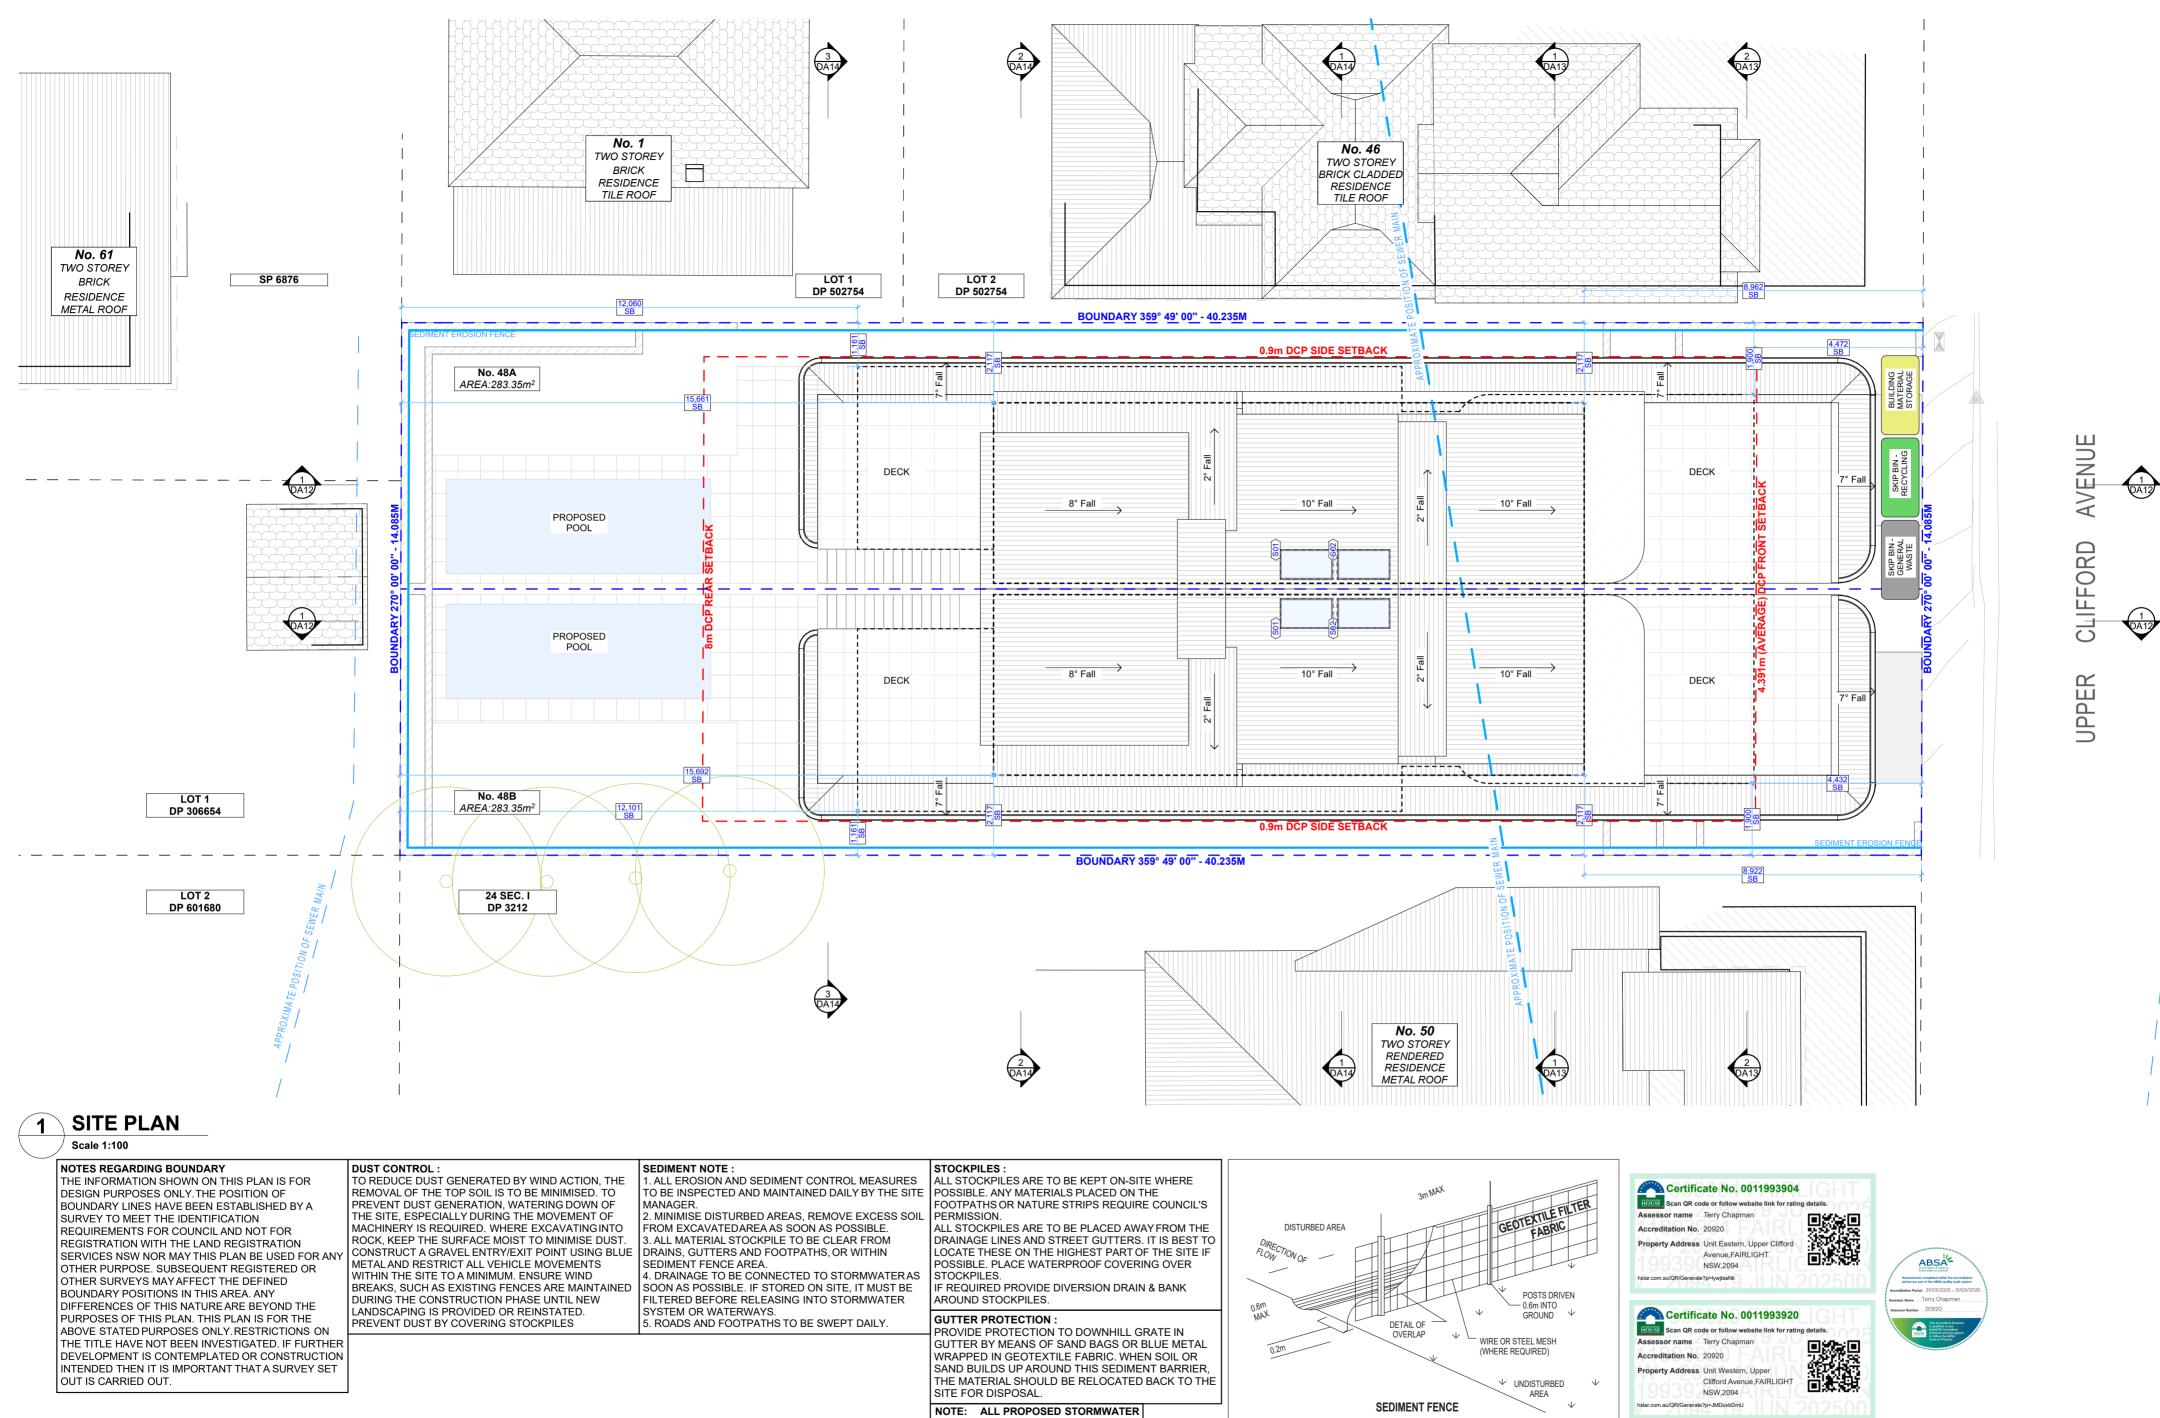



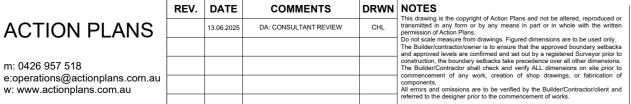

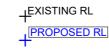

TO CONNECT WITH EXISTING

CLIENT Nicholas & April Allen

Fairlight NSW 2094

PROJECT ADDRESS 48 Upper Clifford Ave


DA04 DATE

SITE / ROOF / SEDIMENT EROSION / WASTE MANAGEMENT / STORMWATER CONCEPT PLAN SCALE




DRAWING NO. **DRAWING NAME**

Friday, 13 June 2025 1:100 @A2

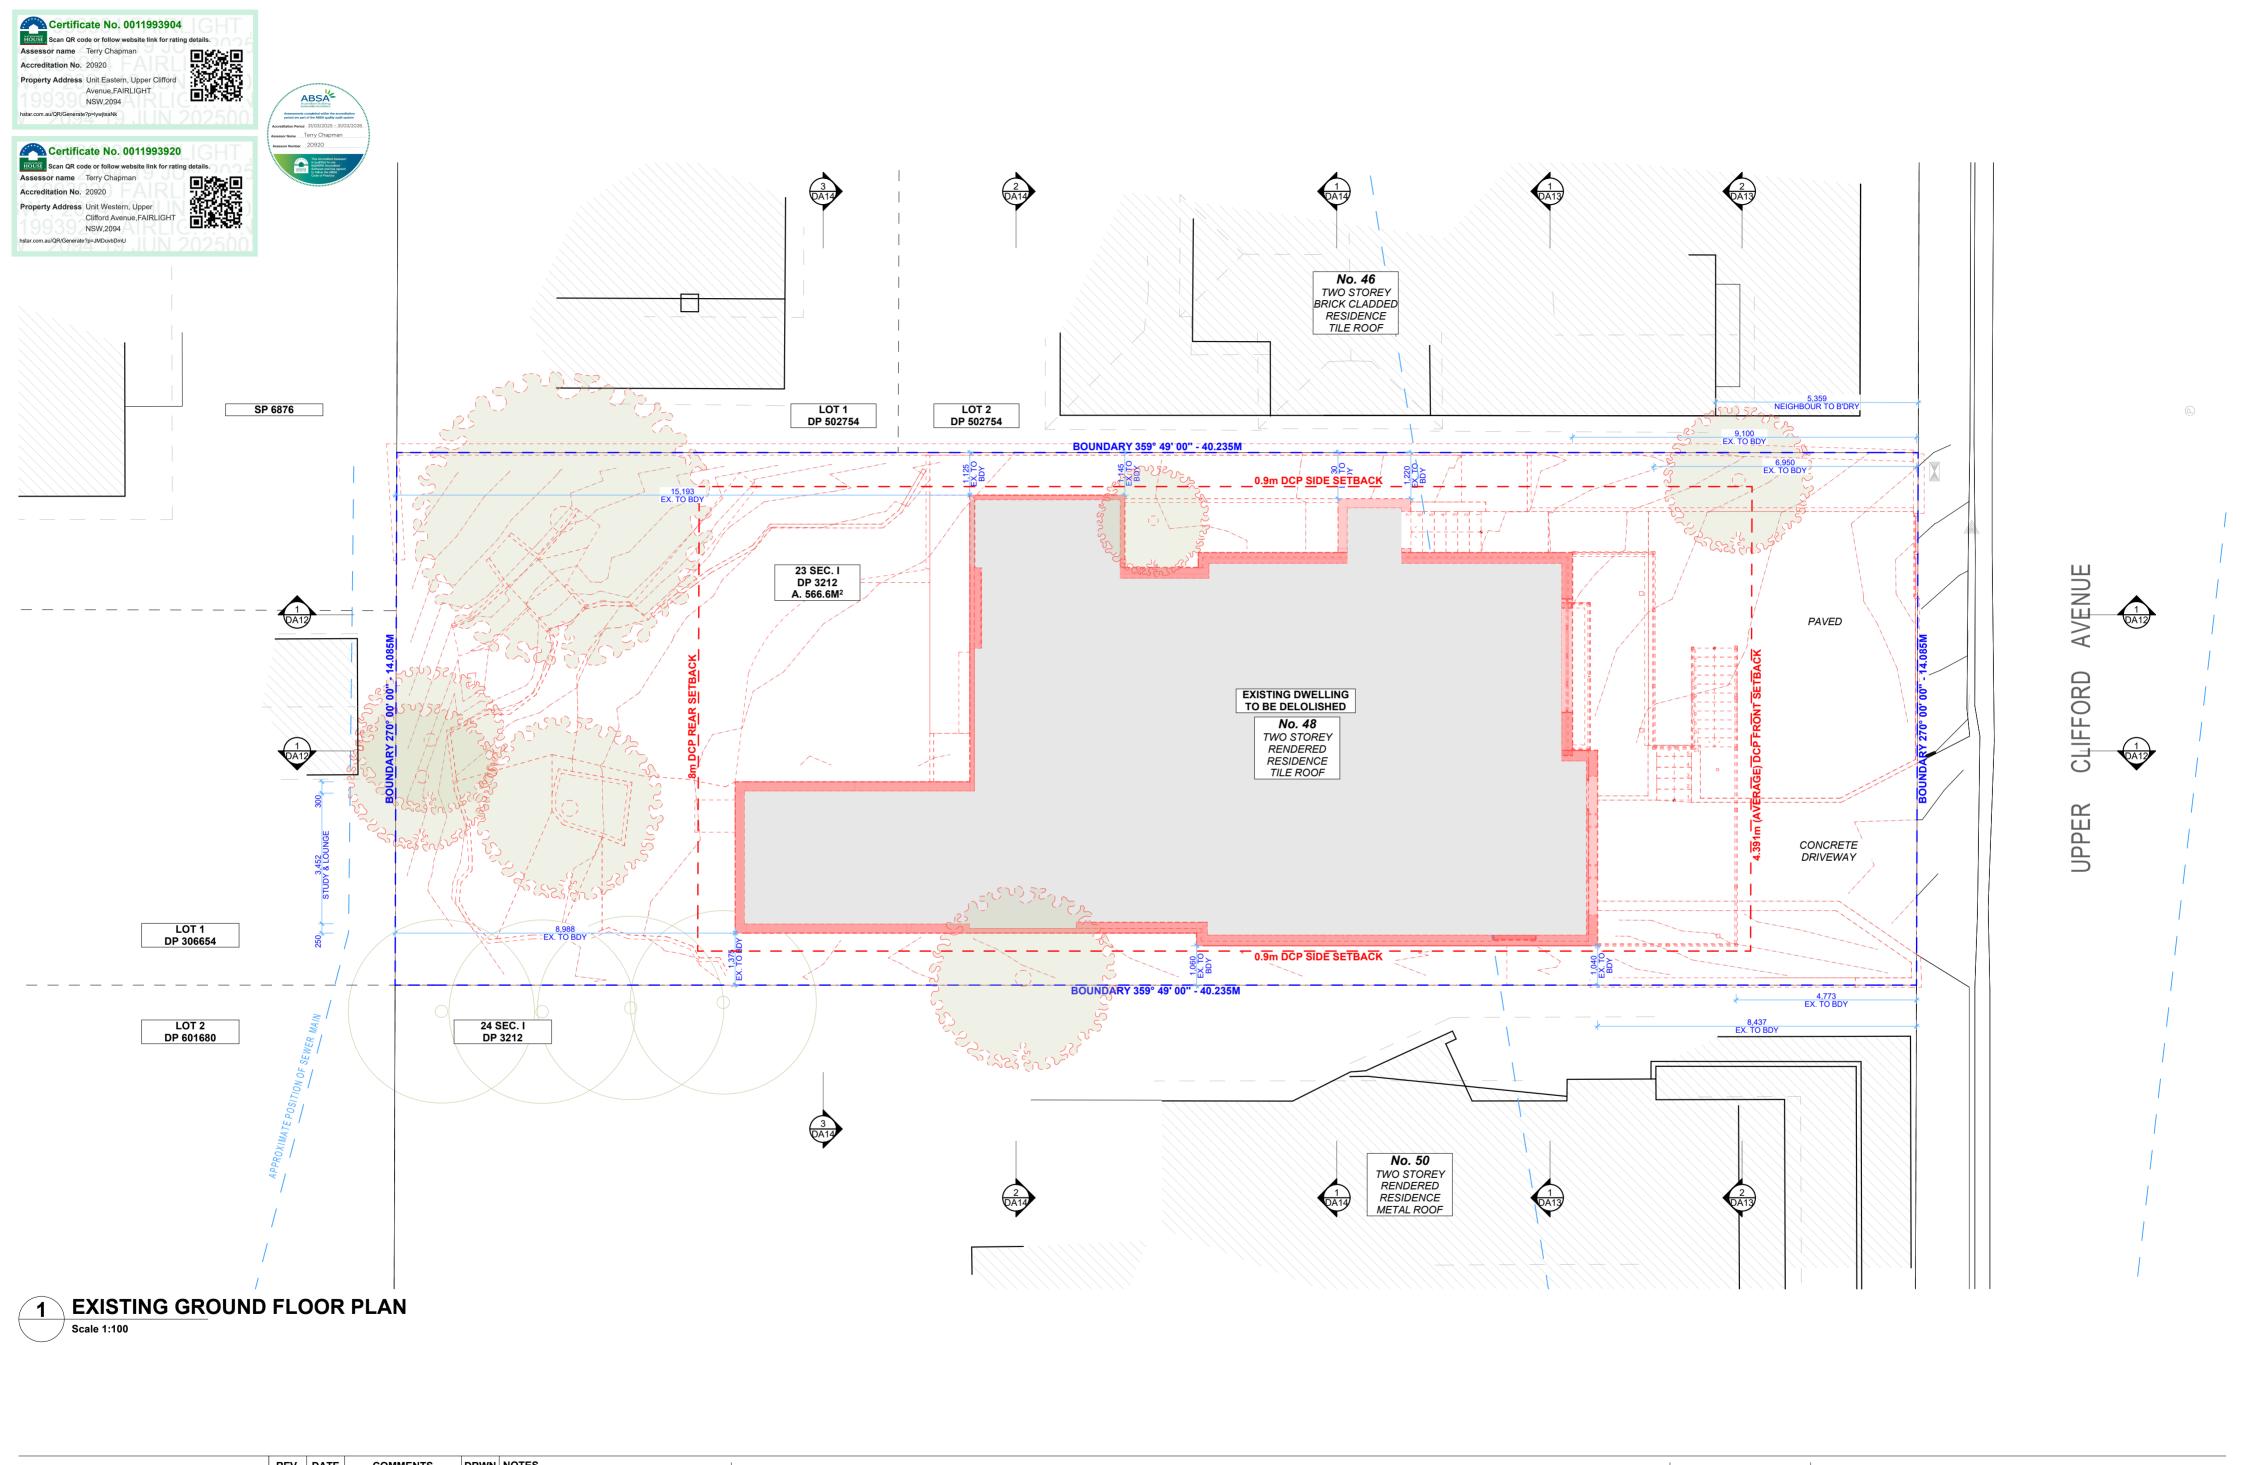

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					construction, the boundary setbacks take precedence over all other dimension The Builder/Contractor shall check and verify ALL dimensions on site prior commencement of any work, creation of shop drawings, or fabrication
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LEXISTING RL

CLIENT Nicholas & April Allen

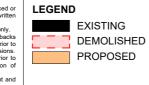DRAWING NO. **DA05**


DRAWING NAME EXISTING GROUND FLOOR PLAN

PROJECT ADDRESS DATE 48 Upper Clifford Ave Fairlight NSW 2094

Friday, 13 June 2025

SCALE 1:100 @A2



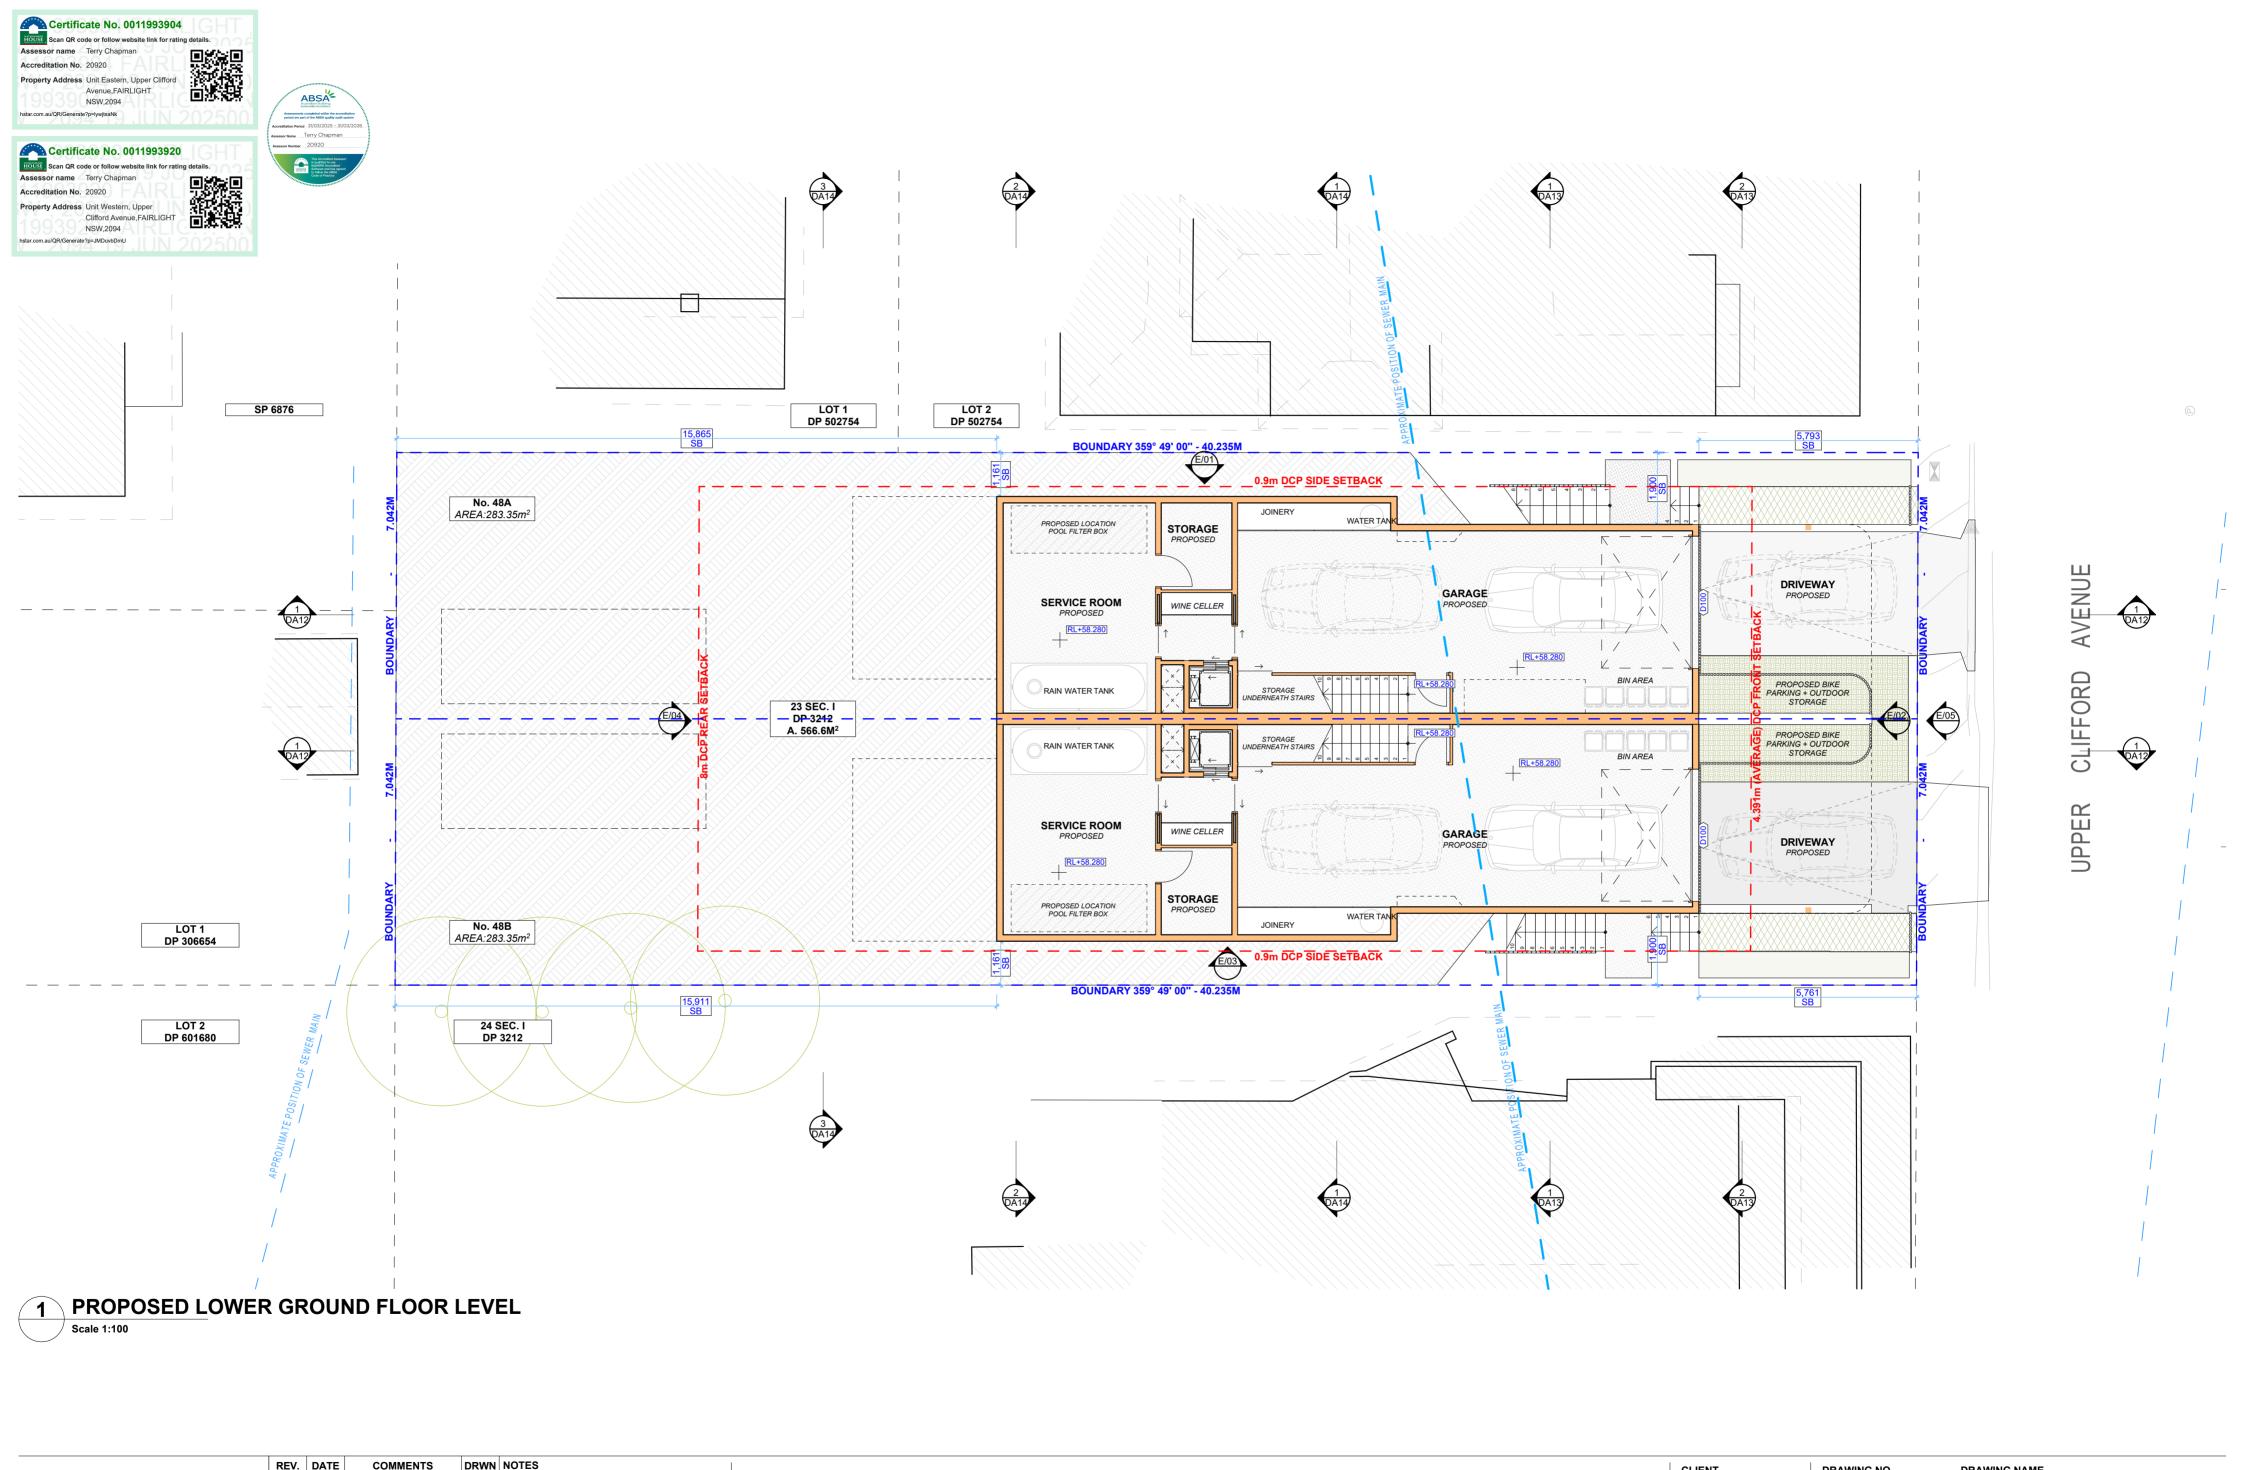



REV. DATE COMMENTS DRWN


13.06.2025 DA: CONSULTANT REVIEW

CH

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CH

DESCRIPTION OF SEASON OF

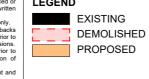

EXISTING RL

CLIENT Nicholas & April Allen DA06

DRAWING NAME
PROPOSED GARAGE FLOOR
PLAN

PROJECT ADDRESS


48 Upper Clifford Ave Fairlight NSW 2094

DATE

Friday, 13 June 2025

SCALE 1:100 @A2



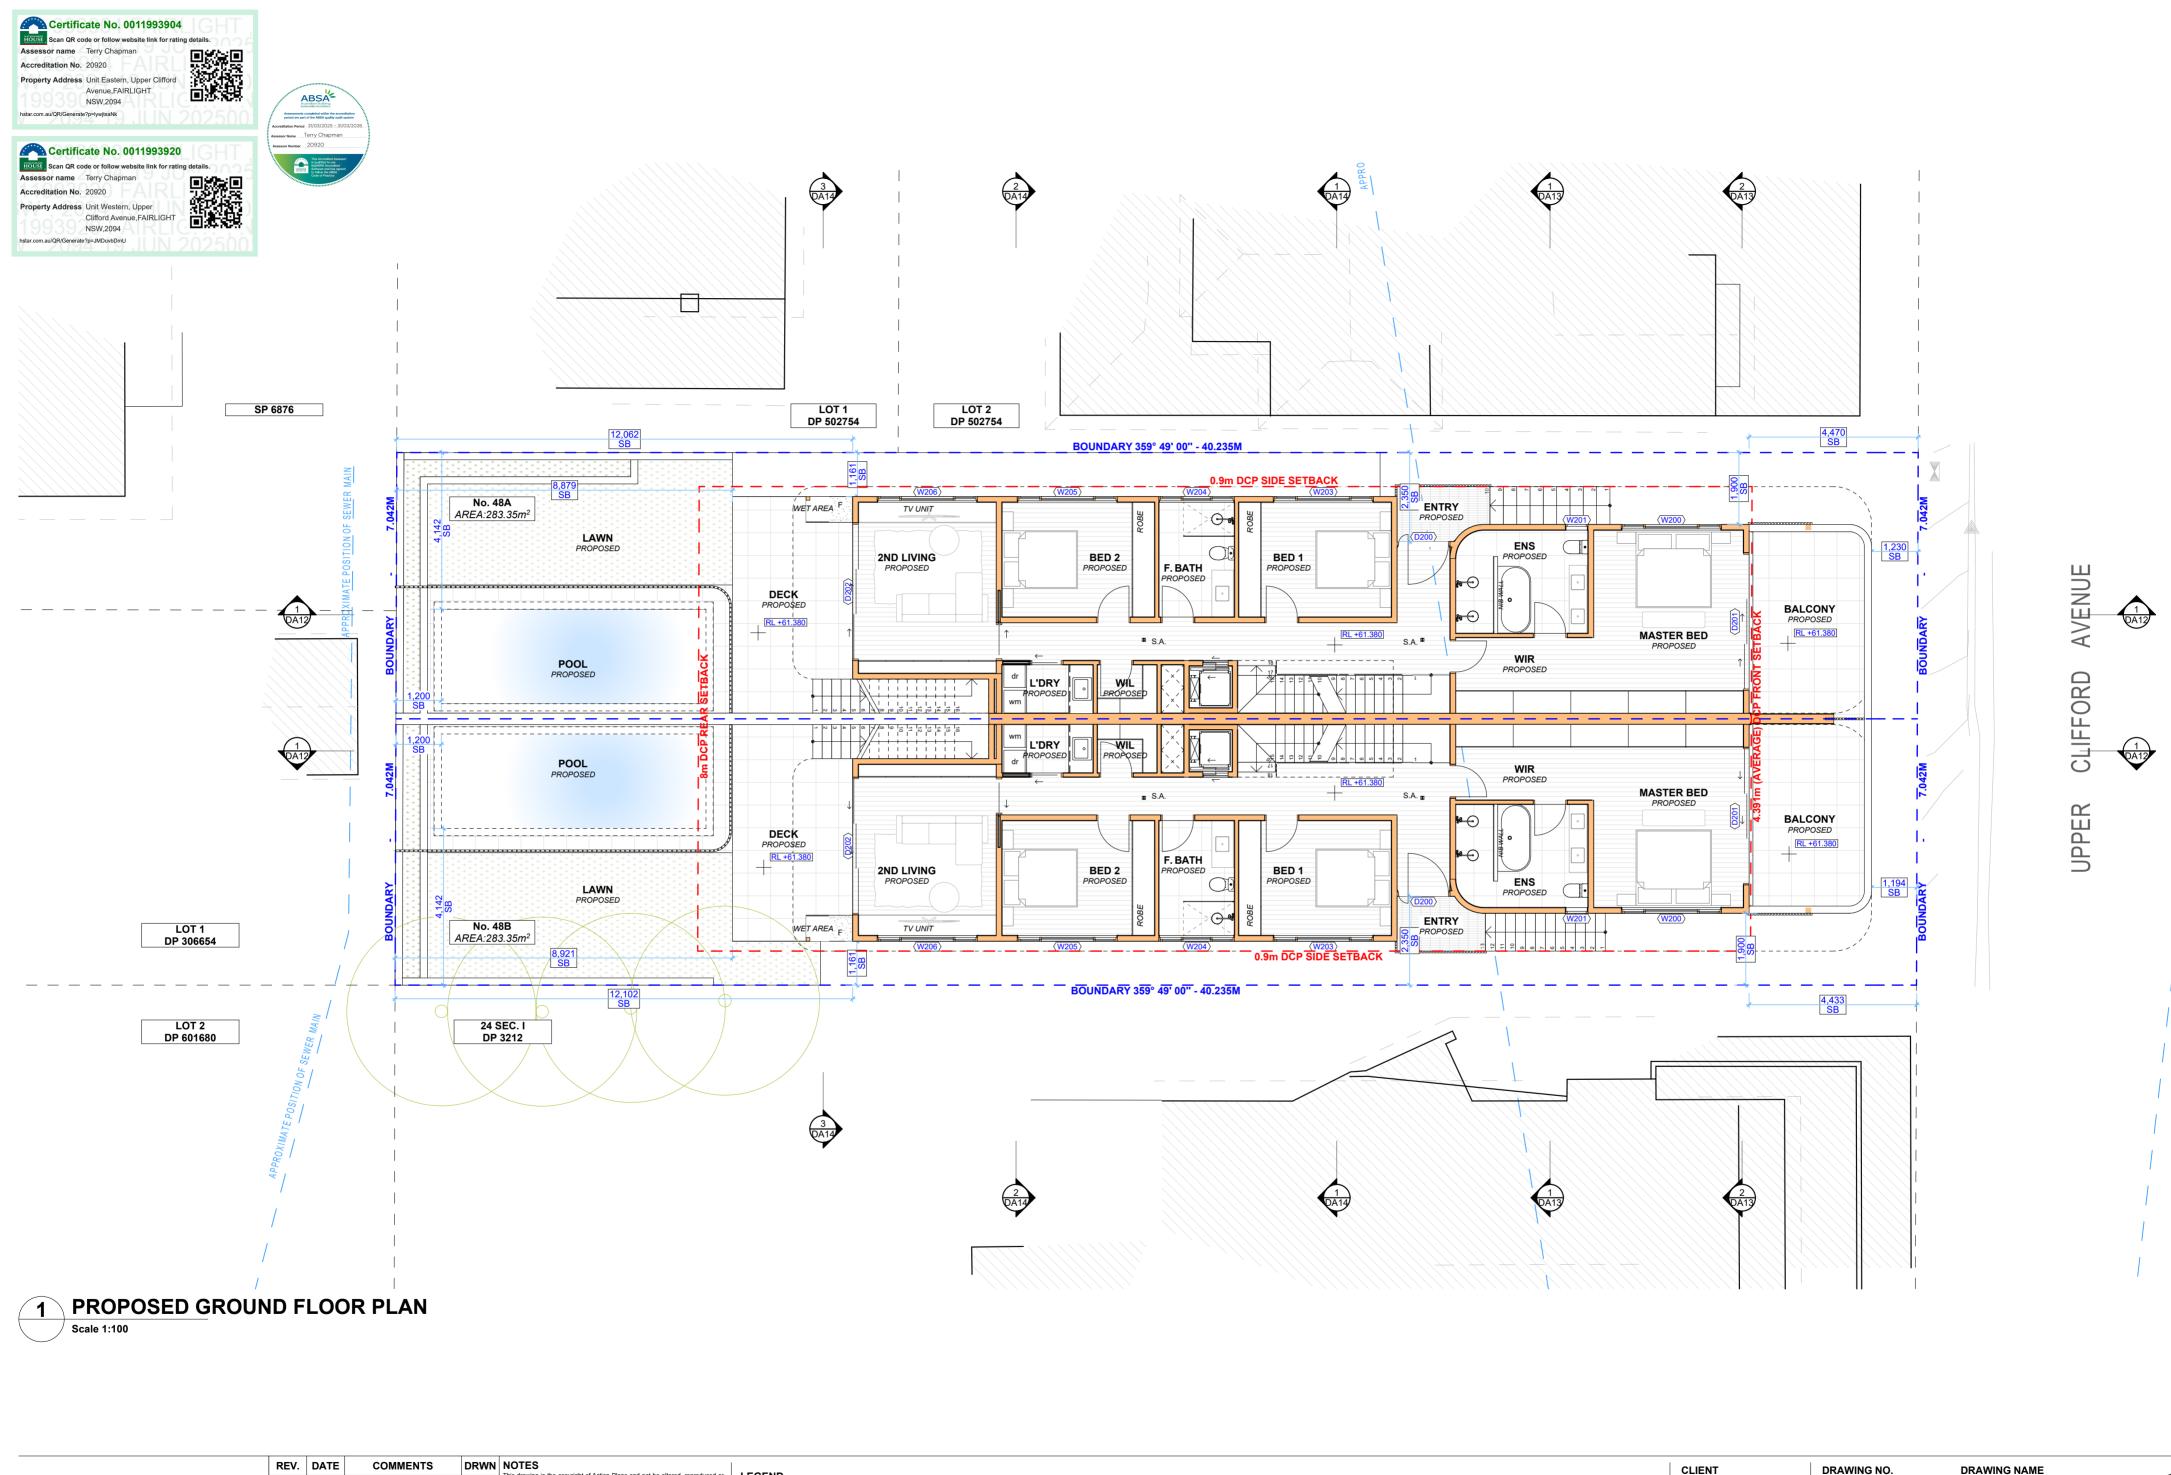



REV. DATE

COMMENTS

DRWN


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EXISTING RL

CLIENT Nicholas & April Allen

DA07

DRAWING NAME
PROPOSED GROUND FLOOR
PLAN


PROJECT ADDRESS

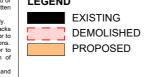
48 Upper Clifford Ave Fairlight NSW 2094

DATE

Friday, 13 June 2025


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.au					components. All errors and omissions are to be verified by the Builder/Contractor/client and referred to the designer prior to the commencement of works.
					referred to the designer prior to the confinencement of works.

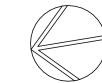
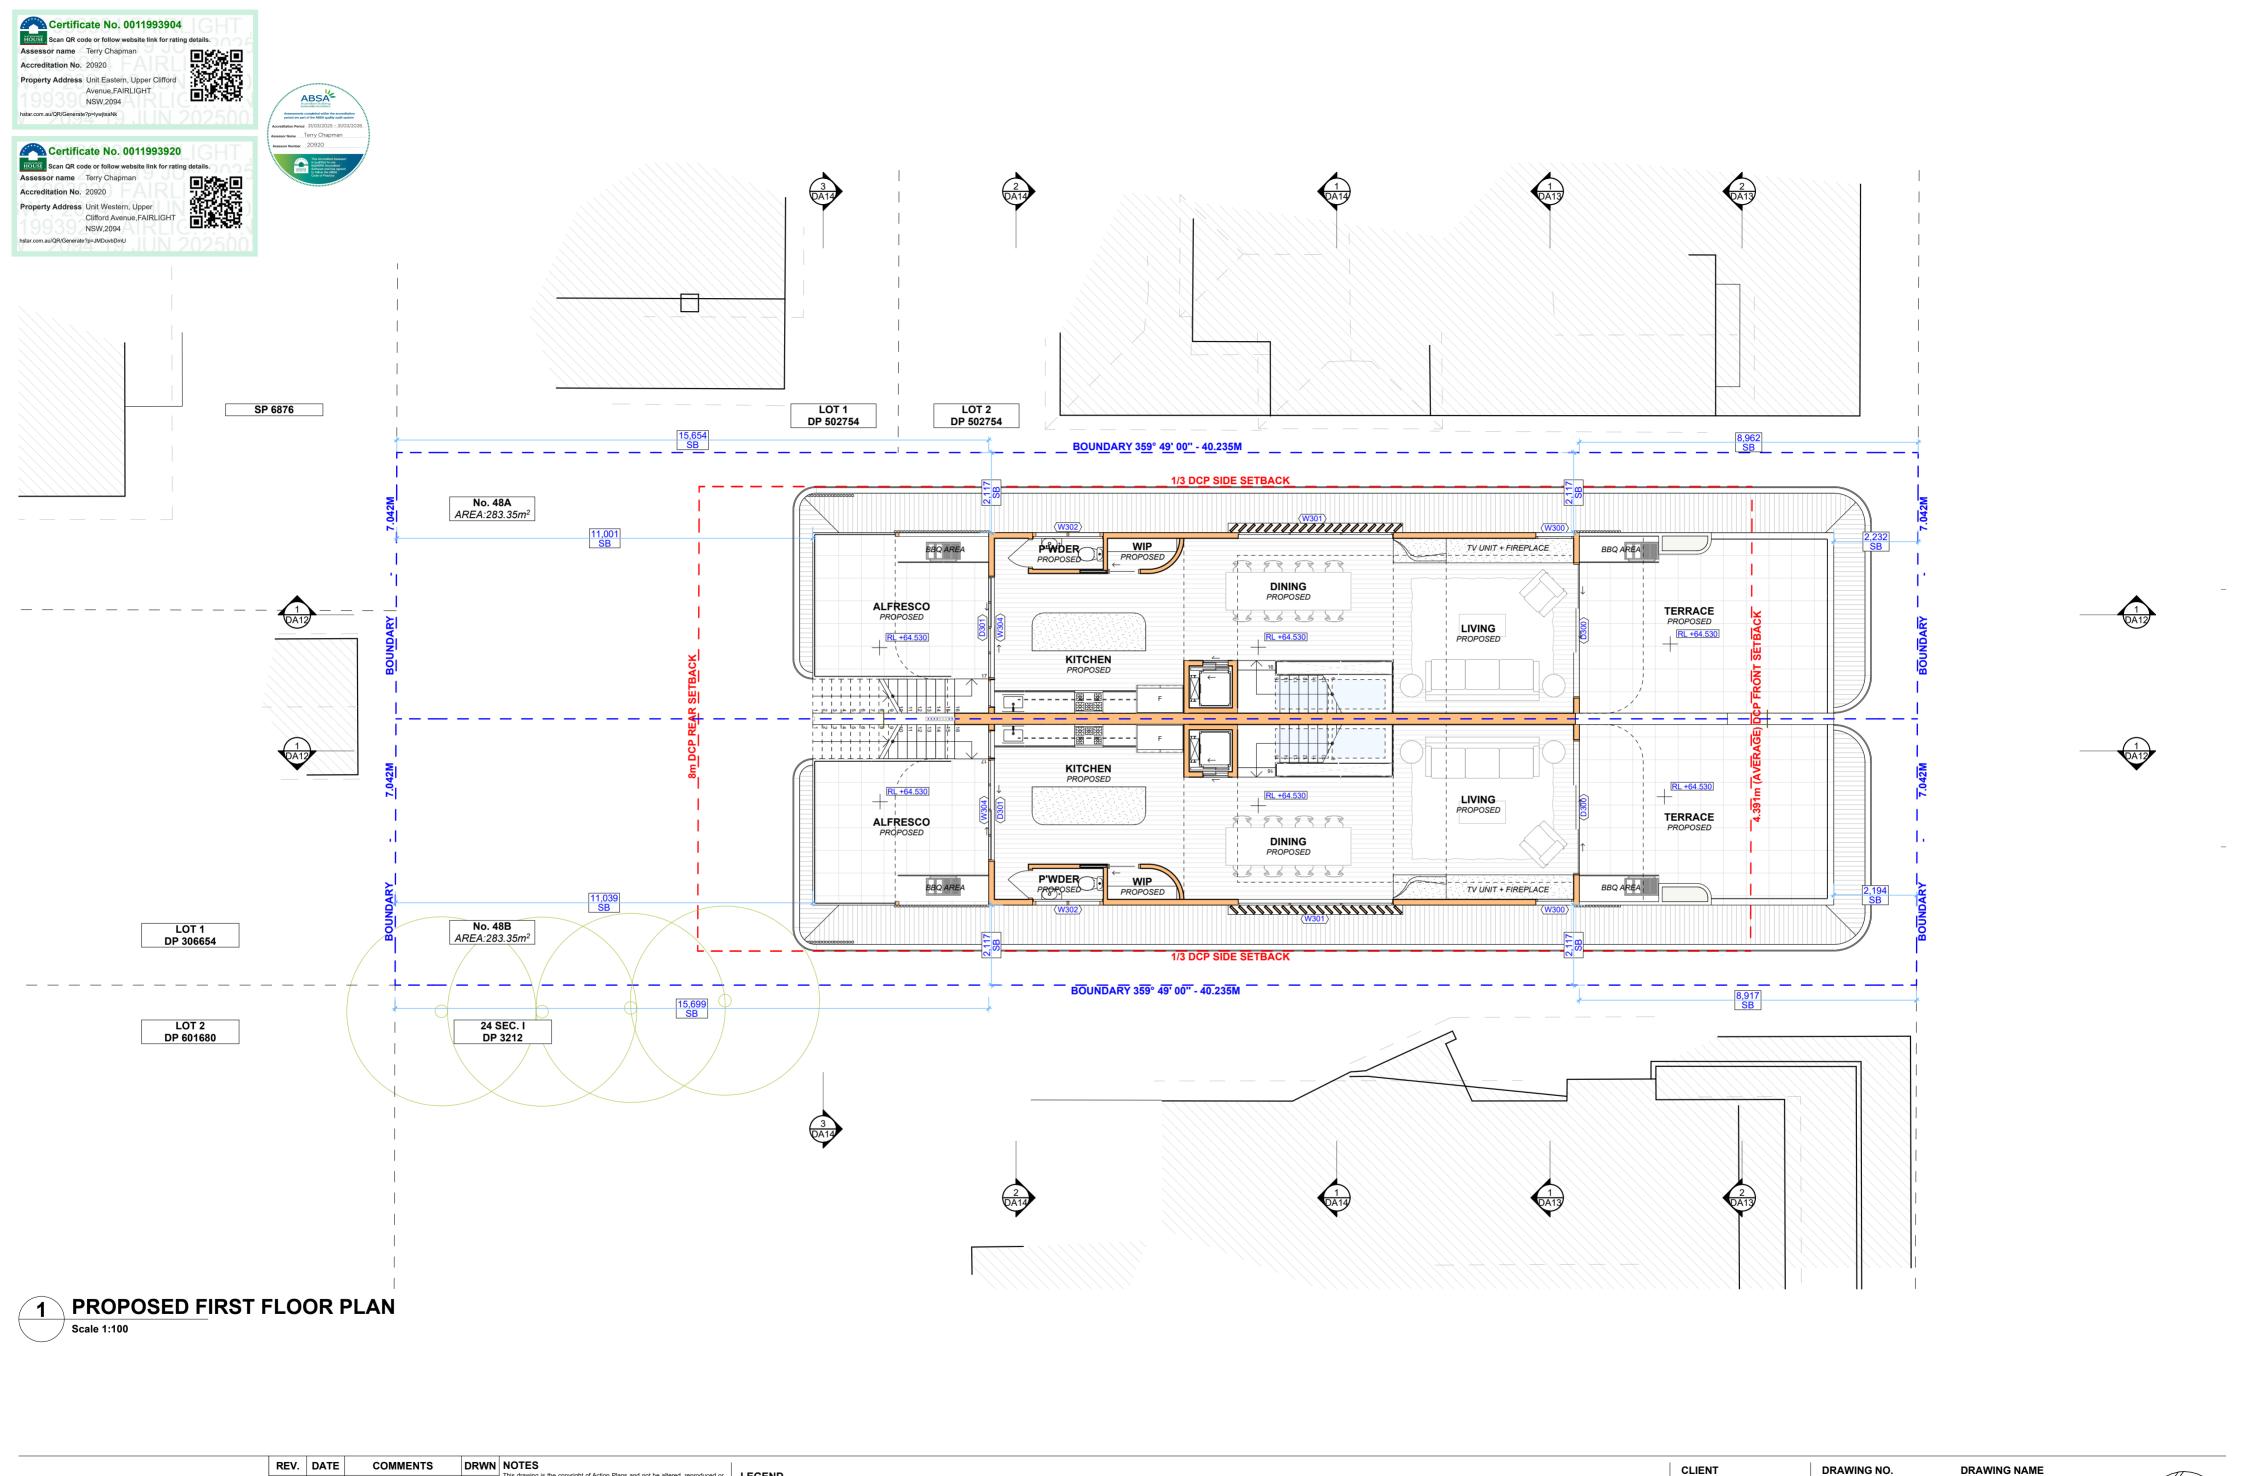
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CLIENT Nicholas & April Allen

PROJECT ADDRESS


48 Upper Clifford Ave Fairlight NSW 2094 DA08

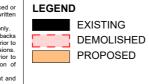DRAWING NAME
PROPOSED FIRST FLOOR
PLAN

DATE SC Friday, 13 June 2025 1:1

SCALE 1:100 @A2



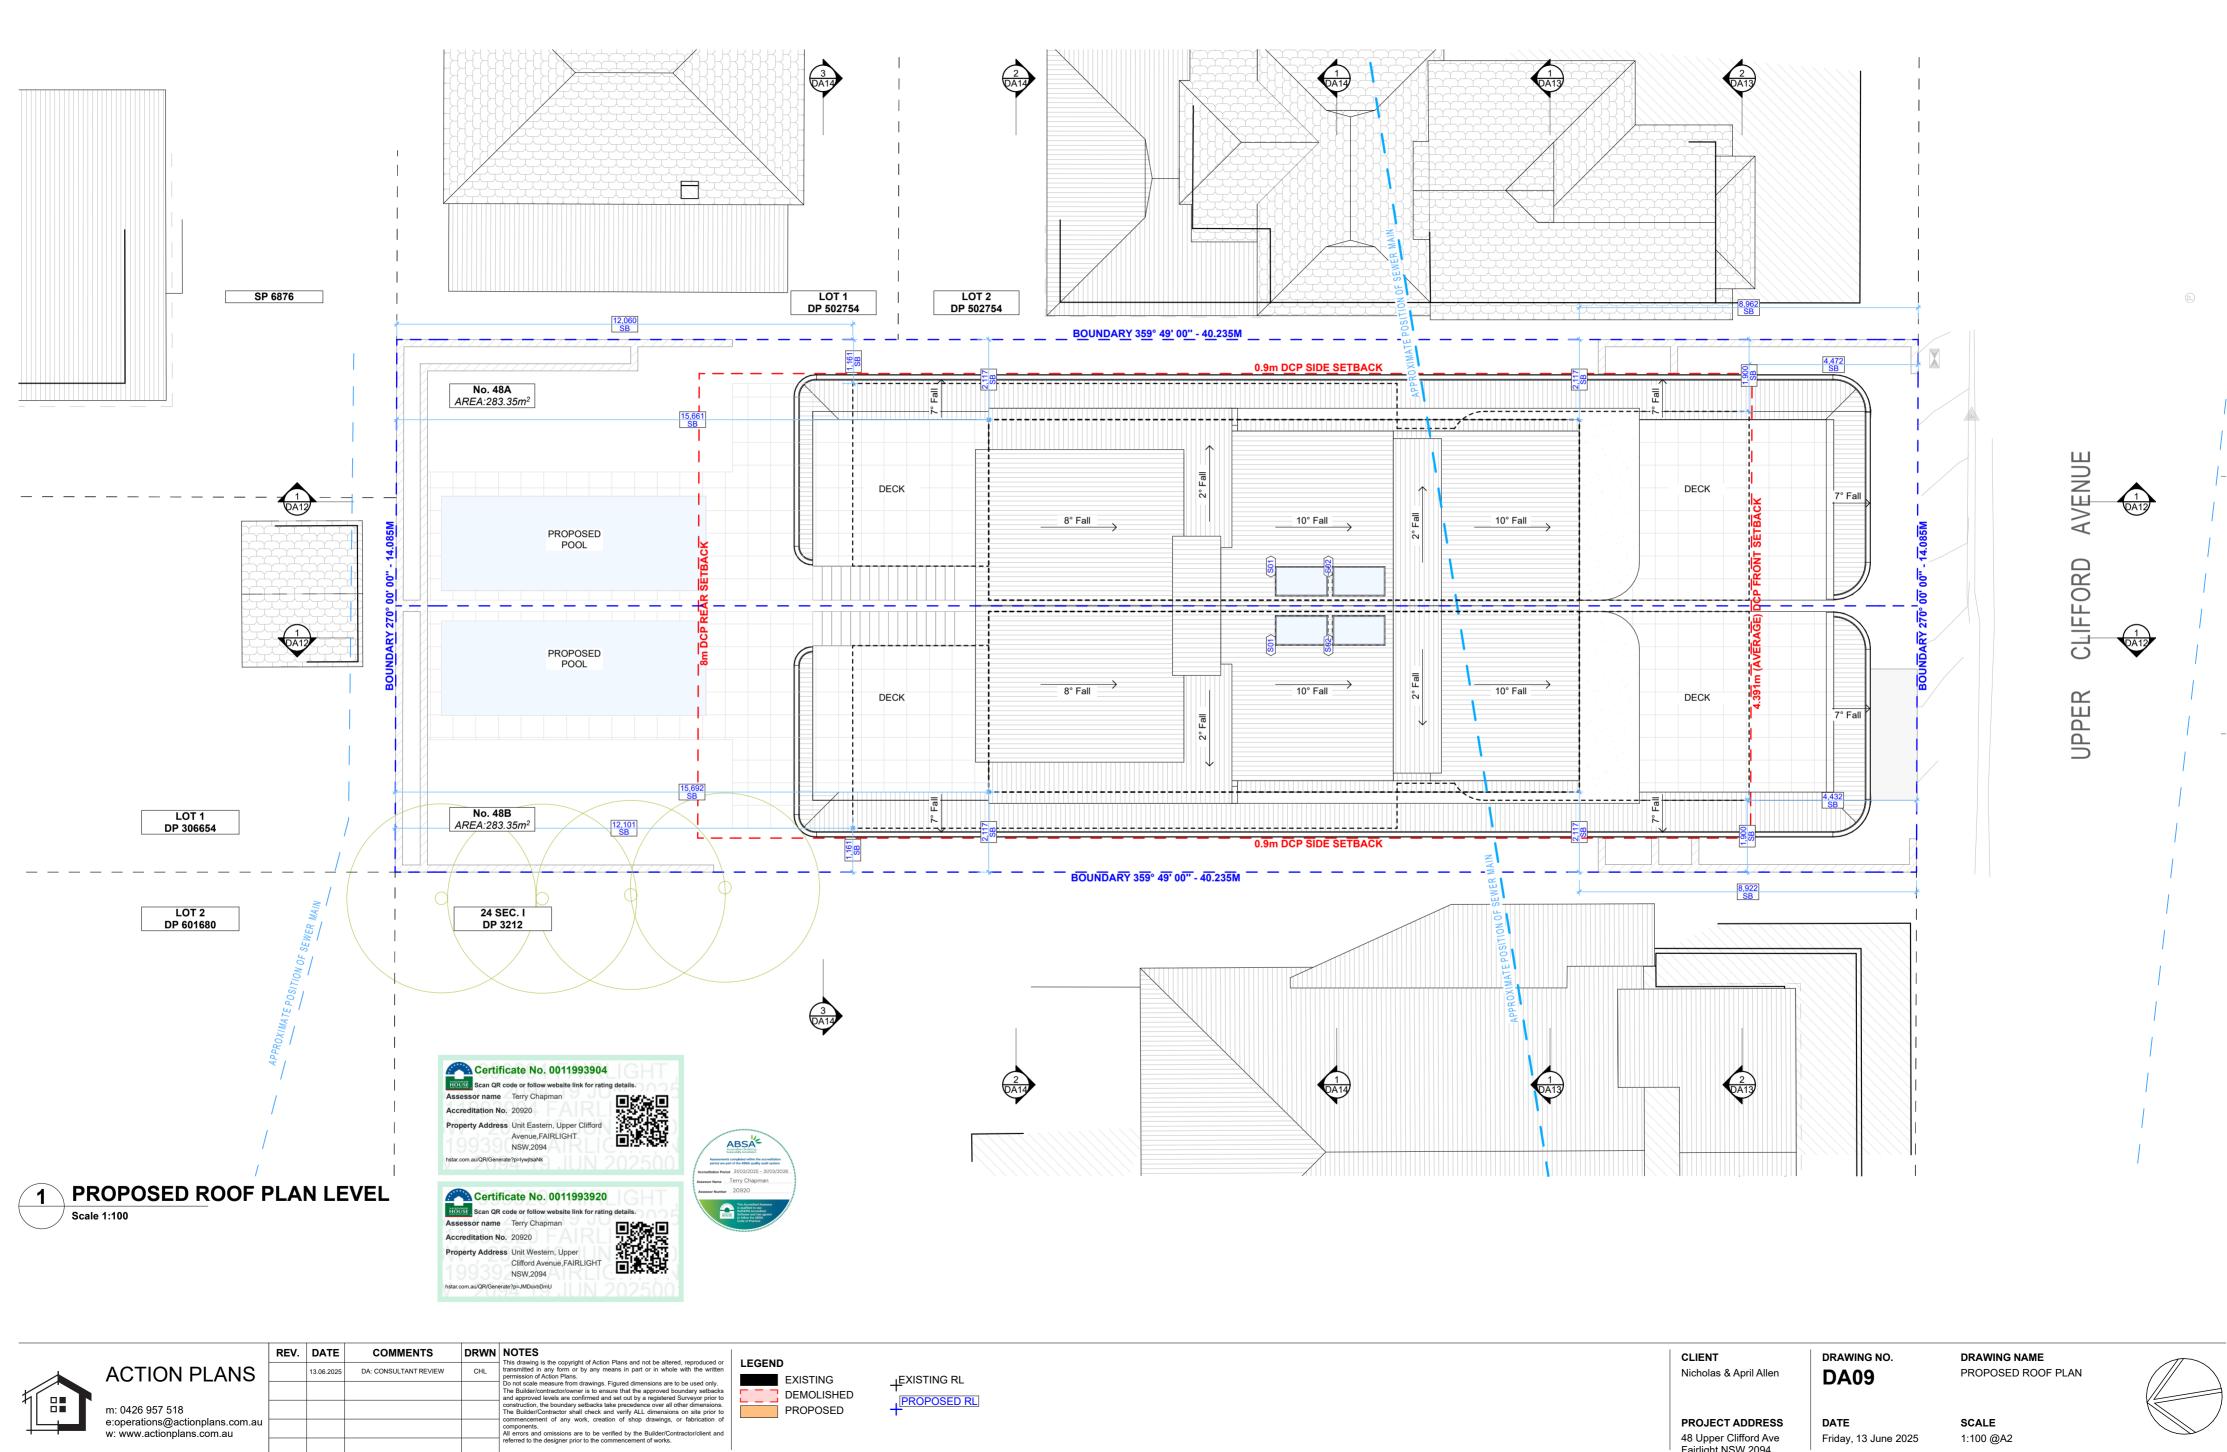

EXISTING

DEMOLISHED

PROPOSED

≠EXISTING RL

PROPOSED RL

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PROPOSED ROOF PLAN

SCALE

1:100 @A2

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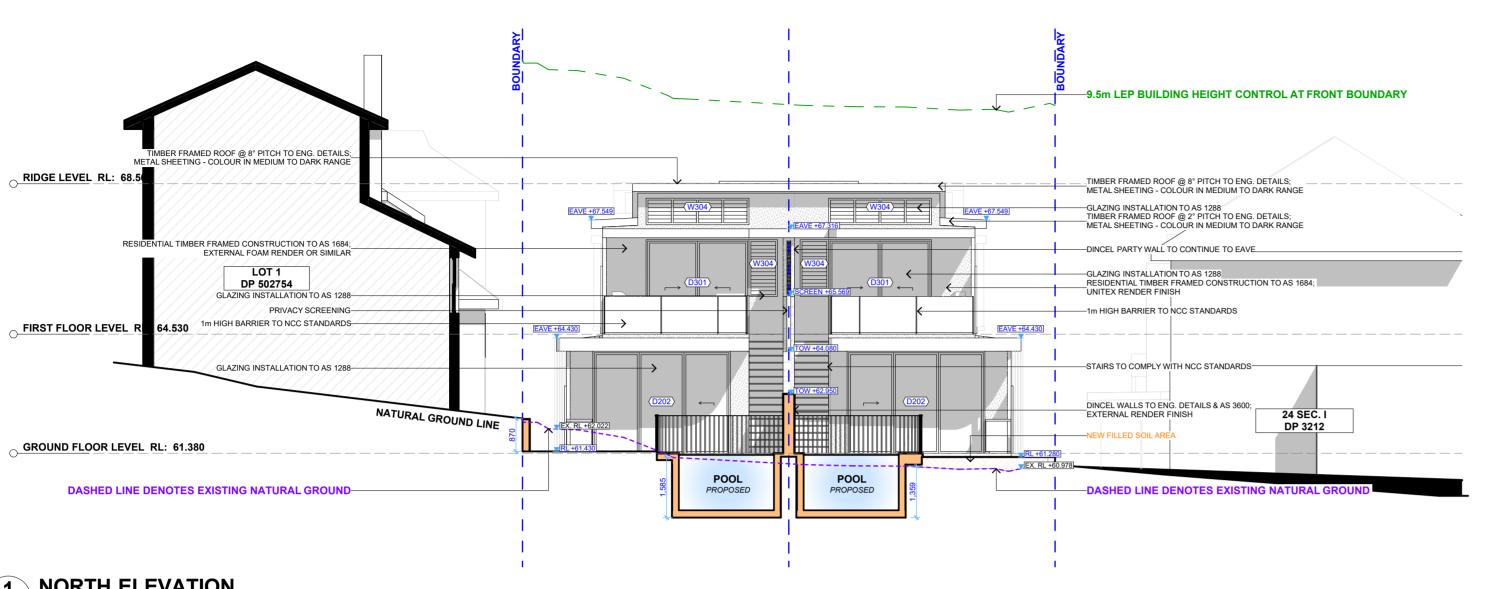
48 Upper Clifford Ave

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DA09

Friday, 13 June 2025

DATE



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Assessor name Terry Chapman

Accreditation No. 20920

Property Address Unit Eastern, Upper Clifford

Avenue, FAIRLIGHT

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Assessor name Terry Chapman


Accreditation No. 20920

Property Address Unit Western, Upper

Clifford Avenue, FAIRLIGHT


NSW,2094

1 NORTH ELEVATION

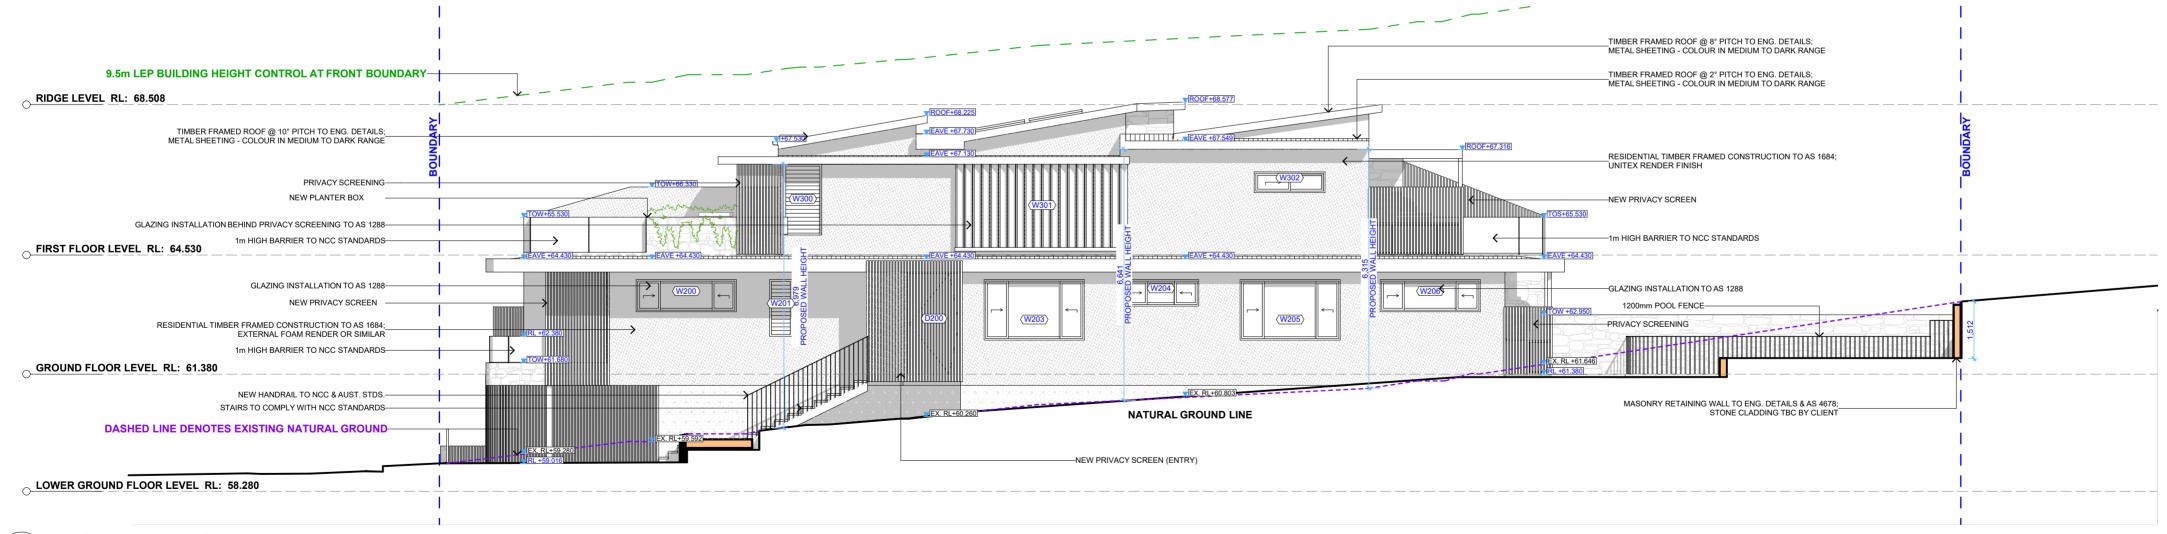

2 EAST ELEVATION

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						The Builder/contractor/owner is to ensure that the approved boundary setbacks and approved levels are confirmed and set out by a registered Surveyor prior to construction, the boundary
	m: 0426 957 518					setbacks take precedence over all other dimensions. The Builder/Contractor shall check and verify ALL dimensions on site prior to commencement of
	e:operations@actionplans.com.au w: www.actionplans.com.au					any work, creation of shop drawings, or fabrication of components. All errors and omissions are to be verified by the Builder/Contractor/client and referred to the
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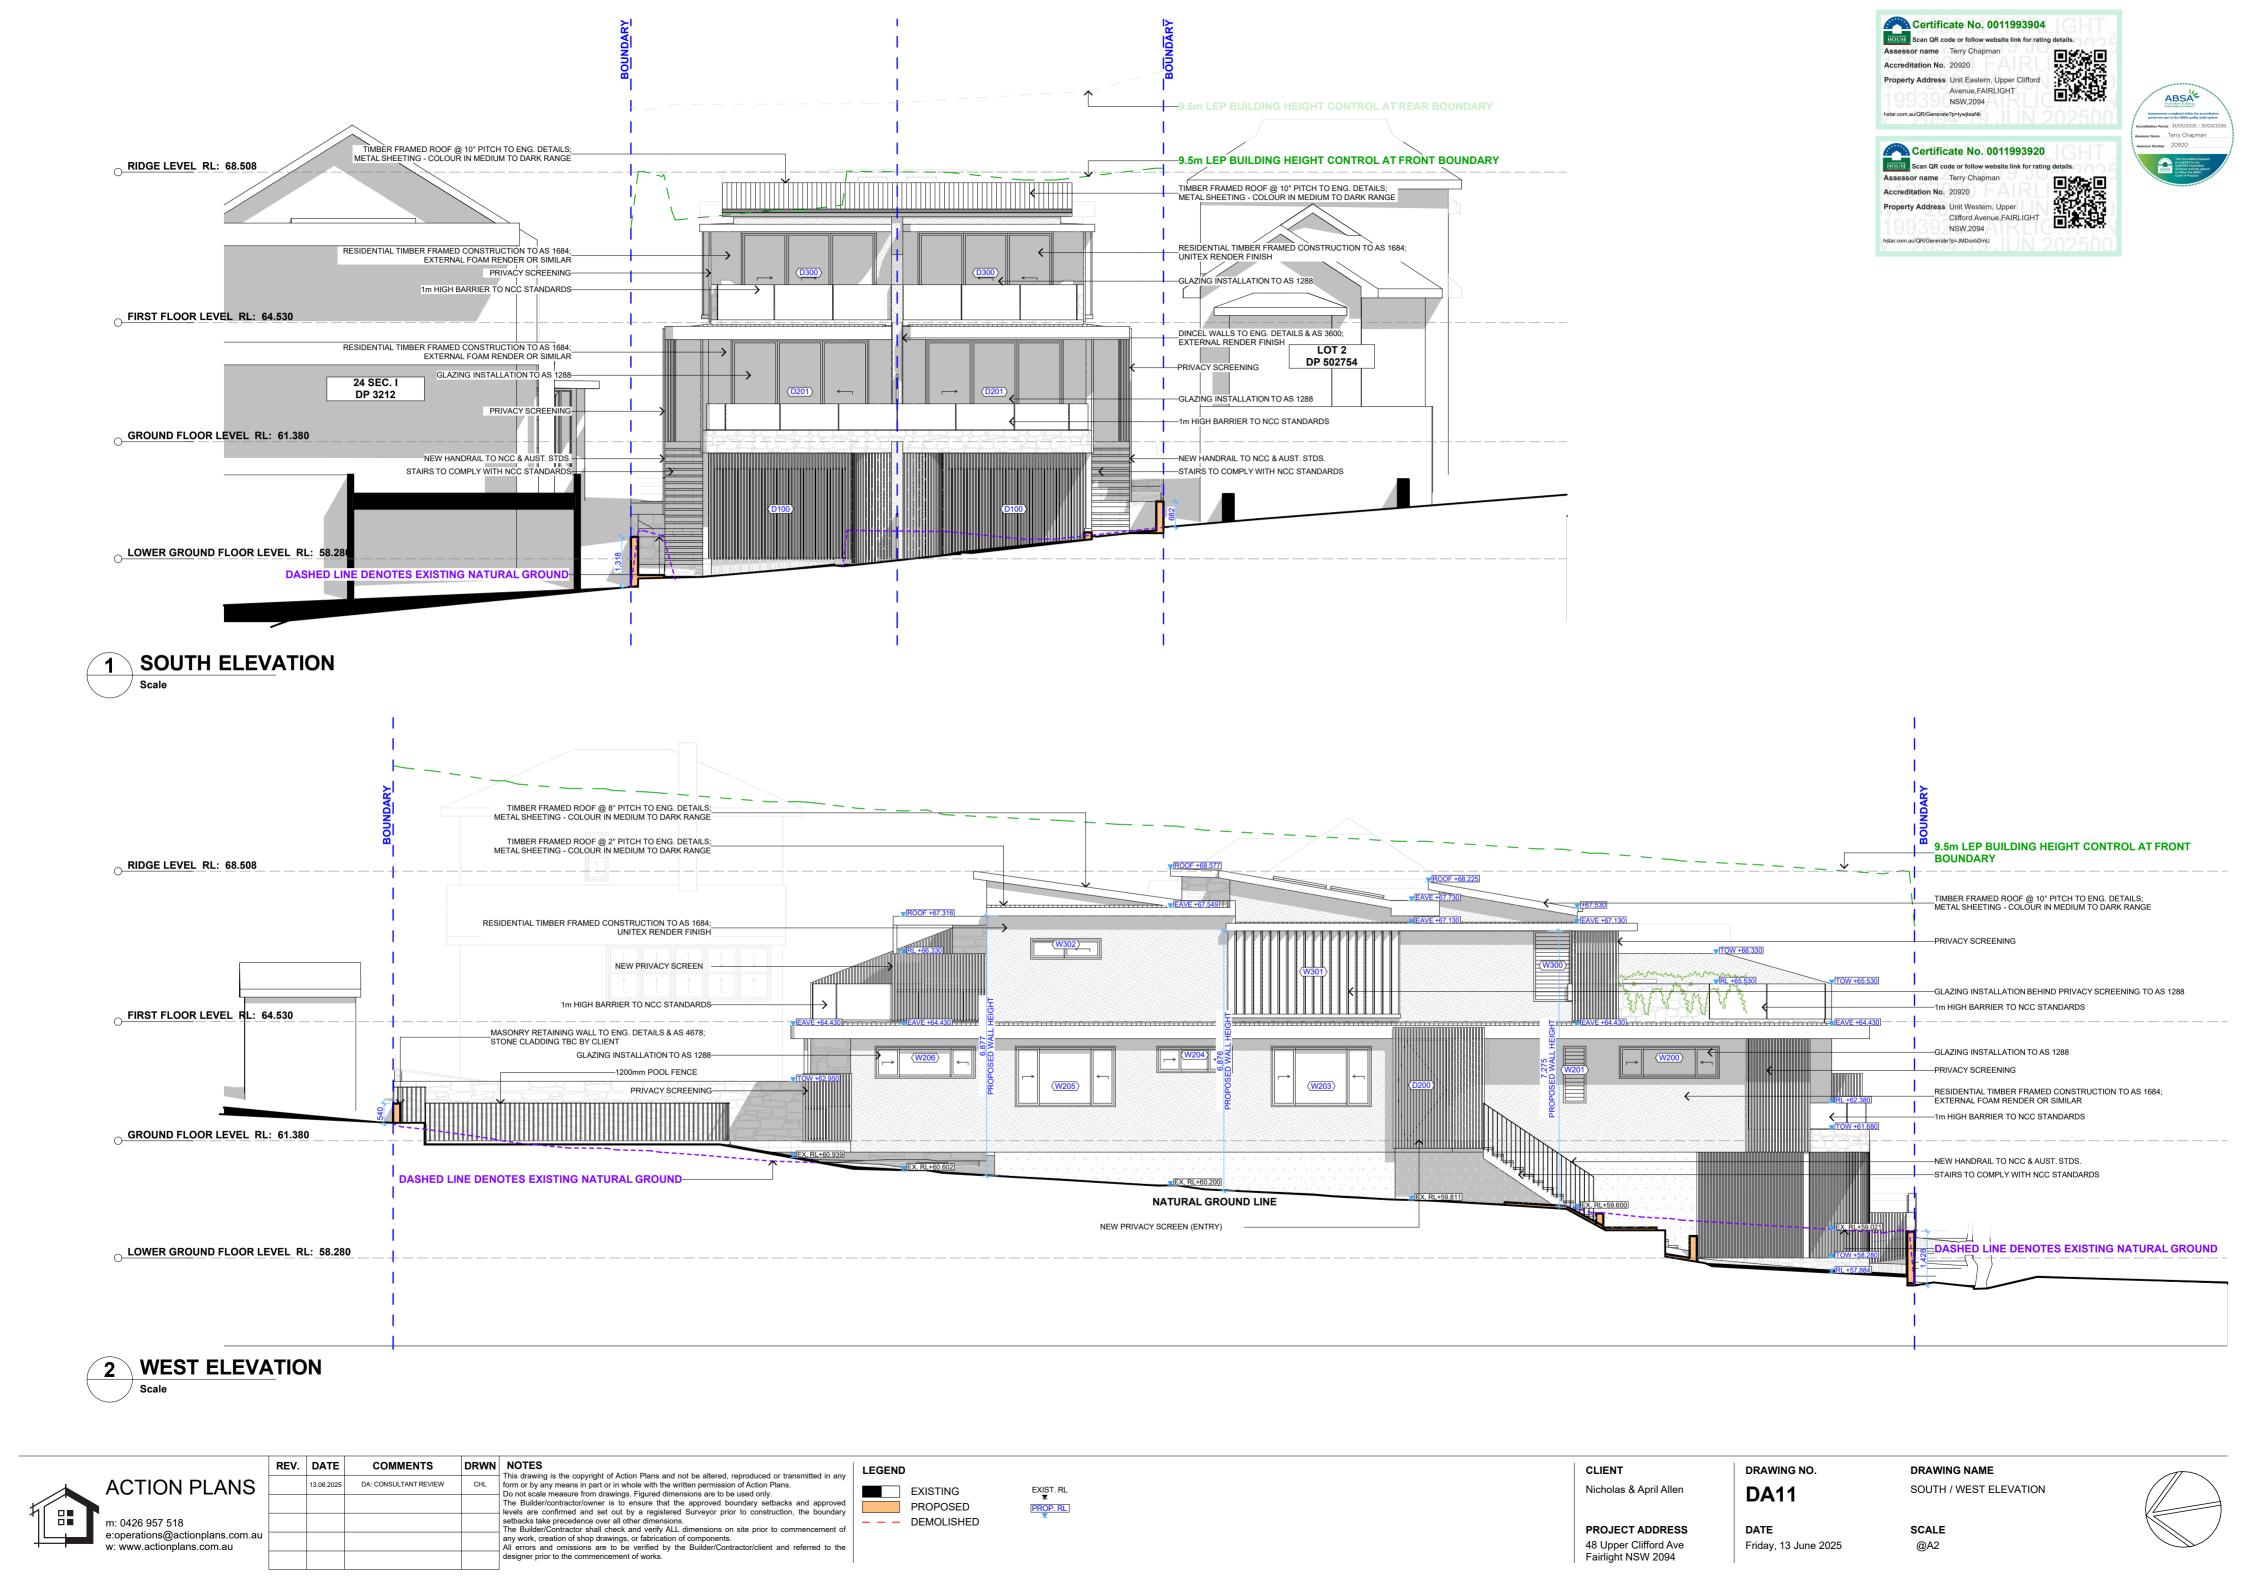
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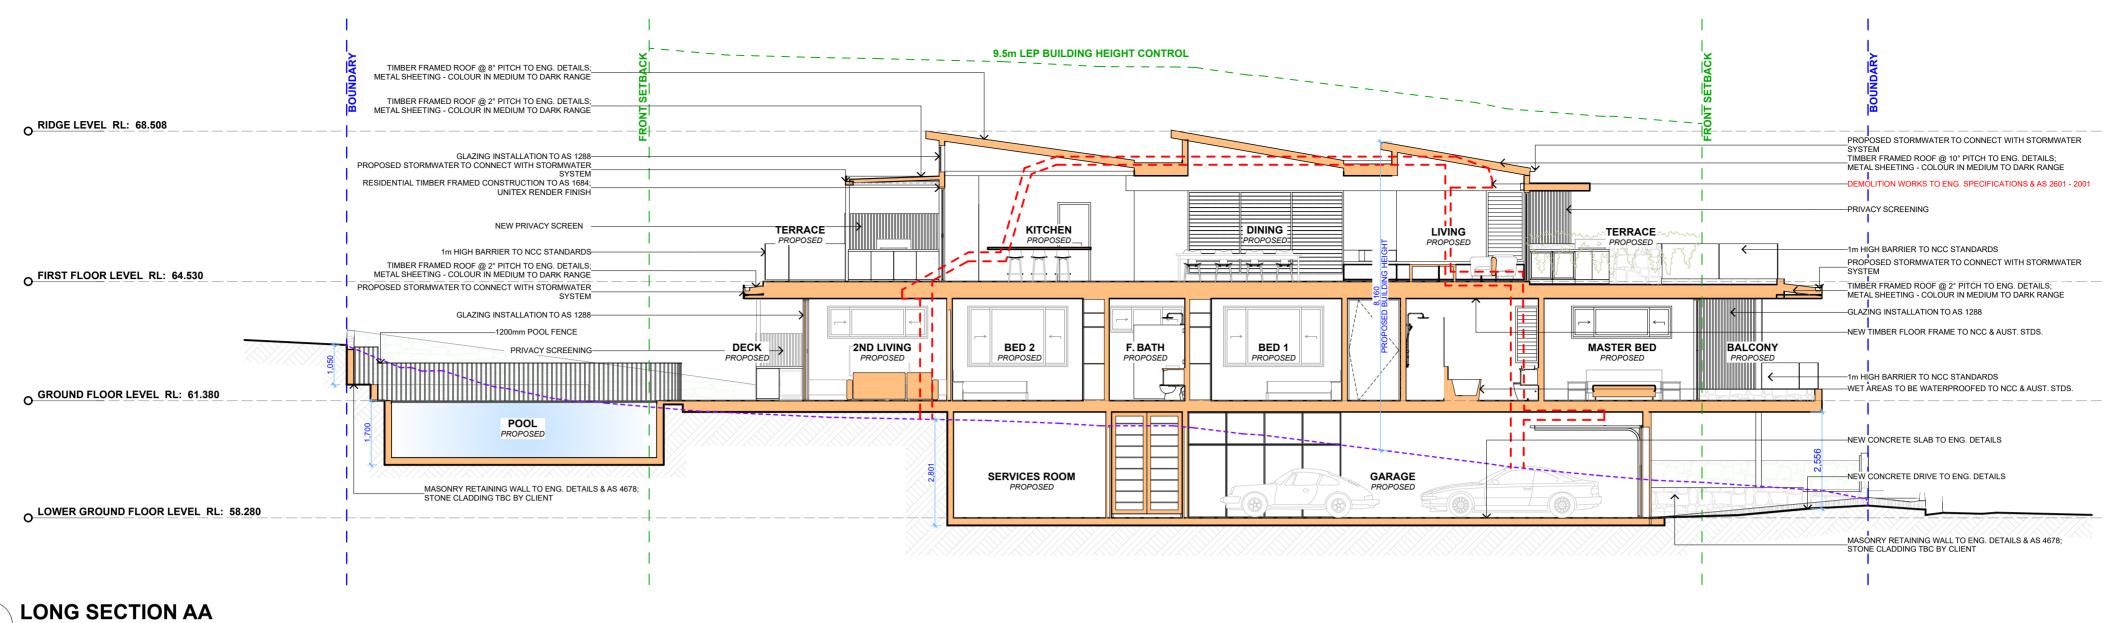
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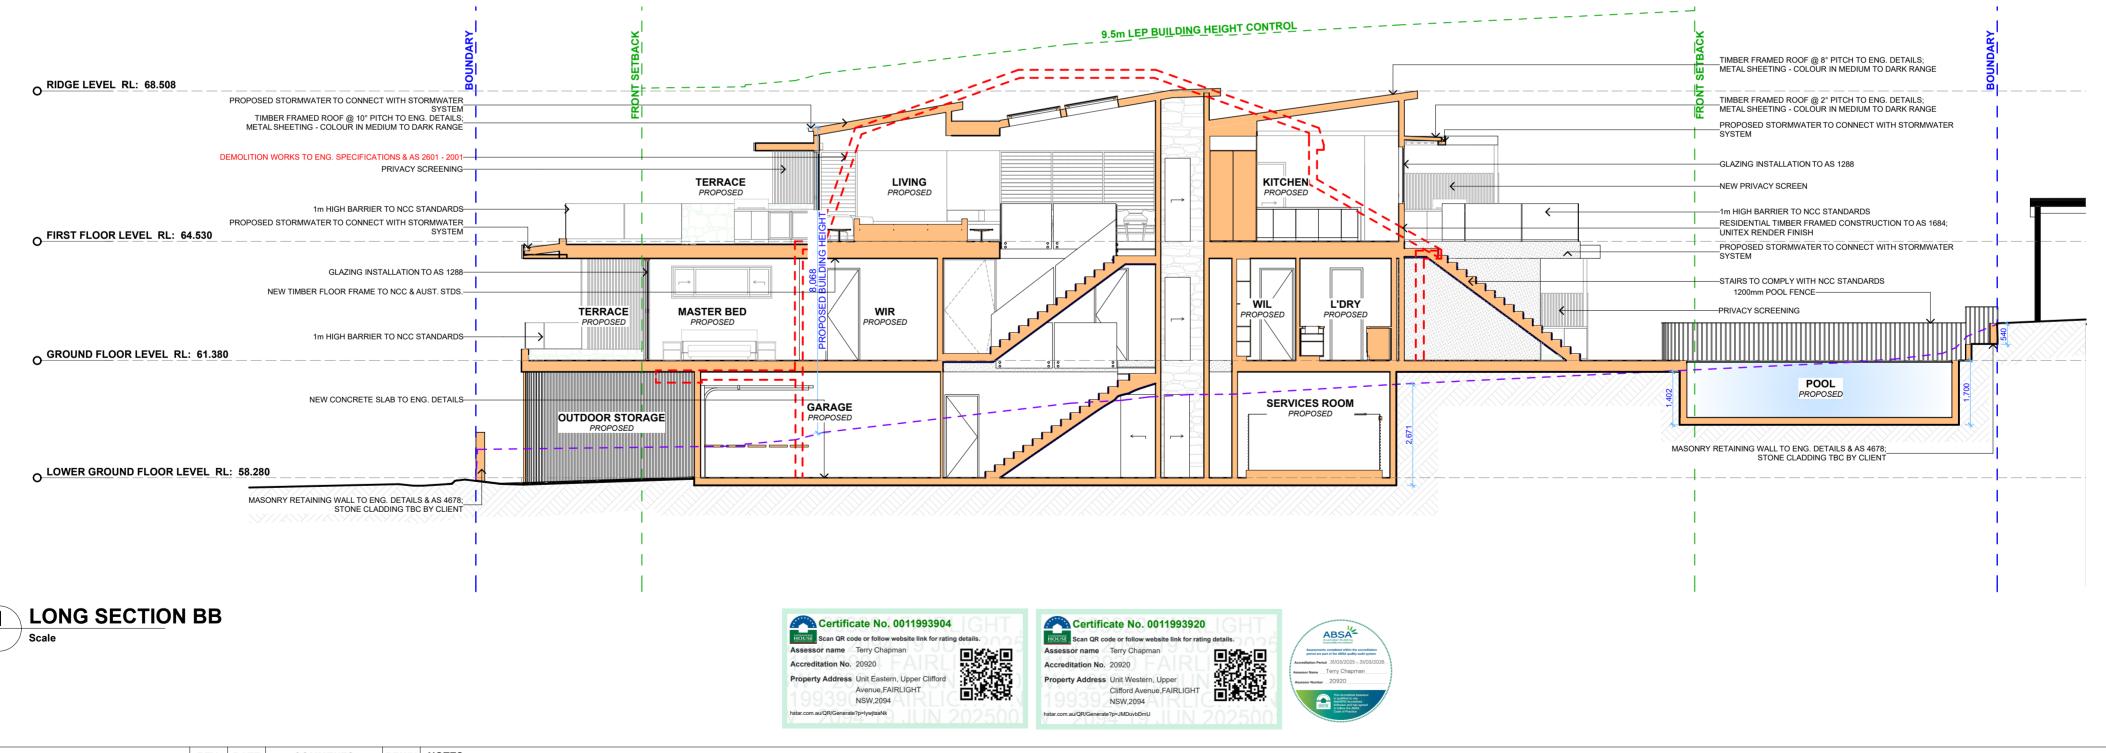
NORTH / EAST ELEVATION

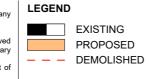DRAWING NAME

DATE SCALE
Friday, 13 June 2025 @A2










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					setbacks take precedence over all other dimensions. The Builder/Contractor shall check and verify ALL dimensions on site prior to commencem	
om.au					any work, creation of shop drawings, or fabrication of components. All errors and omissions are to be verified by the Builder/Contractor/client and referred to the	
					designer prior to the commencement of works.	

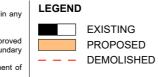

EXIST. RL ▼	
PROP. RL	

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48 Upper Clifford Ave

Fairlight NSW 2094

DRAWING NO. **DA12** DATE


Friday, 13 June 2025

DRAWING NAME LONG SECTIONS

SCALE

1:100 @A2



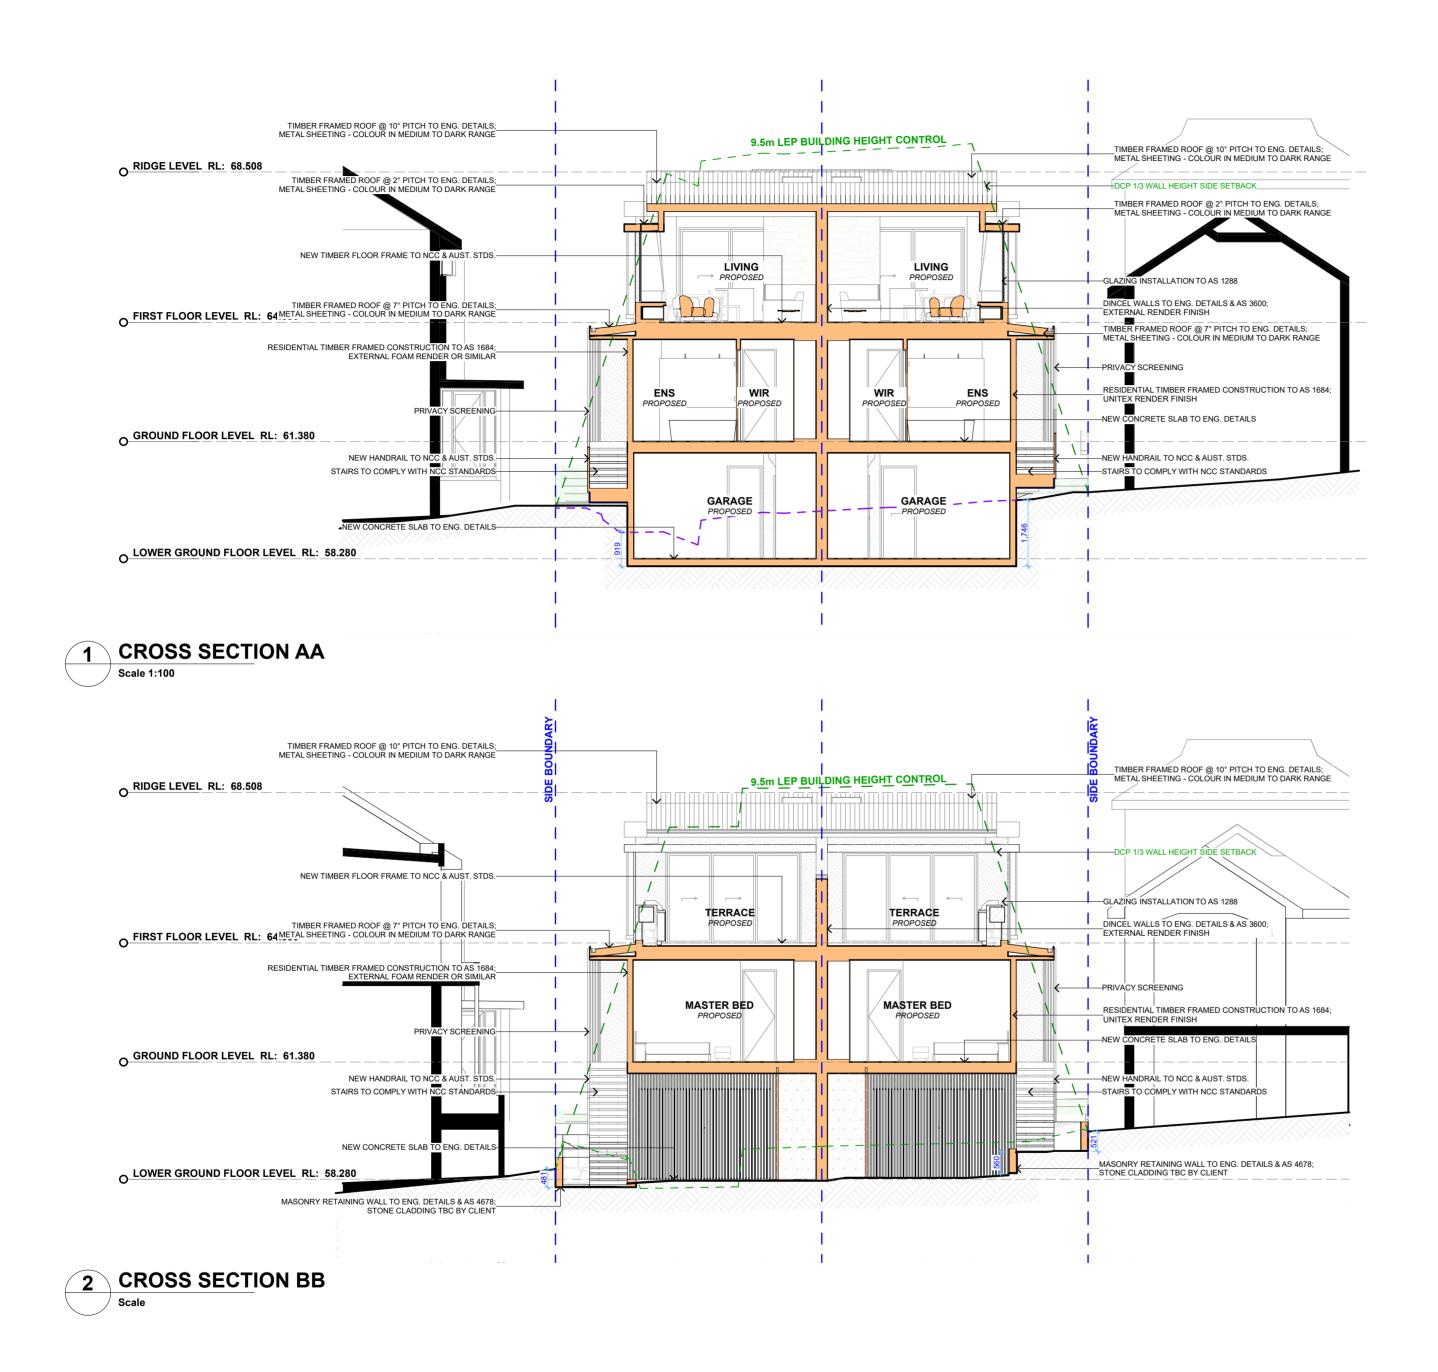

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Accreditation No. 20920

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Property Address Unit Western, Upper

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NSW,2094

Clifford Avenue, FAIRLIGHT

CLIENT
Nicholas & April Allen

PROJECT ADDRESS

48 Upper Clifford Ave

Fairlight NSW 2094

l Allen

DA13

DATE
Friday, 13 June 2025

DRAWING NO.

DRAWING NAME
CROSS SECTIONS

SCALE 1:100 @A2



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REV. DATE COMMENTS DRWN

13.06.2025 DA: CONSULTANT REVIEW

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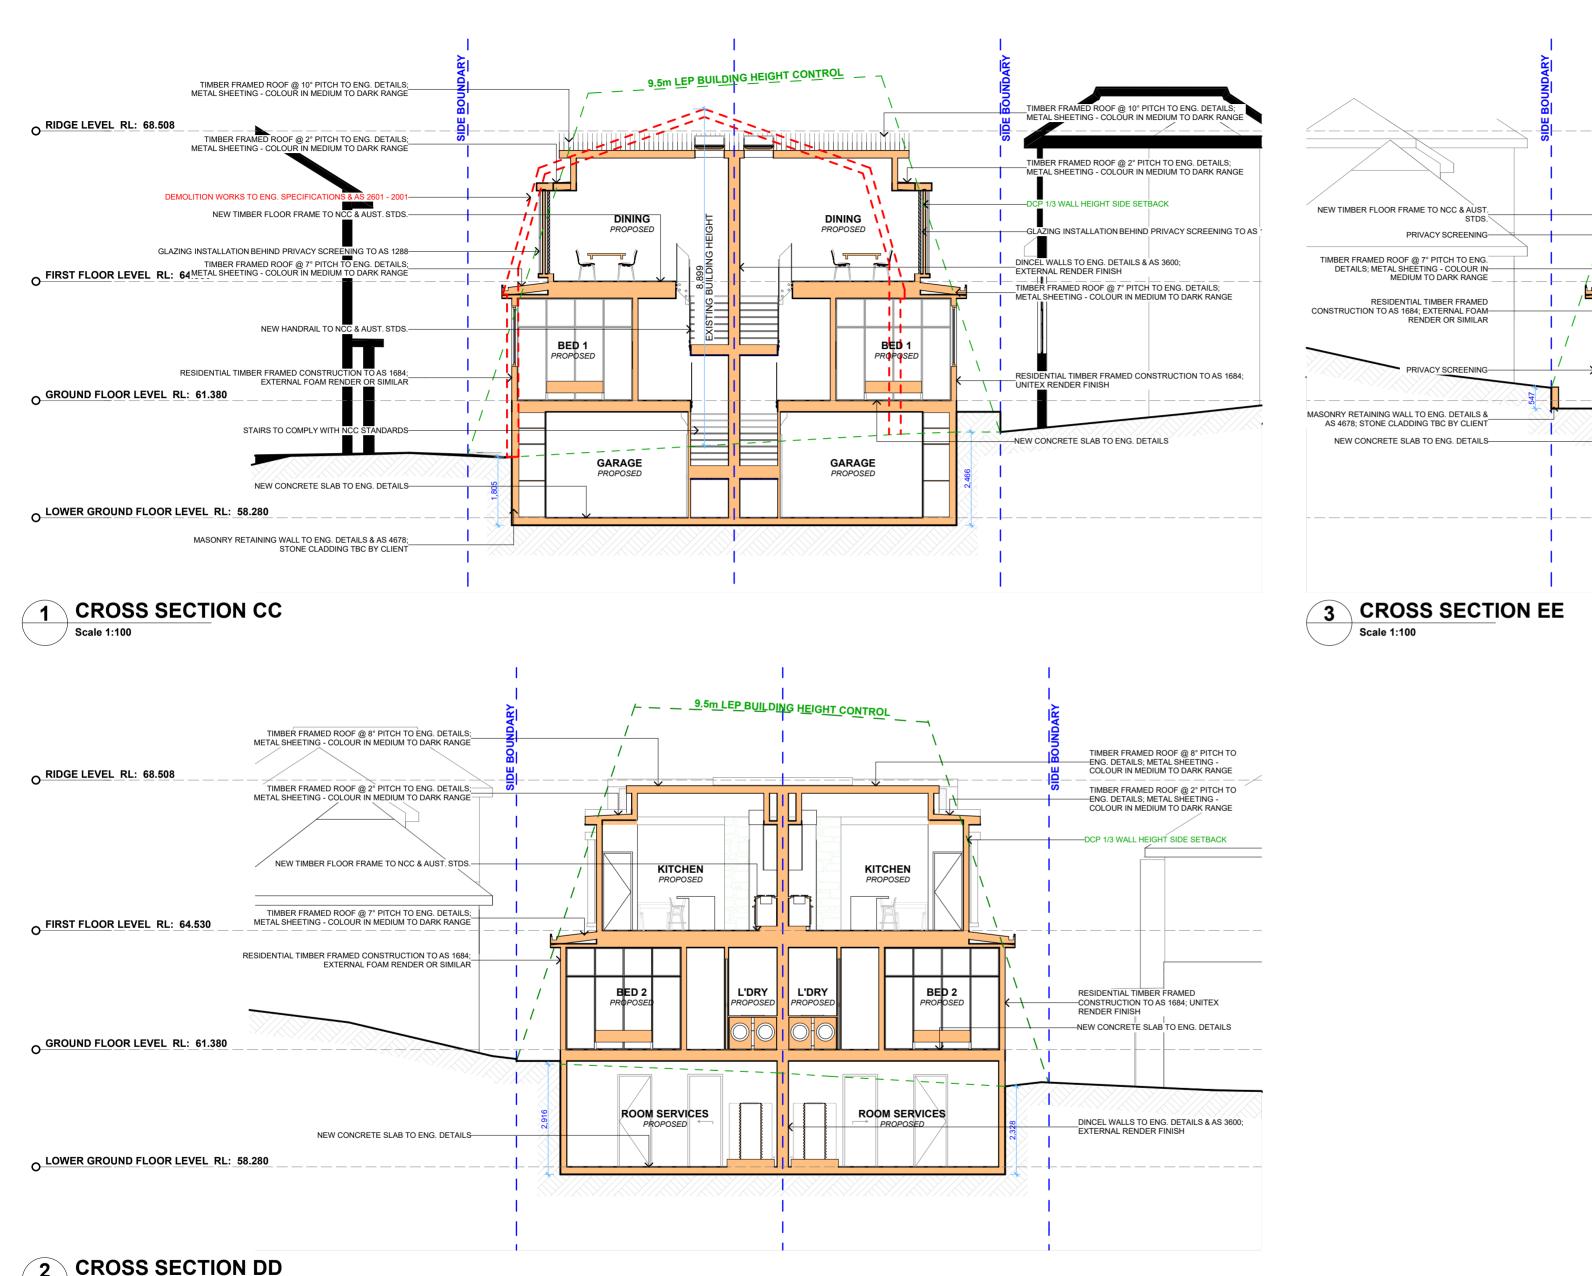
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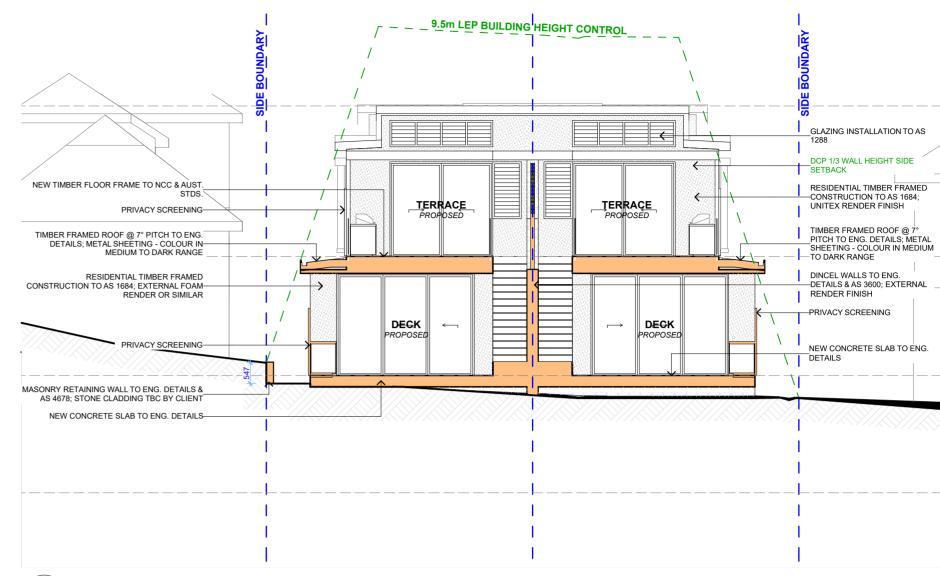
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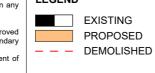
13.06.2025 DA: CONSULTANT REVIEW

CHL

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EXIST. RL

PROP. RL

CLIENT
Nicholas & April Allen
PROJECT ADDRESS

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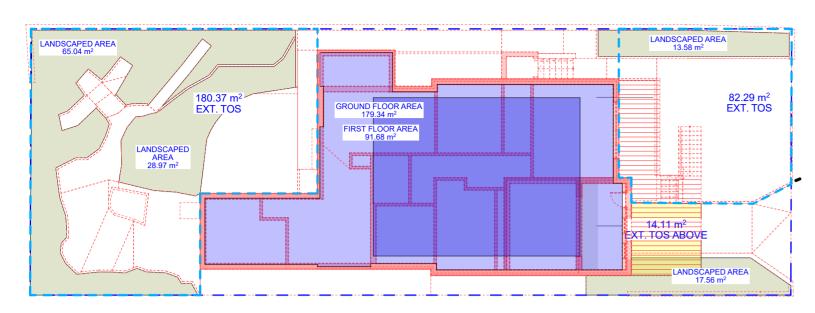
Fairlight NSW 2094

DA14

DRAWING NAME
CROSS SECTIONS

DATE SCALE Friday, 13 June 2025 1:100 @

SCALE
1:100 @A2



0 EXISTING AREA CALCULATIONS Scale

EASTERN LOT AREA: 283.35M²

GFA - 0.65:1 (184.1775M²)

GARAGE LEVEL: 11.19M²
GROUND FLOOR: 110.05M²
FIRST FLOOR: 62.69M²
TOTAL PROPOSED GFA: 183.83M²

TOTAL OPEN SPACE PROPOSED TOS: TOS ABOVE GROUND: TOTAL OPEN SPACE:

LESS THAN 3m

(92.91M²) (62.326M²) **54.78%(155.236M²)** (26.97M²)

55% (155.84M²)

TOS LESS THAN 3m
TOS INCLUDING AREA

64.3%(182.206M²)

LANDSCAPE AREA 35% OF T.O.S (54.54M²) PROPOSED: **42.28% (65.89M²)**

WESTERN LOT A AREA: 283.35M²

GFA - 0.65:1 (184.1775M²)

GARAGE LEVEL: 11.19M²
GROUND FLOOR: 110.05M²
FIRST FLOOR: 62.69M²
TOTAL PROPOSED GFA: **183.83M²**

TOTAL OPEN SPACE PROPOSED TOS: TOS ABOVE GROUND: TOTAL OPEN SPACE:


55% (155.84M²) (92.23M²) (62.326M²) 54.54%(154.556M²)

TOS LESS THAN 3m TOS INCLUDING AREA LESS THAN 3m


64.03%(181.456M²)

(26.90M²)


LANDSCAPE AREA 35% OF T.O.S (54.54M²) PROPOSED: **42.71% (66.57M²)**

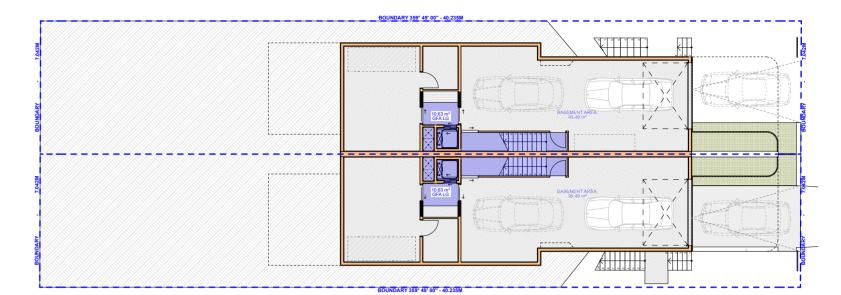

1 PROPOSED GFA LG

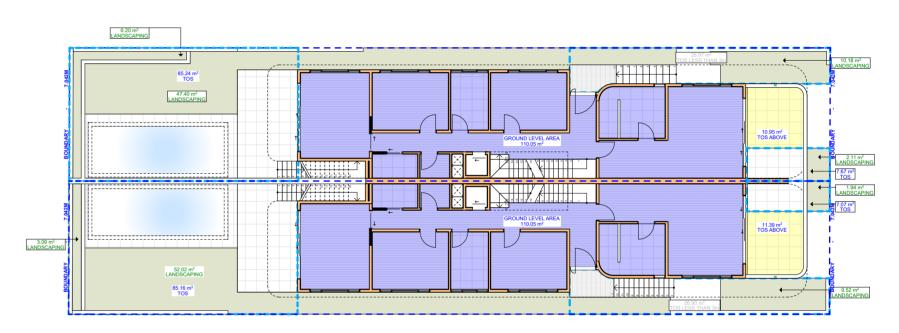

PROPOSED GFA/LANDSCAPING GF
Scale

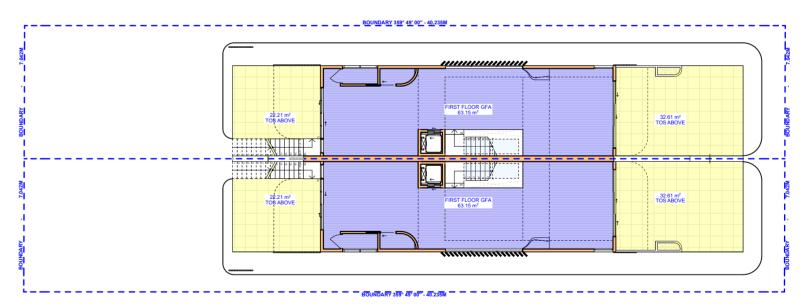

3 PROPOSED GFA FF







NSW,2094

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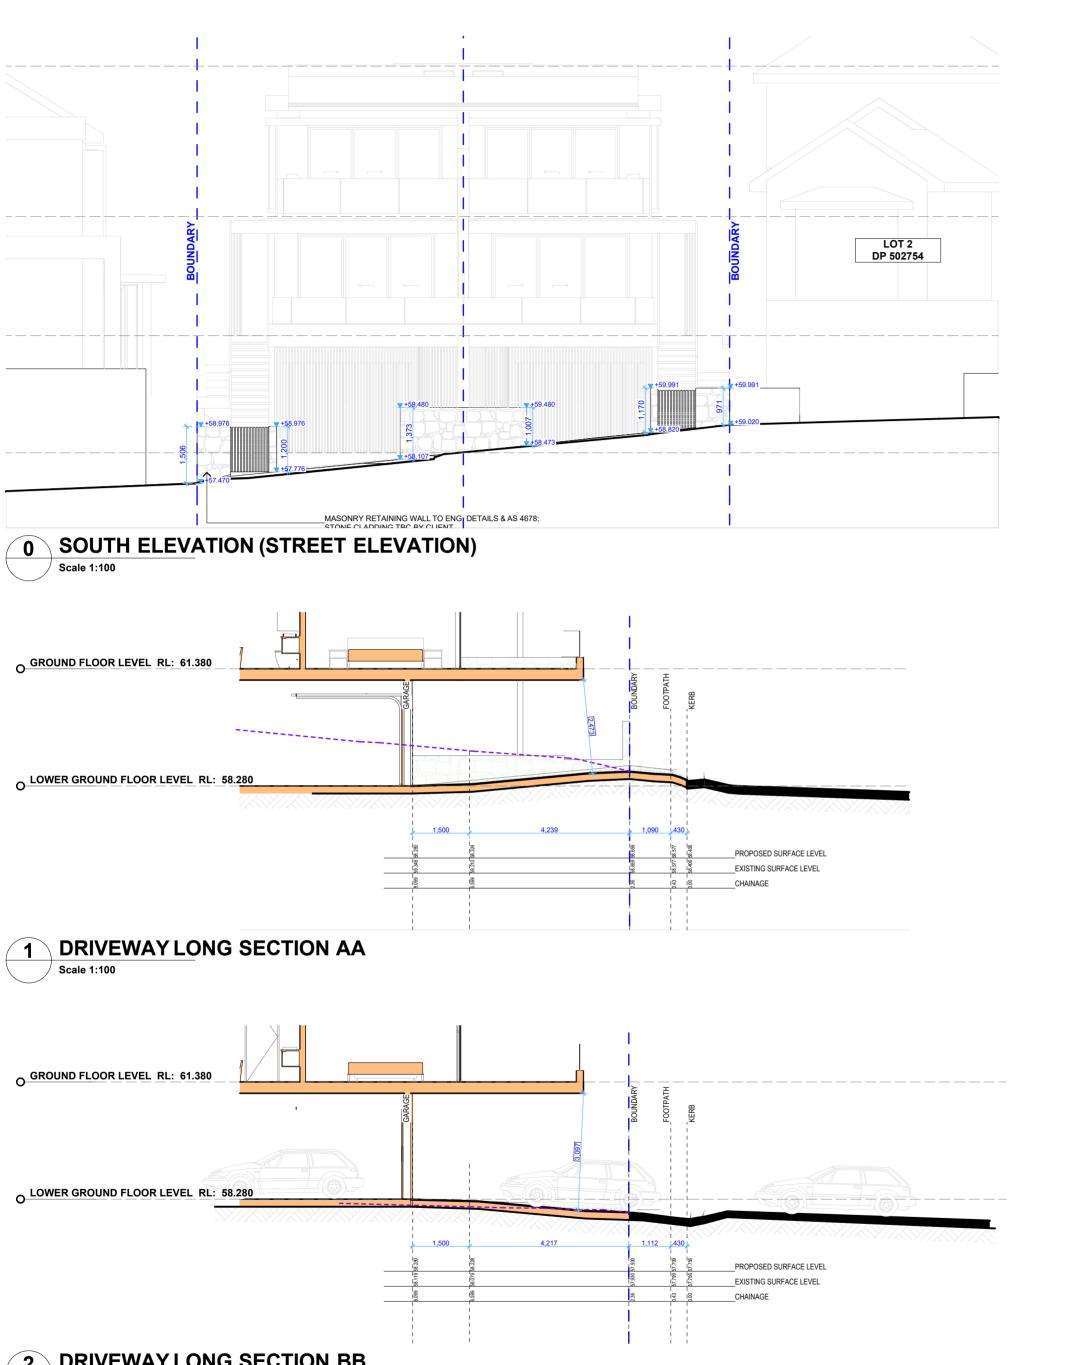
+EXISTING RL


+PROPOSED R




Fairlight NSW 2094





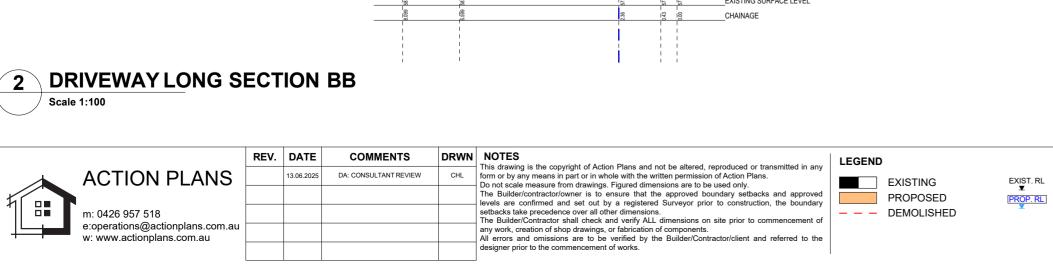

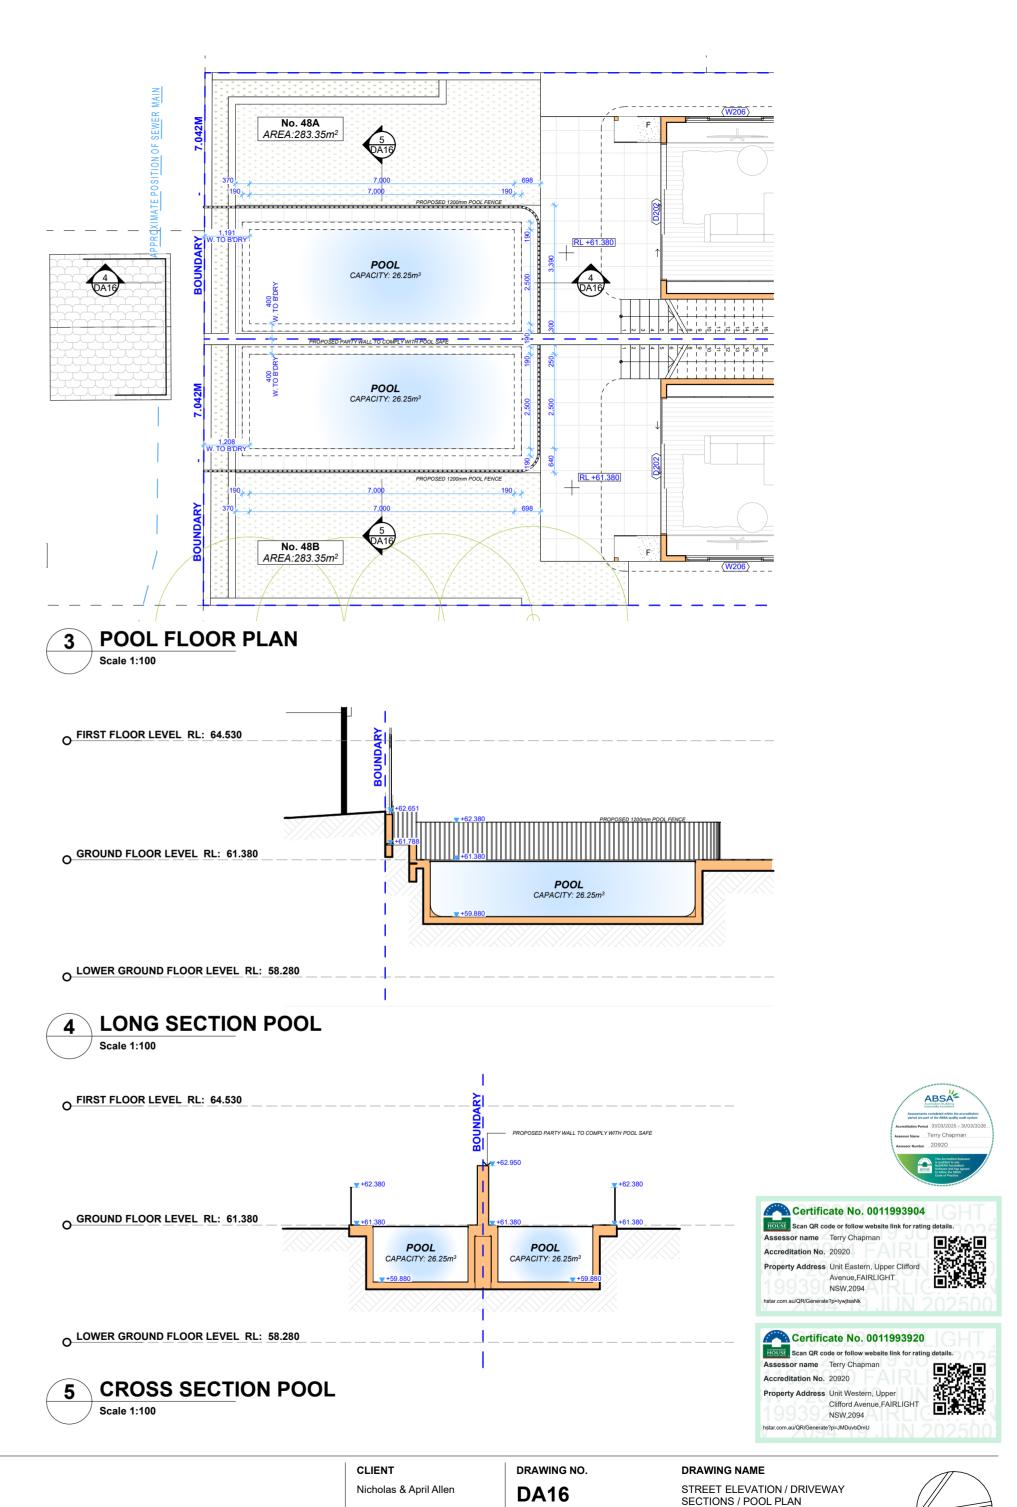

PROJECT ADDRESS

48 Upper Clifford Ave

Fairlight NSW 2094

DATE

Friday, 13 June 2025

SCALE

1:100 @A2



Certificate No. 0011993920


EXECUTE: Scan QR code or follow website link for rating details.

Assessor name Terry Chapman

Property Address Unit Western, Upper Clifford Avenue, FAIRLIGHT NSW, 2094

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	В	09.05.2025	SECOND DESIGN AMENDMENT	AP	construction, the boundary setbacks take precedence over all other dimensions. The Builder/Contractor shall check and verify ALL dimensions on site prior to commencement of any work, creation of shop drawings, or fabrication of
J	С	####	FINAL DESIGN PLAN	####	components. All errors and omissions are to be verified by the Builder/Contractor/client and
		####	####	####	referred to the designer prior to the commencement of works.

LEGEND

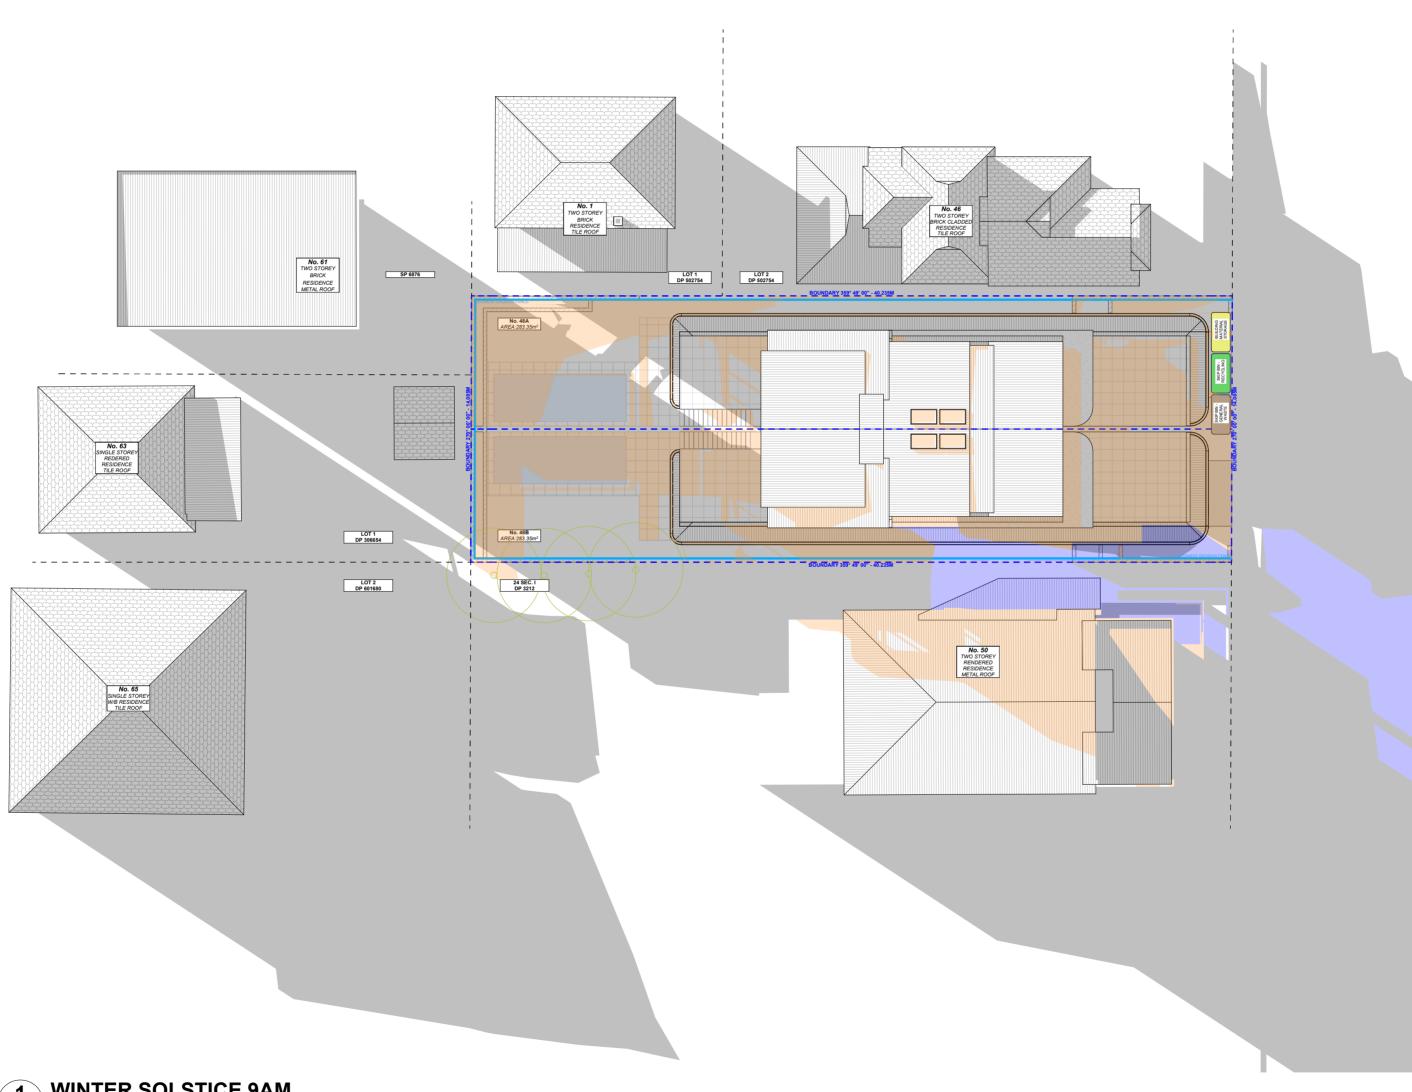EXISTING SHADOWS PROPOSED SHADOWS

NEIGHBOURING SHADOWS



PROJECT ADDRESS

48 Upper Clifford Ave Fairlight NSW 2094

DRAWING NO. **DA17**

DRAWING NAME WINTER SOLSTICE 9 AM

DATE SCALE 1:200 @A2 Friday, 13 June 2025






Certificate No. 0011993920

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Assessor name Terry Chapman Accreditation No. 20920

Property Address Unit Western, Upper Clifford Avenue, FAIRLIGHT NSW,2094 hstar.com.au/QR/Generate?p=JMDuvbDmU



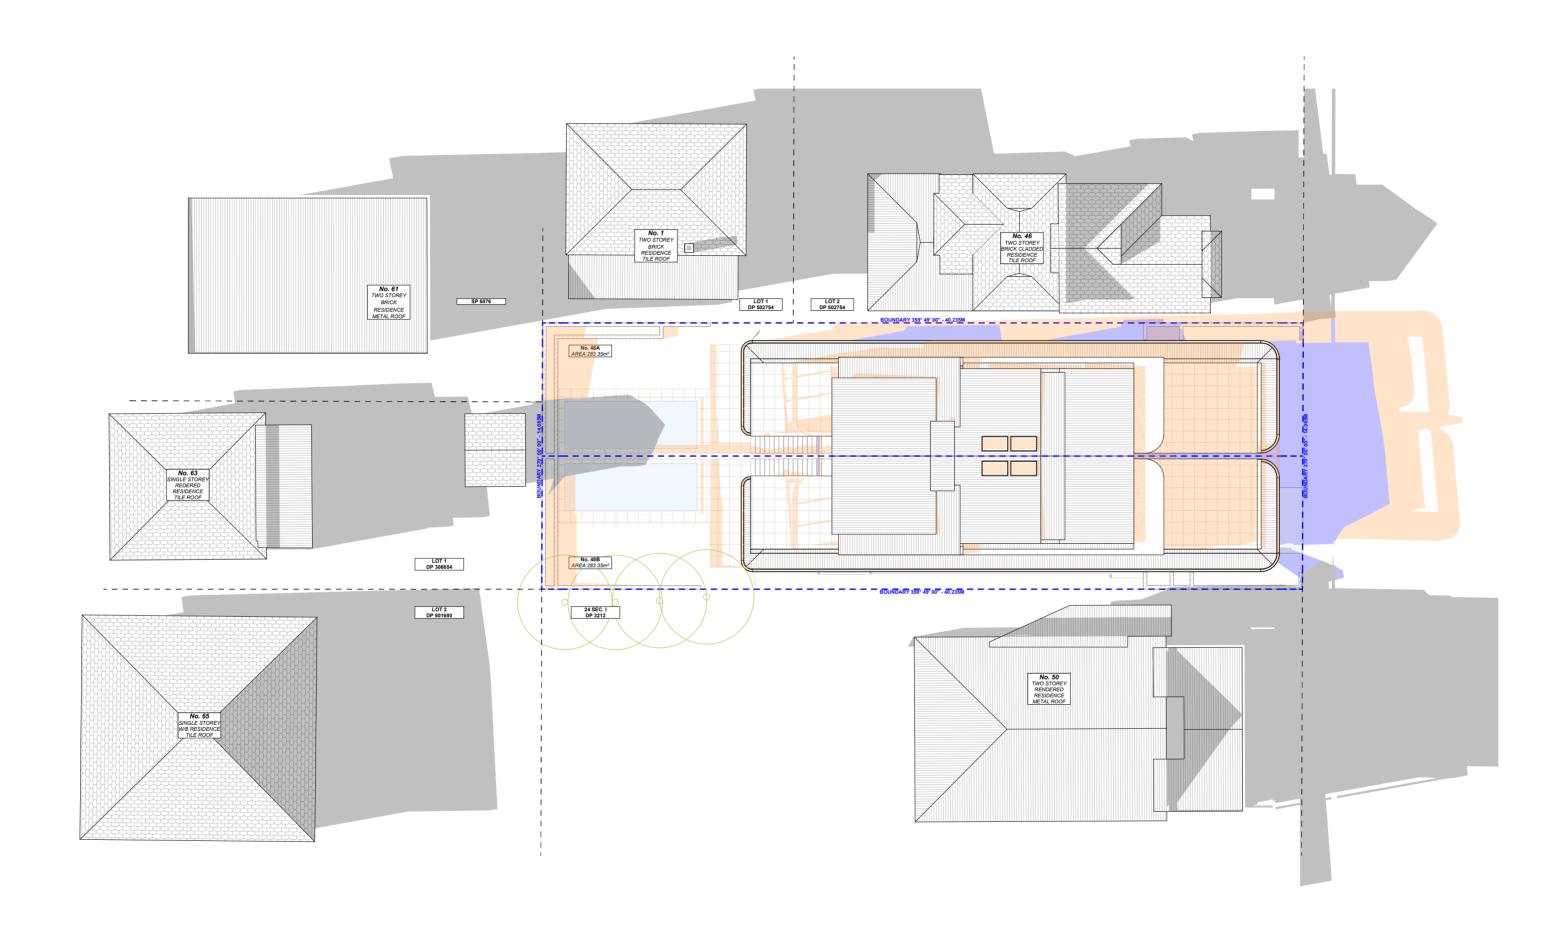

WINTER SOLSTICE 12PM



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	В	09.05.2025	SECOND DESIGN AMENDMENT	AP	construction, the boundary setbacks take precedence over all other dimensions. The Builder/Contractor shall check and verify ALL dimensions on site prior to commencement of any work, creation of shoo drawings, or fabrication of
1	С	####	FINAL DESIGN PLAN	####	components. All errors and omissions are to be verified by the Builder/Contractor/client and
		####	####	####	referred to the designer prior to the commencement of works.



CLIENT Nicholas & April Allen


DRAWING NO. **DA18**

DRAWING NAME WINTER SOLSTICE 12 PM

PROJECT ADDRESS DATE 48 Upper Clifford Ave Fairlight NSW 2094 Friday, 13 June 2025

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В	09.05.2025	SECOND DESIGN AMENDMENT	AP	construction, the boundary setbacks take precedence over all other dimensions. The Builder/Contractor shall check and verify ALL dimensions on site prior to commencement of any work, creation of shop drawings, or fabrication of
С	####	FINAL DESIGN PLAN	#### components. All errors and omissions are to be ver	components. All errors and omissions are to be verified by the Builder/Contractor/client and
	####	####	####	referred to the designer prior to the commencement of works.

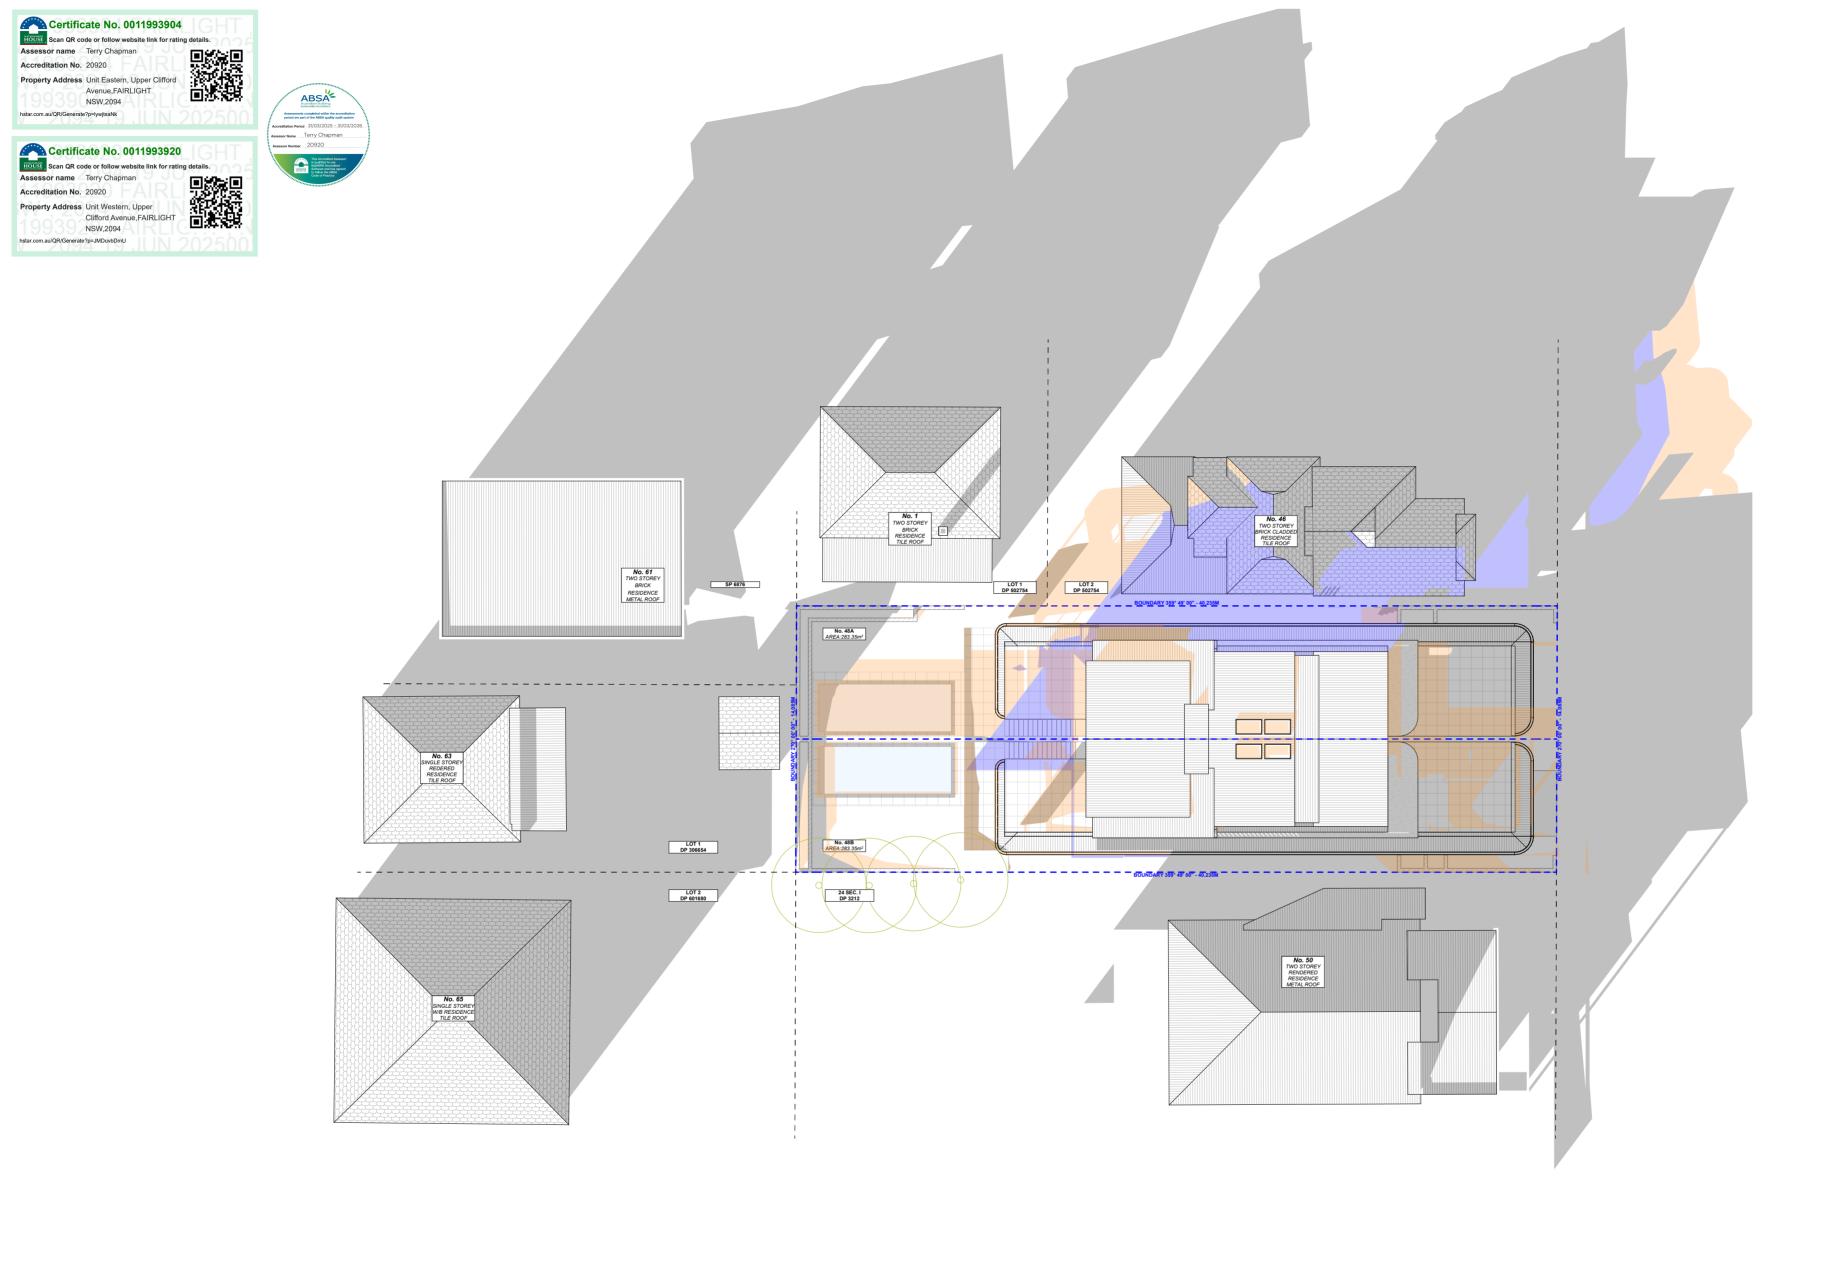

CLIENT Nicholas & April Allen

48 Upper Clifford Ave Fairlight NSW 2094

DA19 PROJECT ADDRESS DATE

DRAWING NO.

DRAWING NAME WINTER SOLSTICE 3 PM

SCALE 1:200 @A2 Friday, 13 June 2025









METAL FRAMED WINDOWS AND DOORS - COLOUR DARK PAINTED



TIMBER CLAD GARAGE DOORS



FRAMELESS BALAUSTER - CLEAR **GLASS**



STONE CLADDING



LIGHT COLOURED EXTERNAL RENDER



MIDDLE DARK METAL ROOF SHEETS

Certificate No. 0011993904

Assessor name Terry Chapman Accreditation No. 20920 Property Address Unit Eastern, Upper Clifford Avenue,FAIRLIGHT NSW,2094

Certificate No. 0011993920 Assessor name Terry Chapman Property Address Unit Western, Upper Clifford Avenue,FAIRLIGHT

COMMENTS





DRWN NOTES



REV.	DAIL	COMMENTS	DRWN	
	13.06.2025	DA: CONSULTANT REVIEW	CHL	This drawing is the copyright of Action Plans and not be altered, reproduced or transmitted in any form or by any means in part or in whole with the written permission of Action Plans. Do not scale measure from drawings. Figured dimensions are to be used only.
				The Builder/contractor/owner is to ensure that the approved boundary setbacks and approved levels are confirmed and set out by a registered Surveyor prior to construction, the boundary
				setbacks take precedence over all other dimensions. The Builder/Contractor shall check and verify ALL dimensions on site prior to commencement of
				any work, creation of shop drawings, or fabrication of components. All errors and omissions are to be verified by the Builder/Contractor/client and referred to the
				designer prior to the commencement of works.



EXIST. RL ▼ PROP. RL



PROJECT ADDRESS

48 Upper Clifford Ave

Fairlight NSW 2094

DATE Friday, 13 June 2025

DRAWING NO.

DA20

SAMPLE BOARD SCALE

DRAWING NAME

@A2





Certificate No. 0011993920 Assessor name Terry Chapman

Accreditation No. 20920 Property Address Unit Western, Upper Clifford Avenue,FAIRLIGHT NSW,2094





Dual Occupancy 48 Upper Clifford Avenue			Basix Require			Dwelling				
			Prepared by Chapman Environmental Services						\Longrightarrow	
			www.basixcertificates.co			CHA	PMAN	1		
Fairlight	NSW	2094	1300 004 914					ENVIRONME	NTAL SERVICES	
Eastern										
Water Target		40	Water Score		42					
Energy Target		72	Energy Score		76					
Max H & C Loads are (N	/J/m²)	30	Actual H & C Loads are (M	J/m²)	29.9	Star Rating				7
Western Water Target		40	Water Score		42	1				
Energy Target		72	Energy Score		76	1				
Lifeigy raiget		/2	Lifeigy Score		70	†				
Max H & C Loads are (N	/J/m²)	30	Actual H & C Loads are (M	J/m²)	29.6	Star Rating				7
,	· ,	,	,	. ,		, ,			'	
	l -	1 01	(2) 25	Basix Comm		/				0
Landscaping	l otal area of	garden & law	n (m²) 35 ea		Area or indi	genous/low w	vater use pia	ints (m-)		0
Fixtures	Shower hea	ds	4 star (> 6 but <= 7.5 L/m	nin)	Toilets	4 star		All taps	4 star	
	Is at a transmission	-:	I: (I.) 2000	Cal	last was aff f	t	f - + l + /	/ma 2\	10	
	IMINIMUM R	ainwater tan	k size (L) 2000 ea	Col	lect run off f	rom roof area	or at least ((m-)	40 ea	
Alternative Water	Toilet co	nnection	Laundry connection	Landscane	connection	Pool to	on un		Spa to	nn un
		es	Yes		'es	Ye			n/	
	•			•		•				
Pool	Max pool vo			ot require a o	cover	Pool pump	must have a	timer		
	Pool heating	g	Electric heat pump							
	Hot water s	vstem	Gas instantaneous			Rating	5 star			
	Bathroom v		Individual fan, ducted to fa	acade or roo	f	with		itch on/off		
	Kitchen ven		Individual fan, ducted to fa			with		itch on/off		
	Laundry ver	ntilation	Individual fan, ducted to fa	acade or roo	f	with		itch on/off		
Energy	Cooling - liv	ing areas	1-phase airconditioning			Rating	EER 3.0 - 3			
Lifeigy	Cooling - be		1-phase airconditioning			Rating	EER 3.0 - 3			Zoned
	Heating - liv		1-phase airconditioning			Rating	EER 3.0 - 3			Zoncu
	Heating - be		1-phase airconditioning			Rating	EER 3.0 - 3			
	Alternate Er		Photovoltaic system able t				peak kilowa			
	Induction co	ooktop & ele	ctric oven U	itdoor clothe	esline require	ed [No indoor	clothesline	required
			Thermal Performance Ass	occmont Pac	od on the Fe	llowing Pogu	iromonts			
	Concrete siz		l - Garage Level		No insulation		ill efficits			
Floor Types			d - Ground floor			slab insulation	n			
			o - Ground floor			slab insulation				
	I=				I		/= 1			
Floor Coverings	Tiles	Wet Areas			Timber		s/ Bedroom:	S		
	Carpet	n/a			Concrete	Garage				
	Timber fram	ned Polystyre	ene clad on battens	with	Sarking and	R2.5 bulk ins	ulation	Colour	Light	
External Walls	Concrete block with No insulation required Colour Light									
	Plasterboard with R2.5 bulk insulation - Garage level stairwell, F.Bath & Powder internal walls only									
Internal Walls	Plasterboar	a								internal walls only
	Blockwork			with	Garage leve	l lift well wall	5 - K1.5 IIISU	iateu piastei	DOaru	
Party Walls	Dincel									
	Constitution	novo alasta I	and timber from a d	21	- ו- ייי ב כח	lab issuits	ΛII ~~ · · ·	lovel inte	al so:!!:=	
Ceiling (floor over)			noard timber framed mber above plasterboard	with with		lab insulation loor insulatio				
	Josiiiii Aipii	a paner on ti	ilibel above plasterboard	WILII	NZ.5 UIIUEII	iooi iiisulatio	II - All groun	u noor miler	nai ceiings	
Ceilings (roof over)	Timber abov	ve plasterbo	ard.	with	R6.0 bulk in	sulation				
	IN 4 o to 1			**1	D1 2 £1 1	a mlant		C. 1	NA - di	
Roof	Metal	k Master Bed		with	R1.3 roof bl		nly	Colour	Medium	
	IZIIU LIVING &	x iviastel Beo		with	waterproof	f membrane o	лпу			
	AF single gla	azed clear co	mfort plus	Hinged Door		BRD-163-012	2-002 U-Valu	e 4.40 or less	SHGC 0.47 +	/- 5%
	to all window	s and alazed de	oors unless noted otherwise	Sliding Windo	ows				SHGC 0.60 +	
	To all williadws	J GIIG BIGTER AC	ors arriess noted other wise	Louvres		VAN-004-003	3-001 U-Valu	ie 4.70 or less	SHGC 0.49 +	·/- 5%
Windows and Dear										
Windows and Doors	AE double -	lazod alasz		Cliding Deer		I DDD 141 014	1 001 111/-1	10.2.00 or less	I SUCCIO AO :	/ E0/
	AF double g	iazeu ciear		Sliding Doors		DKU-141-U14	+-nnı n-valn	e 5.00 or less	SHGC 0.49 +	j - 570
	To all Sliding of	doors								
	AF = Aluminiu	m Framed	TB = Thermally Broken Alumini	um Framed		TF = Timber Fra	amed			
	•		•			•		_		
	•		dicates downlights, then these o			fluorescent				
1			to be fitted with self-closing dan							
			be installed in accordance with		•					
	If there is a di	screpancy betv	veen this document and the Nat	thers Certificat	e, then the Nat	ners Certificate	shall take pred	cedence		
	Fastors Hair	Coiling Form	1400mm) and Living Dining Living	ng Aron 2 0 5	odroom -					
Notes	1		1400mm) 2nd Living, Dining Livir (1400mm) 2nd Living, Living Are	-	eurooms					
	Western onli	Cennig Fails	(1700) IIII) Ziiu Livilig, Livilig Are	a & Deditionits						

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REV.	DATE	COMMENTS	DRWN
	13.06.2025	DA: CONSULTANT REVIEW	CHL

NOTES

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The Builder/Contractor shall check and verify ALL dimensions on site prior to commencement of any work, creation of shop drawings, or fabrication of components. All errors and omissions are to be verified by the Builder/Contractor/client and referred to the designer prior to the commencement of works. All window & door dimensions, orientation, glazing materials, opening types, frame types are to be confirmed by a suitably qualified person prior to the ordering of any such materials are to take place. U value takes precedence over glazing type/colour in all cases. all new glazing must meet the BASIX specified frame and glass type, \(QR \) meet the ecified U value and SHGC value.

CLIENT

Nicholas & April Allen


DRAWING NO. **DA21**

DRAWING NAME BASIX COMMITMENTS

PROJECT ADDRESS

48 Upper Clifford Ave Fairlight NSW 2094

DATE Friday, 13 June 2025

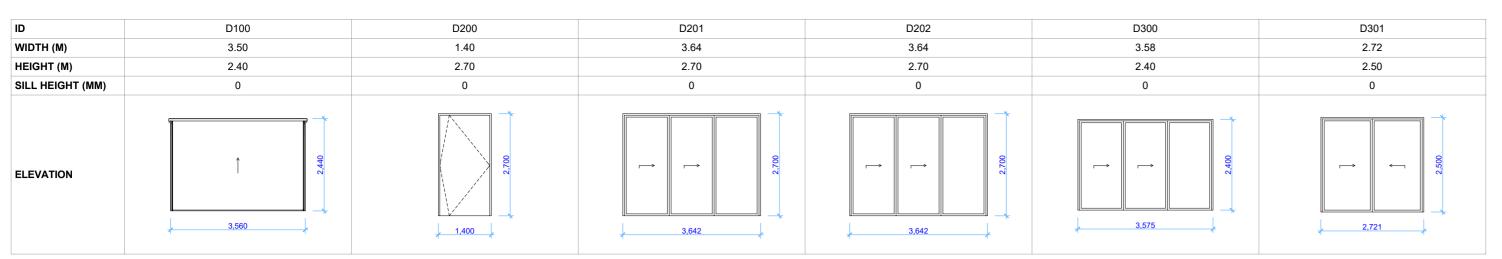



Property Address Unit Western, Upper

hstar.com.au/QR/Generate?p=JMDuvbDmU

Clifford Avenue,FAIRLIGHT NSW,2094



ID	S01	S02
WIDTH (M)		
HEIGHT (M)		
SILL HEIGHT (MM)		
ELEVATION	√ 780 Å	780

2 SKYLIGHT SCHEDULE Scale 1:1

ID	W200	W201	W203	W204	W205	W206	W300	W301
WIDTH (M)	2.65	0.60	2.65	2.00	2.65	2.65	1.00	4.12
HEIGHT (M)	0.85	1.50	1.60	0.70	1.60	0.85	1.87	2.20
SILL HEIGHT (MM)	1,650	1,000	900	1,800	900	1,650	530	200
ELEVATION	2,650	, 600 J	2,650	2,000	2,650	2,650	1,000	4,118
ID	W302	W304	W304					
WIDTH (M)	1.87	0.75	2.72					
HEIGHT (M)	0.55	1.50	0.70					
SILL HEIGHT (MM)	1,650	1,000	2,897					

3 WINDOWS SCHEDULE Scale 1:1

1,870


ELEVATION

WINDOWS AND DOOR SCHEDULE WESTERN SIDE

		ı
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1		
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752



EXIST. RL

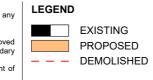

PROJECT ADDRESS


48 Upper Clifford Ave Fairlight NSW 2094

Friday, 13 June 2025

DRAWING NAME

SCALE 1:1 @A2



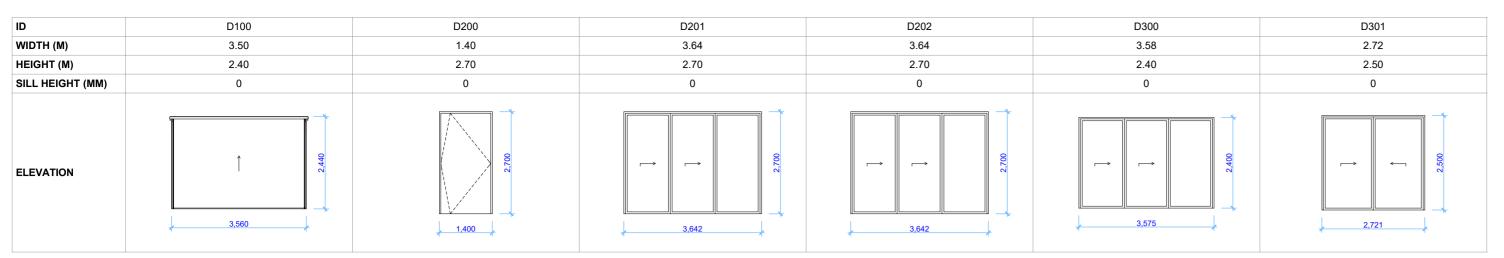

Certificate No. 0011993904 Assessor name Terry Chapman
Accreditation No. 20920
Property Address Unit Eastern, Upper Clifford
Avenue, FAIRLIGHT
NSW.2094 NSW,2094 hstar.com.au/QR/Generate?p=lywjtsaNk Certificate No. 0011993920

Scan QR code or follow website link for rating details.

Assessor name Terry Chapman

Clifford Avenue,FAIRLIGHT NSW,2094

Accreditation No. 20920 Property Address Unit Western, Upper



ID	S01	S02
WIDTH (M)		
HEIGHT (M)		
SILL HEIGHT (MM)		
ELEVATION	780	780



ID	W200	W201	W203	W204	W205	W206	W300	W301
WIDTH (M)	2.65	0.60	2.65	2.00	2.65	2.65	1.00	4.12
HEIGHT (M)	0.85	1.50	1.60	0.70	1.60	0.85	1.87	2.20
SILL HEIGHT (MM)	1,650	1,000	900	1,800	900	1,650	530	200
ELEVATION	2,650	600	2,650	2,000	2,650	2,650	1.000	4,118
ID	W302	W304	W304					
WIDTH (M)	1.87	0.75	2.72					
HEIGHT (M)	0.55	1.50	0.70					
SILL HEIGHT (MM)	1,650	1,000	2,897					

3 WINDOWS SCHEDULE Scale 1:1

1,870

ELEVATION

WINDOWS AND DOOR SCHEDULE EASTERN SIDE



	REV.	DATE	COMMENTS	DRWN	1			
3		13.06.2025	DA: CONSULTANT REVIEW	CHL	This drawing is the copyright of Action Plans and not be altered, reproduced or transmitted in any form or by any means in part or in whole with the written permission of Action Plans.			
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752




≠EXISTING RL PROPOSED RL CLIENT Nicholas & April Allen

DRAWING NO. **DA23**

> DRAWING NAME WINDOWS AND DOOR SCHEDULE EASTERN SIDE

PROJECT ADDRESS DATE 48 Upper Clifford Ave Fairlight NSW 2094 Friday, 13 June 2025

SCALE 1:1 @A2

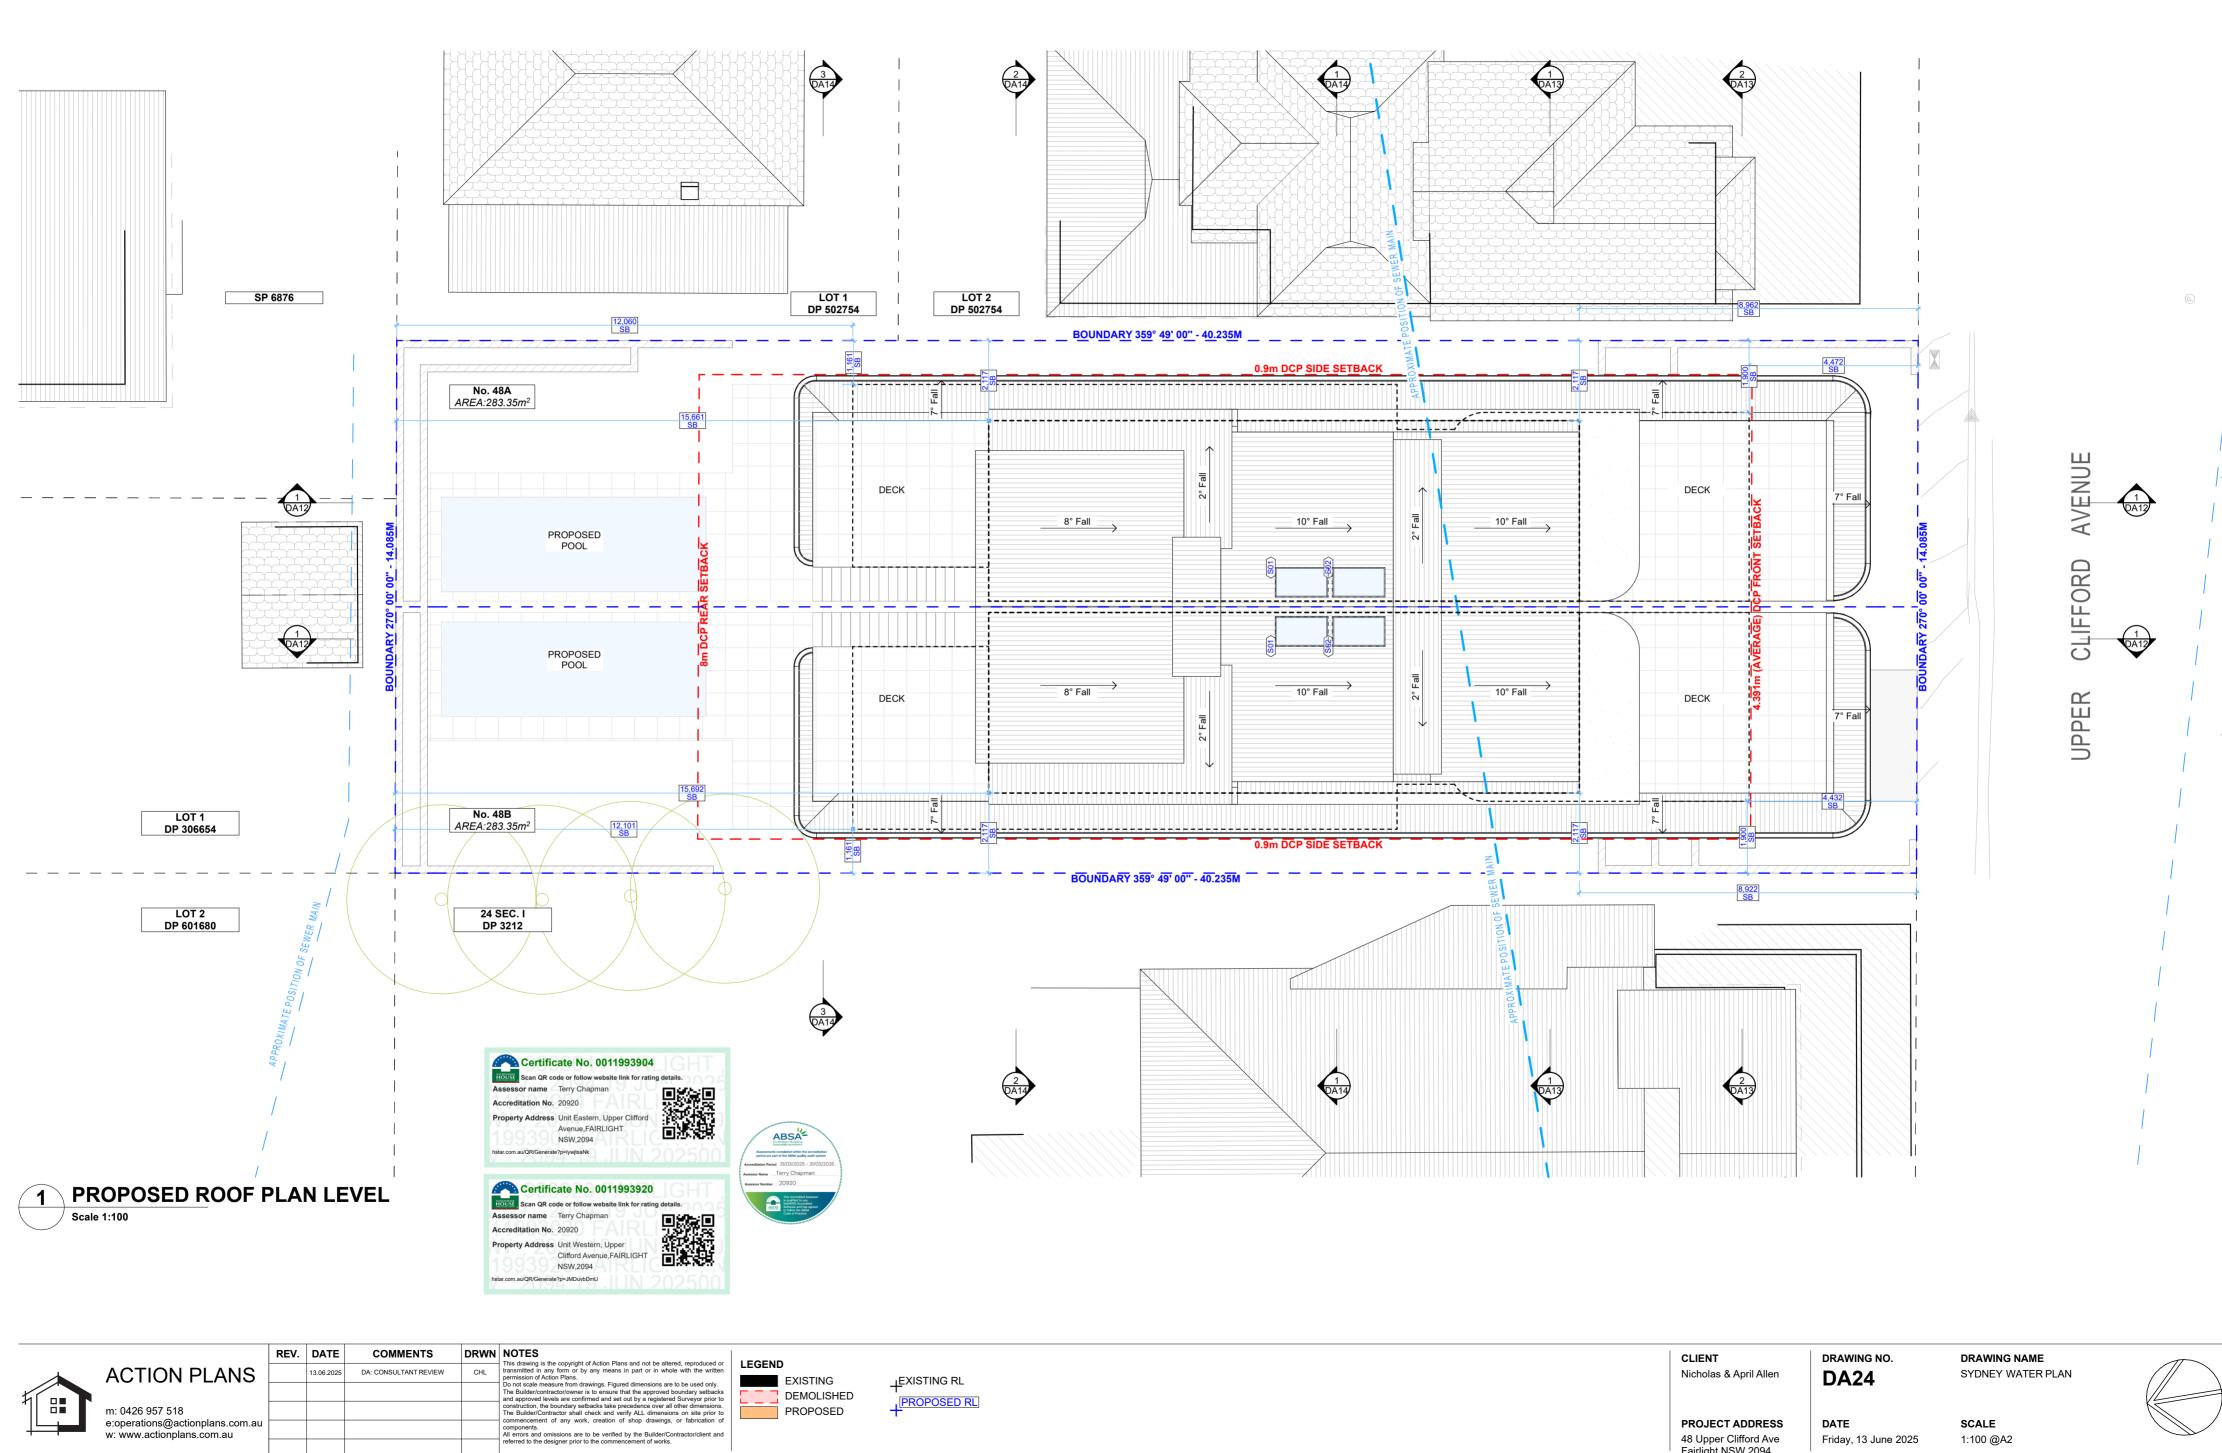

EXISTING

DEMOLISHED

PROPOSED

≠EXISTING RL

PROPOSED RL

ACTION PLANS

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w: www.actionplans.com.au

m: 0426 957 518

SYDNEY WATER PLAN

SCALE

1:100 @A2

Nicholas & April Allen

PROJECT ADDRESS

48 Upper Clifford Ave

Fairlight NSW 2094

DA24

Friday, 13 June 2025

DATE