

All dimensions shown are to frame, underside of roof trusses and FFL (concrete) to underside of floor joist

FFL denotes - concrete level floor joist + selected flooring

All construction work to comply with the NCC and all relevant Australian standards

All previous issues are to be discarded only these plans are to be read

rev	amendment	date	rev	amendment	dat
A B C D E	FD AMENDMENT AMENDMENT AMENDMENT FFD DA SUBMISSION	16.02.25 07.03.25 18.03.25 06.04.25 29.05.25			



for / client
MR AND MRS WANG
TITLE


location
LOT34/35, 231-233 McCARRS CREEK RD
CHURCH POINT
NORTHERN BEACHES COUNCIL
DO NOT SCALE DRAWINGS
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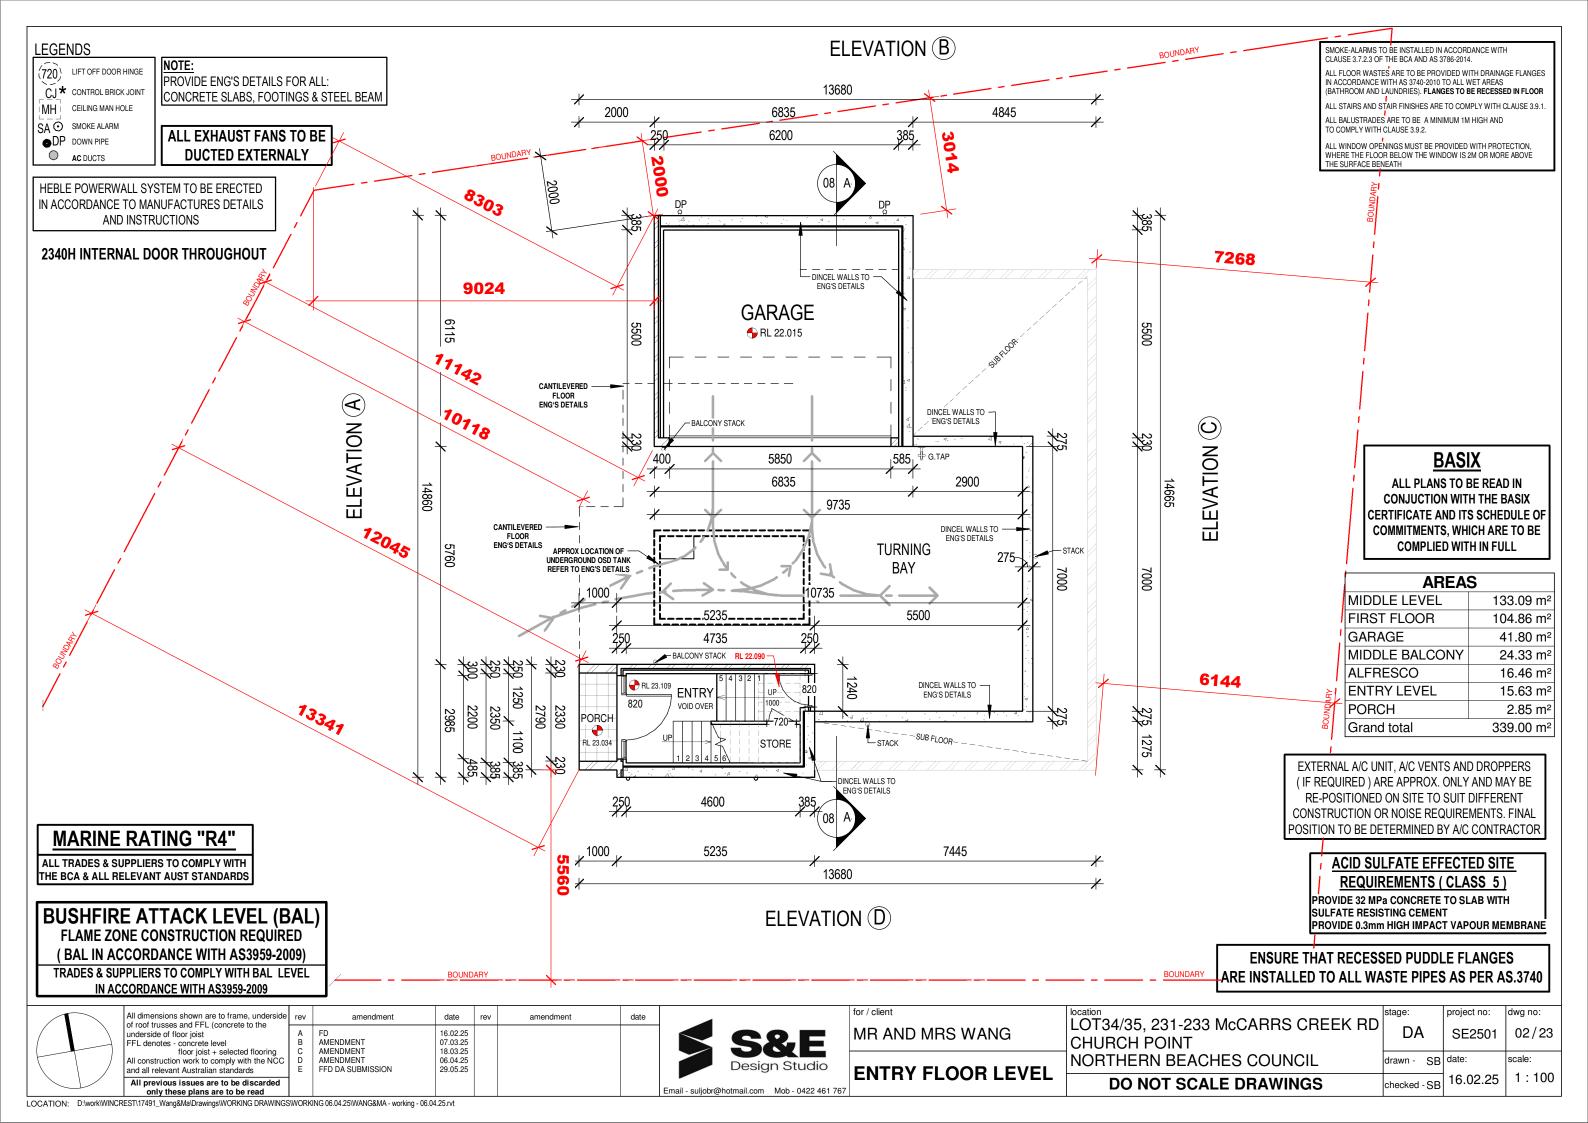
 K RD
 stage:
 project no:
 dwg no:


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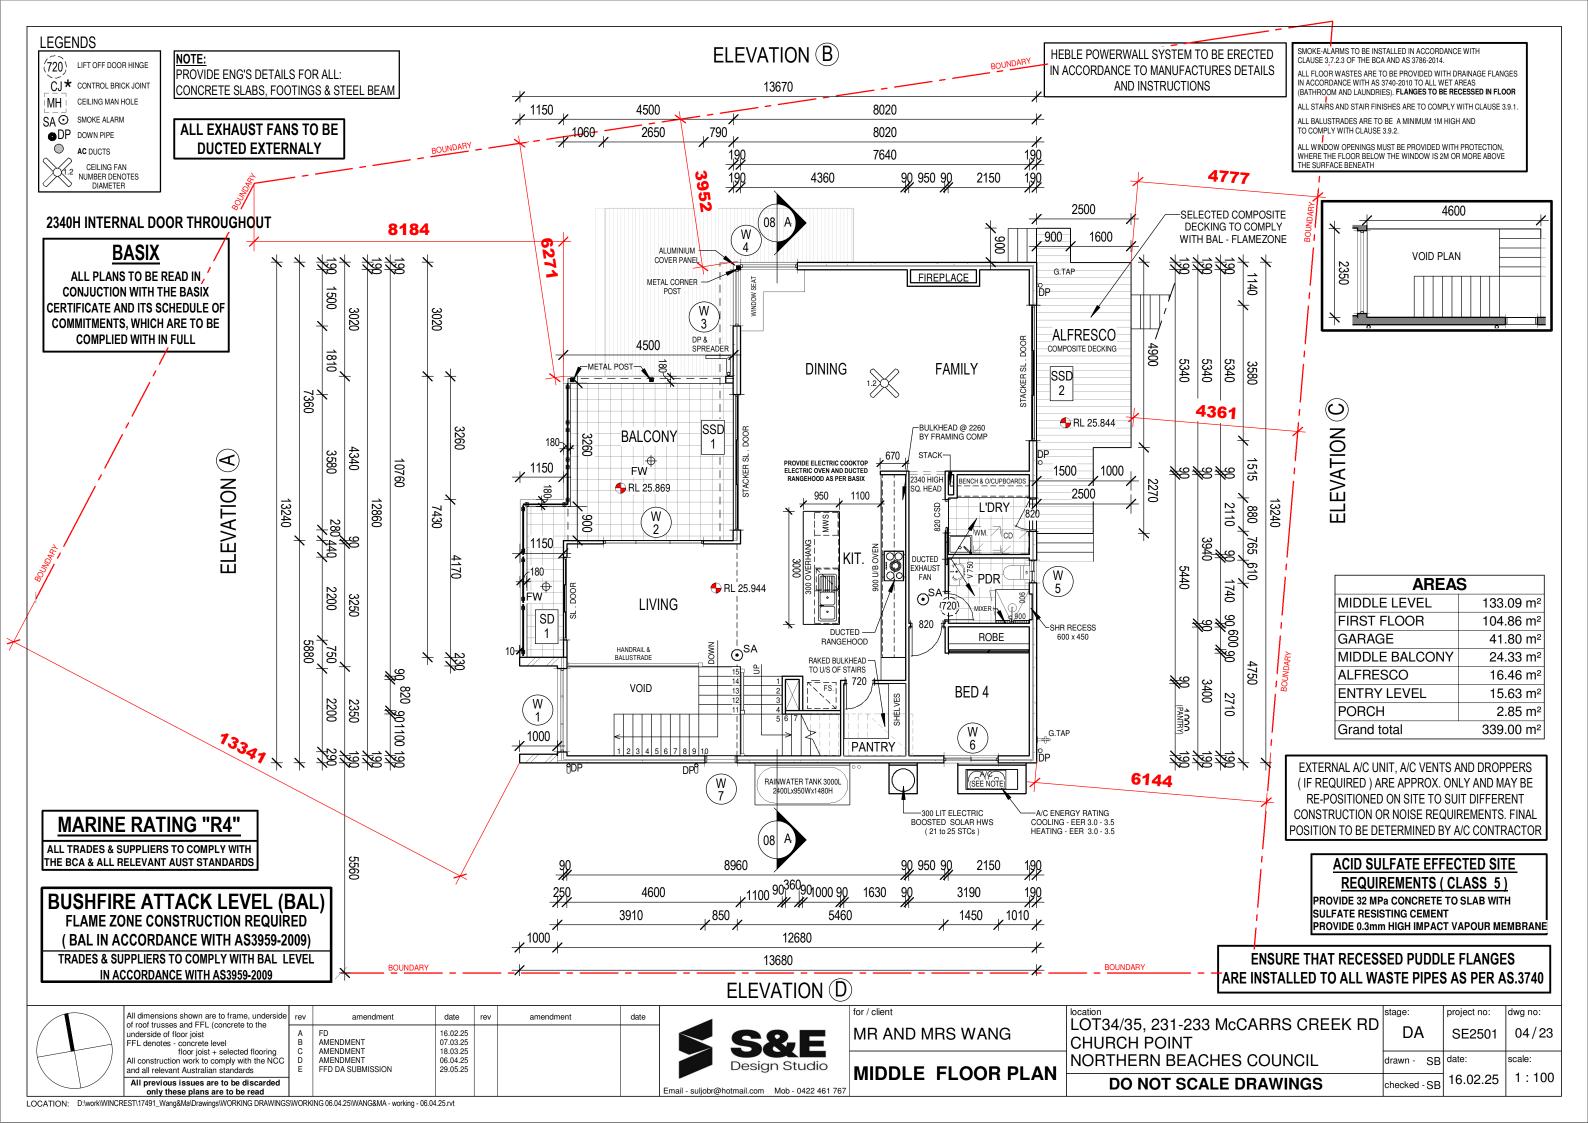
 drawn - SB
 date:
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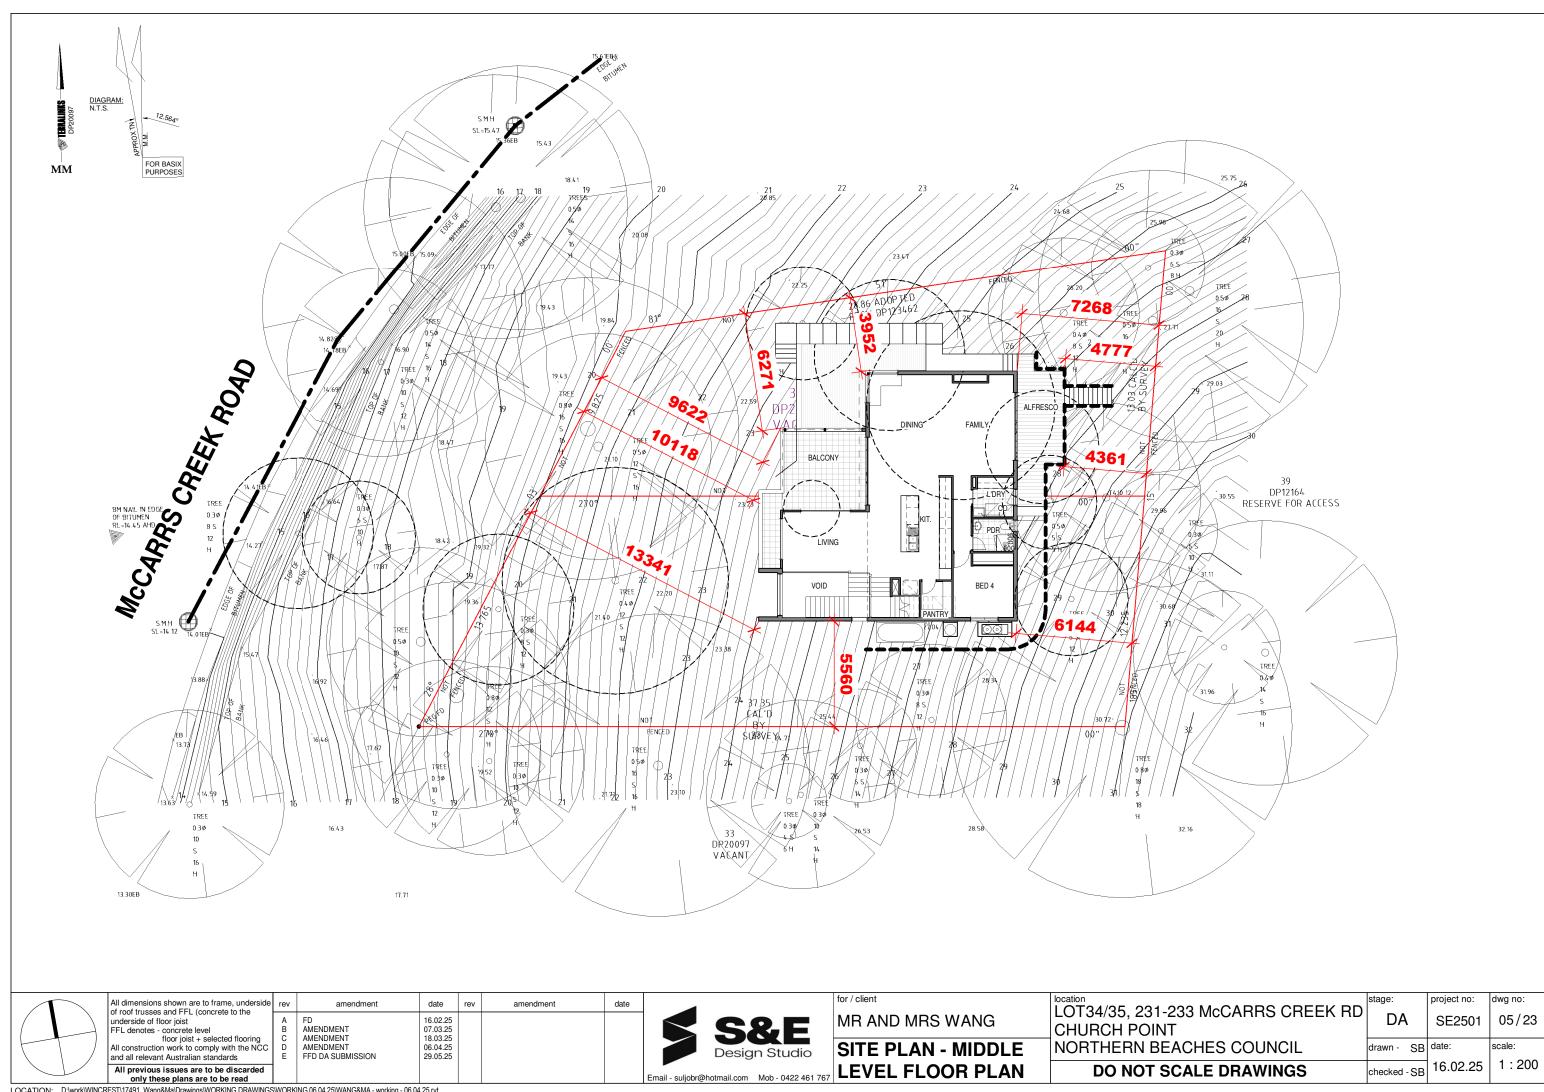
 checked - SB
 16.02.25










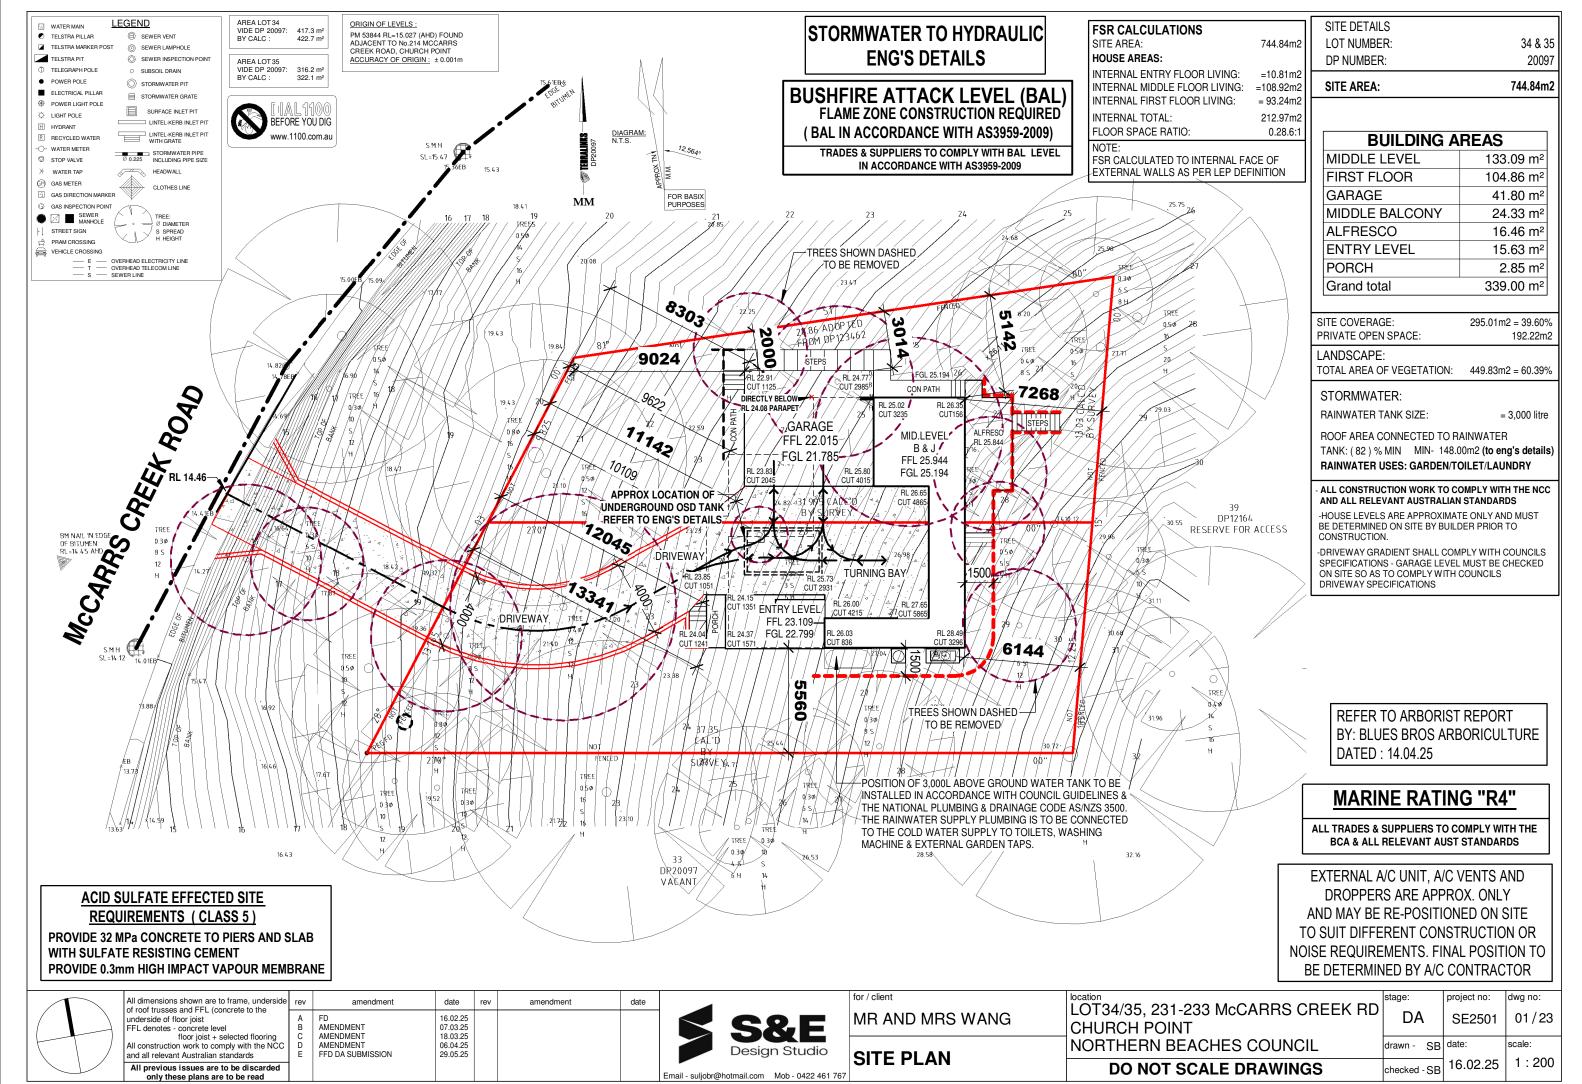


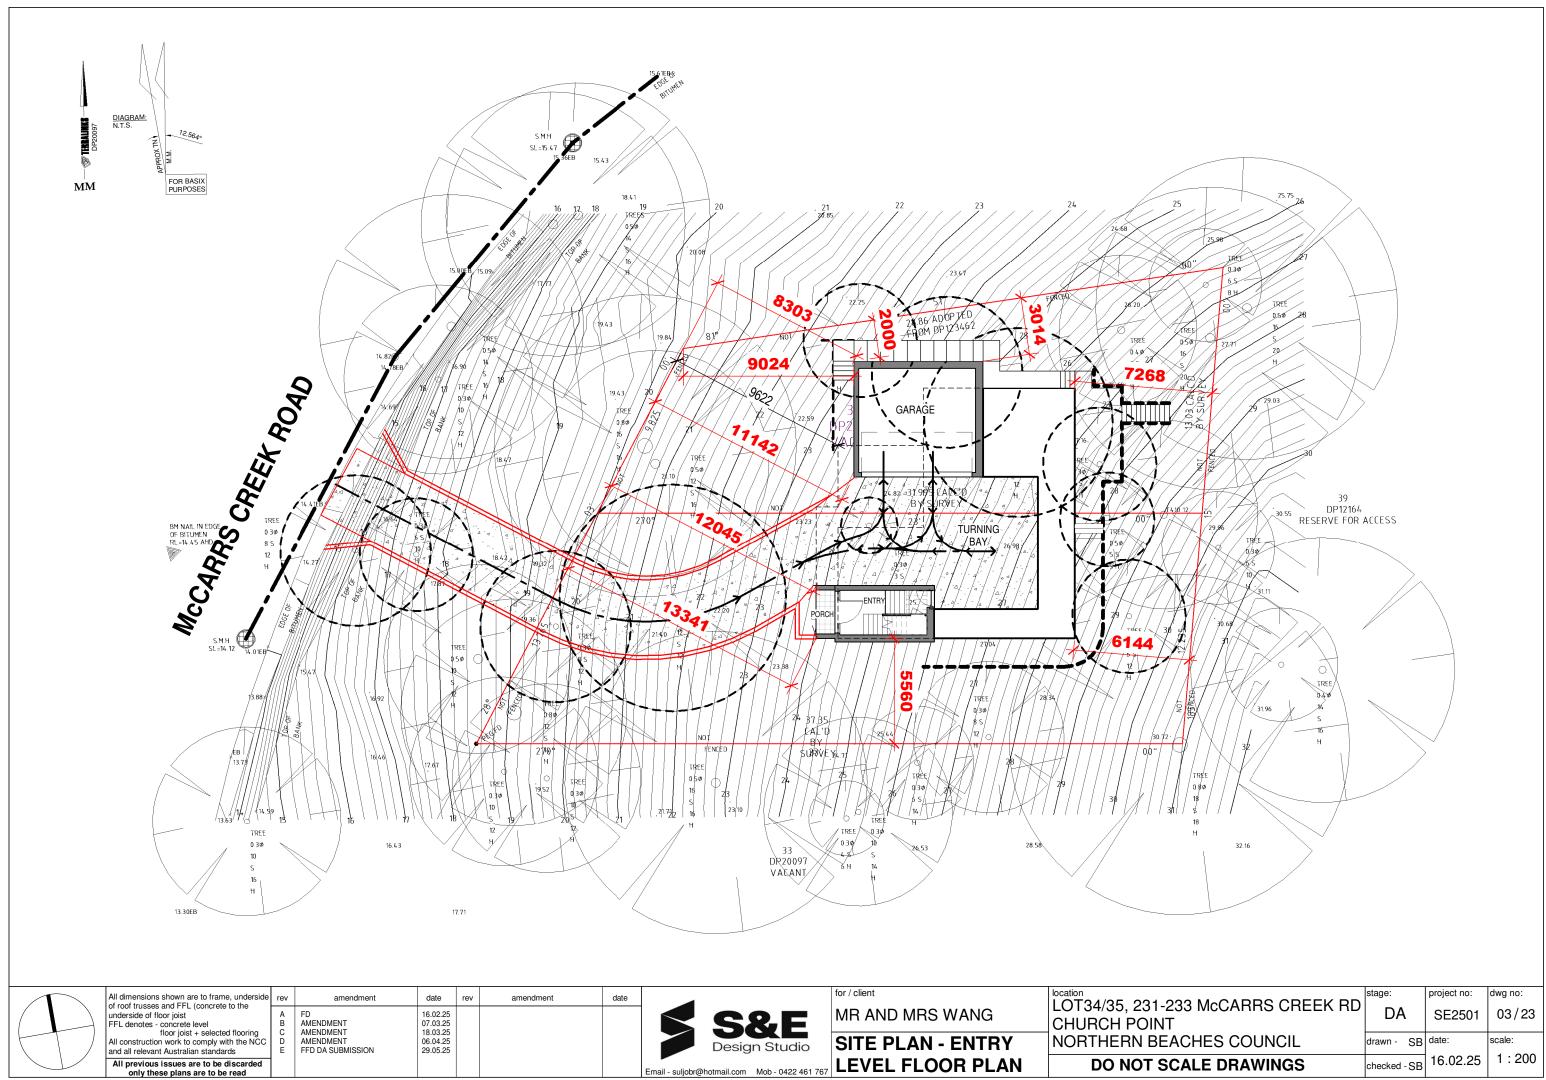


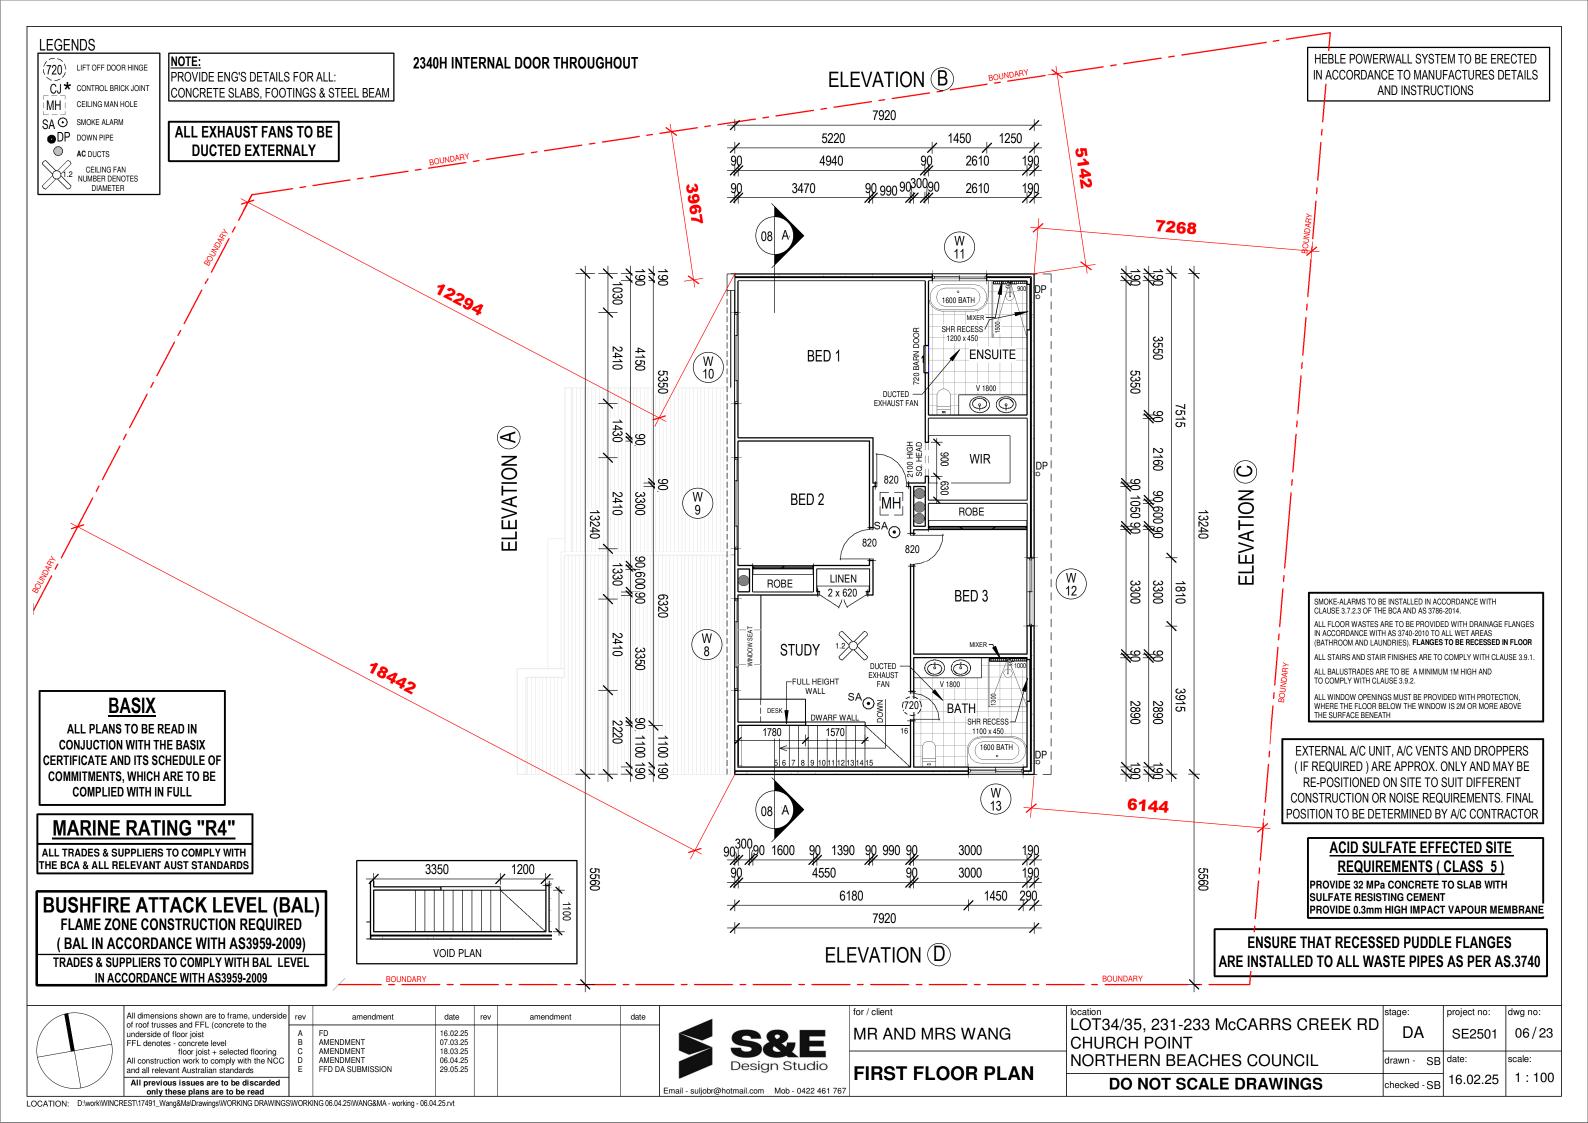


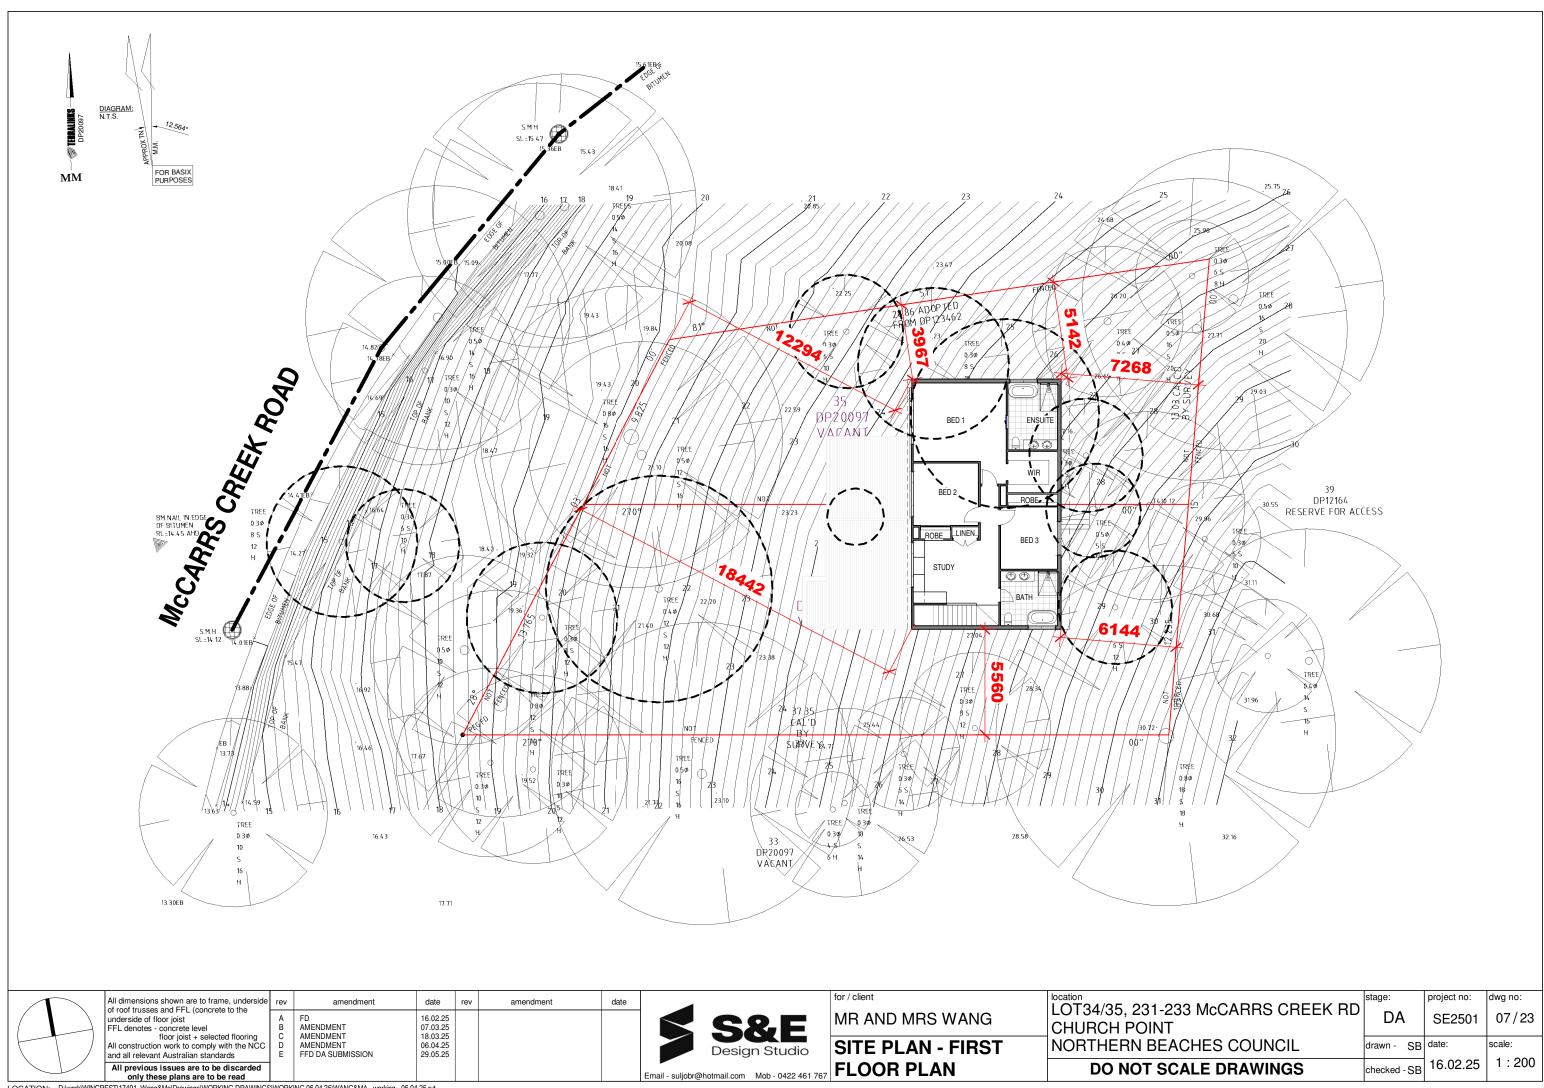

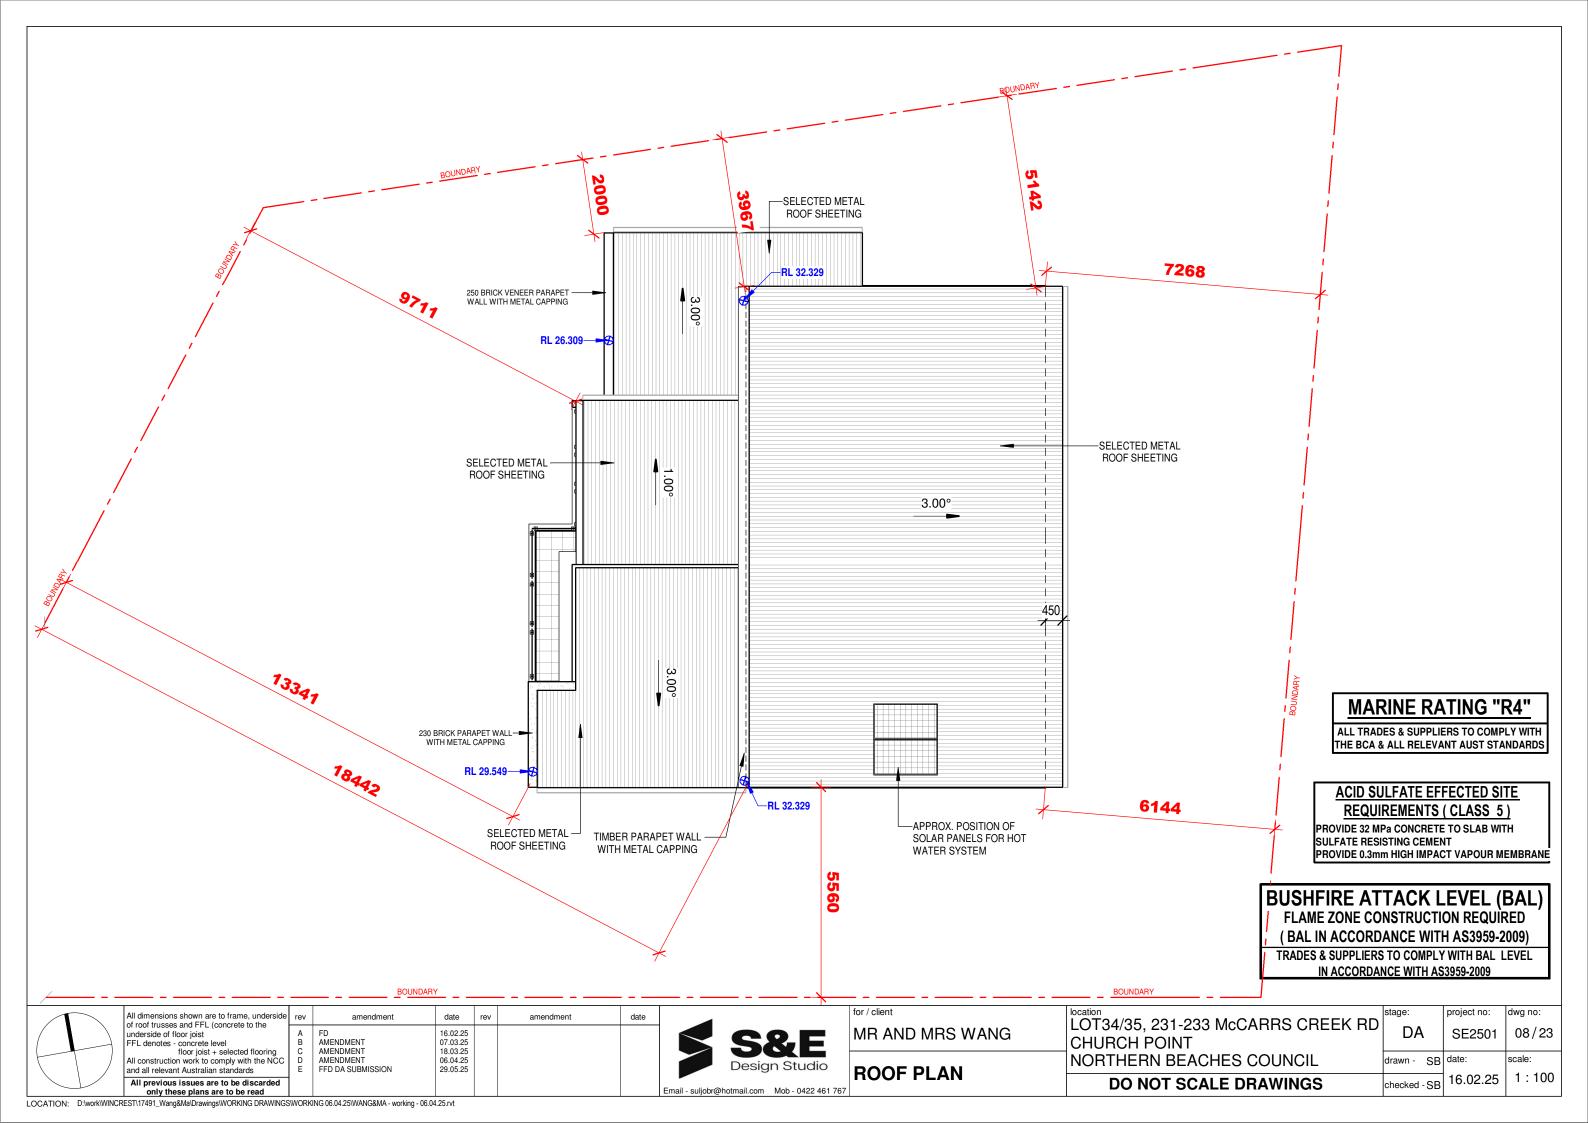

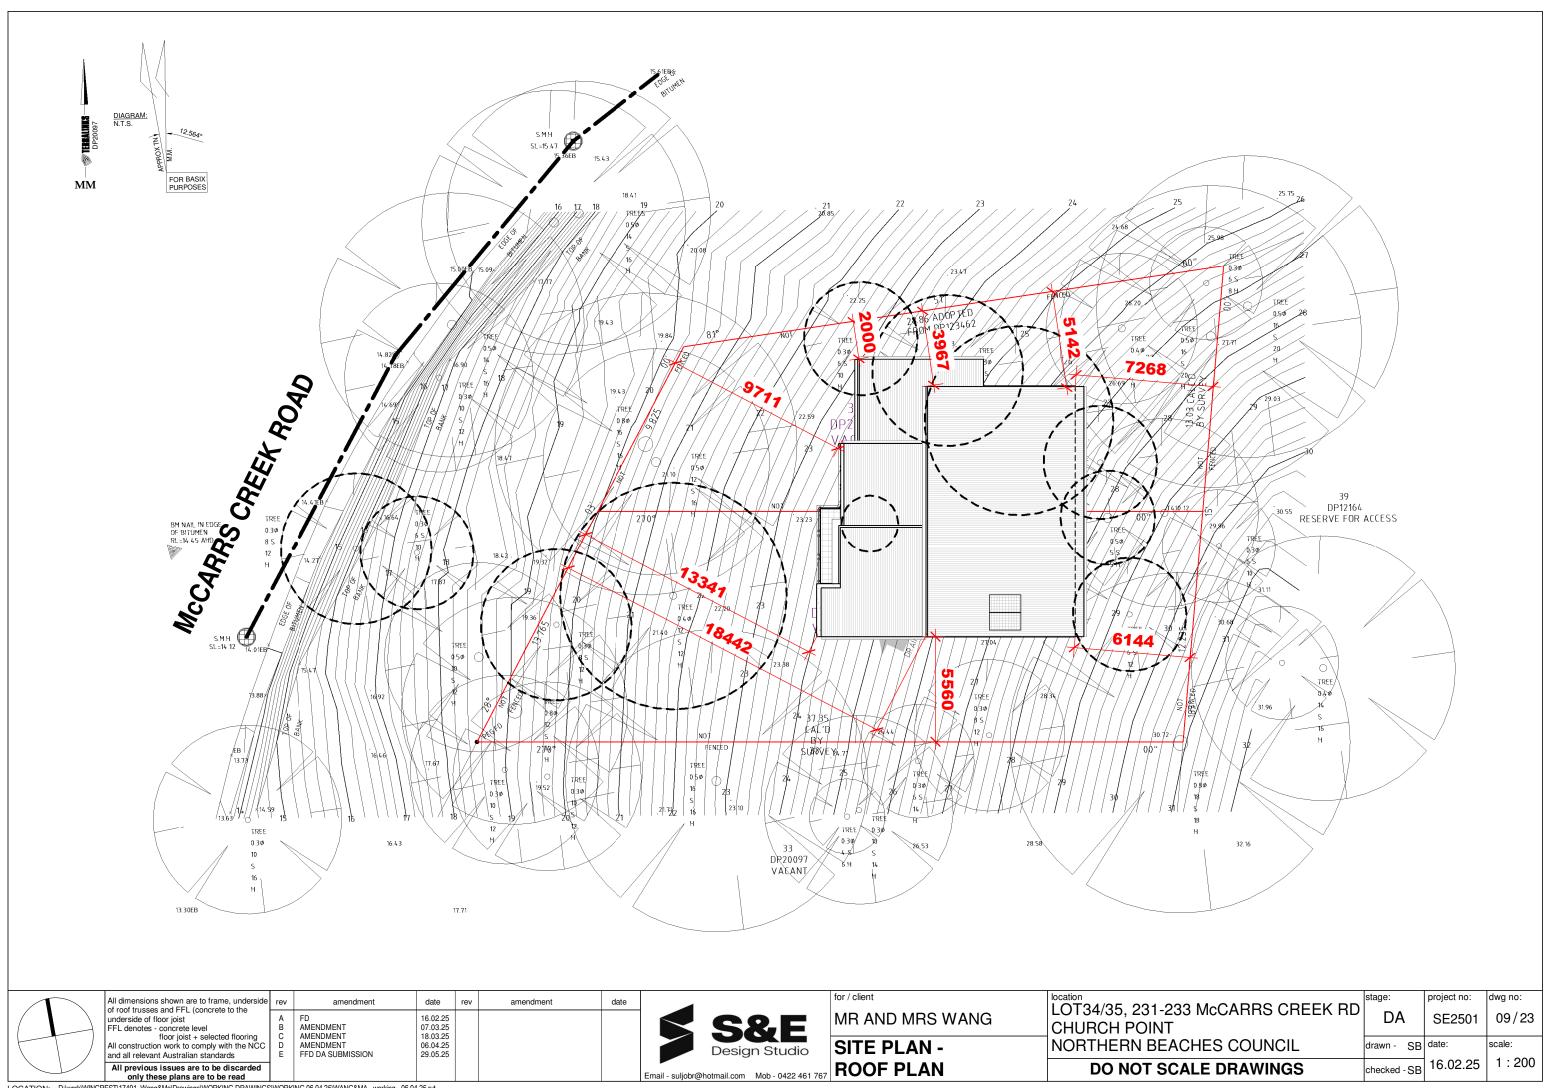

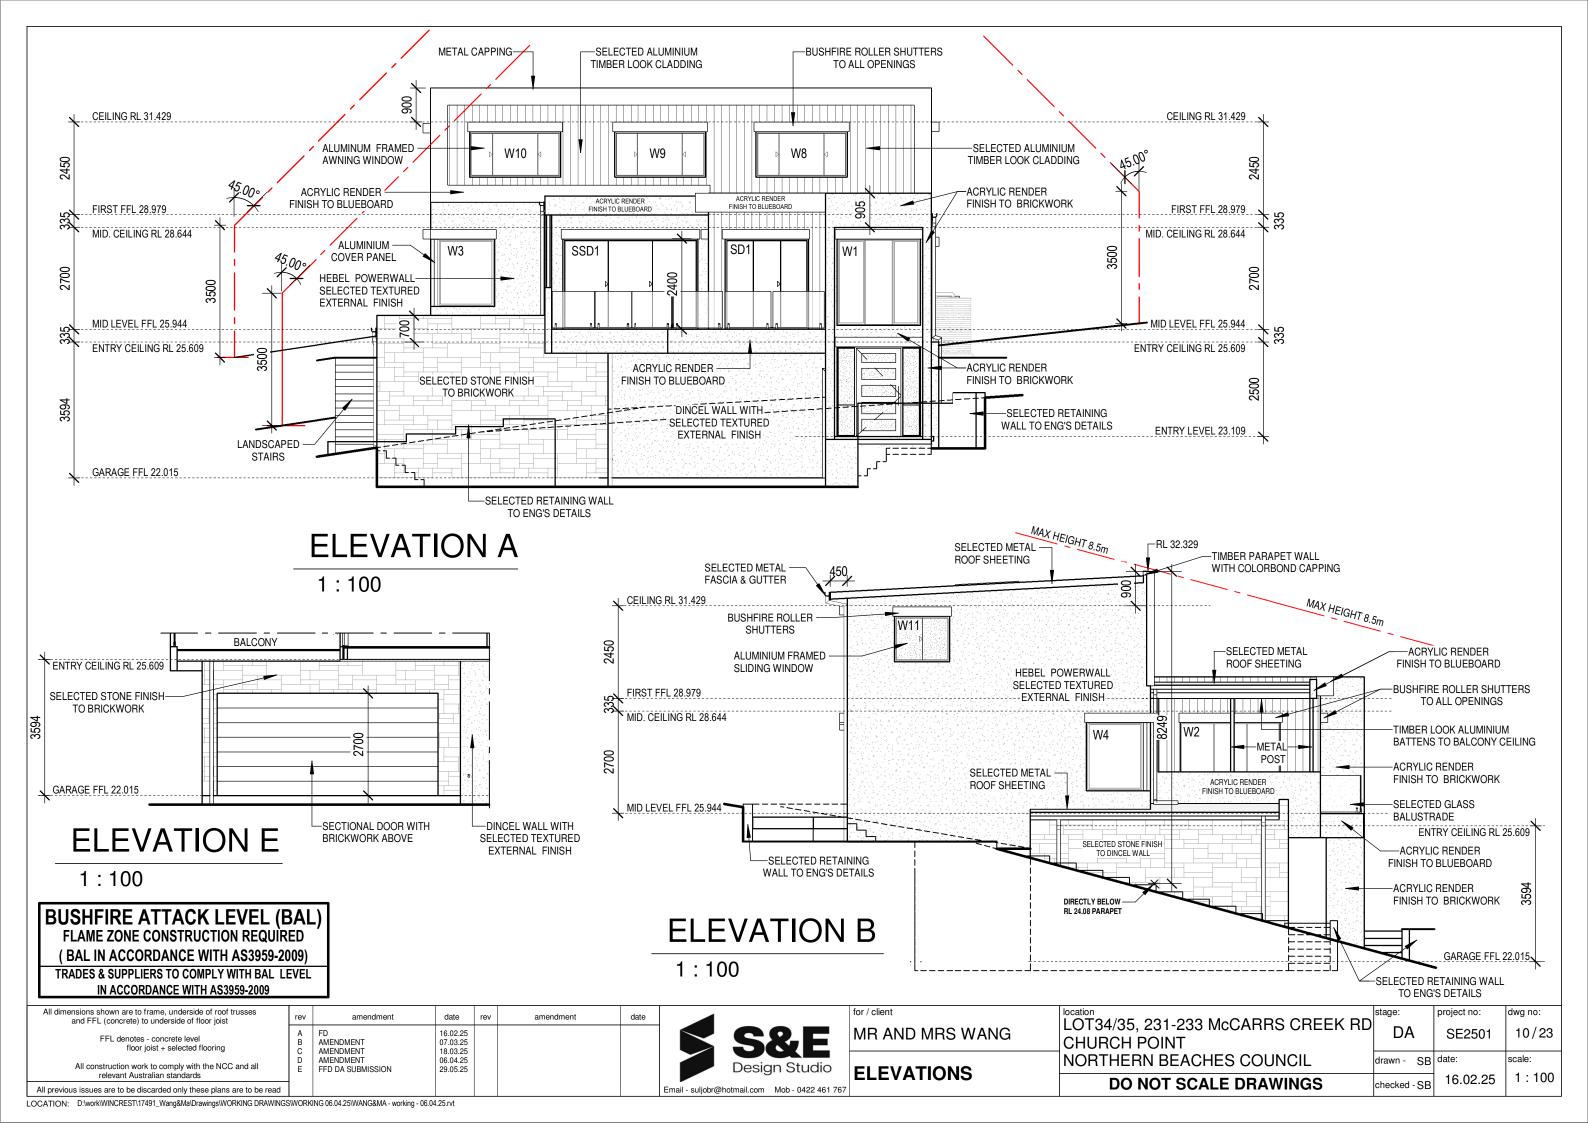

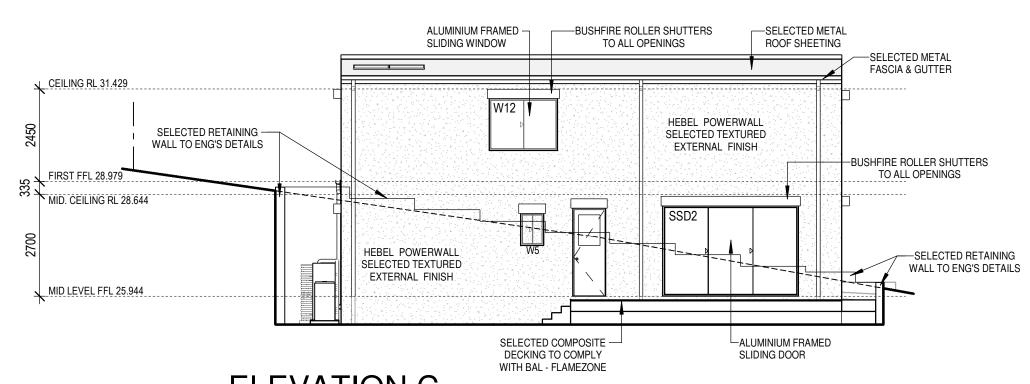


BUSHFIRE ATTACK LEVEL (BAL)
FLAME ZONE CONSTRUCTION REQUIRED
(BAL IN ACCORDANCE WITH AS3959-2009)

TRADES & SUPPLIERS TO COMPLY WITH BAL LEVEL
IN ACCORDANCE WITH AS3959-2009


**ELEVATION C** 

1:100

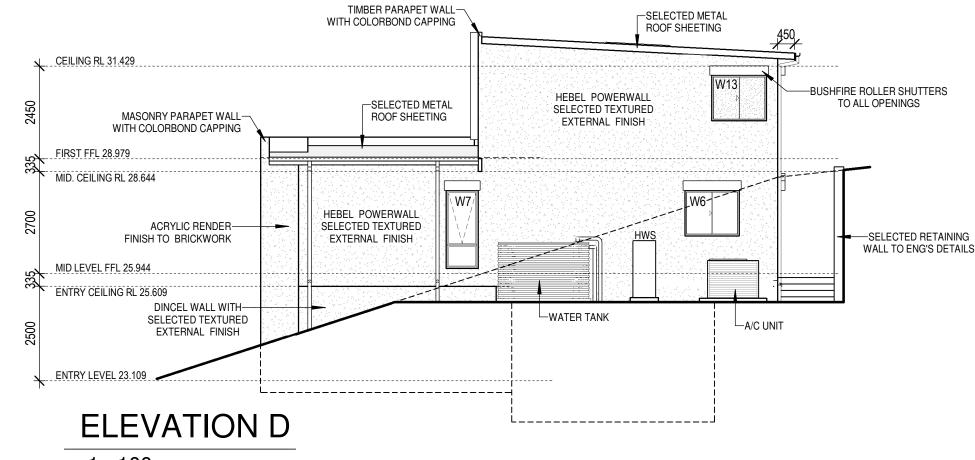

1:100

All dimensions shown are to frame, underside of roof trusses and FFL (concrete) to underside of floor joist project no: dwg no: LOT34/35, 231-233 McCARRS CREEK RD DA FD AMENDMENT AMENDMENT 16.02.25 07.03.25 11/23 MR AND MRS WANG SE2501 FFL denotes - concrete level floor joist + selected flooring **CHURCH POINT** 18 03 25 AMENDMENT FFD DA SUBMISSION NORTHERN BEACHES COUNCIL SB date: scale: 29.05.25 **ELEVATIONS** relevant Australian standards 1:100 16.02.25 DO NOT SCALE DRAWINGS checked - SB All previous issues are to be discarded only these plans are to be read

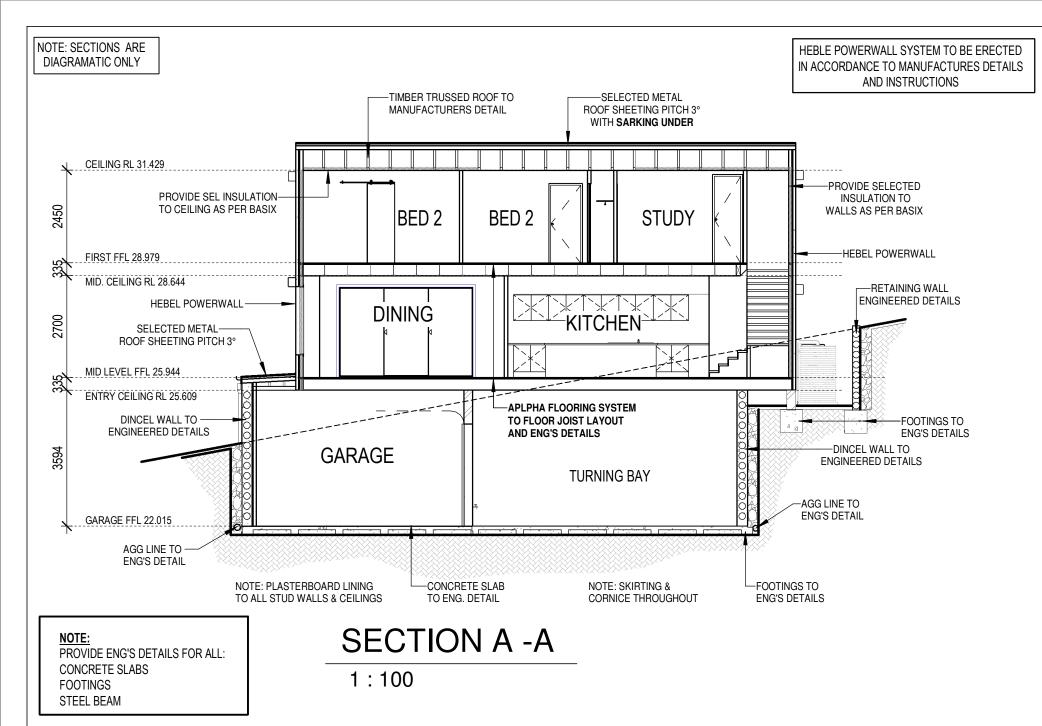

	Window and SI . door Schedule									
wt	wt Window No. Height Width Window Style Glazing									
W	1	2300	2200	FIXED	CLEAR LOW e TB - DOUBLE					
W	2	2400	2650	FIXED	CLEAR LOW e TB - DOUBLE					
W	3	1800	1500	FIXED	CLEAR LOW - E					
W	4	1800	1500	FIXED	CLEAR LOW - E					
W	5	857	610	SLIDING	OBSCURE / TG					
W	6	1200	1450	SLIDING	CLEAR LOW e TB - DOUBLE					
W	7	2057	850	AWNING	CLEAR LOW e TB - DOUBLE					
W	8	1200	2410	SLIDING	CLEAR LOW e TB - DOUBLE					
W	9	1200	2410	SLIDING	CLEAR LOW e TB - DOUBLE					
W	10	1200	2410	SLIDING	CLEAR LOW e TB - DOUBLE					
W	11	1200	1450	SLIDING	CLEAR LOW e TB - DOUBLE					
W	12	1372	1810	SLIDING	CLEAR LOW e TB - DOUBLE					
W	13	1200	1450	SLIDING	OBSCURE / TG					
SSD	1	2400	3580	STACKER SL.DOOR	CLEAR LOW e TB - DOUBLE					
SSD	2	2400	3580	STACKER SL.DOOR	CLEAR LOW e TB - DOUBLE					
SD	1	2400	2200	SLIDING DOOR	CLEAR LOW e TB - DOUBLE					

TG - DENOTES TOUGHENED GLASS

NOTE: ALL WINDOW FRAMES AND GLASS TO COMPLY WITH BASIX CERTIFICATE

To Cantilever/Suspended Floor Coverings

ALL BED ROOM WINDOW OPENINGS HIGHER THAN 2.0m FROM FINISHED GROUND LEVEL TO BE PROTECTED IN ACCORDANCE WITH CLAUSE 3.9.2.6 VOLUME 2 OF THE BUILDING CODE OF AUSTRALIA

### **MARINE RATING "R4"**

**ALL TRADES & SUPPLIERS TO COMPLY WITH** THE BCA & ALL RELEVANT AUST STANDARDS

## **GENERAL NOTES:**

- PROVIDE PEST CONTROL SYSTEM TO PERIMETER OF HOME AS REQUIRED BY CERTIFYING AUTHORITY.
- AS/NZS 3000-2000 ELECTRICAL REQUIREMENTS: SAFETY SWITCH TO FRIDGE & LIGHT CIRCUITS; ISOLATING SWITCH FOR WALL OVEN.
- PROVIDE GLASSWOOL CEILING INSULATION TO ROOF SPACE OF LIVING AREAS, AS PER BASIX
- PROVIDE GLASSWOOL WALL INSULATION TO EXTERNAL WALLS OF LIVING AREAS. AS PER BASIX
- PROVIDE SHOWERHEAD MINIMUM RATING AS PER BASIX
- KITCHEN, LAUNDRY & VANITY BASIN TAPS AS PER BASIX
- TOILET CISTERNS AS PER BASIX
- PROVIDE 3000 LITRE RAIN WATER TANK
- ARTIFICIAL LIGHT REQUIREMENTS TO BE AS PER BASIX
- 300 LIT ELECTRIC BOOSTED SOLAR HWS (21 to 25 STCs)
- 75mm GAP BETWEEN FRIDGE & WALL TO BE MAINTAINED
- MANHOLE POSITION IS APPROXIMATE ONLY AND MAY BE RE-POSITIONED ON SITE TO SUIT CONSTRUCTION CONSTRAINTS OR REQUIREMENTS

# ALL PLANS TO BE READ IN **CONJUCTION WITH THE BASIX** CERTIFICATE AND ITS SCHEDULE OF

BASIX

**Floors** 

Material

COMMITMENTS, WHICH ARE TO BE 1st Floor **COMPLIED WITH IN FULL** 

Alphafloor R2.0 Insulation Tiles to Entry and Liv/Kit Ground R2.0 Insulation R2.0 Insulation 1st Floor Timber Waffle Pod 225mm Basement Walls Colour **External Material** Ground Default ACC Hebel Timber Frame R2.5, Non Reflective Wrap 1st Floor ACC Hebel / F.Cement Timber Frame R2,5, Non Reflective Wrap Default NIL/R2.5. Non Reflective Wra Default Dincel wall / Brick veneer No insulation to garage walls Garage Ceilings Insulation to Roof Above Sarking Ground Plaster Timber Frame Ground Metal Default Plaster Timber Frame R5.0 1st Floor Sarking Metal Default

Added Insulation

BUSHFIRE ATTACK LEVEL (BAL) FLAME ZONE CONSTRUCTION REQUIRED (BAL IN ACCORDANCE WITH AS3959-2009)

TRADES & SUPPLIERS TO COMPLY WITH BAL LEVEL IN ACCORDANCE WITH AS3959-2009

> ALL BUILDING WORK SHALL BE CARRIED OUT IN ACORDANCE WITH THE NCC AND ALL **RELEVANT STANDARDS**

ALL WORK TO COMPLY WITH CDC, COUNCIL REQUIREMENTS AND ALL OTHER AUTHORITES BUILDER TO CHECK ALL DIMENSIONS ON SITE PRIOR TO COMMENCEMENT OF WORK

ALL DIMENSIONS, SIZES ect ARE IN MILIMETERS

for / client All dimensions shown are to frame, underside of roof trusses

FFL denotes - concrete level floor joist + selected flooring

and FFL (concrete) to underside of floor joist

relevant Australian standards All previous issues are to be discarded only these plans are to be read

FD AMENDMENT 07.03.25 AMENDMENT 18 03 25 AMENDMENT 06.04.25 FFD DA SUBMISSION 29.05.25



MR AND MRS WANG

SECTION/SCHEDULES

LOT34/35, 231-233 McCARRS CREEK RD **CHURCH POINT** NORTHERN BEACHES COUNCIL

DO NOT SCALE DRAWINGS

R2.0

R2.0

R2.0

Ventilated

Yes

Yes

dwg no: project no: DA SE2501 12/23 SB date: scale: 1:100 16.02.25 checked - SB

LOCATION: D:\work\WINCREST\17491\_Wang&Ma\Drawings\WORKING DRAWINGS\WORKING 06.04.25\WANG&MA - working - 06.04.25.rvt



#### **BASIX & THERMAL COMMITMENTS**









Walls Colour Ground Default 1st Floor Default Basement Default  Ceilings Ground Plaster 1st Floor Plaster	Pod 225mm  External ACC Het ACC Het Dincel w No insul  Erial Timber Frame Timber Frame Timber BELOW G Glazing Standau Low-e S Low-e T	Added Insulation R2.0 Insulation R5.0 Insulation to Grange walls R5.0 R5.0 R5.0 R5.0 R5.0 R5.0 R5.0 R5.0	on  or Frame  of Above  ASIX) Celae must b  DNS ARE  L	Ground Ist Fortificate for all the same of AN INDICATIO. Ocation(s) of All Wet Areas a Corner window	n Reflec n Reflec , Non Re  Oof und Floor Il extern r lower i ION ONI Glazing and Entry	To Car R2.0 To Car R2.0 tive Wrap tive Wrap seflective Wra Insulation Sarking Sarking Sarking Sarking Required y side windo	To comply you n n SHGC value wi REFERENCE TI	Tiles  I Int  Omm L'  Omm B  G  Material  Metal  Metal  must use githin the r  HE CERTI	ternal Insulated 'dry, Pdr iath Garage  Colour  Default  Default  Default  Glazing with the ange given.  FICATE(S).	R2.0 R2.0 R2.0 Ventilat Yes Yes	
Ground Alphafla  1st Floor Timber Basement Waffle  Walls Colour Ground Default  1st Floor Default  Basement Default  Ceilings Mate  Ground Plaster  1st Floor Plaster  Glazing  Supplier  Wideline	External ACC Het ACC Het Dincel w No insul  Erial Timber Frame Timber Frame Timber BELOW Gi Glazing Standau Low-e Standau	R2.0 Insulation R2.0 Insulation R2.0 Insulation  Material bel Timber Frame bel / F.Cement Timber vall / Brick veneer lation to garage walls  Insulation to Roo R5.0 R5.0 R5.0  othe NatHERS (or Britane type, the U value LAZING NOMINATIO Type Required rd Single Clear Single Clear	of Above  ASIX) Celue must b  DNS ARE  L	R2.5, Nor R2.5, Nor NIL/R2.5,  RO Grou 1st F  rtificate for all the the same or AN INDICATI ocation(s) of All Wet Areas a Corner window	n Reflec n Reflec , Non Re  Oof und Floor Il extern r lower i ION ONI Glazing and Entry	tive Wrap tive Wrap effective Wra  Insulation Sarking Sarking Sarking All glazing. 1 TYPLEASE Required y side windo	Internal Materia Plaster Timber 9 Plaster Timber 9	Tiles  I Int  Omm L'  Omm B  G  Material  Metal  Metal  must use githin the r  HE CERTI	ternal Insulated 'dry, Pdr iath Garage  Colour  Default  Default  Default  Glazing with the ange given.  FICATE(S).	R2.0 R2.0 R2.0 Ventilat Yes Yes	
1st Floor Timber Basement Waffle  Walls Colour Ground Default 1st Floor Default Basement Default  Ceilings Mate Ground Plaster  Glazing Supplier Wideline	External ACC Het ACC Het Dincel w No insul  erial Timber Frame Timber Frame Timber BELOW G Glazing Standa Low-e S Low-e T	Material bel Timber Frame bel / F.Cement Timber vall / Brick veneer lation to garage walls  Insulation to Roo R5.0 R5.0 R5.0 the NatHERS (or Brick veneer) lation to garage walls  Type Required ord Single Clear Single Clear	ASIX) Ceruse must b	R2.5, Nor R2.5, Nor NIL/R2.5,  RO Grou 1st F  rtificate for all the the same or AN INDICATI ocation(s) of All Wet Areas a Corner window	n Reflec n Reflec , Non Re  Oof und Floor Il extern r lower i ION ONI Glazing and Entry	tive Wrap tive Wrap effective Wra  Insulation Sarking Sarking al glazing. 1 ATPLEASE Required y side windo	Internal Materia Plaster Timber 9 Plaster Timber 9  To comply you not shall be shall	il Int 00mm L' 00mm B G Material Metal Metal must use githin the r HE CERTI	ternal Insulated 'dry, Pdr ath  carage  Colour  Default  Default  glazing with the range given. FICATE(S).	R2.0 R2.0 R2.0 Ventilat Yes Yes	
Walls Colour Ground 1st Floor Basement Ceilings Ground Plaster Supplier Wideline  Waffle Colour Default Default Water Default Notes Window substitutions was	External ACC Het ACC Het Dincel w No insul  erial Timber Frame Timber Frame Timber BELOW Gi Glazing Standal Low-e S Low-e T	Material bel Timber Frame bel / F.Cement Timber vall / Brick veneer lation to garage walls  Insulation to Roo R5.0 R5.0  Insulation to Roo R5.0 Insulation to Roo R5.0 Insulation to Roo R5.0 Insulation to Roo R5.0 R5.0 R5.0 Insulation to Roo R5.0 R5.0 R5.0 Insulation to Roo R5.0 R5.0 R5.0 R5.0 R5.0 R5.0 R5.0 R5.0	ASIX) Ceruse must b	R2.5, Nor R2.5, Nor NIL/R2.5,  RO Grou 1st F  rtificate for all the the same or AN INDICATI ocation(s) of All Wet Areas a Corner window	n Reflec n Reflec , Non Re  Oof und Floor Il extern r lower i ION ONI Glazing and Entry	tive Wrap tive Wrap effective Wra Insulation Sarking Sarking al glazing. 1 and have ar LY PLEASE Required y side windo	Plaster Timber 9 Plaster Timber 9	90mm L' 90mm B G Material Metal Metal Must use githin the r HE CERTI	dry, Pdr ath  Colour  Default  Default  glazing with the ange given.  FICATE(S).	R2.0 R2.0 R2.0 Ventilat Yes Yes	
Walls Ground 1st Floor Basement Ceilings Ground Plaster 1st Floor Plaster  Clazing Supplier Wideline  Notes Window substitutions w	External ACC Het ACC Het Dincel w No insul  erial Timber Frame Timber Frame Clease Refer to opening and fra THE BELOW GI Glazing Standar Low-e Si Low-e Timber Frame	bel Timber Frame bel / F.Cement Timbe vall / Brick veneer lation to garage walls  Insulation to Roo R5.0 R5.0 R5.0  In the NatHERS (or Britane type, the U value LAZING NOMINATIO Type Required ord Single Clear Single Clear	ASIX) Ceruse must b	R2.5, Nor R2.5, Nor NIL/R2.5,  RO Grou 1st F  rtificate for all the the same or AN INDICATI ocation(s) of All Wet Areas a Corner window	n Reflec n Reflec , Non Re  Oof und Floor Il extern r lower i ION ONI Glazing and Entry	tive Wrap tive Wrap effective Wra Insulation Sarking Sarking al glazing. 1 and have ar LY PLEASE Required y side windo	Plaster Timber 9 Plaster Timber 9	90mm L' 90mm B G Material Metal Metal Must use githin the r HE CERTI	dry, Pdr ath  Colour  Default  Default  glazing with the ange given.  FICATE(S).	R2.0 R2.0 R2.0 Ventilat Yes Yes	
Ground Default  1st Floor Default  Ceilings Mate  Ground Plaster  1st Floor Plaster  Glazing  Supplier  Wideline	ACC Het ACC Het Dincel w No insul  erial Timber Frame Timber Frame Please Refer to opening and fra THE BELOW G Glazing Standal Low-e S Low-e T	bel Timber Frame bel / F.Cement Timbe vall / Brick veneer lation to garage walls  Insulation to Roo R5.0 R5.0 R5.0  In the NatHERS (or Britane type, the U value LAZING NOMINATIO Type Required ord Single Clear Single Clear	ASIX) Ceruse must b	R2.5, Nor R2.5, Nor NIL/R2.5,  RO Grou 1st F  rtificate for all the the same or AN INDICATI ocation(s) of All Wet Areas a Corner window	n Reflec n Reflec , Non Re  Oof und Floor Il extern r lower i ION ONI Glazing and Entry	tive Wrap tive Wrap effective Wra Insulation Sarking Sarking al glazing. 1 and have ar LY PLEASE Required y side windo	Plaster Timber 9 Plaster Timber 9	90mm L' 90mm B G Material Metal Metal Must use githin the r HE CERTI	dry, Pdr ath  Colour  Default  Default  glazing with the ange given.  FICATE(S).	R2.0 R2.0 R2.0 Ventilat Yes Yes	
Ground Default  1st Floor Default  Basement Default  Ceilings Mate  Ground Plaster  1st Floor Plaster  Glazing  Supplier  Wideline  Notes Window substitutions w	ACC Het ACC Het Dincel w No insul  erial Timber Frame Timber Frame Please Refer to opening and fra THE BELOW G Glazing Standal Low-e S Low-e T	bel Timber Frame bel / F.Cement Timbe vall / Brick veneer lation to garage walls  Insulation to Roo R5.0 R5.0 R5.0  In the NatHERS (or Britane type, the U value LAZING NOMINATIO Type Required ord Single Clear Single Clear	ASIX) Ceruse must b	R2.5, Nor R2.5, Nor NIL/R2.5,  RO Grou 1st F  rtificate for all the the same or AN INDICATI ocation(s) of All Wet Areas a Corner window	n Reflec n Reflec , Non Re  Oof und Floor Il extern r lower i ION ONI Glazing and Entry	tive Wrap tive Wrap effective Wra Insulation Sarking Sarking al glazing. 1 and have ar LY PLEASE Required y side windo	Plaster Timber 9 Plaster Timber 9	90mm L' 90mm B G Material Metal Metal Must use githin the r HE CERTI	dry, Pdr ath  Colour  Default  Default  glazing with the ange given.  FICATE(S).	R2.0 R2.0 R2.0 Ventilat Yes Yes	
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Ground Plaster  1st Floor Plaster  Glazing  Supplier  Wideline  Notes Window substitutions w	Timber Frame Timber Frame Please Refer to opening and fra THE BELOW Gi Glazing Standar Low-e S Low-e 1	R5.0 R5.0  The NatHERS (or Batter type, the U value LAZING NOMINATION Type Required ord Single Clear  Single Clear	ASIX) Cei ue must b DNS ARE L	rtificate for all the the same of AN INDICATI ocation(s) of All Wet Areas a Corner window	und Floor Il extern r lower ION ONI Glazing and Entr	Sarking Sarking al glazing. 1 and have ar Y PLEASE Required y side windo	Fo comply you n n SHGC value wi REFERENCE TI	Metal Metal must use githin the r HE CERTI	Default Default  glazing with the range given. FICATE(S).	Yes Yes	
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Supplier Wideline  Notes Window substitutions w	Please Refer to opening and fra THE BELOW Gi Glazing Standar Low-e S Low-e T	the NatHERS (or Barame type, the U value LAZING NOMINATION Type Required ord Single Clear Single Clear	ue must b ONS ARE L	rtificate for all the the same of AN INDICATI Cocation(s) of All Wet Areas a	Il extern r lower ION ONI Glazing and Entr	al glazing. I and have ar LY PLEASE Required y side windo	Fo comply you n n SHGC value w REFERENCE TH DWS	nust use g ithin the r HE CERTI	glazing with the ange given. FICATE(S).		
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	Location	o soπware limitations	5.				F	an Size			
Dining/Family and Study							1200r		mm		
503.72 Showerheads		m2 3,00 To	00L C	ank, connecte Garden, WC, L Kitchen	aundry	80% of Bathroo	m Taps	<b>Recycled</b> No	l Water, connec		
3 Star > 7.5 but less	< or = 9.0 litres	per minute 4 8	Star	6 Star		6 Sta	ır		No		
Energy Hot W	ater F	Rating Air	Condition	ning				Ot	her		
Electric	Boost Solar	21 to 25 STCs Coo	oling 3.0 -	3.5 EER - Hea	ating 3.0	- 3.5 EER	3 Phase	Ai	ir Conditioning Zo	oned	
Solar Photovoltaic S	System					Cooking		О	outdoor Cloths	s Line	
No						Induction C	Cooktop/ Electric (	Ove			
Ventuation	<b>_aundry</b> Natural Ventilati	ion- external window		throom cted			Kitchen Ducted				
	Tatoral Tornian	on external window	Du	otou			Duotod				
Notes											

All dimensions shown are to frame, underside of roof trusses and FFL (concrete) to underside of floor joist

FFL denotes - concrete level floor joist + selected flooring

All construction work to comply with the NCC and all relevant Australian standards All previous issues are to be discarded only these plans are to be read

A FD
B AMENDMENT
C AMENDMENT
D AMENDMENT
E FFD DA SUBMISSION

date 16.02.25 07.03.25 18.03.25 06.04.25 29.05.25





Frys Building Consultancy Pty Ltd Trading as Frys Energywise are Accredited Thermal Energy Assessors ABSA 20856, BDAV 12/1441, COLA 2011291


for / client MR AND MRS WANG


BASIX COMMITMENTS

		Γ.		
	LOT34/35, 231-233 McCARRS CREEK RD CHURCH POINT	DA	project no: SE2501	13/23
•	NORTHERN BEACHES COUNCIL	drawnAuthor	date:	scale:
•	DO NOT SCALE DRAWINGS	cheChecker	16.02.25	

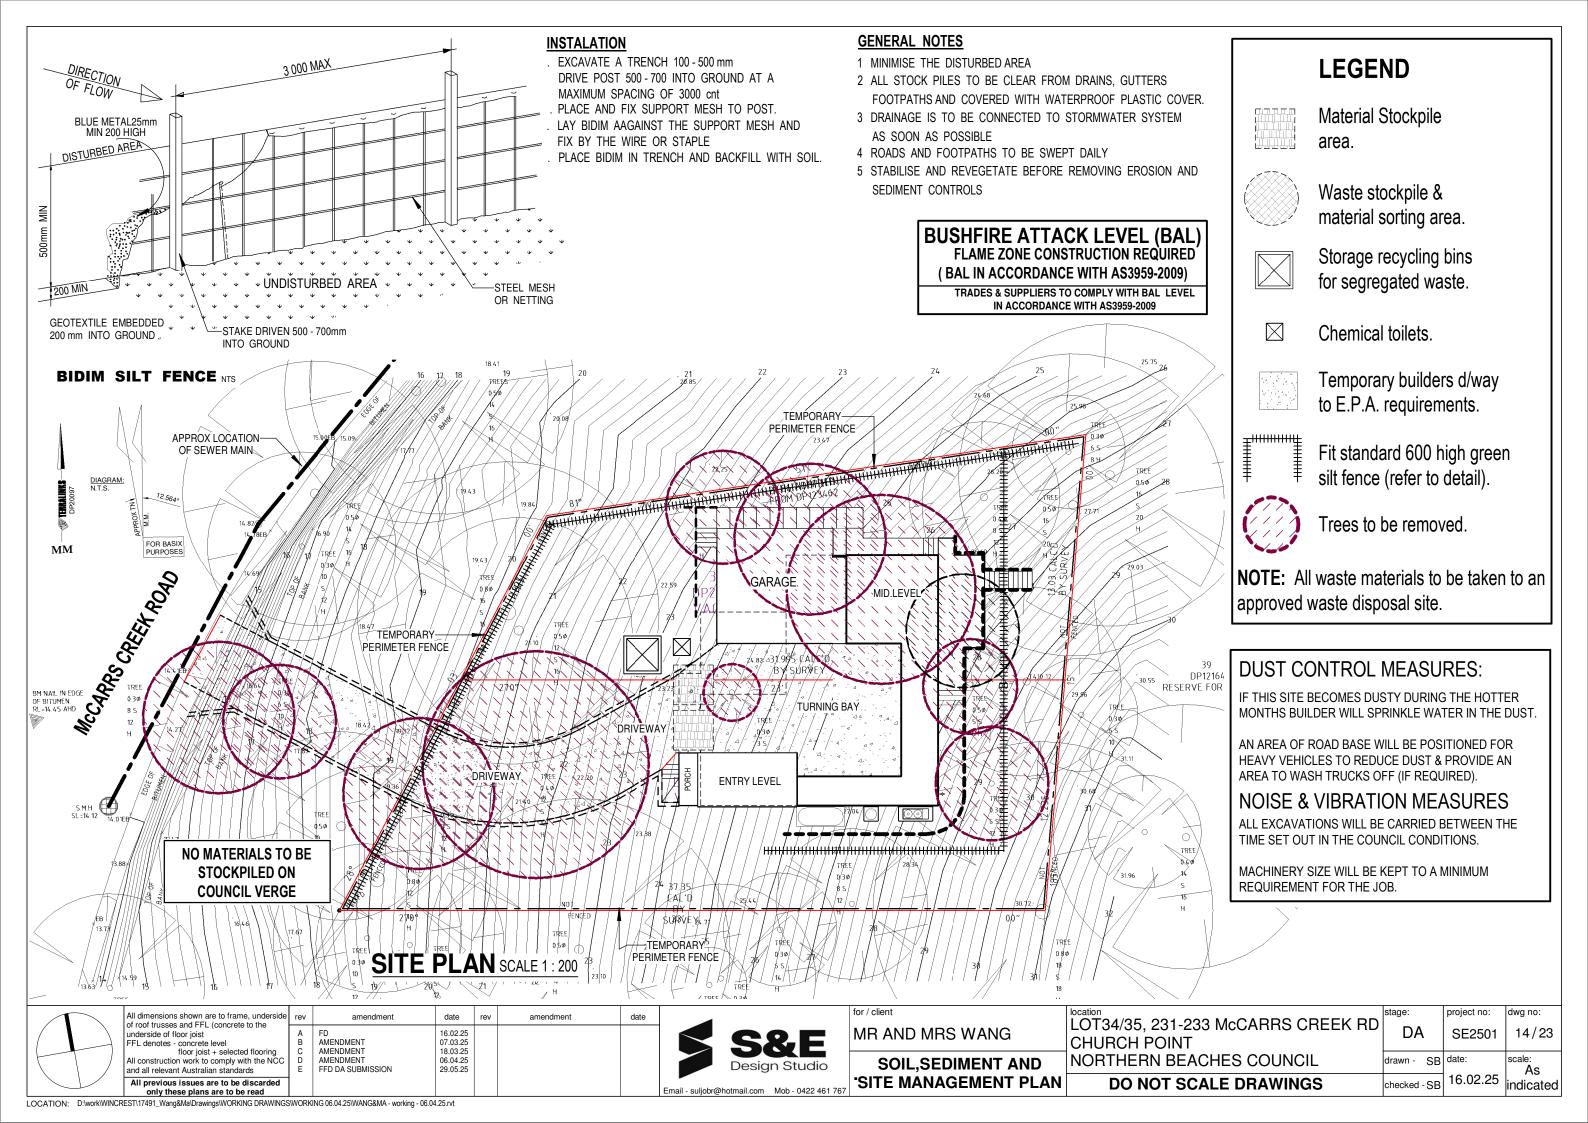


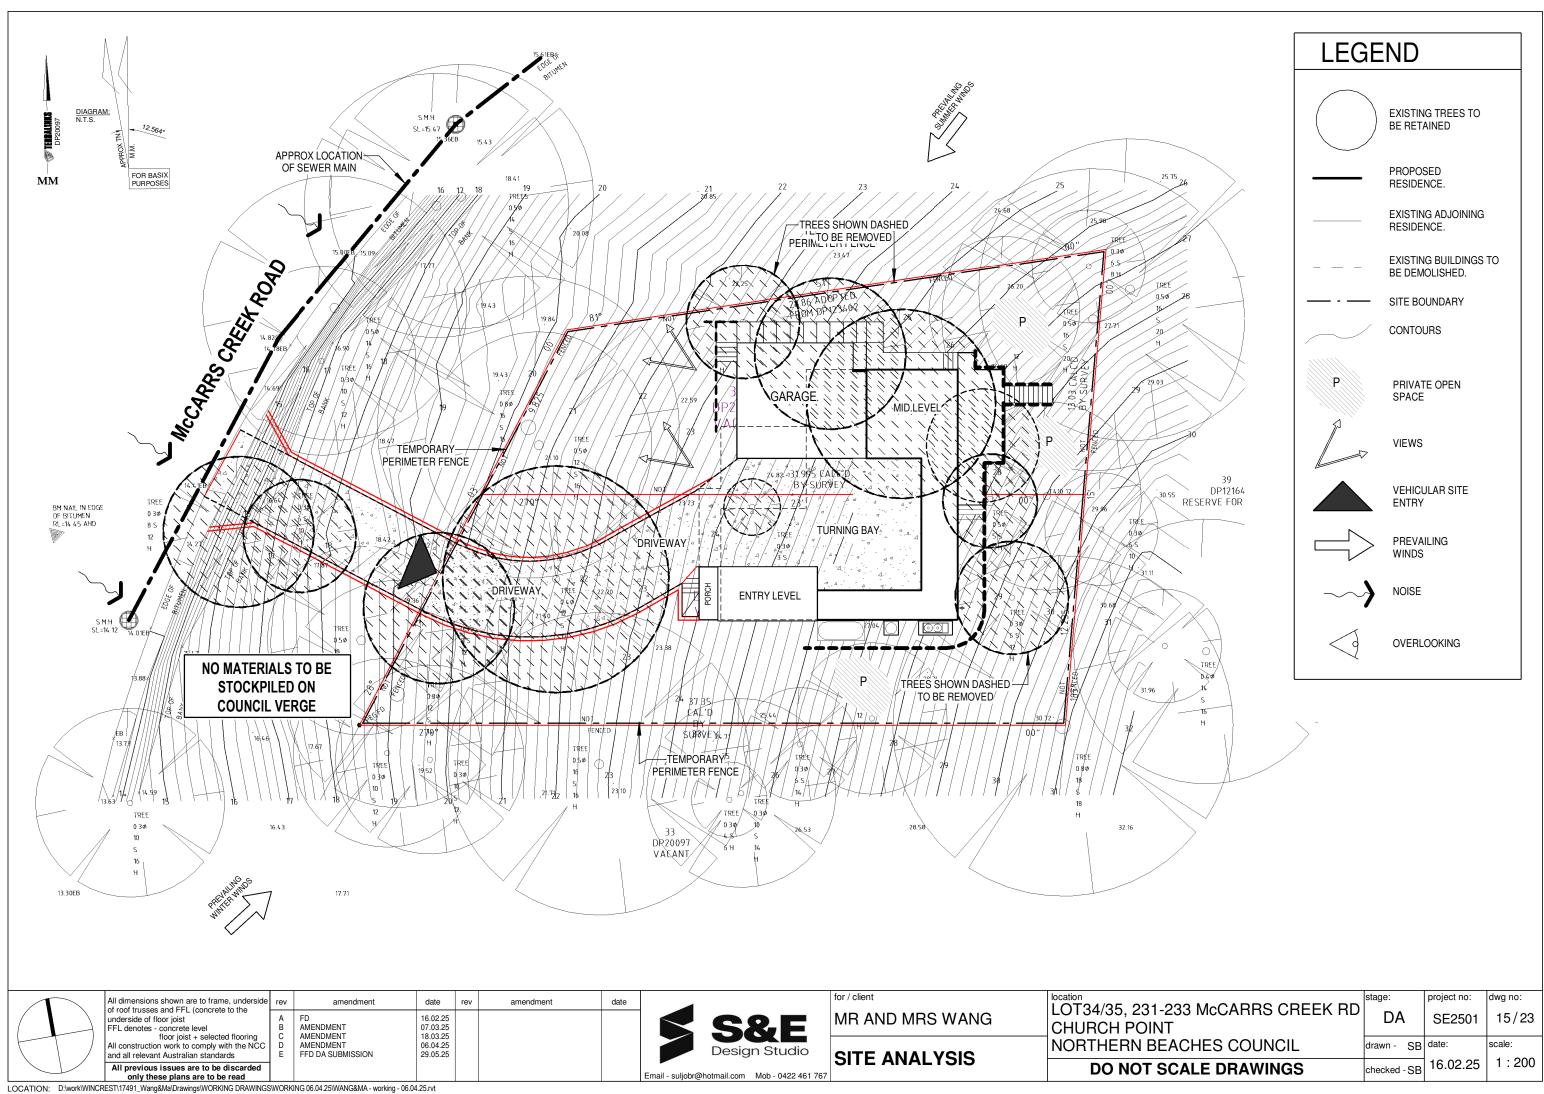


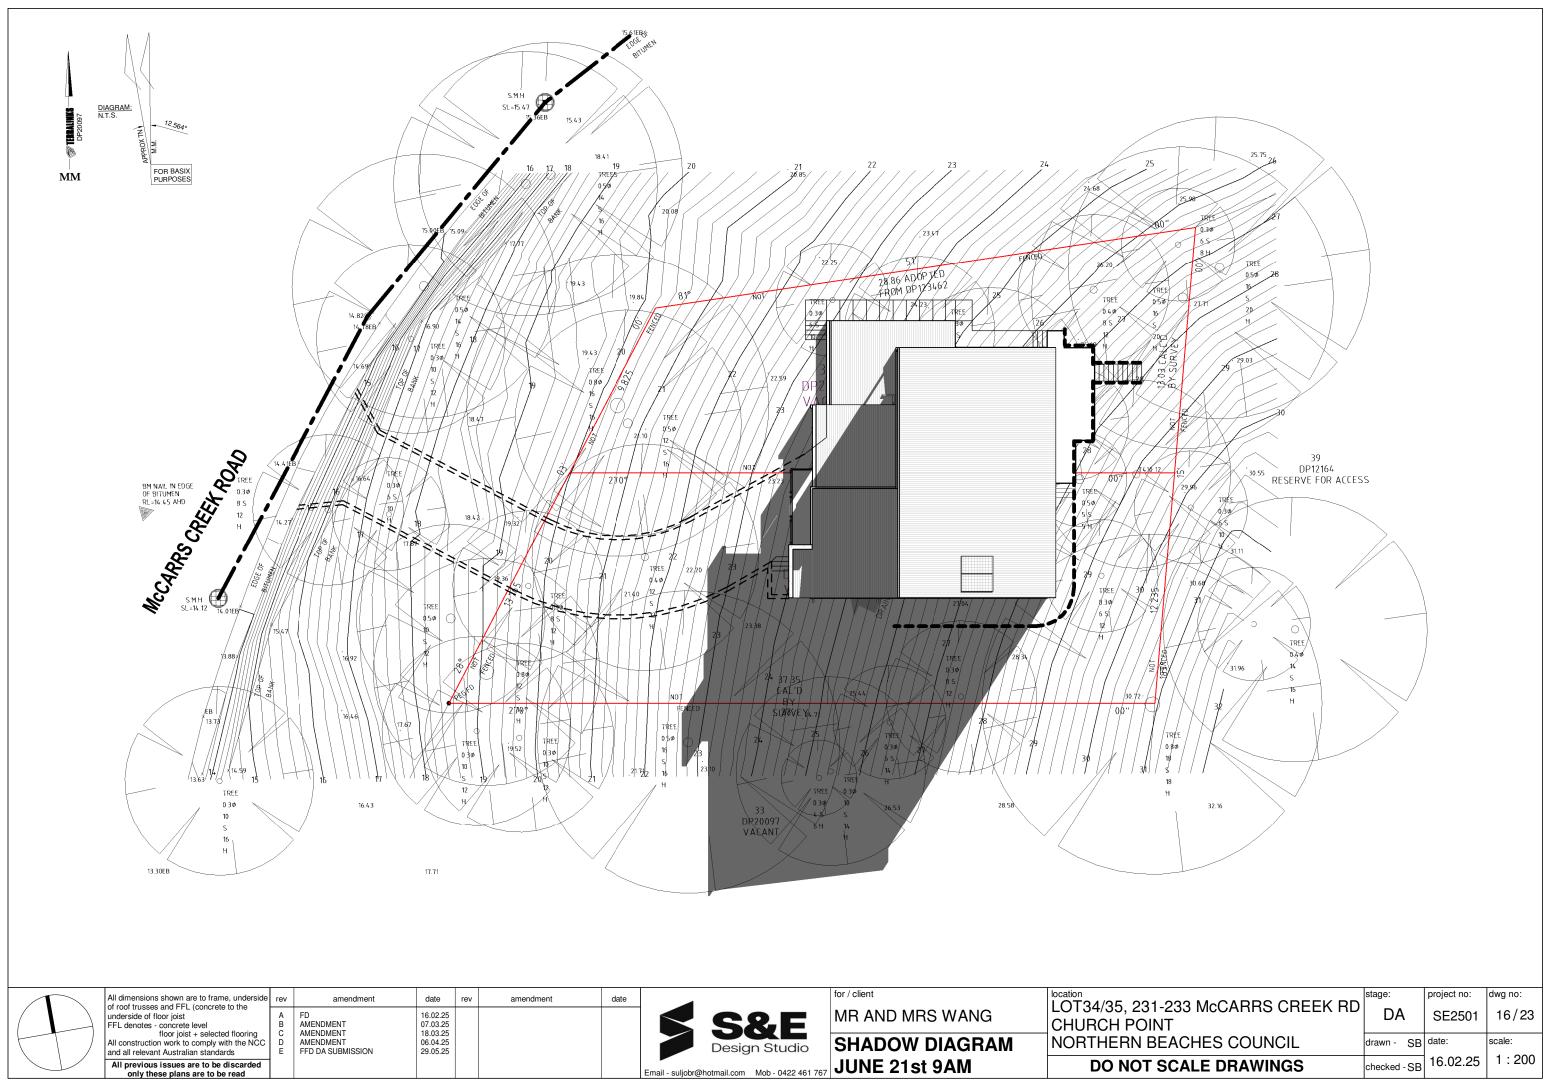


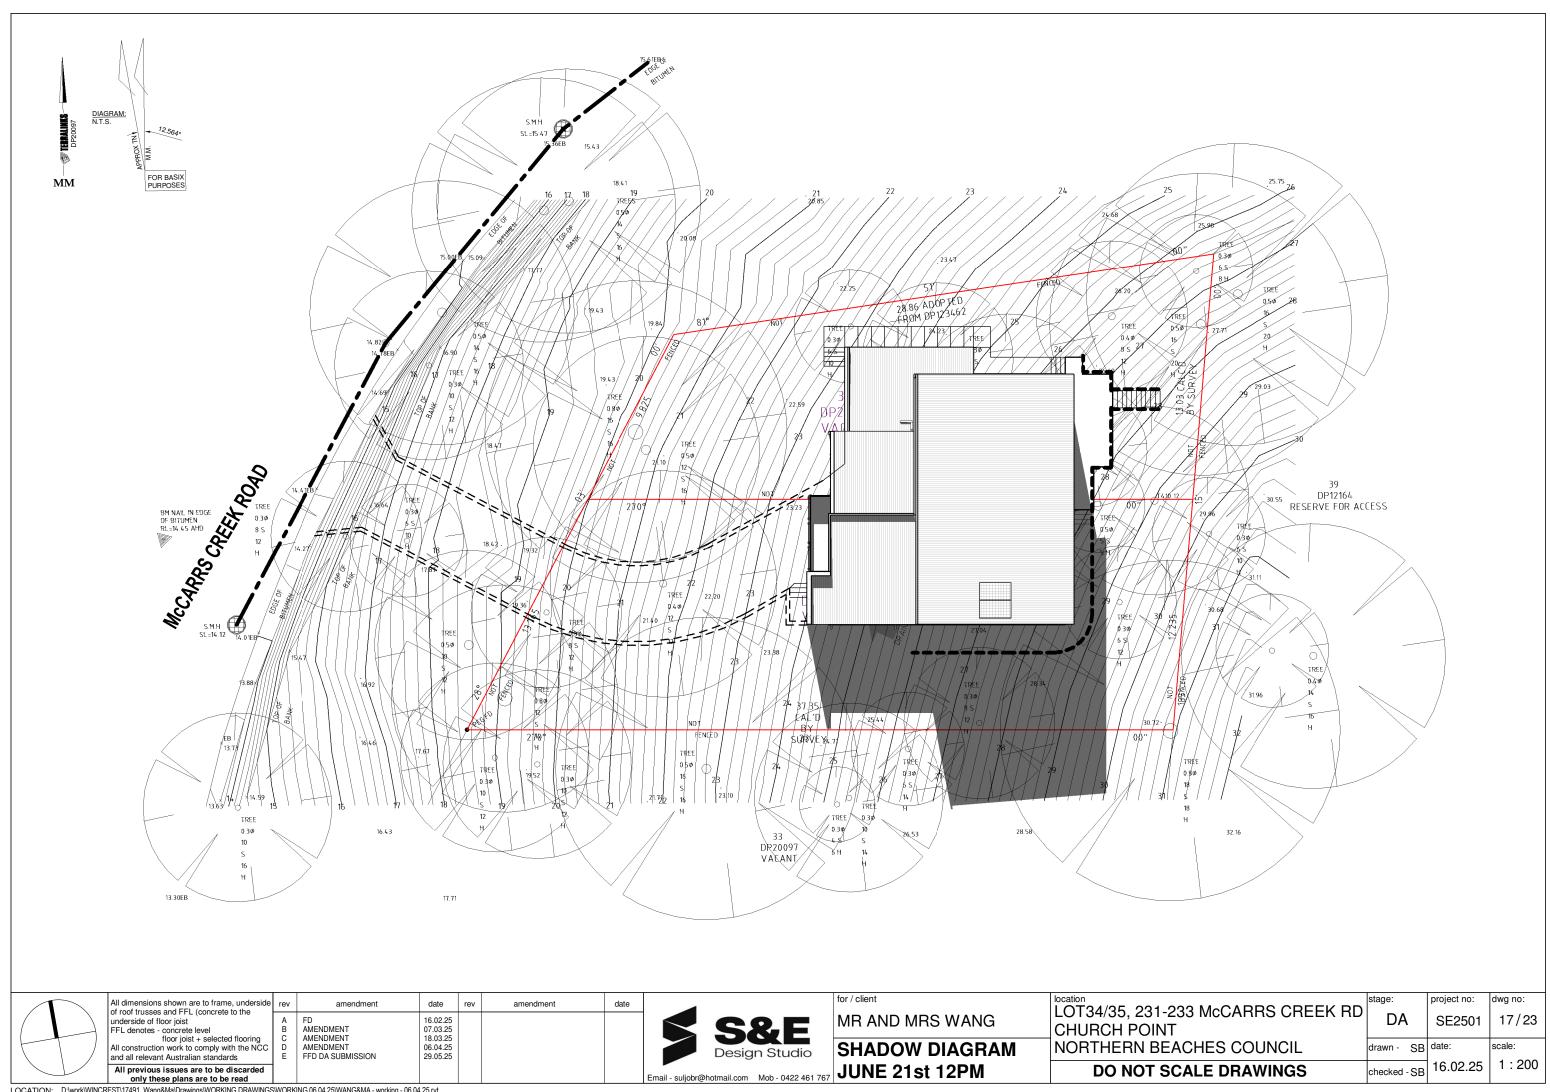





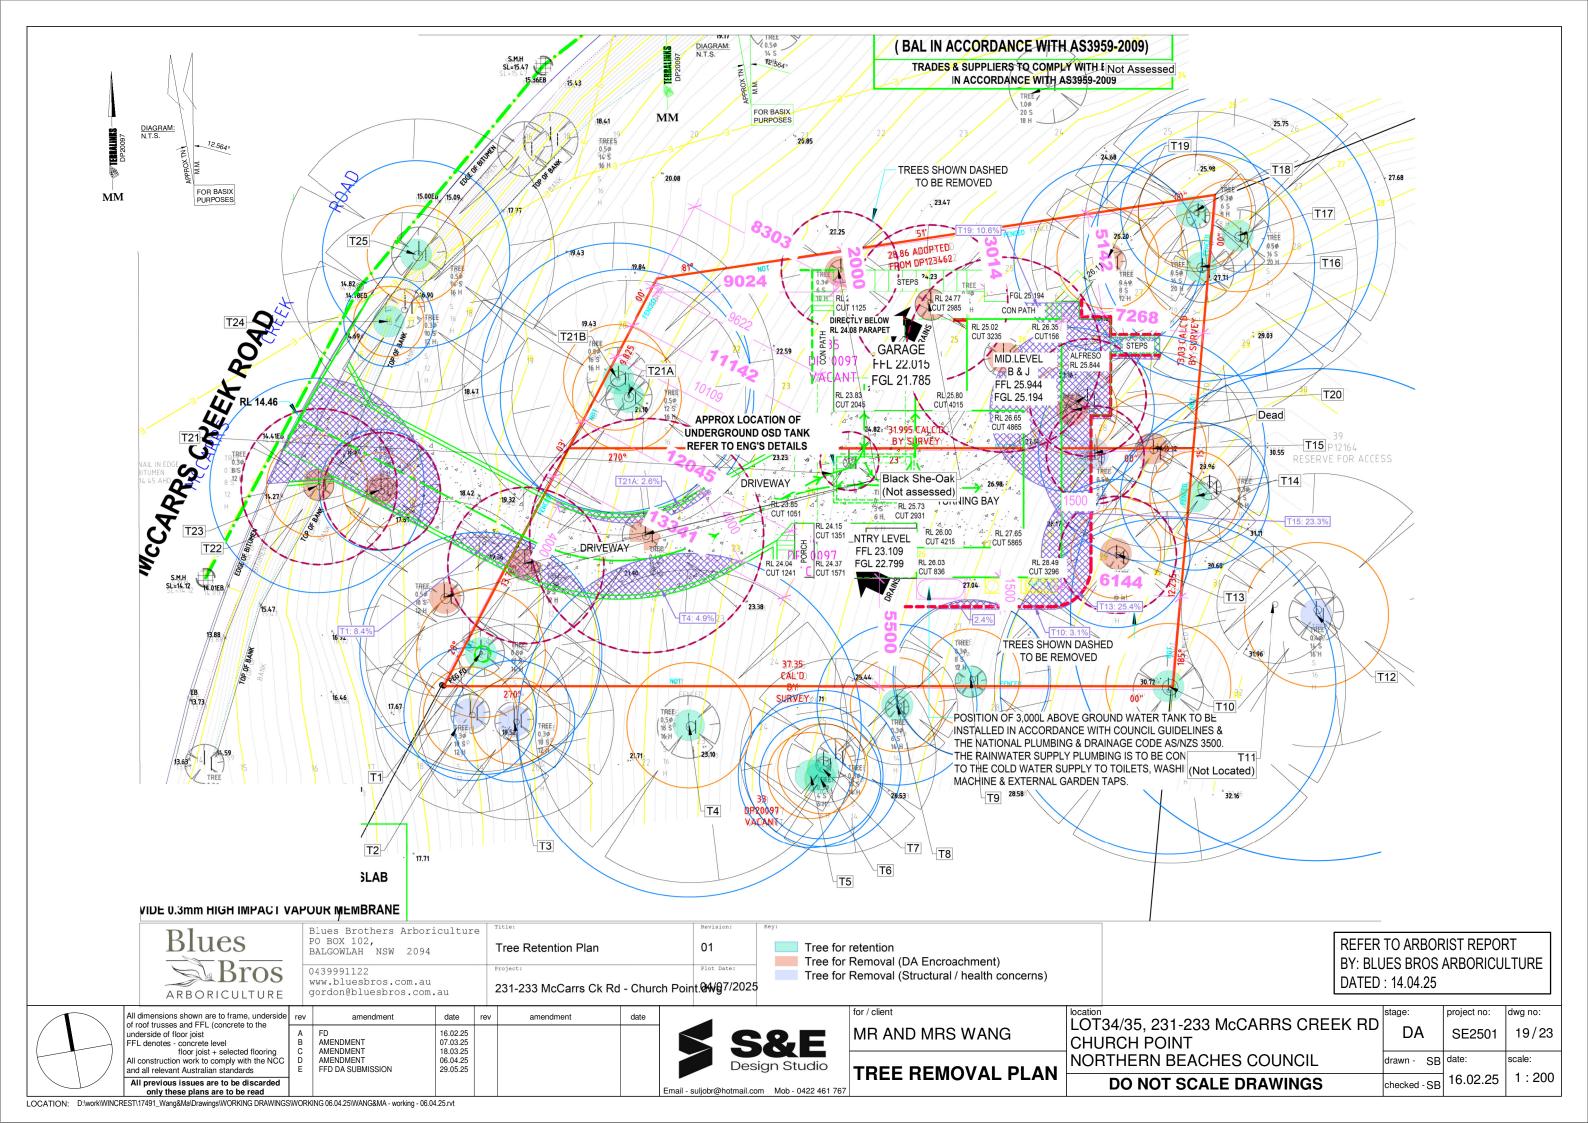

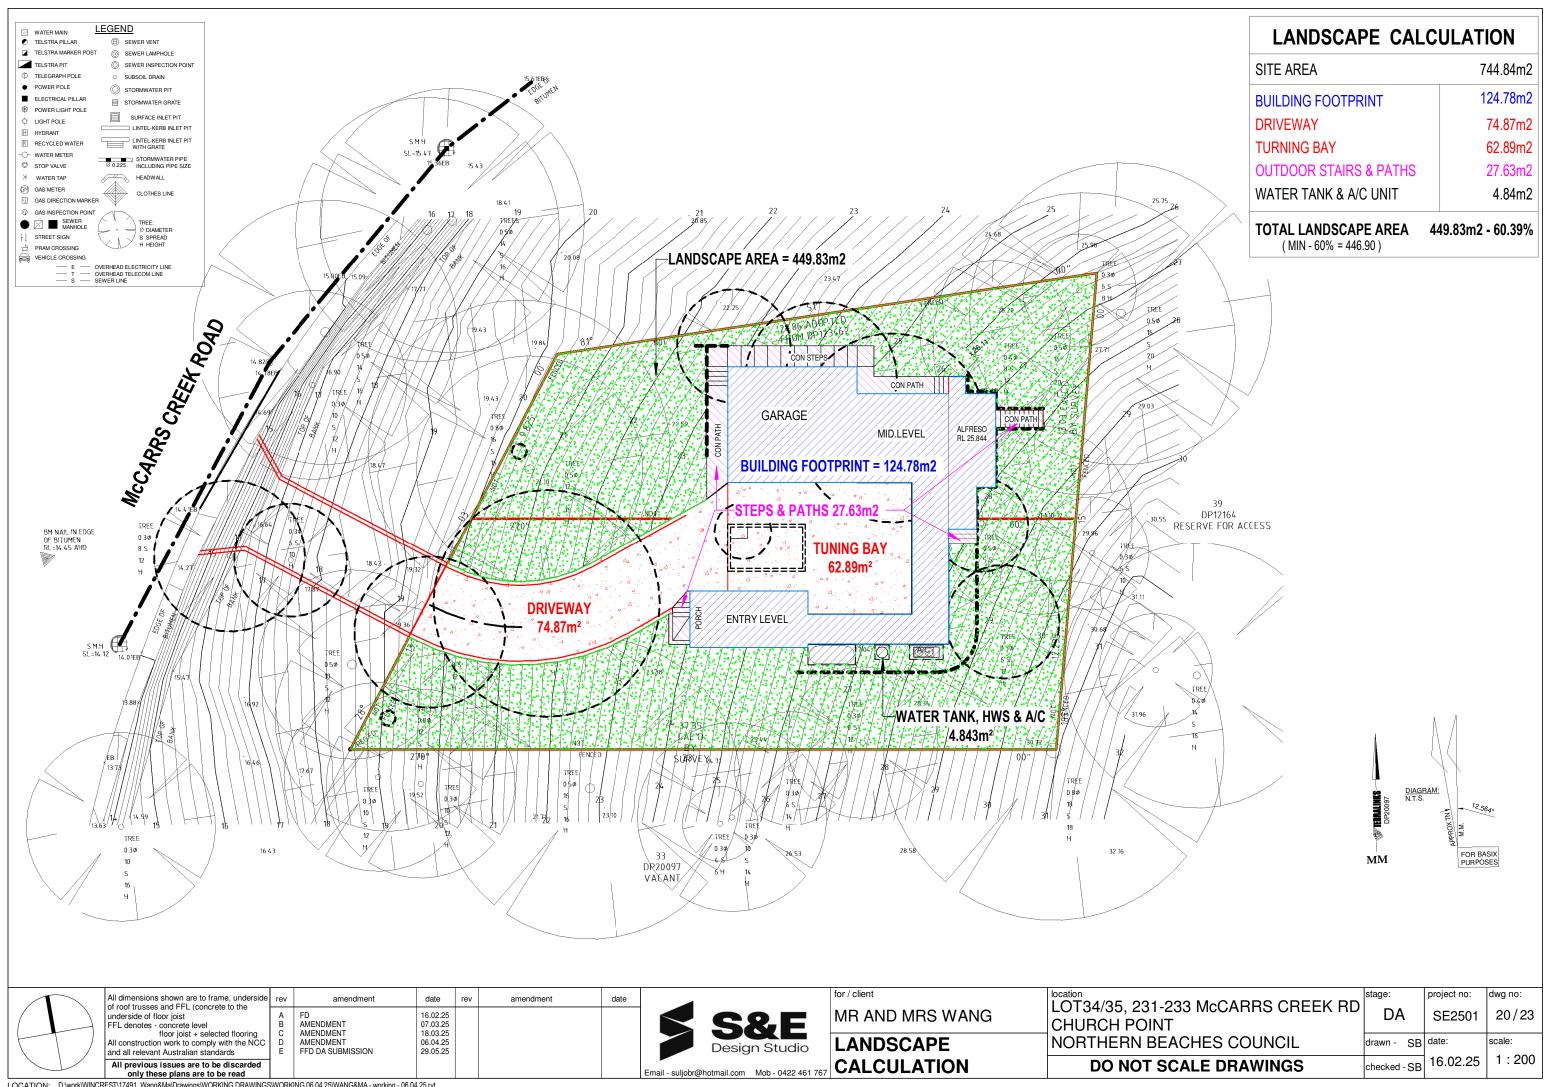


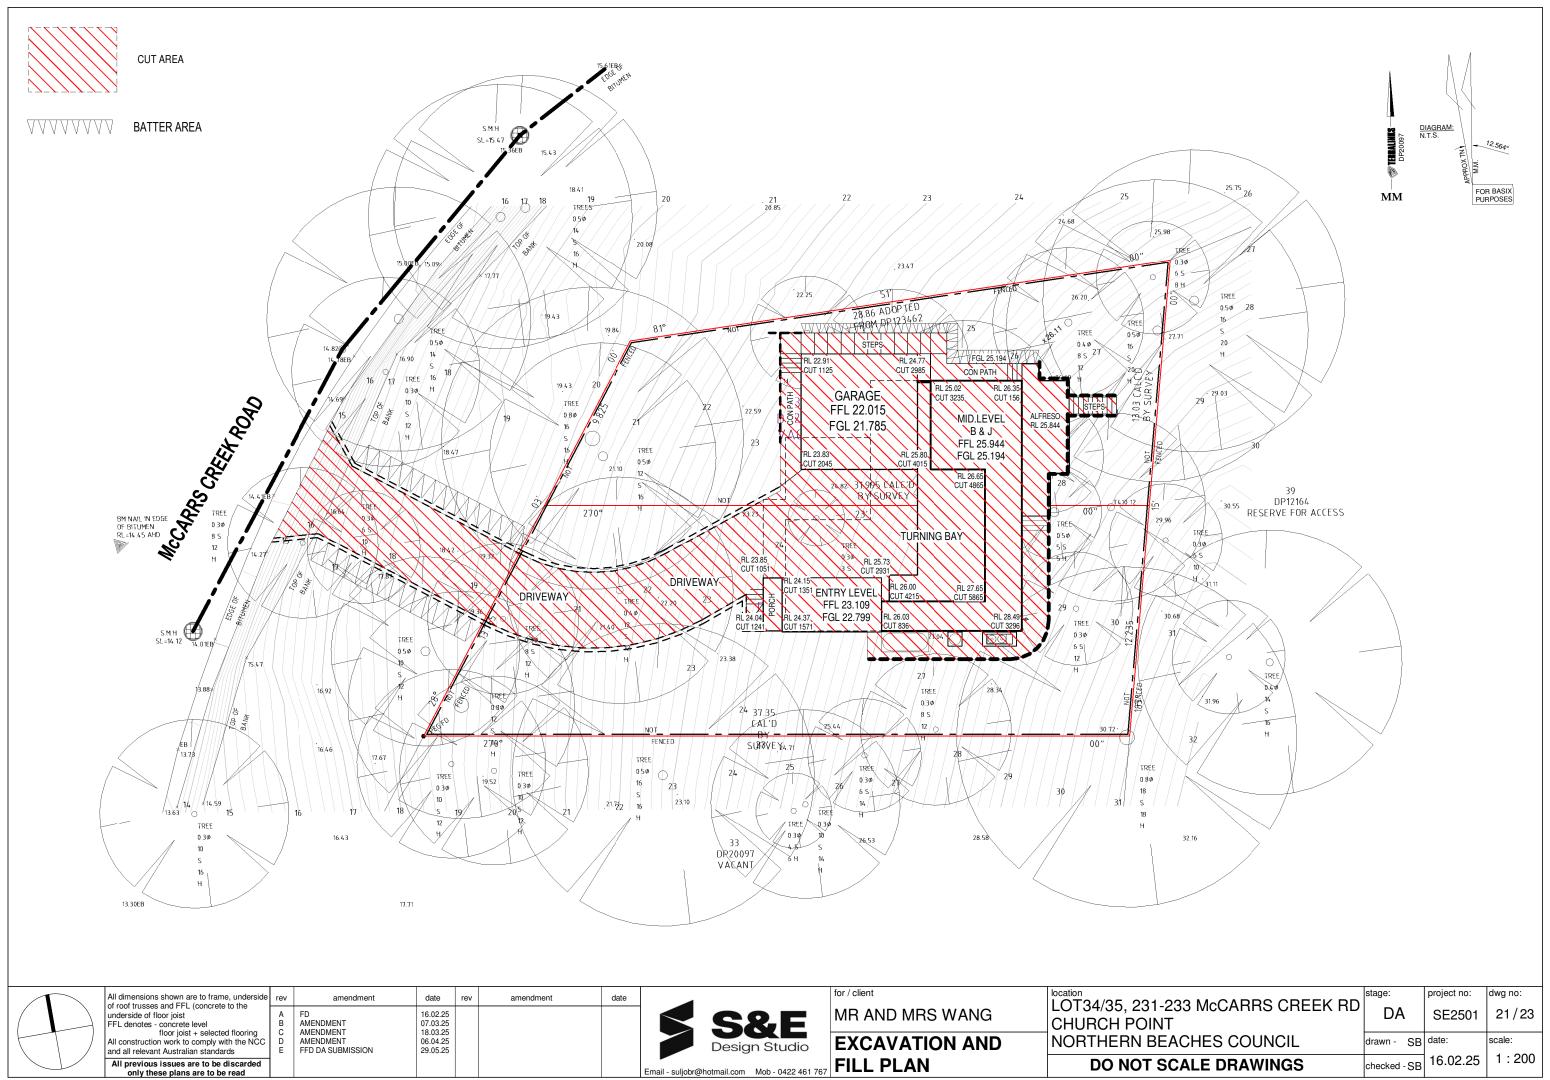

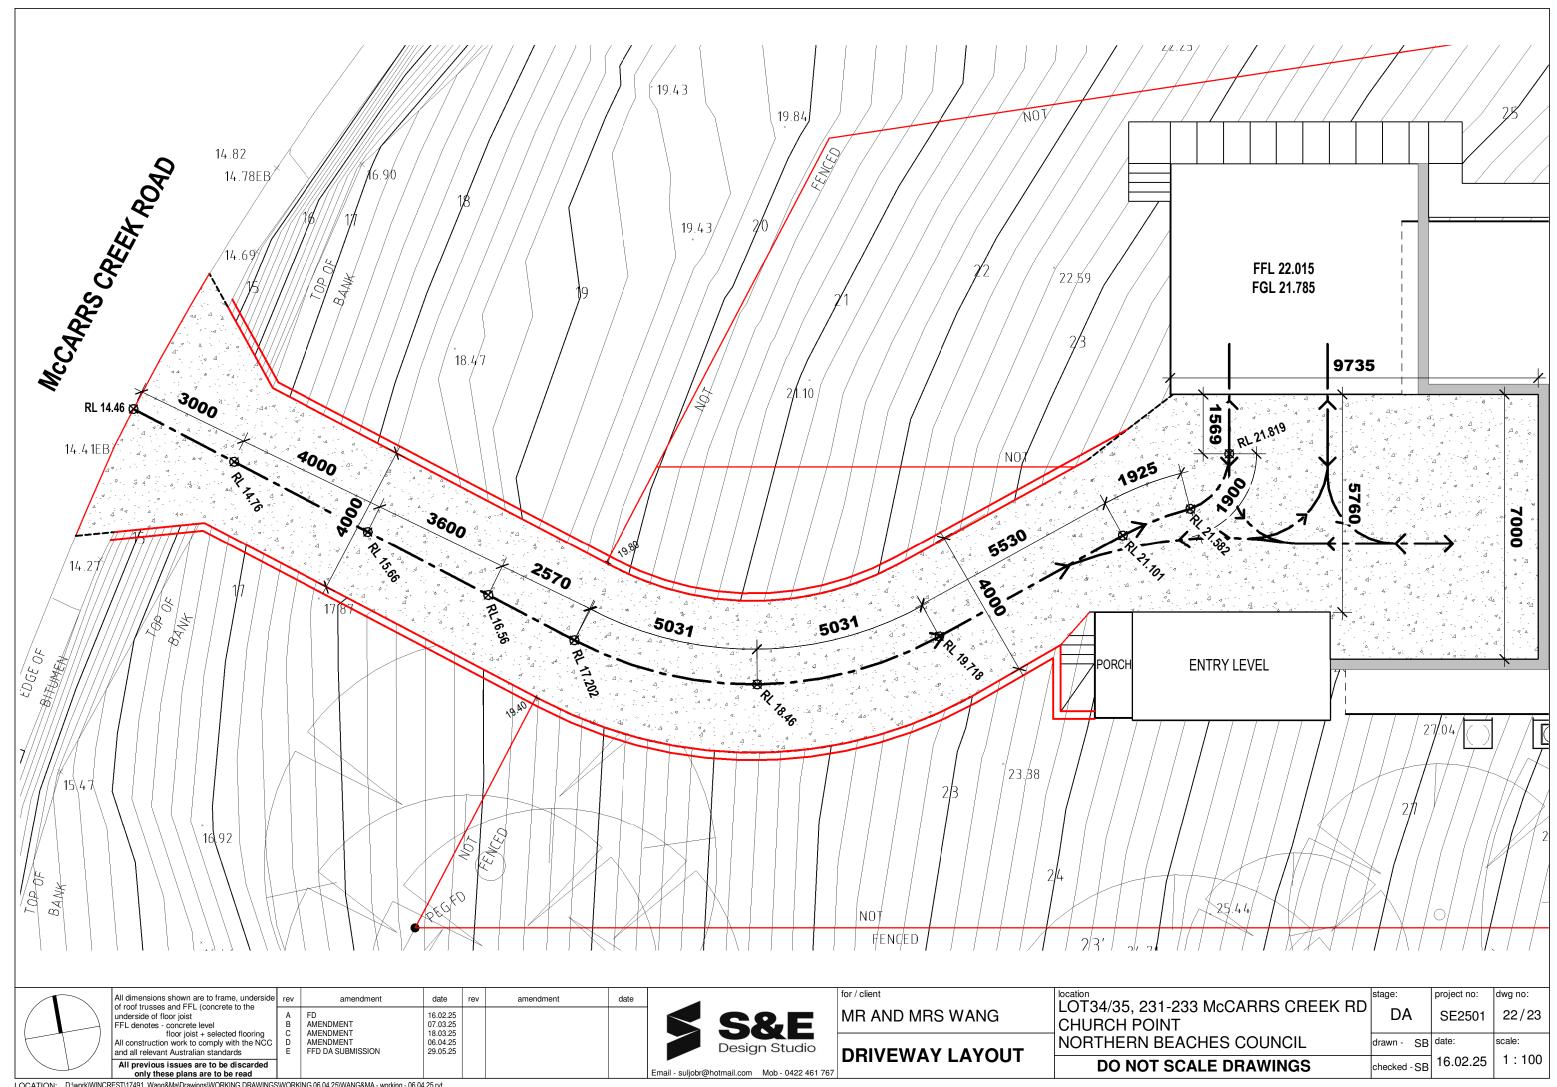

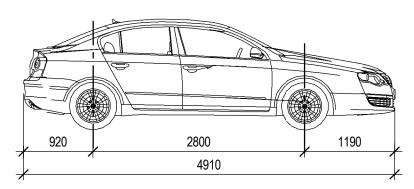

Australian B85 Type Vehicle – AS2890.1:2004

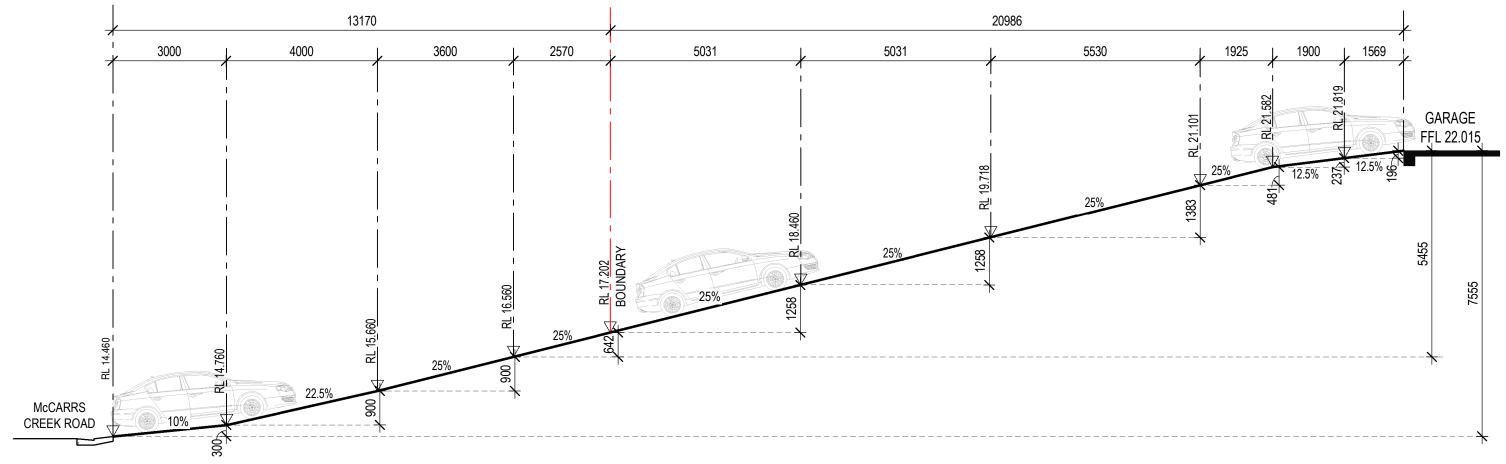

**SCALE 1:100** 

All dimensions shown are to frame, underside of roof trusses and FFL (concrete) to underside of floor joist	rev amendment	date rev	amendment	date			LOT34/35, 231-233 McCARRS CREEK RD	stage:	project no:	dwg no:
FFL denotes - concrete level floor joist + selected flooring	A FD B AMENDMENT	16.02.25 07.03.25			S S&F	MR AND MRS WANG	CHURCH POINT	DA	SE2501	23/23
All construction work to comply with the NCC and all	C AMENDMENT D AMENDMENT E FFD DA SUBMISSION	18.03.25 06.04.25 29.05.25			Design Studio	LONGITUDINAL	NORTHERN BEACHES COUNCIL	drawn - SB		scale:
relevant Australian standards  All previous issues are to be discarded only these plans are to be read					Email - suljobr@hotmail.com Mob - 0422 461 767	DRIVEWAY SECTION	DO NOT SCALE DRAWINGS	checked - SB	16.02.25	indicated