

ACTION PLANS

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DEVELOPMENT APPLICATION


These plans are for Council Approval only.

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70 HILMA STREET, COLLAROY PLATEAU NSW 2097



ITEM DETAILS	DEVELOPMENT APPLICATION			
ADDRESS	70 Hilma St Collaroy Plateau, NSW 2097			
LOT & DP/SP	LOT 38 SEC L DP 33000			
COUNCIL	NORTHERN BEACHS COUNCIL (WARR	INGAH)		
SITE AREA	422.72m ² BY CALC.			
FRONTAGE	10.67m			
CONTROLS	PERMISSIBLE / REQUIRED	EXISTING	PROPOSED	COMPLIANCE
CONTROLS	m / m² / %	m / m² / %	m / m² / %	
<u>LEP</u>				
LAND ZONING	R2 – LOW DENSITY RESIDENTIAL	R2	R2	YES
MINIMUM LOT SIZE	450m²	422.72m ²	UNCHANGED	YES
FLOOR SPACE RATIO	NOT IDENTIFEID	N/A	N/A	N/A
MAXIMUM BUILDING HEIGHT	8.5m	6.54m	8.354m	YES
<u>HAZARDS</u>				
DEVELOPMENT ON SLOPING LAND	AREA A	N/A	N/A	N/A
DCP				
WALL HEIGHT	7.2m	5.231m	4.742m	YES
NUMBER OF STOREYS	2	2	UNCHANGED	YES
SIDE BOUNDARY ENVELOPE	5m		UNCHANGED	NO
SIDE BOUNDARY SETBACKS	0.9m	N: 0.9m S: 0.94m	N: 0.903m S: 0.9m	YES
FRONT BOUNDARY SETBACK	6.5m	6.020m	6.5	YES
REAR BOUNDARY SETBACK	6.0m	16.008m	10.152m	YES
LANDSCAPE OPEN SPACE	40% (169.08m²)	35% (148.09m²)	37% (157.73m²)	NO
PRIVATE OPEN SPACE	60m²	-	60m²	YES

IMPORTANT NOTATION FOR BUILDERS

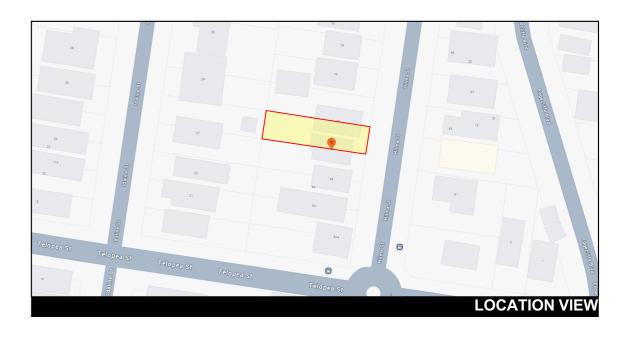- All dimensions are to be confirmed on-site by the builder/subcontractor, any incongruencies must be reported to the Designer in writing before the commencement of any work.
- No Survey has been made on the boundaries, all bearings, distances, and areas have been taken from the contour survey plan. A Survey must be carried out to confirm the exact boundary locations.
- No construction work shall commence until a site survey confirming the site boundaries has been completed. The contractor is to ensure that the approved boundary setbacks are confirmed and used, the boundary setbacks take precedence over all other dimensions. The Survey work must be performed by a reaistered Surveyor.
- In the event of encountering any discrepancies on these drawings, specification, or subsequent instructions issued, the Builder/Subcontractor shall contact the designer in writing before proceeding further

The builder/subcontractor is responsible to ensure that all materials installed on-site are fit for purpose and comply with the NCC and relevant Australian standards. The builder is to get written confirmation of material selection by the client prior to ordering

- All construction, control joints, and expansion joints in the wall, floors, other locations shall be in strict accordance with the Structural Engineering details. No joints or breaks other than specified are allowed without written permission from the Engineer
- Measurements for the fabrication of secondary components such as windows, doors, internal frames, structural steel components, and the like, are not to be taken from these documents. Measurements must be taken on-site to suit the work as constructed.
- All structural components shall be in strict accordance with details and specifications as prepared by a
- All existing structures need to be examined for structural adequacy, and it is the Contractor's responsibility to ensure that a certificate of structural adequacy is obtained prior to the start of any work.

SPECIFICATION

- "Approval" obtained by either an 'Accredited Certifying Authority' or 'Local Council'.
- The Owner will directly pay all fees associated with the following: -

Building approval from council or accredited certifier, any footpath and kerb deposits with the local council, insurance fees to Building Services Corporation, Long Service Leave levy fees and approval fees by water

sewerage authority. All other fees are to be paid by the builder. The amount of any local authority deposits which are forfeited due to damage or other causes, will be deducted from payments due to the builder -The Builder is to provide at his/her own expense adequate Public Risk Insurance and arrange

- indemnification under the Workers Compensation Act. Works insurance to be as stated in the contract conditions
- All tenderers are to visit the site to satisfy themselves as to the nature and extent of the Works, facilities available and difficulties entailed in the works as Variations will not be allowed due to work arising owing to
- These drawings shall be read in conjunction with all structural and other consultant's drawings and specifications and with any such written instructions as may be issued during the course of the contract
- Set out dimensions shown on this drawing shall be verified by the builder on site before commencement of any work. Dimensions shall not be obtained by scaling the drawings. Use only figured dimensions. All dimensions are in millimetres
- The Builder is to ensure all construction, levels and other items comply with the conditions ofthe Building Approval.
- Any detailing in addition to what is supplied shall be resolved between the Owner and the Builder to the Owner's approval, except for any structural details or design which is to be supplied by the Engineer.
- All work to be carried out in a tradesman like manner and in accordance with the standards, codes and regulations of the Standards Association of Australia, National construction Code of Australia and any statutory authority having jurisdiction over the works.
- All structural work is to be in accordance with the structural details prepared by a suitably qualified structural engineer. Including but not limited to all piers, footings, concrete slabs, retaining walls, steelworks, formwork, underpinning, additional structural loads, timber framing, wind bracing and associated connections. Builder to obtain, prior to finalising the tender unless previously obtained by
- All brickwork is to be selected by owner and is to comply with AS 1640. All masonry is to comply with AS 3700
- Provide all metalwork and flashings necessary to satisfactorily complete the works.
- All timber construction to be in accordance with AS 1684 "Timber Framing Code". Level & Grade where necessary under timber floors to provide a minimum clearance of 300mm under bearers or 400mm under joists. Adequate precautions shall be taken to ensure that the surface &/or seepage water does not collect or remain under floor area.
- Sustainable timbers and not rainforest or old growth timber will be use. Recycled timber or second hand timbers are to be sourced and used in preference to plantation timbers, if available and suitable
- All glazing installed is to comply with AS 1288, 2047 and in accordance with manufacturers
- All wall and ceiling linings to be plasterboard and villaboard or equal in wet areas. A breathable wall wrap is to be provided to all external walls. Timber cladding is to be battened out from timber frame to provide an 'air' gap to prevent condensation. Workmanship is to comply with the relevant Australian Standards or installed In accordance with manufacturer's specification. All bathrooms and wet areas to be waterproofed with a flexible membrane to manufacturer's specification and to AS 3740 and Part 3.8.1 of the Building Code of Australia Housing Provisions.
- All Architraves and skirtings to the profile as selected by owner, and painted or stain finish as selected.
- All plumbing and drainage work to be installed and completed by a licensed tradesman and in accordance with the statutory body having authority over the works. Connect all waste to Sydney Water sewer line.
- Connect all stormwater to existing system or street drainage system in accordance with AS 3500 and part 3.1.2 Drainage of the Building Code of Australia Housing Provisions.
- Smoke detector alarms to be installed in accordance with AS3786 and the Building Code of Australia/ NCC clause 3.7.2.2.
- If a member which provides structural support to the work is subject to attack by Termites protection measures are to comply with AS3660 and be installed to manufacturer's specification.

- Stairs and Balustrades to comply with part 3.9.1 & 3.9.2 of the Building Code of Australia Housing Provisions. Provide a handrail along the full length of the flight and a slip resistant finish to the edge of the nosings to comply with 3.9.1 and 3.9.2 of the NCC. No horizontal elements to facilitate climbing between 150mm and 760mm where floor to level below in more than 4m.
- Electrical works to be in accordance with SAA wiring rules and be done by a licenced tradesperson. Obtain electrical layout prior to proceeding. All electrical power (GPO's) and light outlets to be determined
- Painting: All paints or other coatings shall be of the best quality materials & of approved manufacture. All priming materials shall be of an approved brand acceptable to the manufacturer of the finishing coats to be
- used. External joinery intended to be painted shall be primed on all faces at the place of assembly. Where new work or alteration work adjoins existing painted surfaces allow for repainting existing surfaces to provide uniform appearance.
- ZERO-VOC or LOW-VOC paints and primers only are to be used.

Any work indicated on the plans but not specified and any item not shown on the plans which is obviously necessary as part of proper construction and/or finish, is to be considered as shown and specified and is to

- undertaken at the Builder's expense
- Variations will not be permitted without prior written approval by the owners.
- The Builder shall provide sediment and siltration control measures as required by Council and maintain them throughout the duration of the works.
- A legible copy of the plans bearing approval stamps, must be maintained on the job site at all times. Hours of construction shall be restricted to the times as required by the building approval.
- The Builder is to arrange for all inspections required by the relevant authorities and/or lending institutions, to their requirements.
- The Builder is to obtain approval for interruptions to existing services and minimise the duration and number ofinterruptions. Any interruptions to existing services and equipment is to be undertaken by appropriately qualified tradespersons.
- The Builder shall restore, reinstate or replace any damage to existing structures or landscaping caused by the construction works or workmen
- Provide protection to existing trees to remain, or as required by the Approval Conditions.

GENERAL NOTATION

- Approved means by the 'relevant local authority' or council
- The owner will directly pay the fees associated with the following:

building approval from council, footpath and kerb deposits with the local council, insurance fee to building services corporation, long service leave service levy fee and approval fee by water and sewerage authority. all other fees are to be paid by the builder, the amount of any local authority deposits which are forfeited due to damage or other cause will be deducted from the payments due to the builder

- The builder is to provide at his/her own expense adequate public risk insurance and arrange indemnification under the workers compensation act. works insurance to be stated in the contract
- All work to be carried out in a tradesmen like manner and in accordance with the standards codes and regulations of the standards association of Australia, building code of Australia and any statutory authority having jurisdiction over the work.
- All tenderers are to visit the site to satisfy themselves as to the nature and extent of the works, facilities available and difficulties entailed in the works as variations will not be allowed due to work arising owing to neglect of this clause
- All work and materials to comply with the current Australian standards at the time of commencement were applicable.
- These drawings shall be read in conjunction with all structural and other consultants drawings and specifications and with any such written instructions as may be issued during the course of the contract.
- Set out dimensions shown on this drawing shall be verified by the builder on site before commencement of any work. dimensions should not be obtained by scaling the drawings. use only figured dimensions. all dimensions are in millimetres.
- The builder is to ensure all construction, levels and other items comply with the conditions of the building
- The builder is to comply with all ordinances, local authority regulations and the requirements of all services supply authorities having jurisdiction over the works.
- All plumbing and drainage work to be installed and completed by a licenced tradesman and in accordance with the statutory body having authority over the works, connect all waste to Sydney water sewer line
- All new downpipes are to be connected to the existing storm water system
- All power and stormwater outlet locations shall be determined onsite by the owner.
- Smoke detector alarm to be installed in accordance with as3786 and the building code of Australia.
- Electrical work to be in accordance with SAA wiring rules and be done by a licenced tradesman
- Any detailing in addition to what is supplied shall be resolved between the owner and the builder to the owner's approval, except for any structural details or design which is supplied by the engineer
- All timber sizes and concrete details to be confirmed by the builder prior to commencement of any work. - All structural work is to be in accordance with the structural details prepared by a structural engineer(i.e.) piers, footings, concrete slabs, retaining walls, steelwork, formwork, underpinning, additional structural loads, timber framing, wind bracing and associated connections. builder to obtain prior to finalising tender.
- Any work indicated on the plans but not specified, and any item not shown on the plan which is obviously necessary as a part of construction and/or finish is to be considered as shown and specified, and is to be done as part of the contract, variations will not be permitted without the written consent of the owner.
- The builder shall provide sediment and siltration control measures as required by council and maintain them through the duration of the works.
- A legible copy of the plans bearing approval stamps must be maintained on the job at all times. hours of construction will be restricted to the times as required by the building approval
- The builder is to arrange for all inspections required by the authorities and lending institutions to their
- The builder is to obtain approval for interruptions to existing services and minimise the duration and number of interruptions. any interruptions with existing services and equipment to be attended to by the appropriately skilled tradesmen.
- The builder shall restore, reinstate or replace any damage caused to existing structures or landscaping by construction work or workmen, provide protection to existing trees to remain as required by approval conditions.

- All brickwork is to be selected by owner and is to comply with as1640
- All masonry to comply with as3700
- All metalwork and flashing items necessary to satisfactory complete work shall be provided.
- All autters, downpipes to be colorbond.
- All timber construction to be in accordance with the Australian standard 1684 "timber framing code"
- All glazing installed to comply with as 1288, 2047 and in accordance with manufacturers recommendation
- All wall and ceiling linings to be plasterboard or cement render as selected and villa board in wet areas, to comply with the relevant Australian standards or installed in accordance with manufacturers specification. - All bathrooms and wet areas to be adequately waterproofed to manufacturers speciation and as3740 and part 3.8.1 of the building code of Australia housing provisions
- Stairs and balustrades to comply with part 3.9.1 & 3.9.2 of the building code of Australia housing provision.
- Termite protection measures to comply with as 3660 and be installed to manufacturers specification.
- Any detailing additional to that supplied, shall be resolved between the owner and the builder to the owners approval. except for any structural details or design which is to be supplied by the structural

NCC & AS COMPLIANCES SPECIFICATIONS

- Earthworks part 3.1.1 of NCC
- Earth retaining structures part 3.1.2 of NCC & AS 4678-2002
- Drainage part 3.1.3 of NCC
- Termite-risk management part 3.1.4 of NCC & AS 3660
- Footings & slab part 3.2 of NCC & AS 2870-2011
- Masonry part 3.3 of NCC & AS 3700:2018
- Framing part 3.4 of NCC
- Sub floor ventilation part 3.4.1 of NCC
- Roof & wall-cladding part 3.5 of NCC
- Glazing part 3.6 of NCC & AS 1288, AS 2047
- Fire safety part 3.7 of NCC
- Fire separation of external walls part 3.7.2 of NCC
- Fire protection of separating walls & floors part 3.7.3 of NCC
- Smoke Alarms part 3.7.5 of NCC & AS 3786
- Wet areas & external waterproofing part 3.8.1 of NCC - Room heights - part 3.8.2 of NCC
- Facilities part 3.8.3 of NCC
- Light part 3.8.4 of NCC
- Ventilation part 3.8.5 of NCC
- Sound insulation part 3.8.6 of NCC
- Stairway and ramp construction part 3.9.1 of NCC
- Barriers and handrails part 3.9.2 of NCC
- Swimming pools part 3.10.1 of NCC
- Construction in bushfire prone areas part 3.10.5 of NCC - Fencing & other provisions - Regs & AS 1926.1-2012
- Demolition works AS 2601-2001
- Waterproofing of domestic wet areas to AS 3740-2021
- Plumbing & drainage work to comply with AS 3500:2021 - Plasterboard work to comply with AS 2588:2018
- Structural steel work to comply with AS 4100-2020 & AS 1554:2014
- Concrete work to comply with AS 3600:2018
- Metal roof & wall cladding to comply with AS 1562.1:2018 - Skylights to comply with AS 4285:2019
- Ceramic tiling to comply with AS 3958.1-2007 & 3958.2-1992
- Glazing assemblies to comply with AS 2047:2014 & AS 1288:2021 - Construction of buildings in bushfire prone areas to AS 3959:2018





THIS SET OF DRAWING SHOULD BE READ & KEPT IN ITS ENTIRETY. NO INDIVIDUAL PAGE SHOULD BE SEPARATED FROM THE REST OF THE SET. EACH NOTATION LISTED ON THIS PAGE APPLY TO ALL PAGES OF THIS SET.

SAFTEY NOTES

THESE NOTES MUST BE READ AND UNDERSTOOD BY ALL INVOLVED IN THE PROJECT. THIS INCLUDES (but is not excluded to): OWNER, BUILDER, SUB-CONTRACTORS, CONSULTANTS, RENOVATORS, OPERATORS, MAINTENORS, DEMOLISHERS.

1. FALLS, SLIPS, TRIPS

a) WORKING AT HEIGHTS

DURING CONSTRUCTION

Wherever possible, components for this building should be prefabricated off-site or at ground level to minimise the risk of workers falling more than two metres. However, construction of this building will require workers to be working at heights where a fall in excess of two metres is possible and injury is likely to result from such a fall. The builder should provide a suitable barrier wherever a person is required to work in a situation where falling more than two metres is a possibility.

DURING OPERATION OR MAINTENANCE

For houses or other low-rise buildings where scaffolding is appropriate: Cleaning and maintenance of windows, walls, roof or other components of this building will require persons to be situated where a fall from a height in excess of two metres is possible. Where this type of activity is required, scaffolding, ladders or trestles should be used in accordance with relevant codes of practice, regulations or legislation. For buildings where scaffold, ladders, trestles are not appropriate: Cleaning and maintenance of windows, walls, roof or other components of this building will require persons to be situated where a fall from a height in excess of two metres is possible. Where this type of activity is required, scaffolding, fall barriers or Personal Protective Equipment (PPE) should be used in accordance with relevant codes of practice, regulations or legislation.

b) SLIPPERY OR UNEVEN SURFACES

FLOOR FINISHES Specified

If finishes have been specified by designer, these have been selected to minimise the risk of floors and paved areas becoming slippery when wet or when walked on with wet shoes/ feet. Any changes to the specified finish should be made in consultation with the designer or, if this is not practical, surfaces with an equivalent or better slip resistance should be chosen.

FLOOR FINISHES By Owner

If designer has not been involved in the selection of surface finishes. the owner is responsible for the selection of surface finishes in the pedestrian trafficable areas of this building. Surfaces should be selected in accordance with AS HB 197:1999 and AS/ NZ 4586:2004.

STEPS, LOOSE OBJECTS AND UNEVEN SURFACES

Due to design restrictions for this building, steps and/ or ramps are included in the building which may be a hazard to workers carrying objects or otherwise occupied. Steps should be clearly marked with both visual and tactile warning during construction, maintenance, demolition and at all times when the building operates as a workplace. Building owners and occupiers should monitor the pedestrian access ways and in particular access to areas where maintenance is routinely carried out to ensure that surfaces have not moved or cracked so that they become uneven and present a trip hazard. Spills, loose material, stray objects or any other matter that may cause a slip or trip hazard should be cleaned or removed from access ways. Contractors should be required to maintain a tidy work site during construction, maintenance or demolition to reduce the risk of trips and falls in the workplace. Materials for construction or maintenance should be stored in designated areas away from access ways and work areas.

2. FALLING OBJECTS

LOOSE MATERIALS OR SMALL OBJECTS

Construction, maintenance or demolition work on or around this building is likely to involve persons working above ground level or above floor levels. Where this occurs one or more of the following measures should be token to ovoid objects falling from the area where the work is being carried out onto persons below.

- 1. Prevent or restrict access to areas below where the work is being carried out.
- 2. Provide toeboards to scaffolding or work platforms3. Provide protective structure below the work area.
- Frovide protective structure below the work area.
 Ensure that all persons below the work area have Personal
- Protective Equipment (PPE).

BUILDING COMPONENTS

During construction, renovation or demolition of this building, parts of the structure including fabricated steelwork, heavy panels and many other components will remain standing prior to or after supporting parts are in place. Contractors should ensure that temporary bracing or other required support is in place at all times when collapse which may injure persons in the area is a possibility. Mechanical lifting of materials and components during construction, maintenance or demolition presents a risk of falling objects. Contractors should ensure that appropriate lifting devices are used, that loads are properly secured and that access to areas below the load is prevented or restricted.

3. TRAFFIC MANAGEMENT

For building on a major road, narrow road or steeply sloping road: Parking of vehicles or loading/ unloading of vehicles on this roadway may cause a traffic hazard. During construction, maintenance or demolition of this building designated parking for workers and loading areas should be provided. Trained traffic management personnel should be responsible for the supervision of these areas. For building where onsite loading/ unloading is restricted: Construction of this building will require loading and unloading of materials on the roadway. Deliveries should be well planned to ovoid congestion of loading areas and trained traffic management personnel should be used to supervise loading/ unloading areas. For all buildings: Busy construction and demolition sites present a risk of collision where deliveries and other traffic are moving within the site. A traffic management plan supervised by trained traffic management personnel should be adopted for the work site.

4. SERVICES

GENERAL

Rupture of services during excavation or other activity creates a variety of risks including release of hazardous material. Existing services are located on or around this site. Where known, these ore identified on the plans but the excel location and extent of services may vary from that indicated. Services should be located using on appropriate service (such as Dial Before You Dig), appropriate excavation practice should be used and, where necessary, specialist contractors should be used. Locations with underground power: Underground power lines MAY be located in or around this site. All underground power lines must be disconnected or carefully located and adequate warning signs used prior to any construction, maintenance or demolition commencing. Locations with overhead power lines: Overhead power lines MAY be near or on this site. These pose a risk of electrocution if struck or approached by lifting devices or other plant and persons working above ground level. Where there is a danger of this occurring, power lines should be, where practical, disconnected or relocated. Where this is not practical adequate warning in the form of bright coloured tape or signage should be used or a protective barrier provided.

5. MANUAL TASKS

Components within this design with a moss in excess of 25kg should be lifted by two or more workers or by mechanical lifting device. Where this is not practical, suppliers or fabricators should be required to limit the component mass. All material packaging, building and maintenance components should clearly show the total moss of packages and where practical all items should be stored on site in a way which minimises bending before lifting. Advice should be provided on safe lifting methods in all areas where lifting may occur. Construction, maintenance and demolition of this building will require the use of portable tools and equipment. These should be fully maintained in accordance with manufacturer's specifications and not used where faulty or (in the case of electrical equipment) not carrying a current electrical safety tag. All safety guards or devices should be regularly checked and Personal Protective Equipment should be used in accordance with manufacturer's specification.

6. HAZARDOUS SUBSTANCES

ASBESTOS

For alterations to a building constructed prior to 1990:

If this existing building was constructed prior to:

1990 - it therefore may contain asbestos

1986 - it therefore is likely to contain asbestos

either in cladding material or in fire retardant insulation material. In either case, the builder should check and, if necessary, take appropriate action before demolishing, culling, sanding, drilling or otherwise disturbing the existing structure.

POWDERED MATERIALS

Many materials used in the construction of this building con cause harm if inhaled in powdered form. Persons working on or in the building during construction, operational maintenance or demolition should ensure good ventilation and wear Personal Protective Equipment including protection against inhalation while using powdered material or when sanding, drilling, cutting or otherwise disturbing or creating powdered material.

TREATED TIMBER

The design of this building may include provision for the inclusion of treated limber within the structure. Dust or fumes from this material can be harmful. Persons working on or in the building during construction, operational maintenance or demolition should ensure good ventilation and wear Personal Protective Equipment including protection against inhalation of harmful material when sanding, drilling, cutting or using treated timber in any way that may cause harmful material lo be released. Do not burn treated timber.

VOLATILE ORGANIC COMPOUNDS

Many types of glue, solvents, spray packs, paints, varnishes and some cleaning materials and disinfectants have dangerous emissions. Areas where these are used should be kept well ventilated while the material is being used and for a period after installation. Personal Protective Equipment may also be required. The manufacturer's recommendations for use must be carefully considered at all times.

SYNTHETIC MINERAL FIBRE

Fibreglass, rockwool, ceramic and other material used for thermal or sound insulation may contain synthetic mineral fibre which may be harmful if inhaled or if it comes in contact with the skin, eyes or other sensitive parts or the body. Personal Protective Equipment including protection against inhalation of harmful material should be used when installing, removing or working near bulk insulation material.

TIMBER FLOOR

This building may contain timber floors which have an applied finish. Areas where finishes are applied should be kept well ventilated during sanding and application and for a period after installation. Personal Protective Equipment may also be required. The manufacturer's recommendations for use must be carefully considered at all times.

7. CONFINED SPACES

FXCAVATION

Construction of this building and some maintenance on the building will require excavation and installation of items within excavations. Where practical, installation should be carried out using methods which do not require workers to enter the excavation. Where this is not practical, adequate support for the excavated area should be provided to prevent collapse. Warning signs and barriers to prevent accidental or unauthorised access to all excavations should be provided.

ENCLOSED SPACES

For buildings with enclosed spaces where maintenance or other access may be required: Enclosed spaces within this building may present a risk to persons

entering for construction, maintenance or any other purpose. The design documentation calls for warning signs and barriers to unauthorised access. These should be maintained throughout the life of the building. Where workers are required to enter enclosed spaces, air testing equipment and Personal Protective Equipment should be provided.

SMALL SPACES

For buildings with small spaces where maintenance or other access may be required: Some small spaces within this building will require access by construction or maintenance workers. The design documentation calls for warning signs and barriers to unauthorised access. These should be maintained throughout the life of the building. Where workers are required to enter small spaces they should be scheduled so that access is for short periods. Manual lifting and other manual activity should be restricted in small spaces.

8. PUBLIC ACCESS

Public access to construction and demolition sites and lo areas under maintenance causes risk to workers and public. Warning signs and secure barriers to unauthorised access should be provided. Where electrical installations, excavations, plant or loose materials are present they should be secured when not fully supervised.

9. OPERATIONAL USE OF BUILDING RESIDENTIAL BUILDINGS

This building has been designed as a residential building. If it, at a later date, it is used or intended to be used as a workplace, the provisions of the Work Health and Safely Act 2011 or subsequent replacement Act should be applied to the new use.

NON-RESIDENTIAL BUILDINGS


For non-residential buildings where the end-use has not been identified: This building has been designed to requirements of the classification identified on the drawings. The specific, use of the building is not known at the time of the design and a further assessment of the workplace health and safety issues should be undertaken at the time of fit-out for the end-user. For non-residential buildings where the end-use is known: This building has been designed for the specific use as identified on the drawings. Where a change of use occurs at a later dale a further assessment of the workplace health and safety issues should be undertaken.

10. OTHER HIGH RISK ACTIVITY

All electrical work should be carried out in accordance with Code of Practice: Managing Electrical Risks at the Workplace, AS/ NZ 3012 and all licensing requirements. All work using Plant should be carried out in accordance with Code of Practice: Managing Risks of Plant at the Workplace. All work should be carried out in accordance with Code of Practice: Managing Noise and Preventing Hearing Loss at Work. Due to the history of serious incidents it is recommended that particular care be exercised when undertaking work involving steel construction and concrete placement. All the above applies.





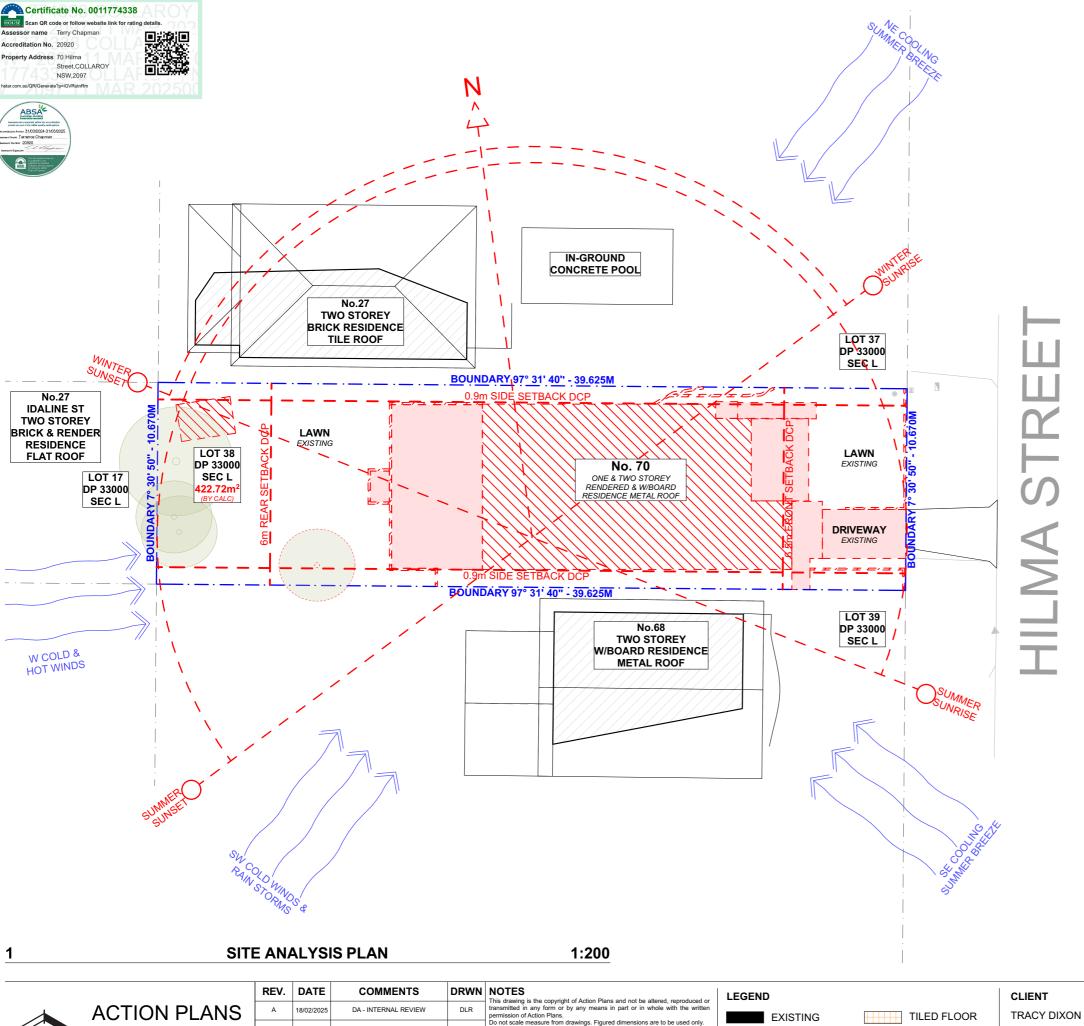



LOCATION VIEW

Figure 51 Figure 51 Figure 52 Figure 52 Figure 52 Figure 53 Figure 53 Figure 54 Figure 54 Figure 55 Figure

NOTE: ALL DEMOLISHED ELEMENTS TO ENG. SPECIFICATIONS AND AS. 2601 - 2001

DRAWING NAME



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	REV.	DATE	COMMENTS	DRWN	NOTES This drawing is the
	А	18/02/2025	DA - INTERNAL REVIEW	DLR	transmitted in any fi permission of Action
	В	20/02/25	DA - SUBMISSION	DLR	Do not scale measu The Builder/contract and approved levels
					construction, the bo
1					commencement of components. All errors and omiss
					referred to the desig

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Do not scale measure from drawings. Figured dimensions are to be used only. The Builder/contractor/owner is to ensure that the approved boundary setbacks and approved levels are confirmed and set out by a registered Surveyor prior to construction, the boundary setbacks take precedence over all other dimensions. The Builder/Contractor shall check and verify ALL dimensions on site prior to commencement of any work, creation of shop drawings, or fabrication of commonents.



PROJECT ADDRESS 70 HILMA STREET, COLLAROY PLATEAU NSW 2097


DRAWING NO.

DA03

SITE ANALYSIS

DATE SCALE 20 February 2025 1:200 @A3



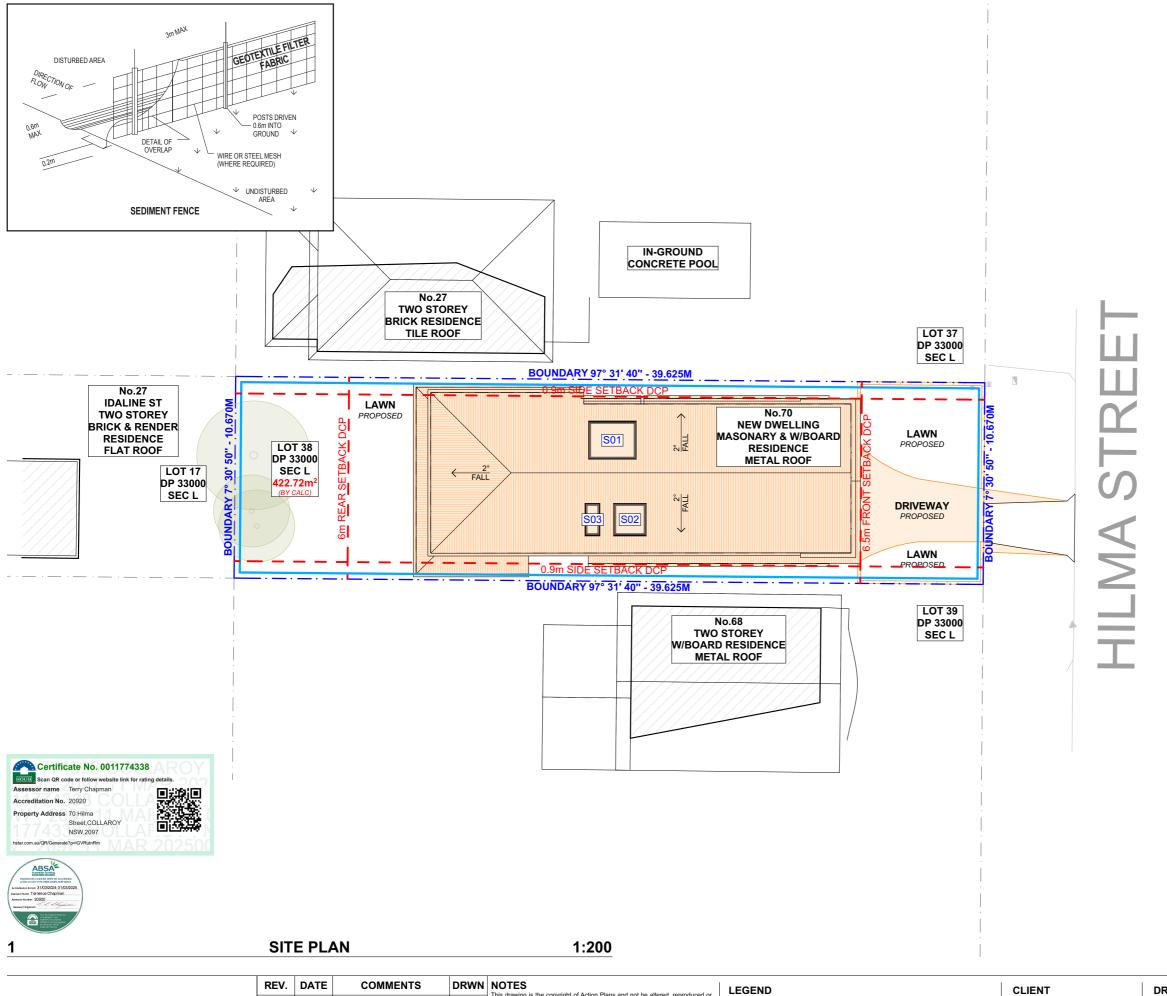

NOTES REGARDING BOUNDARY

THE INFORMATION SHOWN ON THIS PLAN IS FOR DESIGN PURPOSES ONLY. THE POSITION OF BOUNDARY LINES HAVE BEEN ESTABLISHED BY A SURVEY TO MEET THE IDENTIFICATION REQUIREMENTS FOR COUNCIL AND NOT FOR REGISTRATION WITH THE LAND REGISTRATION SERVICES NSW NOR MAY THIS PLAN BE USED FOR ANY OTHER PURPOSE. SUBSEQUENT REGISTERED OR OTHER SURVEYS MAY AFFECT THE DEFINED BOUNDARY POSITIONS IN THIS AREA. ANY DIFFERENCES OF THIS NATURE ARE BEYOND THE PURPOSES OF THIS PLAN. THIS PLAN IS FOR THE ABOVE STATED PURPOSES ONLY. RESTRICTIONS ON THE TITLE HAVE NOT BEEN INVESTIGATED. IF FURTHER DEVELOPMENT IS CONTEMPLATED OR CONSTRUCTION INTENDED THEN IT IS IMPORTANT THAT A SURVEY SET OUT IS CARRIED OUT.

DUST CONTROL:

TO REDUCE DUST GENERATED BY WIND ACTION, THE REMOVAL OF THE TOP SOIL IS TO BE MINIMISED. TO PREVENT DUST GENERATION, WATERING DOWN OF THE SITE, ESPECIALLY DURING THE MOVEMENT OF MACHINERY IS REQUIRED. WHERE EXCAVATING INTO ROCK, KEEP THE SURFACE MOIST TO MINIMISE DUST. CONSTRUCT A GRAVEL ENTRY/EXIT POINT USING BLUE METAL AND RESTRICT ALL VEHICLE MOVEMENTS WITHIN THE SITE TO A MINIMUM. ENSURE WIND BREAKS, SUCH AS EXISTING FENCES ARE MAINTAINED DURING THE CONSTRUCTION PHASE UNTIL NEW LANDSCAPING IS PROVIDED OR REINSTATED. PREVENT DUST BY COVERING STOCKPILES

1. ALL EROSION AND SEDIMENT CONTROL MEASURES TO BE INSPECTED AND MAINTAINED DAILY BY THE SITE MANAGER.

MINIMISE DISTURBED AREAS, REMOVE EXCESS SOIL FROM EXCAVATEDAREA AS SOON AS POSSIBLE. 3. ALL MATERIAL STOCKPILE TO BE CLEAR FROM DRAINS, GUTTERS AND FOOTPATHS, OR WITHIN SEDIMENT FENCE AREA

4. DRAINAGE TO BE CONNECTED TO STORMWATERAS SOON AS POSSIBLE. IF STORED ON SITE, IT MUST BE FILTERED BEFORE RELEASING INTO STORMWATER SYSTEM OR WATERWAYS.

5. ROADS AND FOOTPATHS TO BE SWEPT DAILY.

STOCKPILES:

ALL STOCKPILES ARE TO BE KEPT ON-SITE WHERE POSSIBLE. ANY MATERIALS PLACED ON THE FOOTPATHS OR NATURE STRIPS REQUIRE COUNCIL'S PERMISSION.

ALL STOCKPILES ARE TO BE PLACED AWAY FROM THE DRAINAGE LINES AND STREET GUTTERS. IT IS BEST TO LOCATE THESE ON THE HIGHEST PART OF THE SITE IF POSSIBLE. PLACE WATERPROOF COVERING OVER STOCKPILES.

IF REQUIRED PROVIDE DIVERSION DRAIN & BANK AROUND STOCKPILES.

GUTTER PROTECTION:


PROVIDE PROTECTION TO DOWNHILL GRATE IN GUTTER BY MEANS OF SAND BAGS OR BLUE METAL WRAPPED IN GEOTEXTILE FABRIC, WHEN SOIL OR SAND BUILDS UP AROUND THIS SEDIMENT BARRIER, THE MATERIAL SHOULD BE RELOCATED BACK TO THE SITE FOR DISPOSAL.

> NOTE: ALL PROPOSED STORMWATER TO CONNECT WITH EXISTING

NOTE: SITE BOUNDARY IS TO BE IDENTIFIED BY A REGISTERED SURVEYOR AND CLEARLY MARKED ON SITE PRIOR TO COMMENCEMENT OF ANY CONSTRUCTION WORKS.

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NSW 2097

COLLAROY PLATEAU

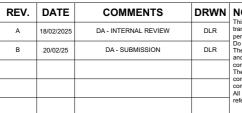PROJECT ADDRESS 70 HILMA STREET. 20 February 2025

DRAWING NO.

DA04


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DRAWING NAME

SITE / ROOF / SEDIMENT EROSION / WASTE MANAGEMENT / STORMWATER SONGEPT PLAN

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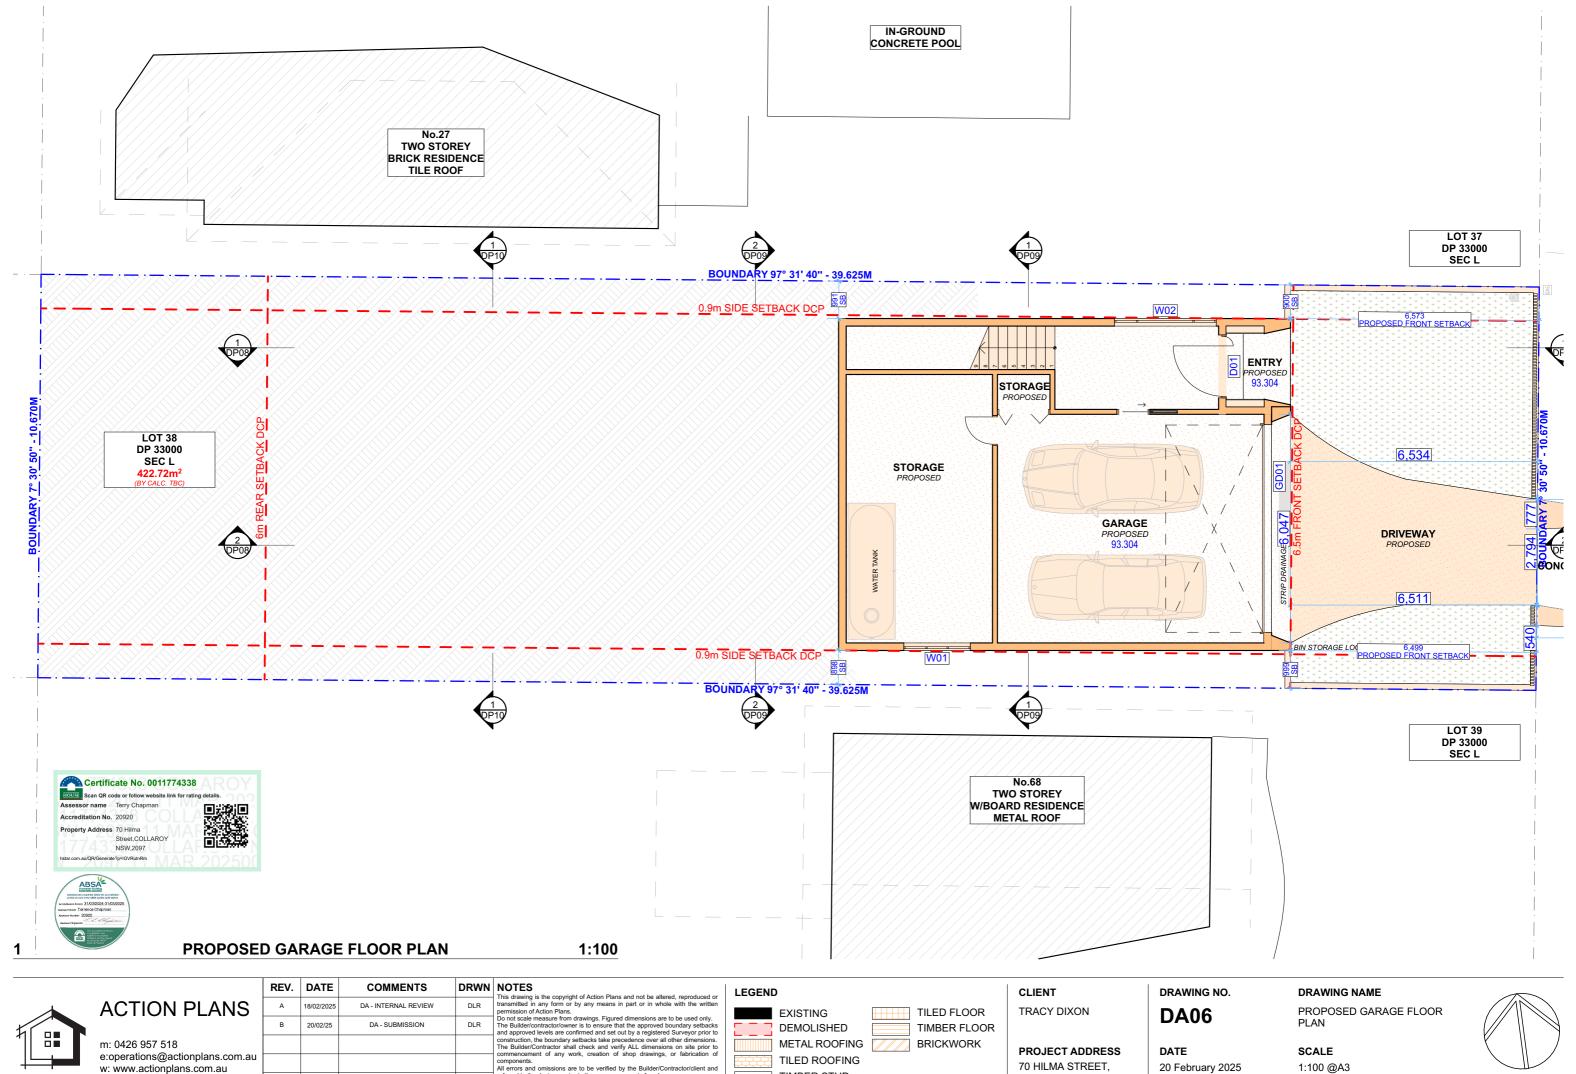
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70 HILMA STREET, COLLAROY PLATEAU NSW 2097

20 February 2025

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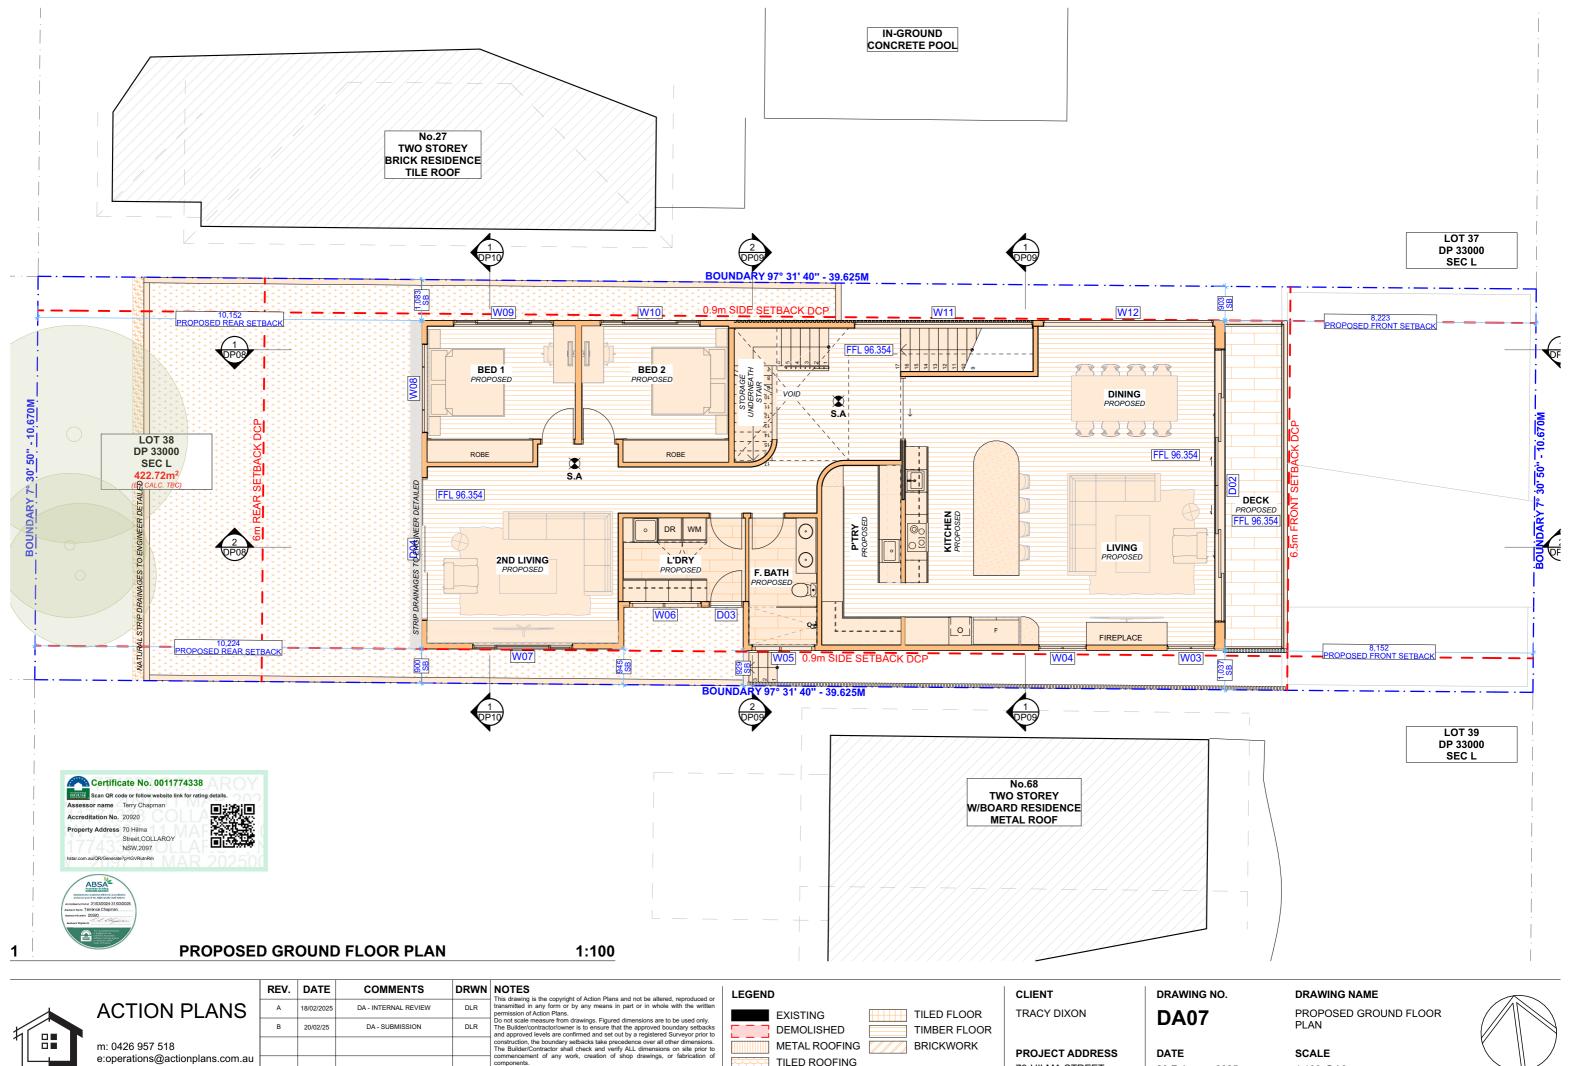


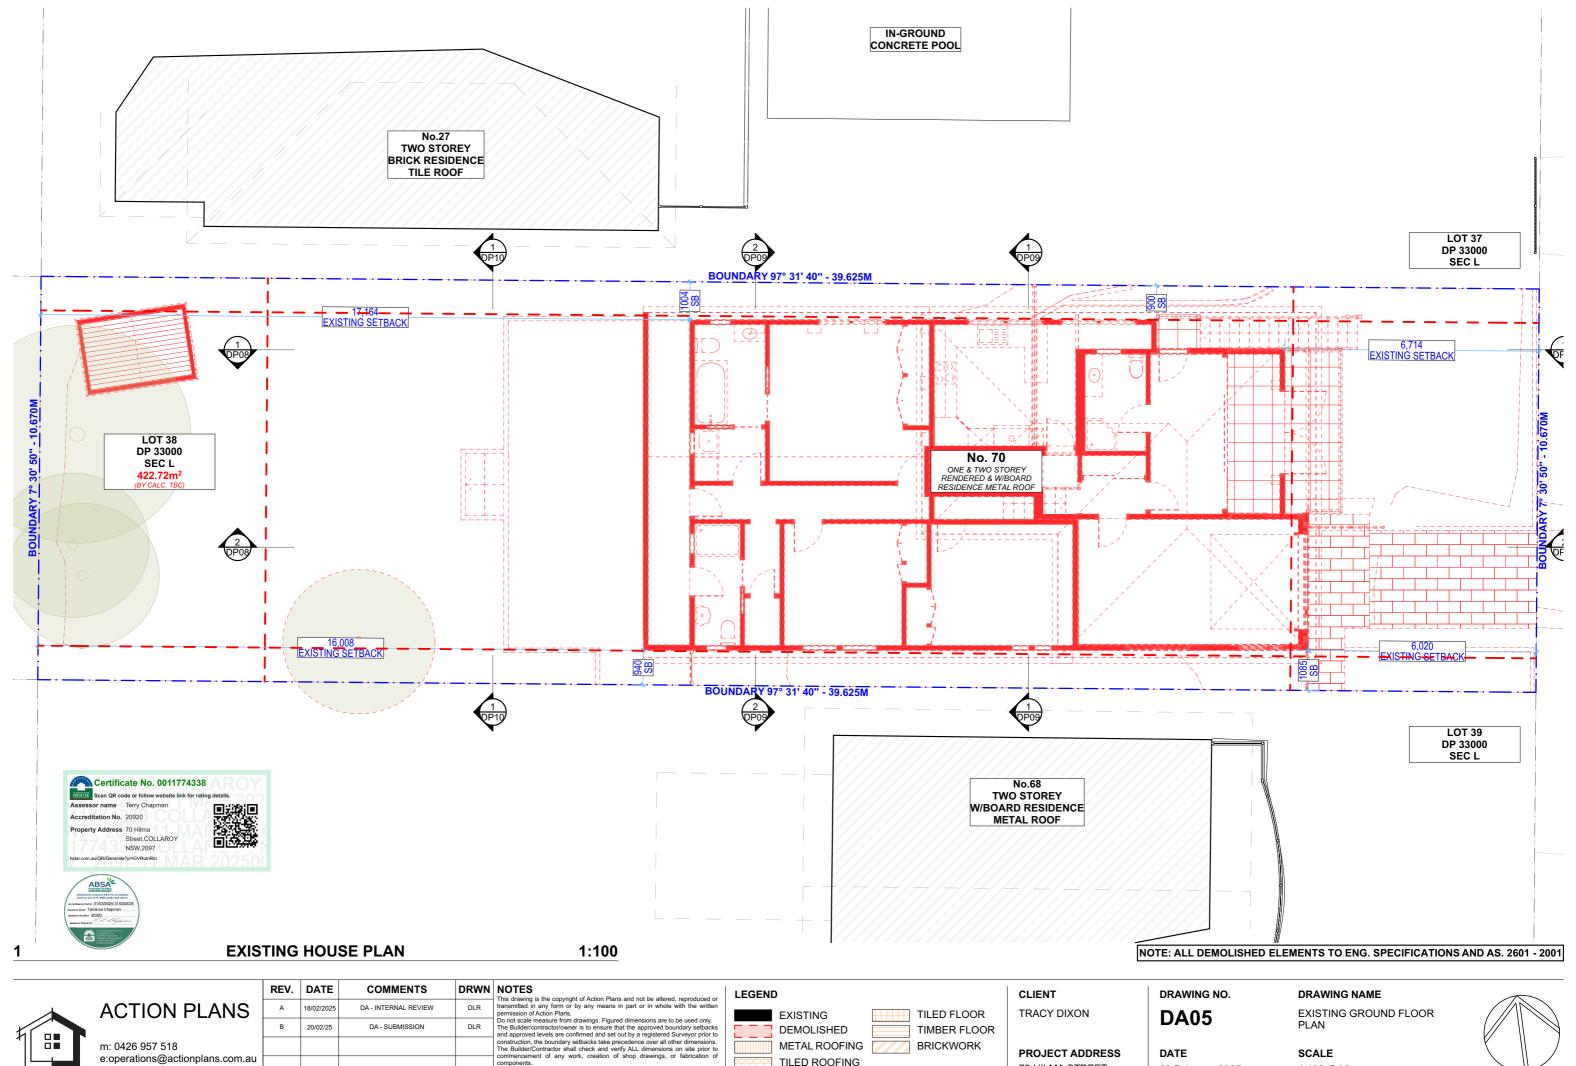

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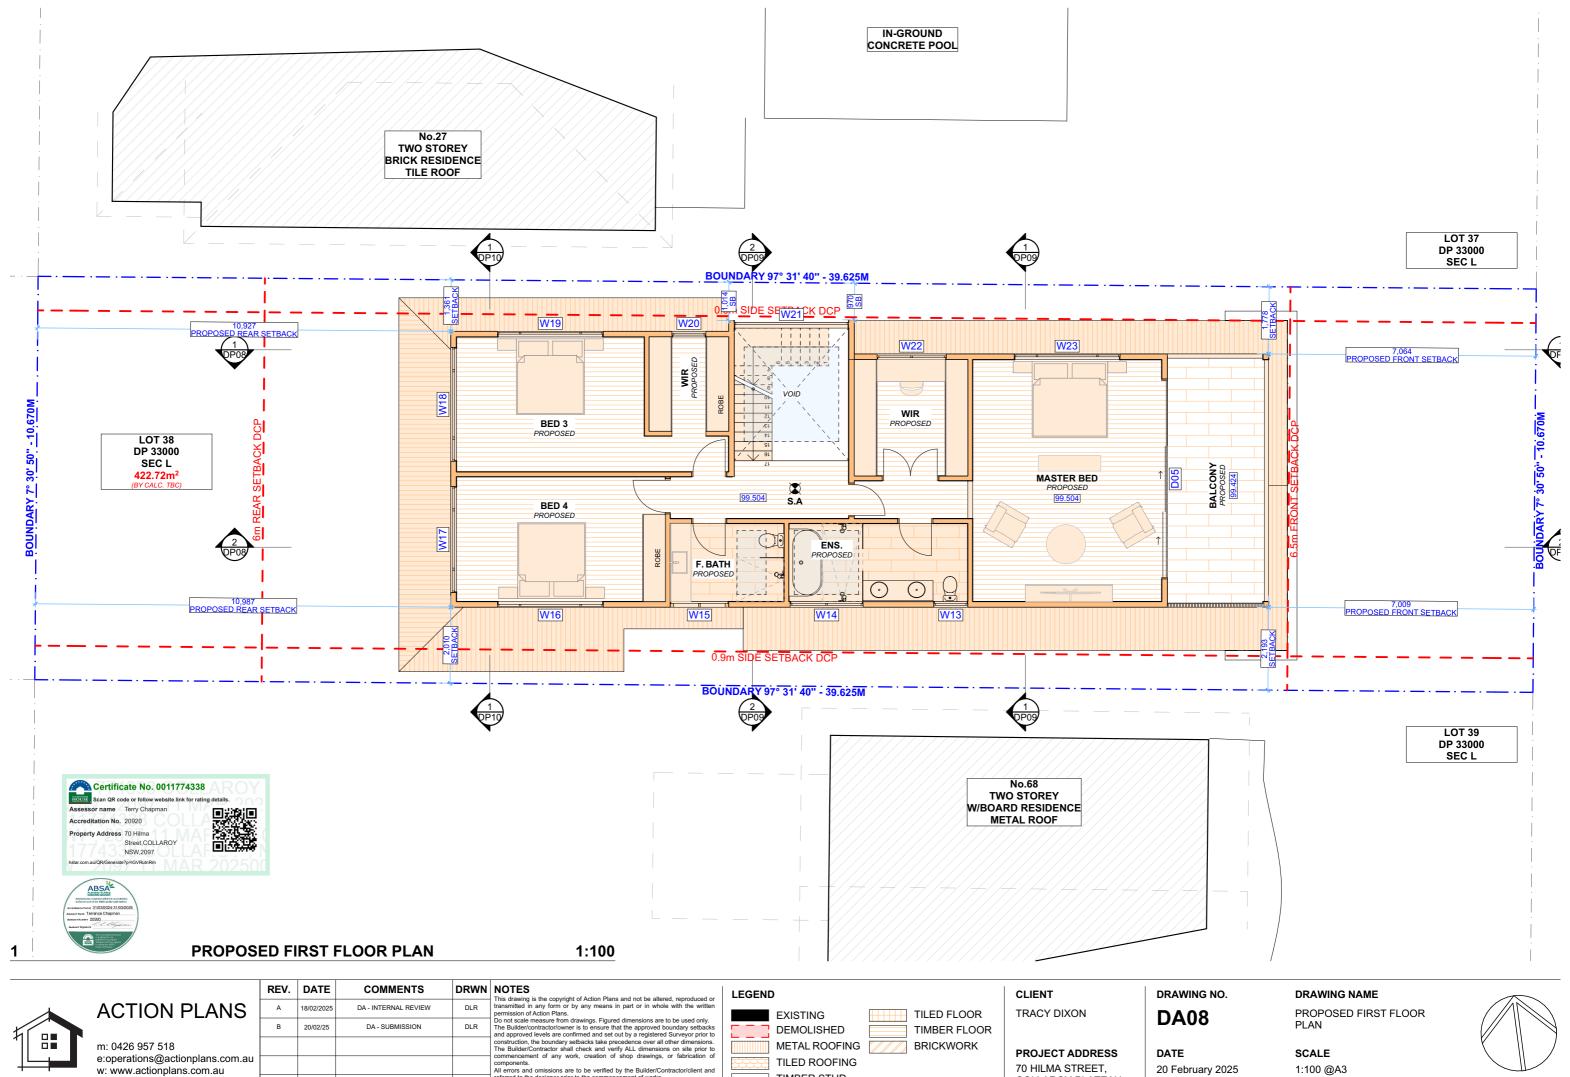


70 HILMA STREET, COLLAROY PLATEAU NSW 2097

20 February 2025

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Certificate No. 0011774338 Accreditation No. 20920 Property Address 70 Hilma Street, COLLAROY NSW, 2097




DRIVEWAY PLAN 1:50



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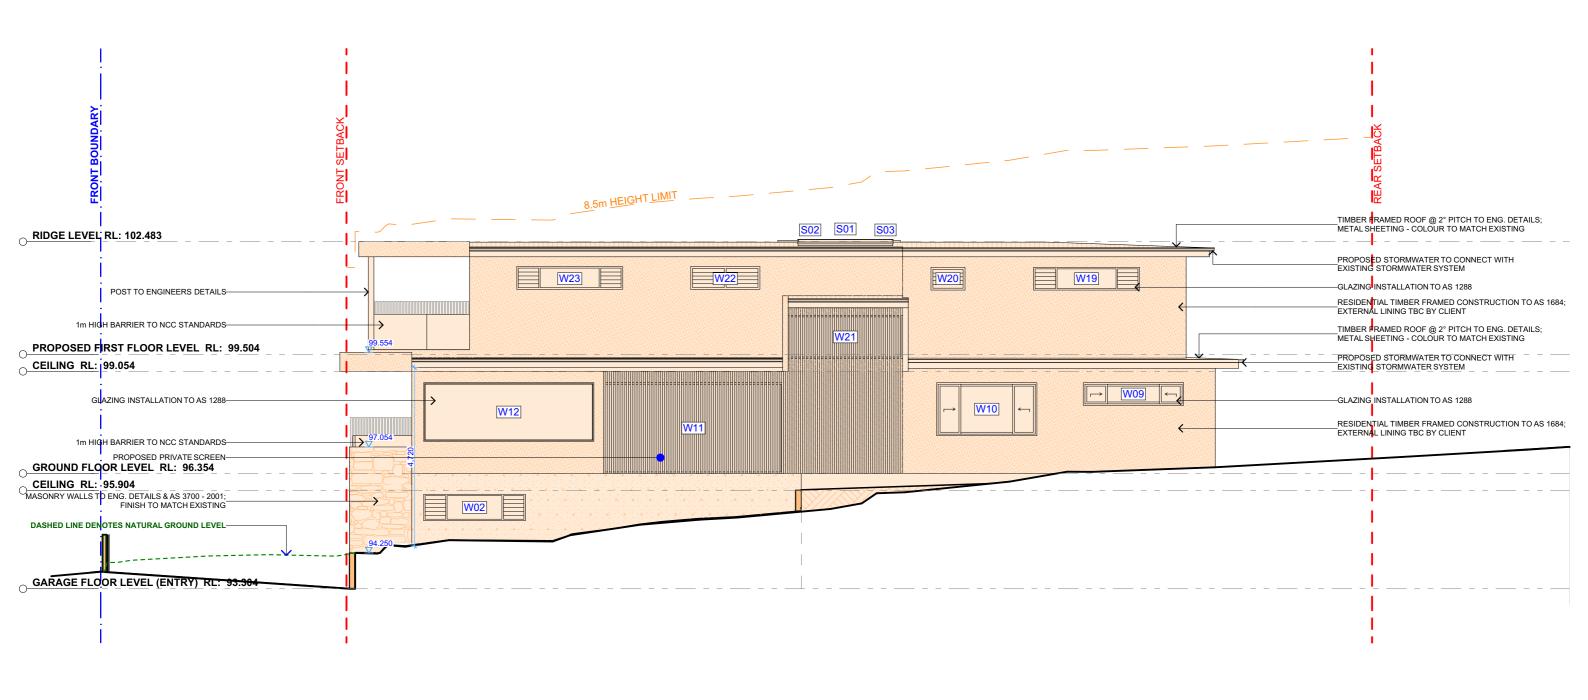
DATE 20 February 2025 DRAWING NAME PROPOSED DRIVEWAY PLAN

SCALE 1:50 @A3



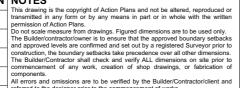





1 NORTH ELEVATION - SIDE 1:100



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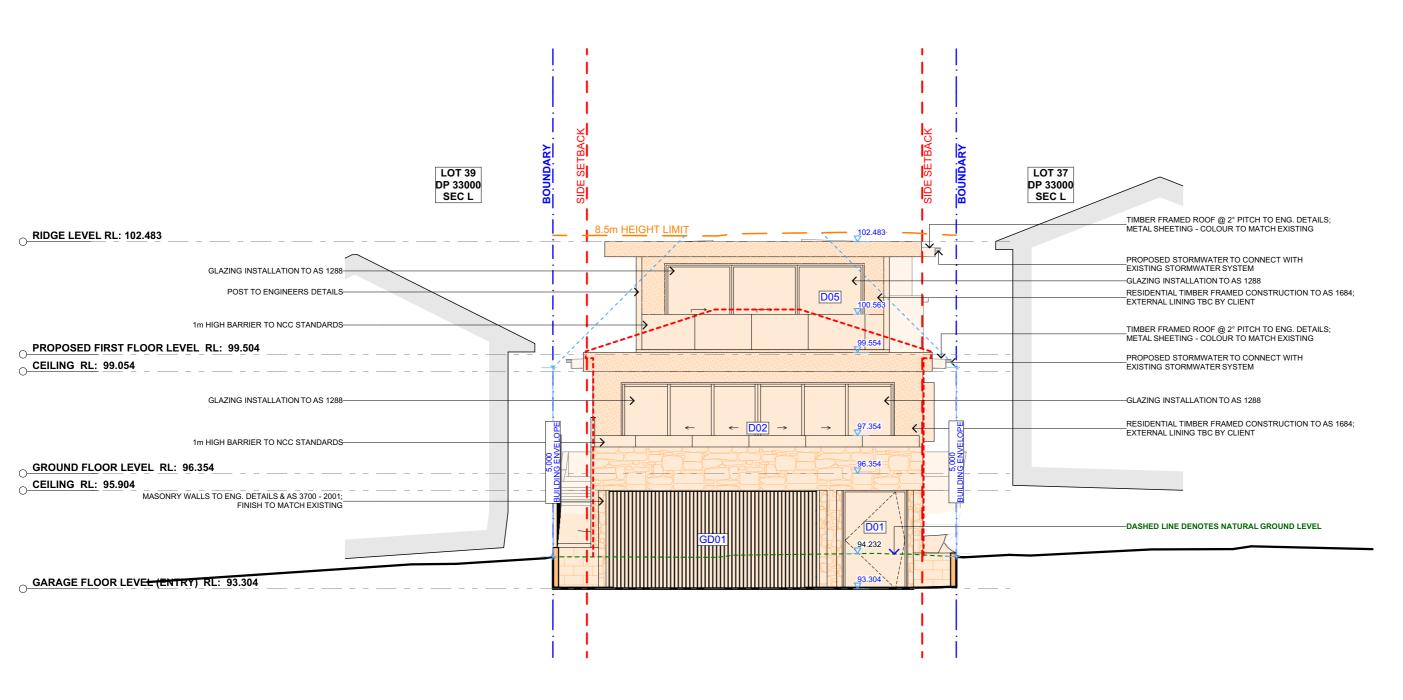
DA10

DRAWING NAMENORTH ELEVATION - SIDE

DATE
20 February 2025







EAST ELEVATION - PRIMARY ROAD 1:100



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EAST ELEVATION - PRIMARY ROAD


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1 EAST ELEVATION (STREET) 1:100



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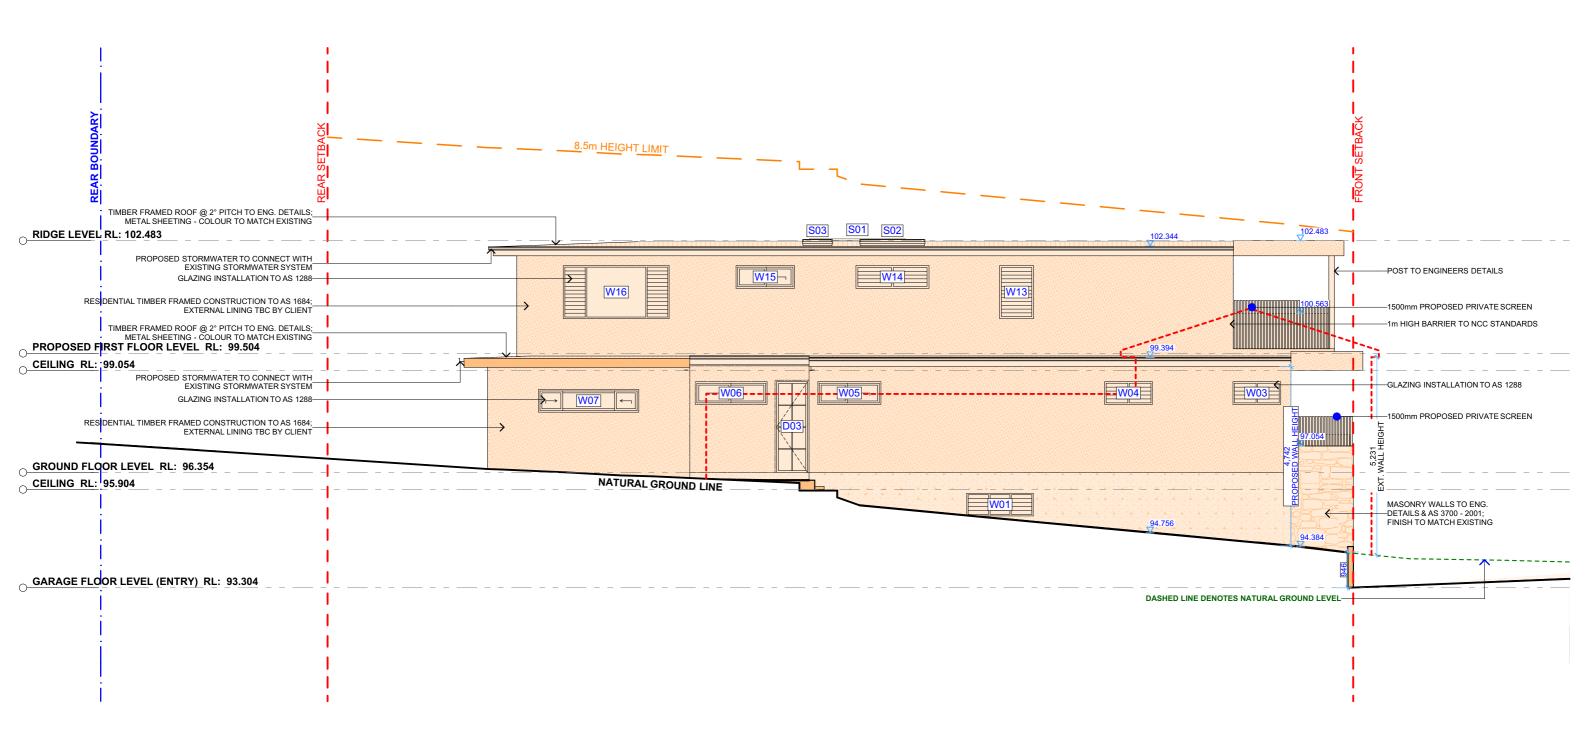
DATE20 February 2025

DRAWING NAME

EAST ELEVATION - STREET

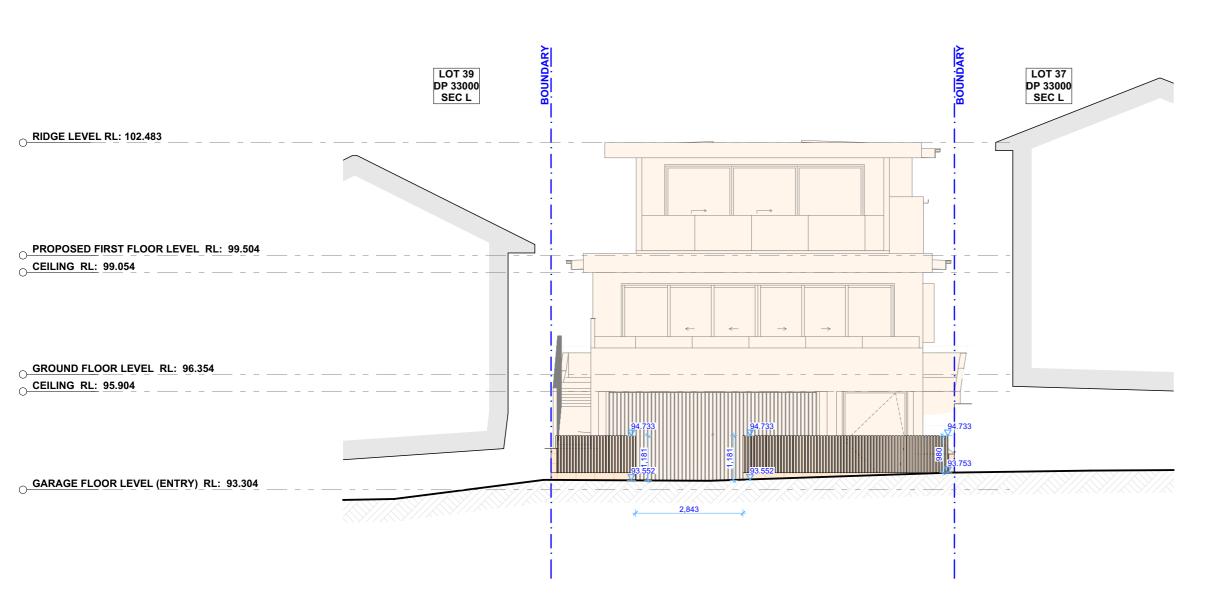





1 SOUTH ELEVATION - SIDE 1:100



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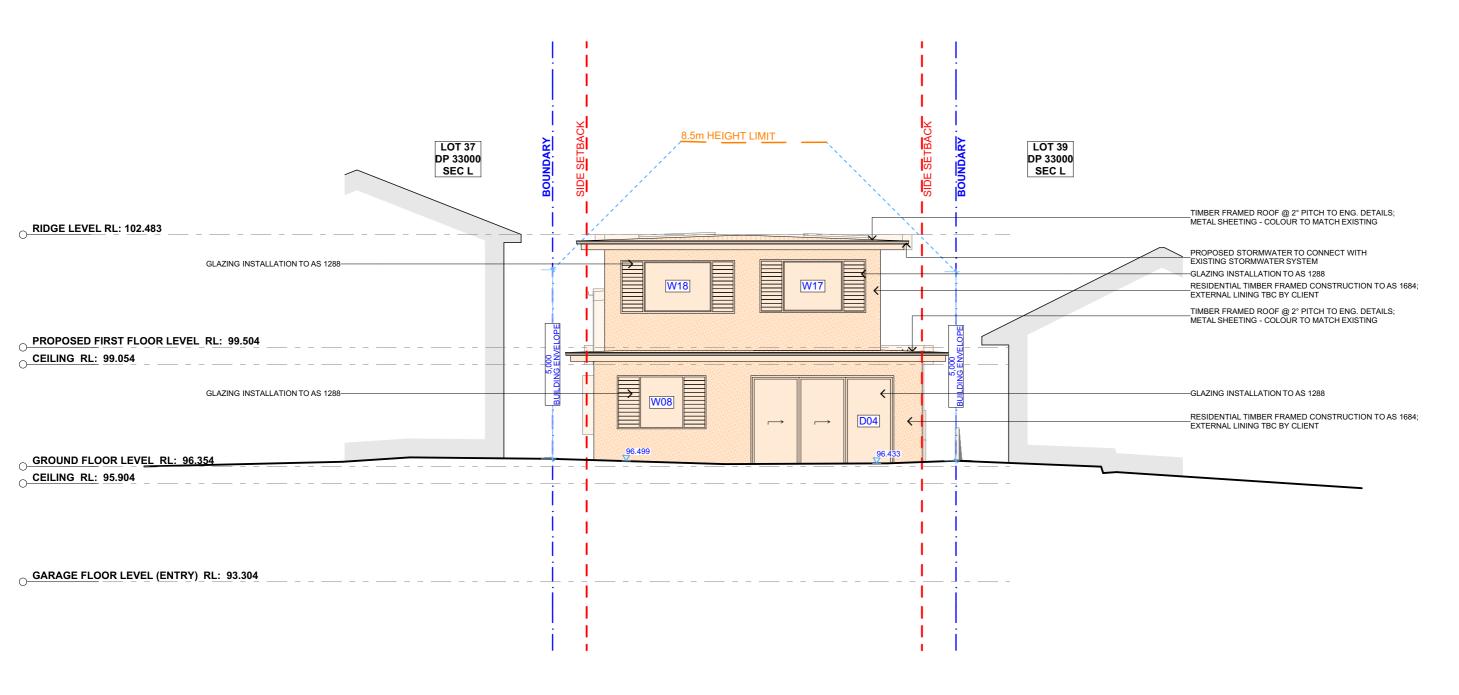
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SOUTH ELEVATION - SIDE

PROJECT ADDRESS
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COLLAROY PLATEAU
NSW 2097

DATE
20 February 2025







WEST ELEVATION - REAR 1:100



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COLLAROY PLATEAU


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DRAWING NO. DRAWING NAME WEST ELEVATION - REAR

DATE 20 February 2025





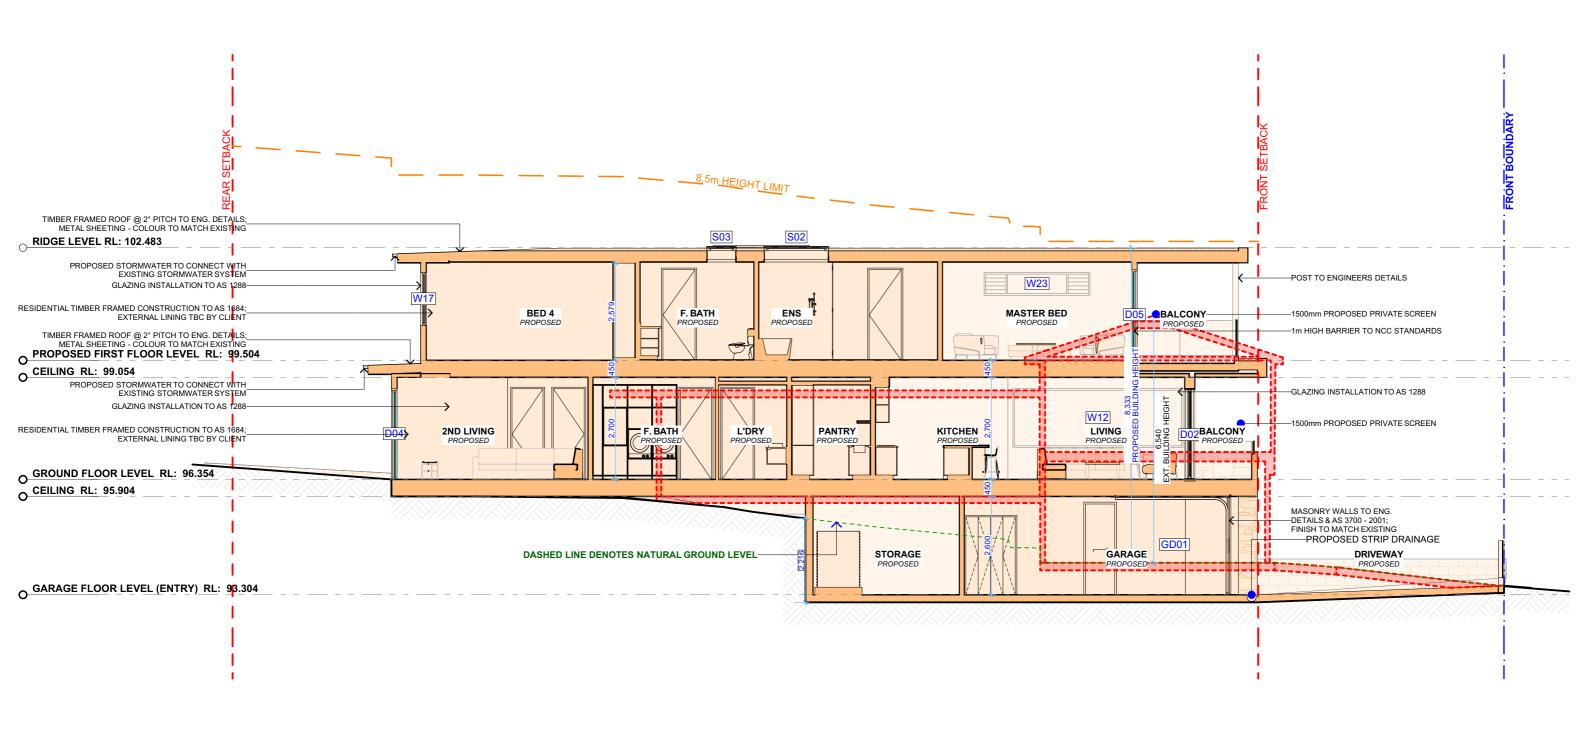

LONG SECTION AA 1:100



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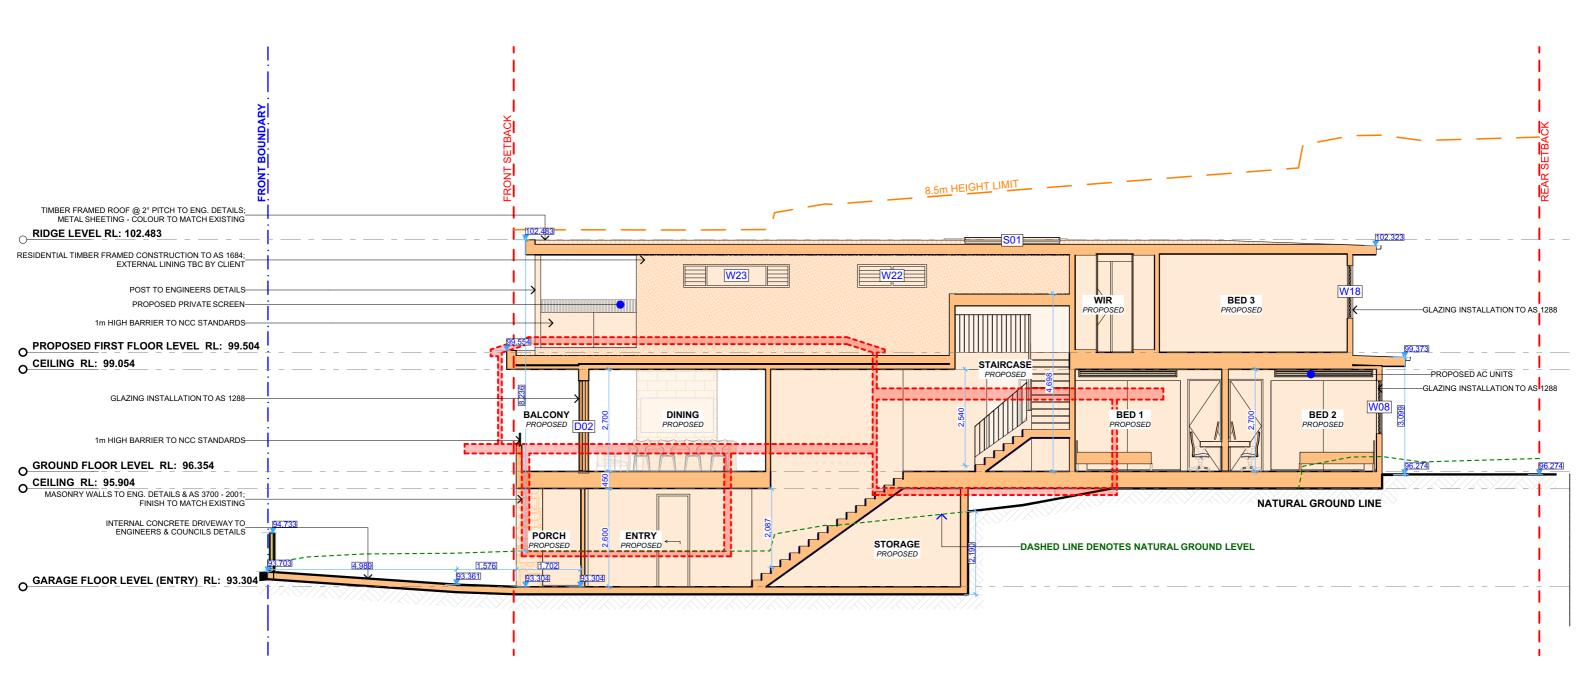
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LONG SECTION

DRAWING NAME

DATE 70 HILMA STREET, 20 February 2025 COLLAROY PLATEAU










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PROJECT ADDRESS DATE 70 HILMA STREET, 20 February 2025

DA16


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LONG SECTION & DRIVEWAY LONG SECTION

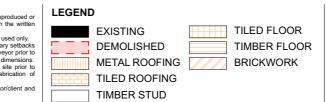DRAWING NAME





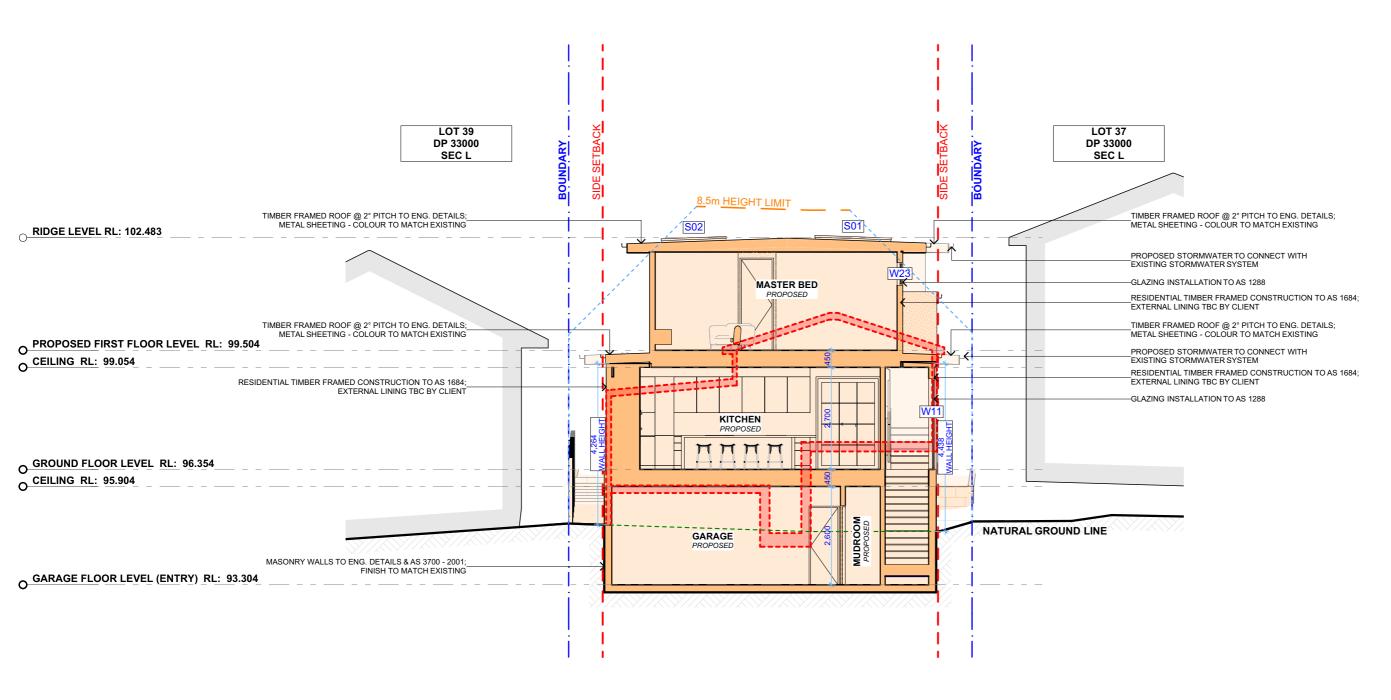

1 CROSS SECTION AA 1:100



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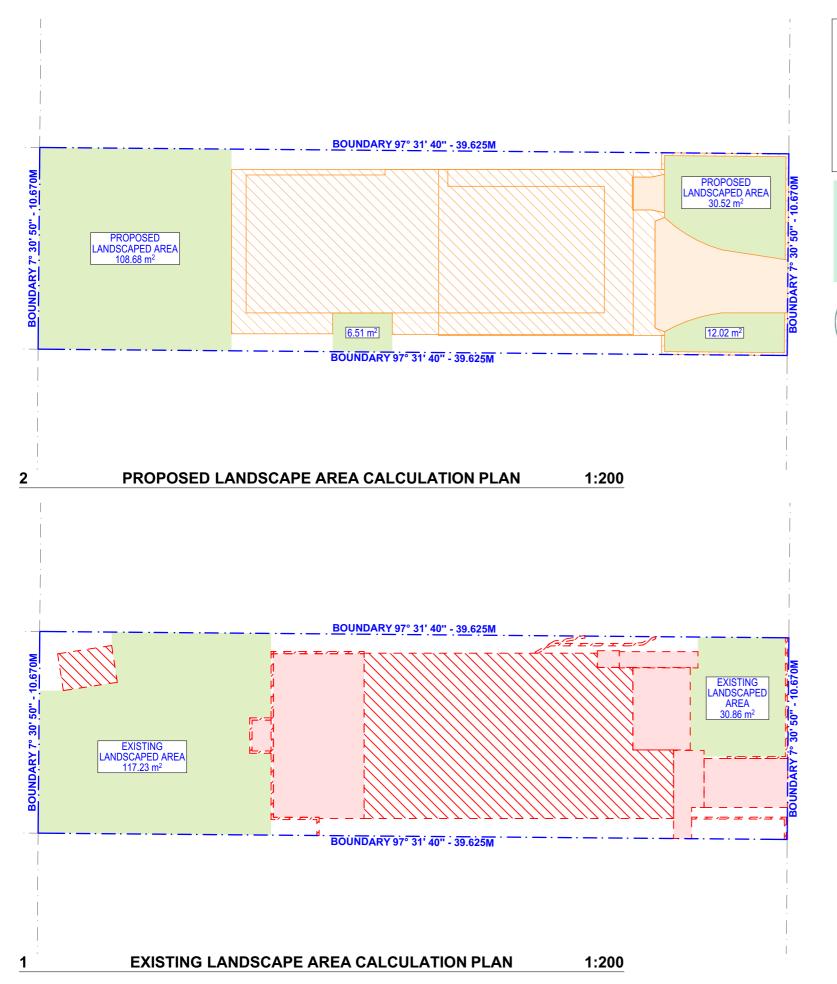
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DRAWING NAME
CROSS SECTION

DATE20 February 2025

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CONTROL TABLE

SITE AREA 422.72m² (CALCULATION)

CONTROL **EXISTING** **PROPOSED**

LANDSCAPED AREA

40% (169.08m²)

35% (148.09m²)

37% (157.73m²)

PRIVATE OPEN SPACE AREA

60m²

60m²





ACTION PLANS 18/02/2025

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NSW 2097

PROJECT ADDRESS

COLLAROY PLATEAU

70 HILMA STREET.

DRAWING NO.

DRAWING NAME AREA CALCULATIONS

DA18

DATE

SCALE 1:200 @A3 20 February 2025









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DA19

20 February 2025

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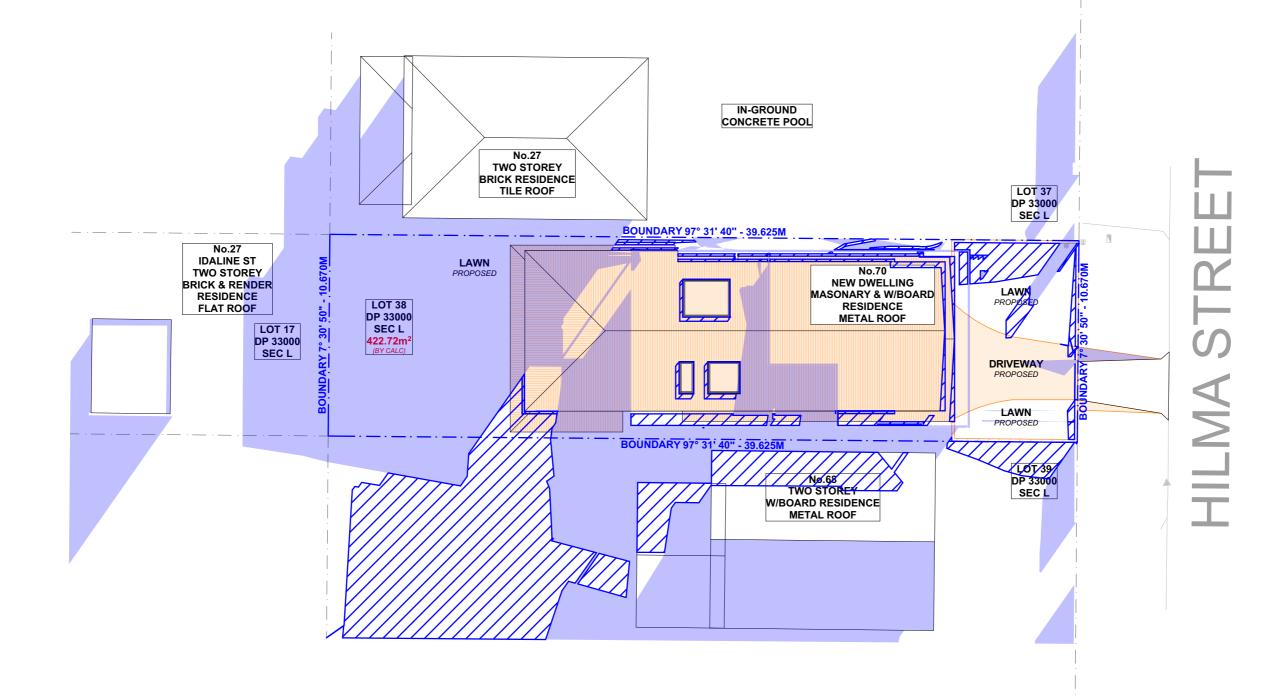
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SAMPLE BOARD









1:200 **WINTER SOLSTICE 9AM**




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	All errors and omissions are to be verified by the Builder/Contractor/client and
Ī	referred to the designer prior to the commencement of works.



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TRACY DIXON

PROJECT ADDRESS

70 HILMA STREET, COLLAROY PLATEAU NSW 2097

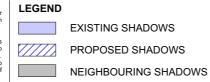DRAWING NO.

DA20

20 February 2025

DATE

WINTER SOLSTICE 9 AM


SCALE 1:200 @A3

DRAWING NAME







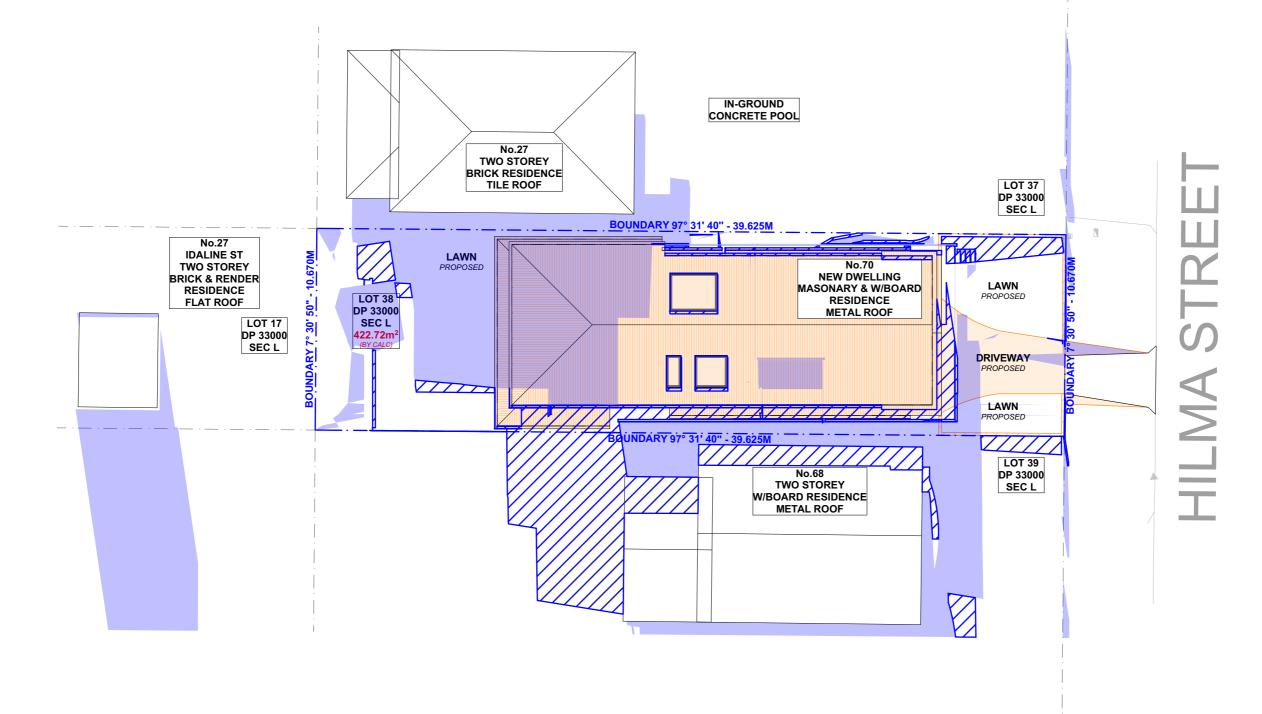

WINTER SOLSTICE 12PM

1:200



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				construction, the boundary setbacks take precedence over all other dimensions. The Builder/Contractor shall check and verify ALL dimensions on site prior to commencement of any work, creation of shop drawings, or fabrication of
				components. All errors and omissions are to be verified by the Builder/Contractor/client and
				referred to the designer prior to the commencement of works.

or	LEGEND	
en		EXISTING SHADOWS
to s.		PROPOSED SHADOWS
to of		NEIGHBOURING SHADOWS

CLIENT TRACY DIXON

TRACY DIXO

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DA21


DATE20 February 2025

DRAWING NAME
WINTER SOLSTICE 12 PM







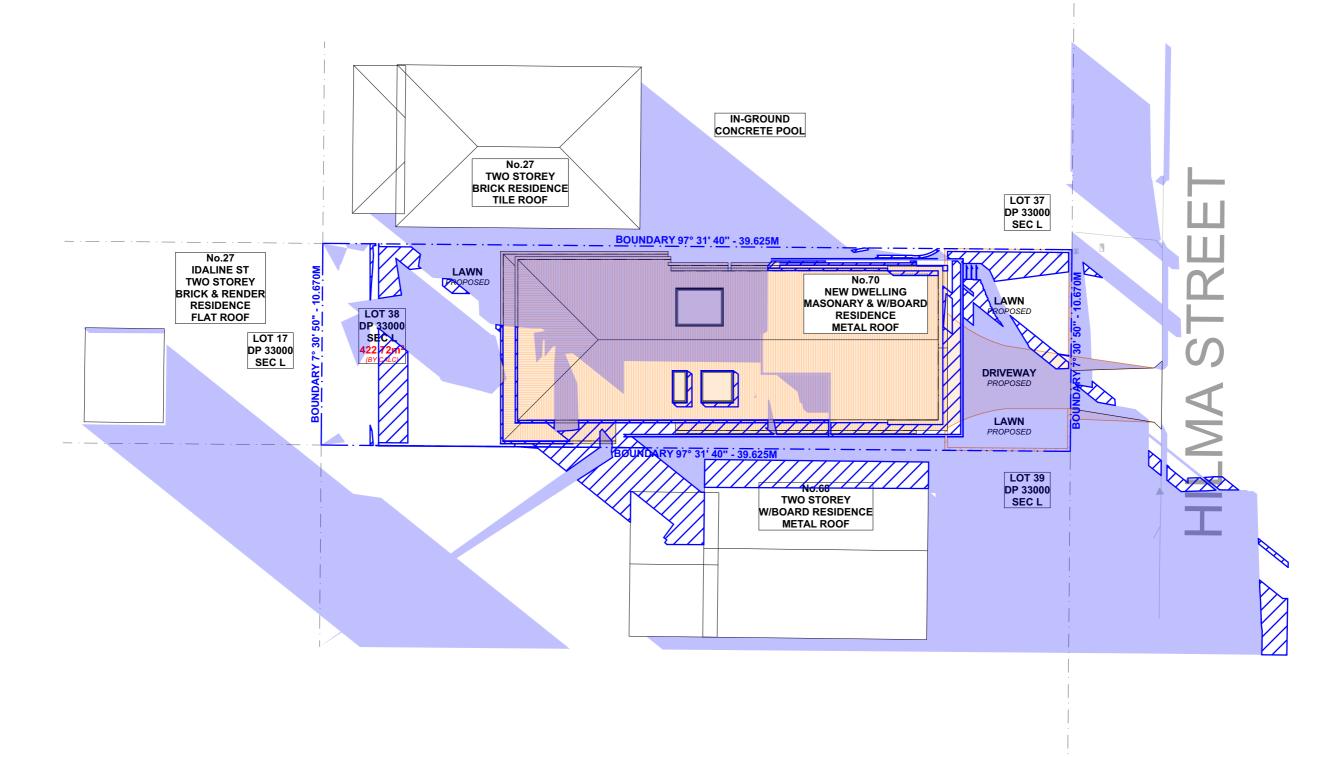

1:200 **WINTER SOLSTICE 3PM**




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	В	20/02/25	DA - SUBMISSION	DLR	Do not scale measur The Builder/contract and approved levels
					construction, the bo The Builder/Contra commencement of components. All errors and omis
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					referred to the desig

on Plans. sure from drawings. Figured dimensions are to be used only. stobr/owner is to ensure that the approved boundary setbacks sla are confirmed and set out by a registered Surveyor prior to boundary setbacks take precedence over all other dimensions. actor shall check and verify ALL dimensions on site prior to of any work, creation of shop drawings, or fabrication of

ssions are to be verified by the Builder/Contractor/client and gner prior to the commencement of works.



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			Basis Bassi		C:	D					
Basix Requirements Summary - Single Dwelling											
New Dwelling	velling Prepared by Chapman Environmental Services										
70 Hilma Street			www.cesenergy.com.au					0114			
Collaroy	NSW	2097	1300 004 914					CHA	PMAN		
COMMON NAME AND THE PROPERTY OF THE PROPERTY O											
Water Target		40	Water Score		41						
Energy Target		72	Energy Score		73						
Ellergy ranget		12	Ellergy Score		/3						
Max H & C Loads are (N	1J/m²)	30	Actual H & C Loads are (MJ/r	n-)	29.6	Star Rating			7		
Basix Commitments											
				Basix Com							
Landscaping	Total area o	of garden & la	ıwn (m²) 130		Area of indig	genous/low	water use pla	nts (m²)	0		
		_		_							
Fixtures	Shower hea	ads	4 star (> 6 but <= 7.5 L/mi	n)	Toilets	4 star		All taps	4 star		
								- 31			
	Minimum R	Rainwater tan	k size (L) 2000 C		llect run off fr	rom root are	ea of at least (m²)	50		
Alternative Water	Toilet co	onnection	Laundry connection	Landscape	andscape connection Pool top up		top up		Spa top up		
		es es	Yes	Yes		n/a			n/a		
			103	163 11/4 11/4					11/ 0		
	Hot water system Electric heat pump - air sourced Rating 15 to 20 STCs										
	Bathroom ventilation No mechanical ventilation (ie, natural)										
	Kitchen ventilation Individual fan, ducted to facade or roof with Manual switch on/off										
	Laundry ventilation Natural ventilation only, or no laundry										
Enorma	Cooling - liv	ing areas	1-phase airconditioning	Ra			Rating EER 3.0 - 3.5				
Energy	Cooling - be	edrooms	1-phase airconditioning			Rating	EER 3.0 - 3	3.5	7		
	Heating - liv		1-phase airconditioning			Rating	EER 3.0 - 3	3.0 - 3.5	- Zoned		
	Heating - be		1-phase airconditioning			Rating	EER 3.0 - :				
	Alternate E								interior		
			Photovoltaic system able to	door clothesline required		n/a	peak kilowatts of electricity				
	Electric coo	ktop & electr	ic oven Out	door clothes	siine requirea			NO ING	oor clothesline required		
			Thermal Performance As				quirements				
Floor Types			- Garage floor	with No insulation required							
riooi Types	Concrete sla	ab on ground	- Ground floor	with	R2.3 under s	lab insulation	on				
Floor Coverings	Tiles	Wet Areas			Timber	Living Ar	eas / Bedroor	ns			
Floor Coverings	Carpet	n/a			Concrete	Garage/	Storage/Entr	V			
		-				<u> </u>	<u> </u>	,			
	Concrete bl	lock lined & fi	ramed - Entry	with	Sarking and	R2.5 bulk in	sulation	Colour	Light		
External Walls	Concrete block - Storage & Garage			with	No insulatio	n required		Colour	Light		
		ned Fibro cla		with	Sarking and		sulation	Colour	Light		
				WICH				Coloui	Light		
Internal Walls	Plasterboar	·d		with	R2.5 bulk ins	sulation - Ga	arage/Laundr	v/ Lower &	Upper Bath internal walls only		
								,,			
s (5)	Concrete ab	oove plasterb	oard	with R2.3 underslab insulation - All garage level internal ceilings							
Ceiling (floor over)		na panel on ti	with No insulation required - All ground floor internal ceilings								
	оз 7р.	na panier on c	macr above plaster board	WICH	With the installation required this ground need internal technique						
Ceilings (roof over)	Timber abo	ve plasterboa	ard.	with	R6.0 bulk ins	sulation - Ex	clude garage	only			
0. (,			· · ·	*****			0 0 .	- /			
	Metal			with	R1.3 roof bla	anket		Colour	Light		
Roof	Concrete - 0	Garage		with	Waterproof		only		9		
				WICH							
	AF single gla	azed clear		Louvres		BRZ-006-00	09-001 U-Value	e 4.88 or less	SHGC 0.46 +/- 5%		
				Sliding Windows		BRD-149-005-001 U-Value 4.57 or less SHGC 0.60 +					
				Hinged Door							
	To all Louvres	, Sliding Windov	vs & Hinged Doors	Tilligea Door	bitb-103-012-002 0-Value 4.35 01 less 31/de 0.47 17-5%						
	AF double g	glazed clear Li	ghtbridge	Fixed Glass					SHGC 0.53 +/- 5%		
Windows and Doors				Sliding Doors	5	BRD-035-0	29-001 U-Valu	ie 2.70 or less	SHGC 0.51 +/- 5%		
	To all Fixed W	indows and Slid	ing Doors								
	Skylights			Skylights		I VFI-011-01	I I II-Value 2 60	or less SHG	iC 0.0.24 +/- 5%		
	J.,,,,,,,,,,,,			Sity iights	· · · · · · · · · · · · · · · · · · ·						
				S01 requires an external shading device able to shade 100% of skylight							
	A.F. Alicenterio		I								
	AF = Aluminium Framed TB = Thermally Broken Aluminium Framed TF = Timber Framed TF = Ti										
1	If the Universal Certificate indicates downlights, then these are to be non-ventilated LED / fluorescent										
1	Any exhaust fans noted are to be fitted with self-closing dampers or be otherwise sealed										
1	All insulation specified must be installed in accordance with Part 3.12.1.1 of the BCA										
1	If there is a discrepancy between this document and the Nathers Certificate, then the Nathers Certificate shall take precedence										
	,										
Notes	Coiling Fore /	1400mm\ ====	ad in the Dining Living Area 3 - 4 Liv	ing & Dadrac							
Notes	Ceiling Fans (1	1400mm) requir	ed in the Dining Living Area, 2nd Liv	iiig & bearoom	15						

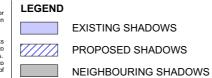This document to be read in conjunction with the Basix Certificate and Nathers Universal Certificate



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The Builder/Contractor shall check and verify ALL dimensions on site prior to commencement of any work, creation of shop drawings, or fabrication of components. All errors and omissions are to be verified by the Builder/Contractor/client and referred to the designer prior to the commencement of works. All window & door dimensions, orientation, glazing materials, opening types, frame types are to be confirmed by a suitably qualified person prior to the ordering of any such materials are to take place. U value takes precedence over glazing type/colour in all cases. all new glazing must meet the BASIX specified frame and glass type, \(QR \) meet the ecified U value and SHGC value.

CLIENT

TRACY DIXON

NSW 2097

DRAWING NO.

DA23 BASIX COMMITMENTS

DRAWING NAME

PROJECT ADDRESS 70 HILMA STREET,

COLLAROY PLATEAU

DATE 20 February 2025