

CONSTRUCTION CERTIFICATE DETERMINATION

Issued under the Environmental Planning and Assessment Act 1979 Section 109C (1) (b), 81A (2) and 81A (4)

CONSTRUCTION CERTIFICATE NO:

136/2007

DETERMINATION

Decision:

Approved

Date of Decision:

5th June 2007

SUBJECT LAND

Address:

43 Crescent Road, Newport

Lot No, DP:

Lot 18C DP 394831

DESCRIPTION OF DEVELOPMENT

Construction of a new two storey dwelling with double garage and

swimming pool.

APPLICANT

Name:

Newport Crescent PTY LTD

Address:

43 Crescent Road, Newport

Contact Number: (tel)

tel: 0400 470 062

OWNER

Name:

Newport Crescent PTY LTD

Address:

43 Crescent Road, Newport

Contact Number: (tel)

tel: 9997 3326 mob: 0400 470 062


BUILDER OR OWNER/BUILDER

Owner Builder:

Trent Barnabas

Owner Builder permit No:

320202P

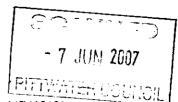

Unit 3/6 Wilmette Place Mona Vale NSW 2103 , PO Box 870 Narrabeen NSW 2101 tel 9944 8222 . fax 9944 6330 . email: info@thecgroup.com.au .www.thecgroup.com.au .acn 111 092 632

PLANS AND SPECIFICATIONS

The development is to be carried out in compliance with the following plans and documentation listed below and endorsed with "The Certification Group" stamp.

DRAWING NUMBER DATE

Architectural Plan No's: DA2001 Rev C, DA2002 Rev C, DA2003 Rev C, DA3001 Rev C, DA3003	
Rev C, DA3004 Rev C, DA 3007 Rev C	December 2005
Plan No's: DA3002 Rev B, DA 3005 Rev B, DA 3006 Rev B	December 2003
Plan No: DA 3008 Rev C (April 2006)	İ
prepared by: Elizabeth Leong Architects P/L	

ATTACHMENTS

Structural Plan No: 0715-1, 0715-2, prepared by Michael Gergich Consulting Engineer Structural and Civil Engineer	26/03/2007
Stormwater Plan No: 0715-3, prepared by Michael Gergich Consulting Engineer Structural and Civil Engineer	26/03/2007
Traffic Engineering Consultant report, prepared by Nick Fadeev Civil & Traffic Engineering Consultant	26/04/2007
Driveway Plan No's: 7002/1, 7002/3 No's: 7002/2 A, 7002/4 A, 7002/5 A prepared by Nick Fadeev Civil & Traffic Engineering Consultant	April 2007 13/05/2007
Access Driveway Profile	26/03/2007
Landscape Plan, prepared by Rebeccaantcliff Garden Design	27/03/2007
Arborist Report, prepared by National Tree Management	September 2006
BASIX Certificate No: 690835	15/08/2006
BASIX Certification, prepared by Trent Barnabas	15/05/2007
Stormwater Management Certification , prepared by Michael Gergich	14/05/2007
Colour Schedule	22/05/2007
Long Service Levy Receipt No: 214433, \$1681.80	1/05/2007
Sydney Water Quick Check Stamp Property No: 3410472	28/03/2007
Construction Certificate Application Form	30/04/2007

CERTIFICATE

I certify that work completed in accordance with documentation accompanying the application for this certificate (with such modifications as verified by the undersigned as may be shown on that documentation) will comply with the requirements of the Environmental Planning and Assessment Regulation, as are referred to in section 81A(5) of the Environmental Planning and Assessment Act, 1979"

SIGNATURE

DATE OF ENDORSEMENT

5th June 2007

CERTIFICATE NO

136/2007

CERTIFYING AUTHORITY

Name of Certifying Authority Name of Accredited Certifier

Registration No Contact No Address THE CERTIFICATION GROUP P/L

Wayne Treble

BPB 0413 - NSW Building Professionals Board PH (02) 9944 8222, FAX (02) 9944 6330 PO BOX 870 NARRABEEN NSW 2101

DEVELOPMENT CONSENT

Council

Development Consent No Date of Determination

Pittwater N0623/06

19th March 2007

BUILDING CODE OF AUSTRALIA CLASSIFICATION

1a & 10b



the certification group

enhancing building performance

COUNCIL COPY

THE CERTIFICATION GROUP PTY LTD
APPROVED CONSTRUCTION CERTIFICATE
DOCUMENTATION.

APPLICATION FORM

Made under the Environmental Planning and Assessment Act 1979, Sections 81A(2)(4), 84A, 85A, & 109C (1)(b), Environmental Planning and Assessment Regulation 2000, clauses 126(1),139(1), or 157(1)

To complete this form, please place a cross in the boxes and fill out the white sections as appropriate.

Application Sought Complying Development Certificate Coccupation Certificate	$ar{\mathcal{X}}$ Construction Certificate $oldsymbol{lpha}$ Principal Certifying Authority	Office Use Only CC: 136/2007 Jon FCG 149.07
Subject Land		annes de la companya
Address 43 CRESCENT RD	NEWPORT	
Lot No, DP, SP, vol/fol. Etc Lot 180	C DP 394831	
Details of the applicant Home/Company NEWPORT CRE	SCENT PTY LTD	_ Contact Person
Postal Address 43 Crescent rd	newport	Postcode 2106 State NSW
E-mail christinebarnabas@	yahoo.com	_ Daytime telephone <u>0400 470 062.</u>
Fax 999 7 3326	Mobile 0400 470	062
Applicant Signature	<u> </u>	Date_ 30/04/07
Consent of Owner(s) If We as the owner/s of the above property authority for the subject of the Principal Certifying Authority for the subject of the Principal Certifying Authority Name(s)/ Company NewPort creating the Port creating Authority of the Port	ect building works, including site inspections at ty with the relevant Council.	le to provide Construction Certification and to act nd to lodge the Notice of Commencement /
Address 43 Crescent Rd 1	Jewport	Postcode 2106 State NSLN
Phone No_9997 3326	10bile 0400 470 062	Fax_ 9997 3326
Signature of Registered owner(s). Company sta	amp or seal to be affixed if applicable	
TRENT BARNABAS Trans	lls	
TREVOR BARNABAS - CR		
Date 30/04/07		_

enhancing building periodmander

Description of the work proposed
Type of work proposed:
■ New Building
Class of Building under Building Code of Australia class 1 4 4 10 6
Description of the work four bedroom, 2 storey Home with double garage + swiming pool
Construction Cost of Works \$345,000
Details of Builder
Contact Person Trent Barnabas
Name/Company NEWPORT CRESCENT PTY LTD
Fax 9997 3326Mobile 0400 470 062
Daytime telephone 9997 3326 Email christine barrabas @ yahoo.com
Builders address 43 Bungan Head Rd Newport Postcode 2106
Details of the relevant Development Consent granted
Consent No. N 0623/06 Date the consent was granted 19 March 2007
Just the consent was granted 17 / Cares / Zeo /
Applicant Checklist
Complete Application Form - Pages & 2
Attach supporting documentation as nominated on Page 3
Complete statistical Return on Page 4
. Samuel Medin on Lage 4
Private Policy
•
The information you provide in this notice is required under the Environmental Planning and Assessment Act 1979 if you are going to
erect a building. If you do not provide the information to the consent authority, you cannot commence the work. The information will be
held by the consent authority and by the council (if the council is not the consent authority). Please contact the certification group if the
information you have provided in this notice is incorrect or changes.
Description of the American Control of the American Co
Date of receipt (To be completed by Certifying Authority)
Date

STATISTICAL RETURN FOR AUSTRALIAN BUREAU OF STATISTICS

What is the site area of land?		Area in square meters 1004.20	
Gross floor area of existing building! If	no existing building, write NIL	Area in square meters	
What is the existing building or site u	sed for at present?	Main Uses Family Home	
	and the second s	Other Uses	and the second s
Does the site contain dual occupancy	akting panggang ng panggang panggang ng panggang panggang ng panggang panggang panggang panggang panggang pang Panggang panggang pa	□Yes ⊠No	South and the second br>Second second s
Gross floor area of proposed building		In square meters 445.7 m ²	
What will the proposed building be u	sed for?	Main Uses Family Home	
		Other Uses	
How many dwellings?		1	
Are pre-existing at this property?		Dwellings Yes	and the same of
Are proposed to be demolished?		Dwellings Yes	And the second s
Are proposed to be constructed?		Dwellings Yes	e partir de la companya de la compa La companya de la co La companya de la co
Are attached to an existing building!		Dwellings NO	er og ut i 1945 og tillet i 1965 og tillet i 1966 og tillet i 1966 og tillet i 1966 og tillet i 1966 og tillet Berling og tillet i 1966 br>Berling og tillet i 1966
Are attached to a new building?		Dwellings No	
How many storeys will the building co	onsist of	Storeys 2	
	rausa (sus 1754 filikus Abus -	ित्र के जिल्हा अन्य का अन्य के अन्य के स्टेबर के विशेष करीं के 	and the second of the first of the second of the second of the
What are the main building materials	? (Please tick appropriate boxes)		
WALLS	ROOF	FLOOR	FRAME
Tull Brick	⊠ Aluminium		☑ Timber
☐ Brick Veneer	Concrete or Slate	★ Timber	☐ Steel
Concrete or Stone	☐ Tile	Cther	
☐ Steel	Fibrous Cement	Unknown	COther
☐ Fibrous Cement	☐ Steel		□ Unknown
▼ Timber/weatherboard	☐ Other		
Cladding- aluminium	Unknown		
Curtain glass			
C Other			
Unknown			

THE CERTIFICATION GROUP - 28 Cook Terrace Mona Vale NSW 2103 . PO Box 870 Narrabeen NSW 2101 tel 9944 8222 . fax 9944 6330 . email: info@thecgroup.com.au . www.thecgroup.com.au . acn 111 092 632



TRENT BARNABAS
43 CRESCENT ROAD
NEWPORT 2106

HOME BUILDING ACT 1989
OWNER BUILDER PERMIT

Permit :320202P Receipt:AA2375850

Issued: 01/05/2007

Amount:\$135.00

Building Site:

43 CRESCENT ROAD, NEWPORT 2106

Authorised Building Work:

N0623/06 DEMOLISION OF EXISTING HOUSE WITH A NEW 2 STOREY 4 BEDROOM HOME BEING BUILT WITH A SWIMMING POOL AND 2 CAR GARAGE

ISSUED BY PITTWATER COUNCIL

Should the property be sold within 6 years of completion of the work it will be necessary to obtain home warranty building insurance from approved insurers if the value of the work was greater than \$12,000. A certificate of insurance must be attached to any contract for sale.

You should obtain professional advice from general insurers regarding public liability and property damage cover, etc.

Note: This permit is only valid when an official receipt has been imprinted. If payment is made by cheque, the permit is conditional on the cheque being met at presentation.

Issuing Officer



5th June 2007

Pittwater Council PO BOX 882 MONA VALE NSW 1660

Dear Sir/Madam,

Re: Development Application No: N0623/06

Our Construction Certificate No: 136/2007 Premises: 43 Crescent Road, Newport

Please find attached a copy of the following:-

• Construction Certificate, stamped approved plans and relevant documentation.

• Notice to Commence Building Work.

· Appointment of a Principal Certifying Authority.

In accordance with the regulations we have enclosed a cheque for the sum of \$30.00 for the submission of the Part 4A certificate.

Should you have any further enquiries please do not hesitate to contact us and we will be pleased to assist you.

NB:(Please forward receipt for the above \$30.00 fee to The Certification Group P/L. PO Box 870 Narrabeen NSW 2101)

Yours faithfully,

Itresse.

Per:


Wayne Treble - Director
The Cortification Group F

The Certification Group P/L

\$30.00 6/6/07. R. 217256 U

Unit 3/6 Wilmette Place Mona Vale NSW 2103 . PO Box 870 Narrabeen NSW 2101

tel 9944 8222 . fax 9944 6330 . email: info@thecgroup.com.au . www.thecgroup.com.au . acn 111 092 632

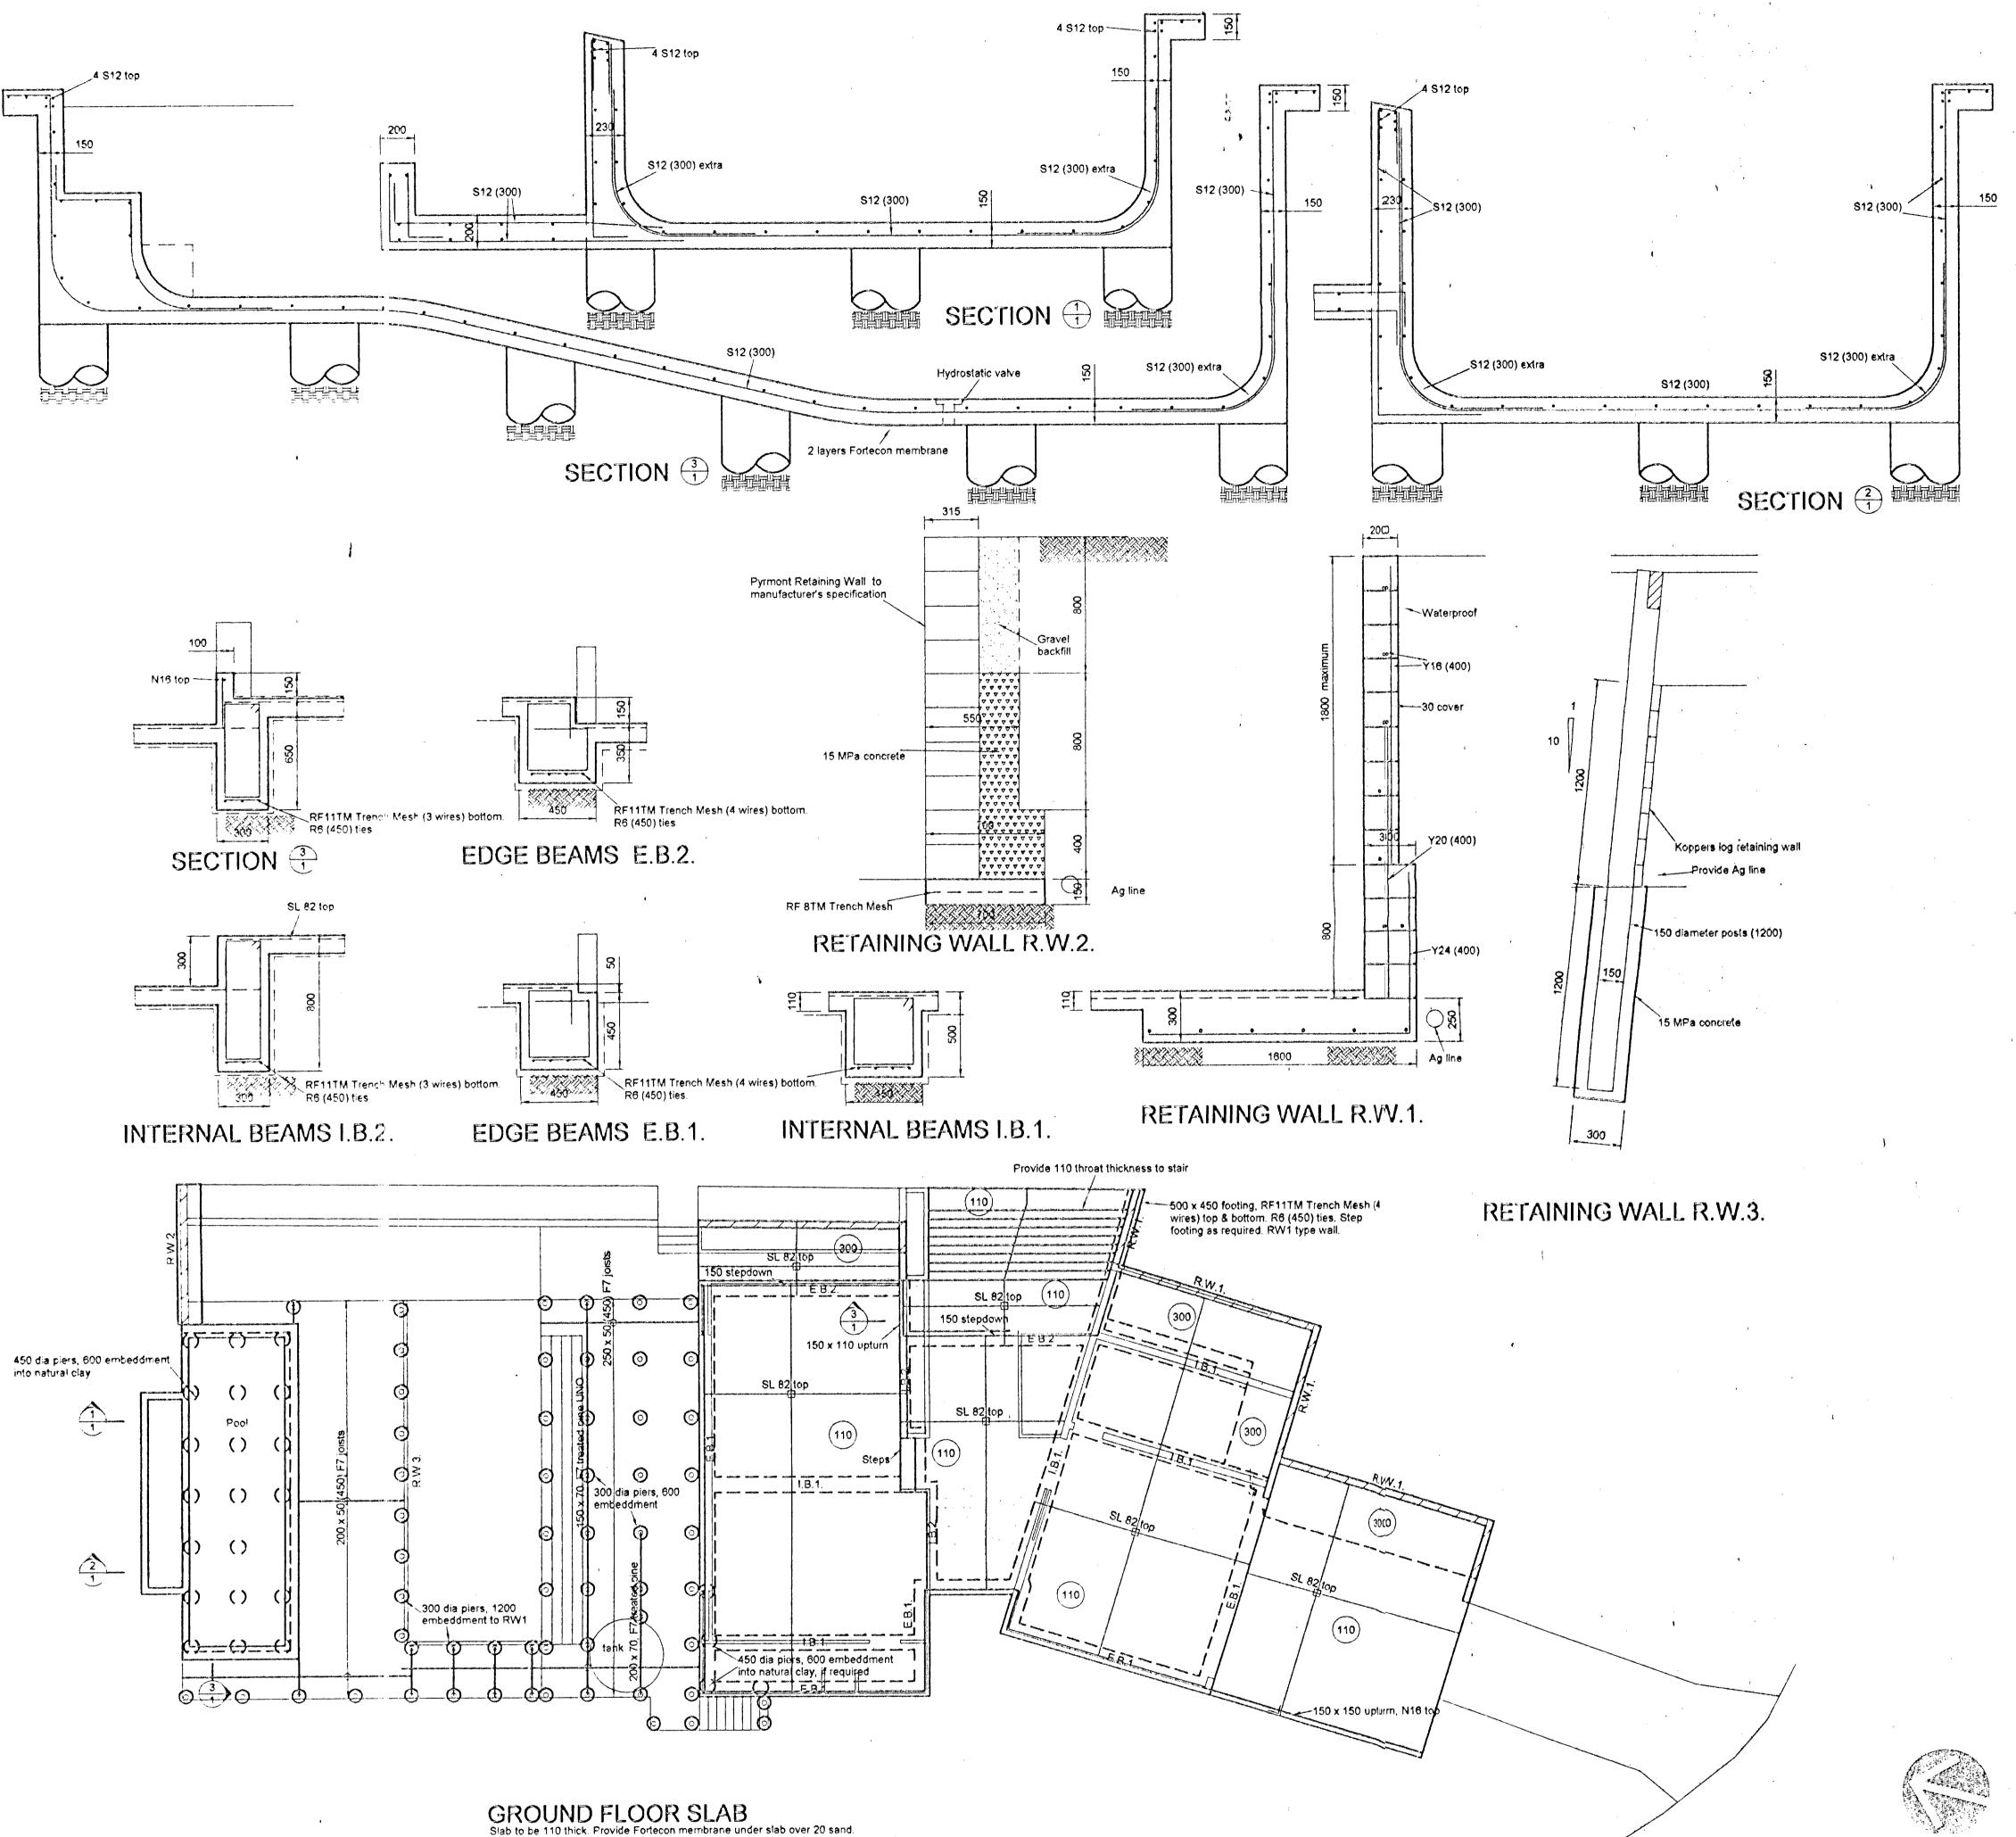

C1. All workmainship and materials shall be in accordance with AS 3800 current edition with amendments.

G1. These distributions shall be read in conjunction with all erchelectural and other consultants drawings and specifications and with such other written instructions as may be issued during the course of the contrast.

Any discrepancy shall be referred to the Engineer before proceeding with the work. C2. Concrete Quality

AUI the requirements of the ACSE Concrete Specification Document 1 shall apply to the formwork. G2. All materials and workmanship shall be in accordance with the refer and current CAA codes and with the By-Laws and Ordinances of the relevant building authorities except where visited by the project specification. reinformcement and concrete unless noted otherwise G3. All differentions shown shall be verified by the builder on site. Engineer's drawing shall not be suized for G4. During construction the structure shall be maketomed in a stable condition and no part shall be overstressed. Temporary bracking shall be provided by the builder to keep the works and excavations stable at all times. FOOTINGS ALL CONCERETE U N O Plant/Project control testing shall be carried out in soco dance with AS 3800 C3. No admixture shall be used in concrete unless applioned in writing FOUNDATIONS. F1. Footings have becan designed for an allosseble bearing pressure intensity of 300kms s (1/2). The foundation materials half be approved by the Engineer for this pressure before placing reliablesses and of construction. C4. Clear concrete cover in mm to all reinforcement shall be as follows unless shown otherwise. F2 Footings shall be located centrally under walls and columns unlets noted otherwise F3. All organic material, soft spots, top soft and any other delete-louis material shalf be removed from under footings and slates. Profit roll ground with vibrating roller and reptace any suffit spots with good (#. Eack/Ding to footing theory ation and sub-bases to slate on ground must consist of approved material constants on 150mm thick layers to at least 95% modified Australian compaction. Masonry Walls M1. All workmanship and materials shall be in accordance with AS 3700 Exposure classification for exterior concretre - B1 All reinforcement shall be firm by supported on mild steel plestic tipped chains, plastic chains or concrete chains to not greater than 1 metre centres both ways. [Sens shall be tied at alternative intersections. In exposure conditions greater than 81 use only plastic thans. C5. Concrete sizes shown do not include thicknesses of applied finishes. C6 Depths of beams are given first and include slab trickness. Core filling grout to have a characteristic strength of 20WPs C7. For chamfars, drip groves, reglets, etc., refer to Architects details, maintain cover to reinforcement at these details. M3. Mortar admixtures shall not be used without the written approval of the Engineer C8. No holds, chalces or embedinient of pipes other than those shown on the structural drawings shall be made in concrete members without the prior written approval of the Engineer.

M4. Masonny walls supporting stats and beams shall have a pre-greased two layer galvanized steel also joint between concrete and masonny unless noted otherwise. M5. All mesonry walls supporting or supported by concrete floors shall be provided with vertical joints for C9. Construction joints where not shown shall be locatified to the approval of the Enginer C10. The finished concrete shall be a dense homogenicous mass, completely filling the formwork thoroughly embedding the reinforoment and frice of stone pockets. All concrete including slabs on ground and footings shall be compacted with mechanical vibrations. C11. Curing of all concrets is to be achieved by keeping surfaces condinuously wet for a period of 3 days, and provention of loss of moisture for a total of 7 days plowed by a gradual drying out. Approved sprayed on cufring compounds may be used where no floor finishes are proposed. Polyttiene sheeting or vet the strain may be used if protected from wind and traffic.

M8. All field beginning and structurel masoning shall be laid on full back of moiths and use perpends shall be early trade with most are M8. All foed boaring and structurel missionity shall be laid on full beds of mortar and all perpands shall be slidly filled with mortar. C12 Construction support propping is to be left in place where needed to avoid over stressing the structure due to construction loading. No mesonary or partition wells are to be constructed on suspended levels until all propping is removed and the member has absorbed its dead load deflection.

M9. Provide vertical control joints at 10m maximum centres, and 5m maximum from carners in measing walks. C13 he Engineer shalf be given 48 hours notice for reliaforcement inspection and concrete shalf not be delivered until final approval obtained. TIMBER.
T1 All timber design, construction and material to AS 1720.1 and AS 1720.2 U.N.O. C14 Conduites, pipes etc., shall only be located in the middle one third of slab depth and speced at not. T3 Softwood to be minimum grade F7 U.N.O. Hardwood to be minimum grade F14 C15. Reinforcments symbols
S Donotes Grade 230 S Hot Rolled Deformed Bars to # 1302 Y Donotes Grade 410 Y Bars to AS 1302 Grade Y
R Denotes Grade 410 Y Bars to AS 1302 Grade Y
R Denotes Grade 230 R Hot RORed Plain Bars to AS 1,302
F Denotes hard-Drawn SWire Reinforcing Fabric to As 1,302
The figures following the symbol site the number of mitimatics in the bar diameter. The figures following the fabric symbol F is the reference number for fabric to AS 1304 U1. Where beams are to be installed to support walls over new openings, walls are to be effectively supported by tomming down to solid support. Out coening and install bearis, wedge between beam sold brokwork to floor over to transfer load from toms and grout between beams and brokwork or floo before removing tomming. C16 Reinforcement is represented diagramatically and not necessarily in true projection C17. Splices in reinforcement shall be made only in politions shown or otherwise approved in writing the Engineer. Laps shall be in accordance with AS 36, 0 and not else than the developme each bar. C18 Fabric reinforcement, shall have splices made so that the overlap, theasured between transverse wires of each sheet of fabric, is not, less the nispacing of those wires plus 50mm. C19. We'ding of reinforcement shall not be permitted unless shown on the structurby the Engineer C20 Jaggles to bars shall be 1 bar diameter over a length of 12 bar diameters C21 Bundled bars shall be fied together at 3;0 bar dia neter centres with three wr C22 Where transverse tie bars are not shown provide Y12 at 300mm spliced who with main bars 300mm U.N.O. 51. All workmanship and materials shall be in accordance with AS 4100 and AS 1554, except where varied by the contract documents. \$2. Unloss noted otherwise, all steel shall be Grade 250 for plates and Grade 300 for other members. S3. Three copies of workshop fabrications drawings shall be submitted to the Engineer for review at least 10 , working days prior to commencement of fabrications 5.4 Buit Designations.
4.6/S Denotes commercial boils of Grade 4.6 to AS 1111, snug tightened
8.6//TB Denotes high strength structural boils of Grade 3.6 to AS 1252, fully tensioned to AS 4100 as a benefit a light. bearing joint
8 B/TF Denotes high strength structural boits of Grade 8 8 to AS 1262, fully tensioned to AS 4100 as a friction joint with facing surfaces left uncoated S5. Unlebs noted otherwise all botts shall be M16 Grade 8.8/s. No connection shall have less than 2 botts. All botts, nots and washers shall be hot dip galvances. S6 TB and TF boits to be installed using approved to \$7. Unless noted, all welds shall be 6mm continuous fillet type GP using £4100 electrodes - buttivelds shall be complete penetration buttivelds to AS 1554. S8. Unless noted otherwise all clear plates shall be 10mm thick S9. Provide seal plates to hollow sections, with "breather" holes if members to be hot dip galvanised


S10. All steetwork shall be sedurely temporarily braced its necessary to stabilise the structure during erection.

\$12. The builder shall provide all closts and driff all holes, necessary for found sleet to steel and other elements to steel whether or not detailed in the drawings.

S11. Structural sleetwork not encased in concrete shall, ave surface treatment in accordance with the Specification

THE CERTIFICATION GROUP PTY LTD
APPROVED CONSTRUCTION CERTIFICATE
DOCUMENTATION.

PLEASE NOTE: A conprehensive check of the Structural Design has not been carried out. The stamping of this STRUCTURAL PLAN by The Certification Group P/L does not relieve the Structural Engineers responsibility to certify the structural adequacy of this development including any variations that may occur during construction.

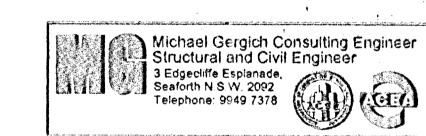

BARNABAS RESIDENCE

PROPOSED RESIDENCE AT
43 CRESCENT ROAD
NEWPORT

Date
26.3.07

Approved

Michael Gargell


BE MIE Aud NPER ENES Structure)

Scales


1:100, 1:20

Drawing No

0715-1

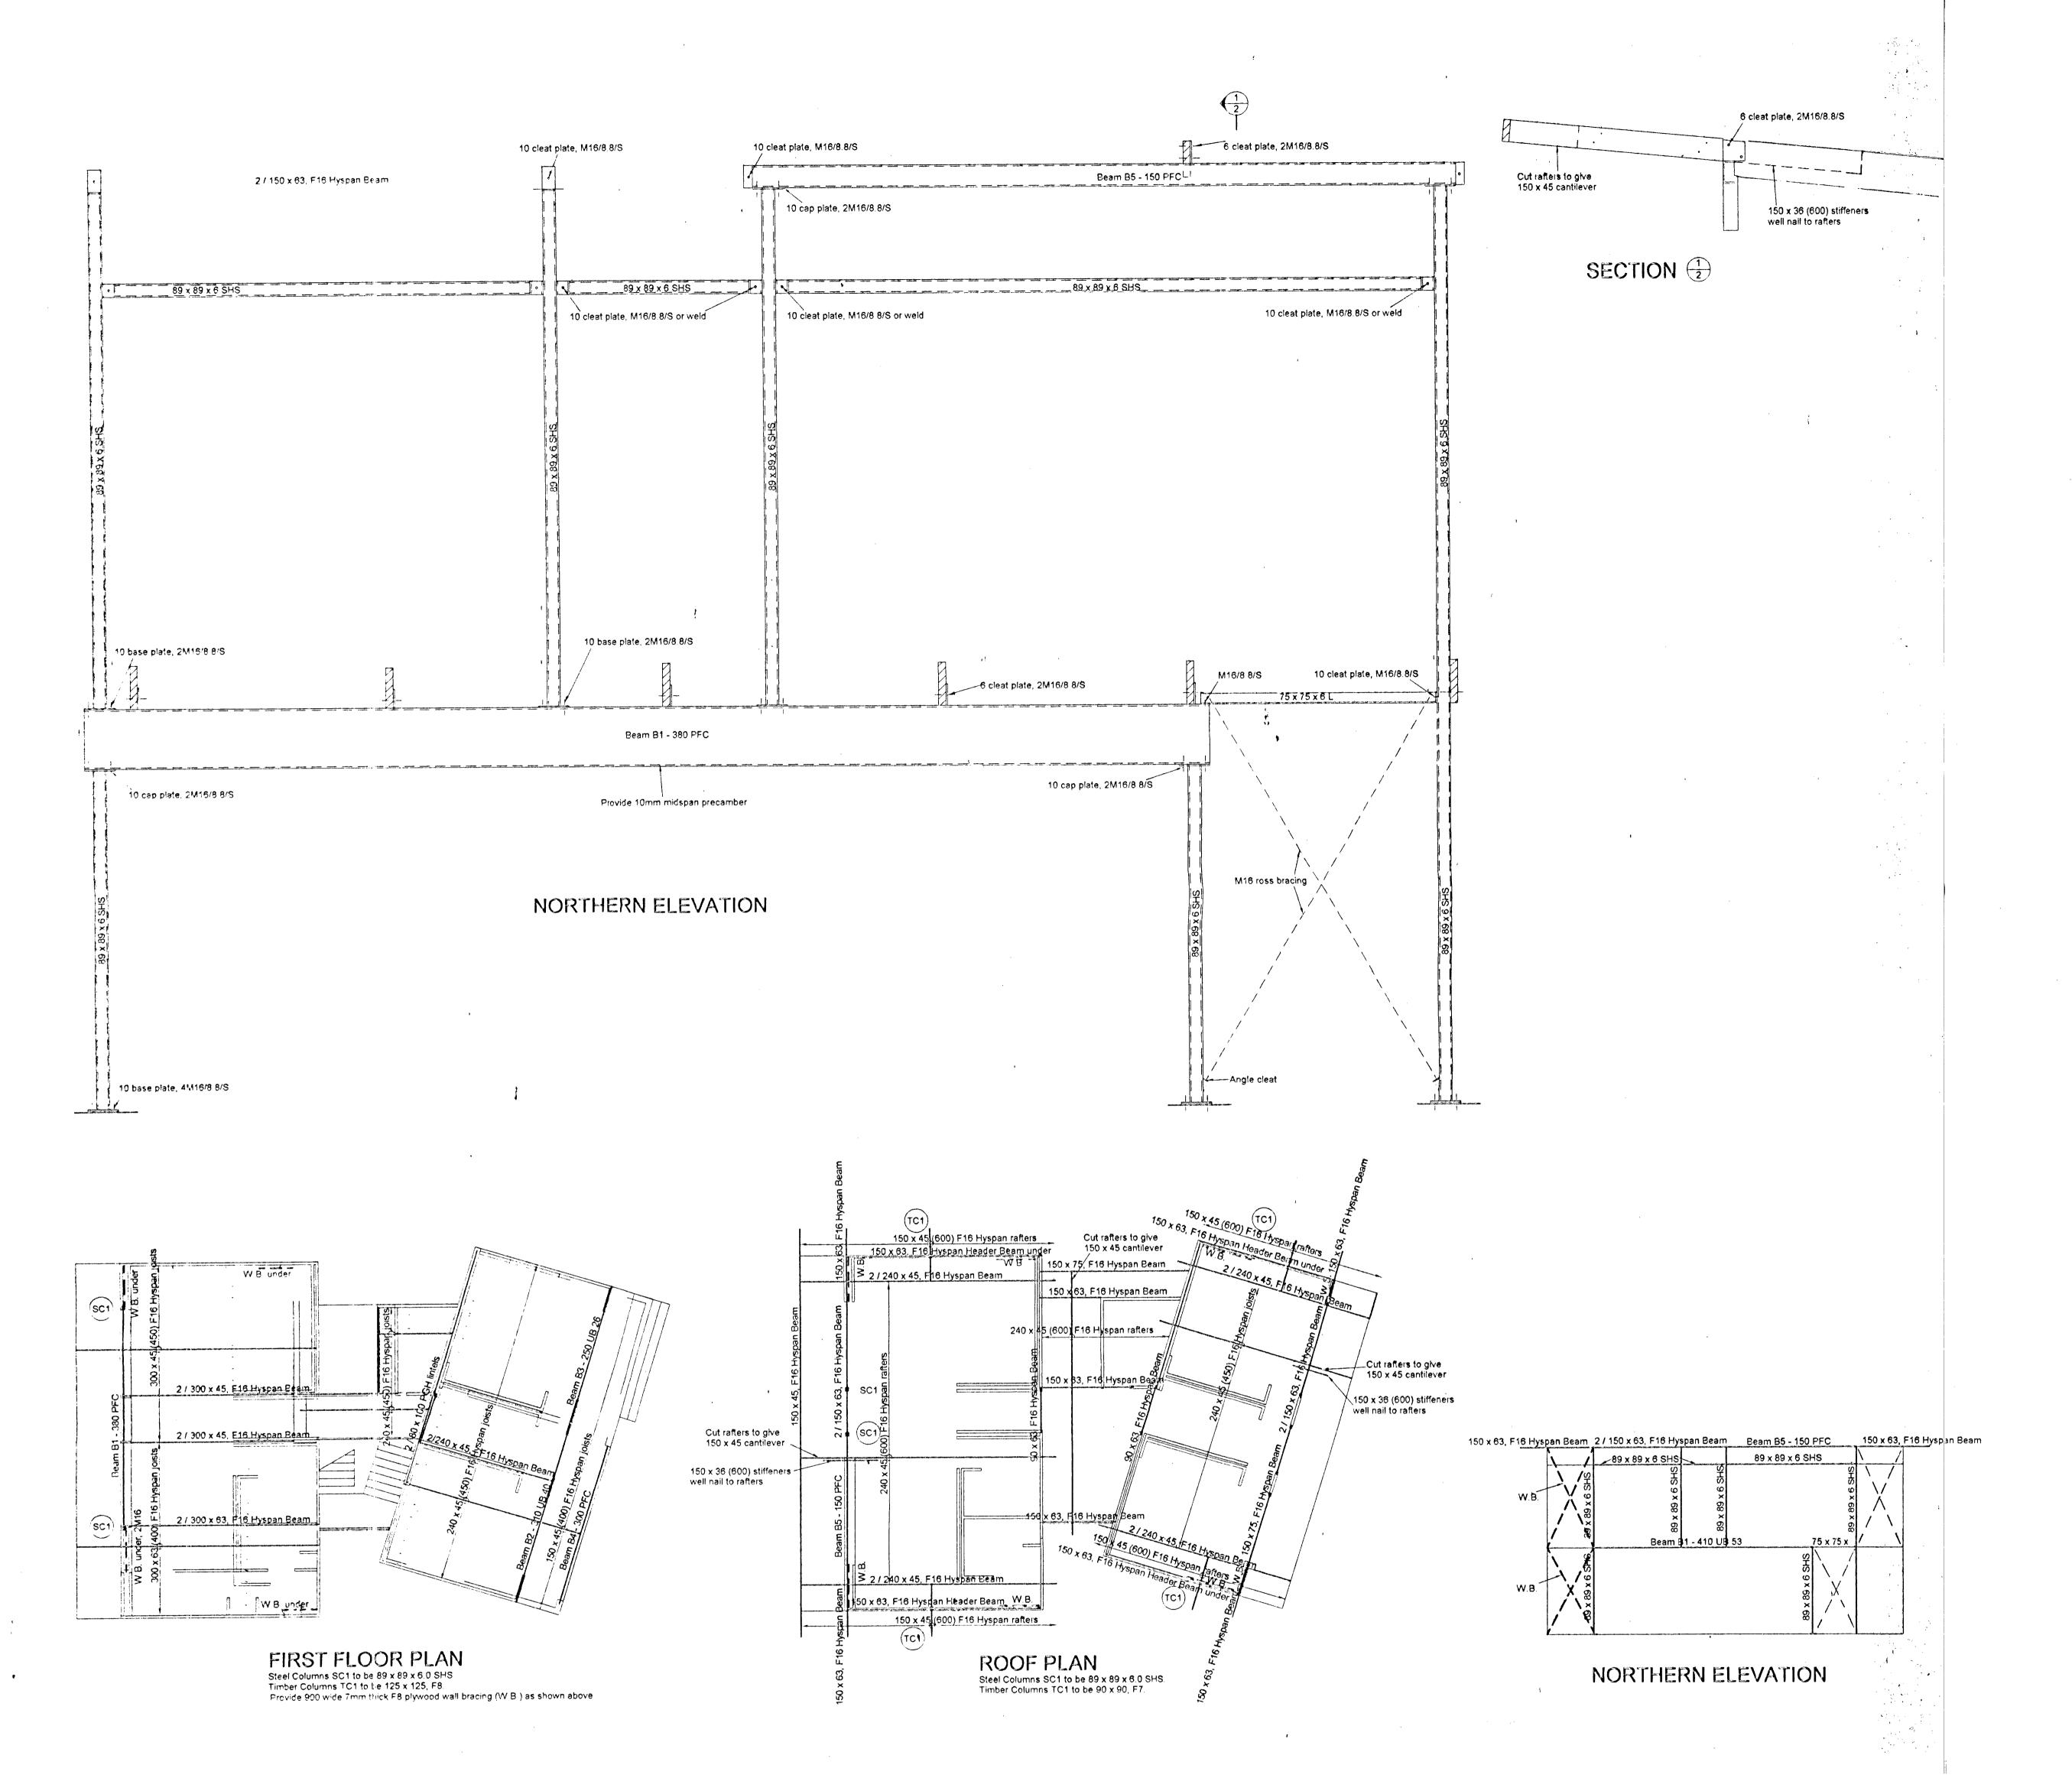

THE CERTIFICATION GROUP PTY LTD
APPROVED CONSTRUCTION CERTIFICATE
DOCUMENTATION.

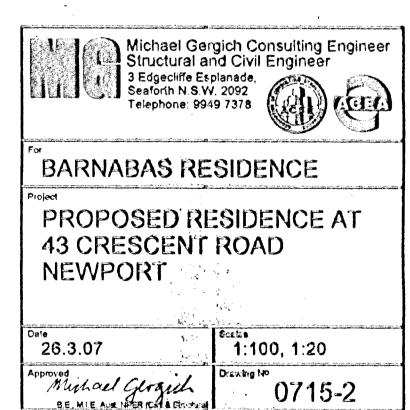

2:38 13 1:27 7 445 3

denotes Design Surface Level

O 200 dia. inlet grate

Downpipe

450 x 450 pit

denotes Natural Surface Level

G1. These drawings shall be read in conjunction with all archetectural and other consultants' drawings and specializations and with such other written instructions as may be issued during the course of the contract Any discrepancy shall be referred to the Engineer before proceeding with the work. G2. All materals and workmanishs shall be in accordance with the relevant and current SAA codes and with the Ry Laws and Ordinances of the relevant building authorities except where varied by the project specification.

G3. All dimensions shown shall be verified by the builder on site. Engalcer's disverg shall ray be ensure for dimensions.

G4. During construction the structure shall be maintained in a stable condition and no pair shall be overstreased. Temporary braining shall be provided by the builder to likely the works and excallations stable at all times.

FOUNDATIONS.

F1. Footings have been designed for an allowable bearing pressure intensity of 500kPa (rock). The foundation materials half be approved by the Engineer for this pressure before placing reinforcement of concrete.

F2. Footings shall be located caribally under walls and enhance unless noted otherwise

F3. All organic material, soft spots, top soil and any other deleterious material shall be removed from unider footings and stabs. Profillroll ground with vibrating roller and replace any soft spots with good fill. Backfilling to footing excession and sub-bases to slabs on ground must consist of approved material compacted in 150mm thick layers to at least 95% modified Australian consparation.

THE CERTIFICATION GROUP PTY LTD APPROVED CONSTRUCTION CERTIFICATE DOCUMENTATION.



BARNABAS RESIDENCE

PROPOSED RESIDENCE AT 43 CRESCENT ROAD NEWPORT

Date 26.3.07	Scales 1:100, 1:20
Approved Mulau Glyguh BE MIE AUG SPERSONA STOUTHER	Drawing No 0715-3

Building Sustainability Index

www.basix.nsw.gov.au

Certificate number: 69083S

commitments set out below. Terms used in this certificate, or in the commitments, government's requirements for sustainability, if it is built in accordance with the www.basix.nsw.gov.au 29/06/2006, published by the Department of Planning. This document is available at have the meaning given by the document entitled "BASIX Definitions" dated This certificate confirms that the proposed development will meet the NSW

Date of issue: Tuesday, 15 August 2006 Director-General



Department of Planning NSW GOVERNMENT

> APPROVED CONSTRUCTION CERTIFICATE THE CERTIFICATION GROUP PTY LTD DOCUMENTATION.

Score

- Water: 45 (Target 40)
- Thermal comfort: pass (Target pass)
- Energy: 40 (Target 40)

COUNCIL COPY dage 1/10

Ollici)	Heating load (MJ/m² year)	Cooling load (MJ/m².year)	Certificate number	Assessor number	Assessor details and thermal	Total area of garden and lawn (m2)	Unconditioned floor area (m2)	Conditioned floor area (m2)	Roof area (m²)	Site area (m²)	Site details	No. of bedrooms	Project type	Project type	Section no.	Lot no.	Plan type and plan number	Local Government Area	Street address	Project name	Holes address	
n/a	n/a	n/a	n/a	n/a	loads	557	18	222	236	1004		4	separate dwelling house		0.0	18C	Deposited Plan 394831	Pittwater Council	43 Crescent Road Newport 2106	Barnabas Residence		

Schedule of BASIX commitments

The commitments set out below regulate how the proposed development is to be carried out. It is a condition of any development consent granted, or complying development certificate issued, for the proposed development, that BASIX commitments be complied with.

Vater Commitments	Show on DA plans	Show on CC/CDC plans & specs	Certifier check
and scape Control of the Control of			
The applicant must plant indigenous or low water use species of vegetation throughout 75 square metres of the site.	· <	•	
Fixtures			
The applicant must install showerheads with a minimum rating of 3 star in all showers in the development.		<	<
The applicant must install a toilet flushing system with a minimum rating of 4 star in each toilet in the development.		•	<
The applicant must install taps with a minimum rating of 4 star in the kitchen in the development.	:	•	
The applicant must install basin taps with a minimum rating of 4 star in each bathroom in the development.	emplo. 1	<u> </u>	
Alternative water			
Rainwater tank The applicant must install a rainwater tank of at least 4000 litres on the site. This rainwater tank must meet, and be installed in accordance with, the requirements of all applicable regulatory authorities.	<	<	\
The applicant must configure the rainwater tank to collect rain runoff from at least 236 square metres of the roof area of the development (excluding the area of the roof which drains to any stormwater tank or private dam).		<	< <
The applicant must configure the rainwater tank so that overflow is diverted to a stormwater tank.		_	
The applicant must connect the rainwater tank to:	• • •	gargen to d - F ments	
all toilets in the development		<	<
 the cold water tap that supplies each clothes washer in the development 	<u> </u>	<	<
 at least one outdoor tap in the development (Note: NSWHealth does not recommend that rainwater be used for human consumption in areas with potable water supply.) 		<	*
 a tap that is located within 10 metres of the swimming pool in the development 	<u></u> .	<	<

The swimming pool must be outdoors.	The swimming pool must not have a volume greater than 40 kilolitres. The swimming pool must have a pool cover.	Swimming pool	 a sub-surface or non-aerosol irrigation system, or if the stormwater has been appropriately treated in accordance with applicable regulatory requirements, to at least one outdoor tap in the development (Note: NSWHealth does not recommend that stormwater be used to irrigate edible plants which are consumed raw.) 	at least 150 square metres of impervious areas	The applicant must configure the stormwater tank to collect overflow from the rainwater tank.	The applicant must install a stormwater tank with a capacity of at least 3000 litres on the site. This stormwater tank must meet, and be installed in accordance with, the requirements of all applicable regulatory authorities.	Water Commitments Show or DA plant
< <	~		<		<u> </u>	<u> </u>	Show on CC/CDC plans & specs
;			<u> </u>		<	<	Certifier check

Thermal Comfort Commitments Floor, walls and ceiling/roof The applicant must construct the floor(s), walls, and ceiling/roof of the dwelling in accordance with the specifical below.	oof of the dwelling in accordance with the specifications listed in the table	Show on Show on CC/CDC plans & specs	Certifier cs check
floor - concrete slab on ground	nii		
floor - suspended floor above garage, framed	nii	en e	words the latest statement of
external wall - framed (weatherboard, fibro, metal clad)	1.30 (or 1.70 including construction)		-
external wall - concrete block/plasterboard	1.18 (or 1.70 including construction)	A THE RESIDENCE OF THE PROPERTY OF THE PROPERT	
internal wall shared with garage - other/undecided	⊒.		
ceiling and roof - raked ceiling / pitched or skillion roof, framed	ceiling: 1.74 (up), roof: foil backed blanket (55mm)	framed; medium (solar absorptance 0.475-0.70)	475-0.70)

	 Pergolas with polycarbonate roof or similar translucent material must have a shading coefficient of less than 0.35. 	The leading edge of each eave, pergola, verandah, balcony or awning must be no more than 500 millimetres above the head of the window or glazed door, except that a projection greater than 500 mm and up to 1500 mm above the head must be twice the value in the table.	Except where the glass is 'single clear' or 'single toned', each window and glazed door must have a U-value no greater than that listed and a Solar Heat Gain Coefficient (SHGC) +/-10% of that listed. Total system U-values and SHGC must be calculated in accordance with National Fenestration Rating Council (NFRC) conditions.	The following requirements must also be satisfied in relation to each window and glazed door:	The dwelling may have 1 skylight (<0.7 square metres) and up to 2 windows/glazed doors (<0.7 square metres) which are not listed in the table.	The applicant must install the windows, glazed doors and shading devices described in the table below, in accordance with the specifications listed in the table. Relevant overshadowing specifications must be satisfied for each window and glazed door.	Windows, glazed doors and skylights	Thermal Comfort Commitments Show on DA plans	
•	<.	• <		<		•		Show on CC/CDC plans & specs	
	<	<	<	<	•	•		Certifier check	

Window/glazed	Orientation	Maximum area (square metres)	Тура	Shading	Overshadowing
W1	2	32.0	improved aluminium, single clear (U-value:6.44, SHGC:0.75)	eave/verandah/pergola/balcony 1,201-1,500 mm	not overshadowed
W2	Z	3.0	improved aluminium, single clear (U-value:6.44, SHGC:0.75)	eave/verandah/pergola/balcony 1,201-1,500 mm	not overshadowed
W3	Z	20.0	improved aluminium, single clear (U-value:6.44, SHGC:0.75)	eave/verandah/pergola/balcony 1,201-1,500 mm	not overshadowed
W4	Z	4.0	improved aluminium, single toned (U-value:6.39, SHGC:0.56)	eave/verandah/pergola/balcony 1,201-1,500 mm	not overshadowed
W5	S	13.9	improved aluminium, single pyrolytic low-e (U-value:4.48, SHGC:0.46)	eave/verandah/pergola/balcony 1,201-1,500 mm	not overshadowed
W7	m	2.5	improved aluminium, single clear (U-value:6.44, SHGC:0.75)	eave/verandah/pergola/balcony 751-900 mm	not overshadowed
The state of the s	•	-			

The computation of the

W15	W14	W12	W11	W10	W9	Windowiglazed door no. W8
8	¥	m		<u> </u>	m	Orientation E
9.8	6.2	2.6	5.0	6.0	4.6	Maximum area, (square metres) 2.0
improved aluminium, single pyrolytic low-e (U-value:4.48, SHGC:0:46)	improved aluminium, single clear (U-value:6.44, SHGC:0.75)	improved aluminium, single clear (U-value:6.44, SHGC:0.75)	improved aluminium, single foned (U-value:6.39, SHGC:0.56)	improved aluminium, single clear (U-value:6.44, SHGC:0.75)	improved aluminium, single clear (U-value:6.44, SHGC:0.75)	improved aluminium, single foned (U-value:6.39, SHGC:0.56)
eave/verandah/pergola/balcony 751-900 mm	eave/verandah/pergola/balcony 751-900 mm	awning (fixed) 1,200-2,000 mm	awning (fixed) 1,200-2,000 mm	eave/verandah/pergola/balcony 751-900 mm	eave/verandah/pergola/balcony 751-900 mm	Shading eave/verandah/pergola/balcony 751-900 mm
not overshadowed	not overshadowed	not overshadowed	not overshadowed	not overshadowed	not overshadowed	Overshadowing not overshadowed

Children by particular than

(c) have only 1 doorway, or opening less than 2 square metres in size, located in the direct path between them.	(b) be at feast 1 square metre in size; and	(a) not be more than 15 metres apart;	The 2 ventilation openings must meet the following specifications:	Breeze path 1: opposite external walls	The 2 ventilation openings must be located as follows:	The applicant must construct the dwelling so that at least 1 ventilation opening is provided in each such room or area of a dwelling is mentioned for a breeze path, then that room or area must have at least 2 ventilation openin	Breeze path 1: main living to other space (not separate bathroom)	The commitment below applies to the following rooms or areas of a dwelling which comprise a breeze path for the	Cross ventilation	nermal Comfort Commitments	
	<u> </u>	•		•		r area. (If only 1 room or		he dwelling:		Show or DA plan	
	<	<		<				<		Show on CC/CDC plans & specs	
	< ·	<		<u> </u>		<	- make	<		Certifier check	

Energy Commitments	Show on DA plans	Show on CC/CDC plans & specs	Certifler check
Hot water			
The applicant must install the following hot water system in the development, or a system with a higher energy rating, or a system with a higher energy rating: gas instantaneous - 6 Star	<	<	<
Cooling system			**************************************
The applicant must install the following cooling system, or a system with a higher energy rating, in at least 1 living area: ceiling fans; Energy rating: n/a		~	<
The applicant must install the following cooling system, or a system with a higher energy rating, in at least 1 bedroom: ceiling fans; Energy rating: n/a		•	<
Heating system			
The applicant must install the following heating system, or a system with a higher energy rating, in at least 1 living area: gas fixed flued heater; Energy rating: 5 Star		<	<
The applicant must install the following heating system, or a system with a higher energy rating, in at least 1 bedroom: gas fixed flued heater; Energy rating: 5 Star		<u> </u>	•
Ventilation			
The applicant must install the following exhaust systems in the development:			
Kitchen: individual fan, ducted to façade or roof; Operation control: manual switch on/off		, •	. <
Laundry: natural ventilation only, or no laundry; Operation control: n/a		< •	< •
Artificial lighting			
The applicant must ensure that the "primary type of artificial lighting" is fluorescent or light emitting diode (LED) lighting in each of the following rooms, and where the word "dedicated" appears, the fittings for those lights must only be capable of accepting fluorescent or light emitting diode (LED) lamps:			
• at least 3 of the bedrooms / study; dedicated		<	<
the kitchen; dedicated		<	<
• all bathrooms/toilets; dedicated		٠, ١	• •
• the laundry; dedicated		< -	< '

· was first of the same

t , , .

	Show on DA plans	Show on CC/CDC	Certifier check
all hallways; dedicated		-	<u> </u>
Natural lighting			
The applicant must install a window and/or skylight in 3 bathroom(s)/toilet(s) in the development for natural lighting.	<	<	<
Swimming pool			
not incorporate any hea		•	
The applicant must install a timer for the swimming pool pump in the development.	: -	<	
Office			
The applicant must install a gas cooktop & electric oven in the kitchen of the dwelling.		•	
The applicant must install a fixed outdoor clothes drying line as part of the development.		<	

In these commitments, "applicant" means the person carrying out the development.

Commitments identified with a V in the "Show on DA plans" column must be shown on the plans accompanying the development application for the proposed development (if a development application is to be lodged for the proposed development).

Commitments identified with a 🗸 in the "Show on CC/CDC plans and specs" column must be shown in the plans and specifications accompanying the application for a construction certificate I complying development certificate for the proposed development.

Commitments identified with a 🗸 in the "Certifier check" column must be certified by a certifying authority as having been fulfilled, before a final occupation certificate(either interim or final) for the development may be issued.

Department of Planning

15 May 2007

Wayne Treble Certification Group Unit 3/6 Wilmette Place Mona Vale NSW 2103 THE CERTIFICATION GROUP PTY LTD APPROVED CONSTRUCTION CERTIFICATE DOCUMENTATION.

Dear Wayne,

This letter is just to inform you that I Trent Barnabas as the Owner Builder of 43 Crescent Road Newport, will comply with condition C7 of the Development Consents endorsed on the 17 march 2007. I will also make sure that the building conforms with the Basix Certificate.

Kind Regards TRENT BARNABAS

T.M.

COUNCIL COPY

3 Edgediffe Esplanade Seaforth N.S.W. 2092 Phone: 9949-7379

Structural and Civil Engineer

May 14 2007

The General Manager Pittwater Council 5 Vuko Place WARRIEWOOD 2102

Dear Sir

Re Residence at 43 Crescent Road, Newport for Mr & Mrs T Barnabas

I certify that the Stormwater Drawing No 0715-3 and has been designed to comply with the Water Management Policy B5.3 of Pittwater 21 DCP.

Should you require any further information, please do not hesitate to contact me.

Yours faithfully

MICHAEL GERGICH

Muhael Gergich

THE CERTIFICATION GROUP PTY LTD APPROVED CONSTRUCTION CERTIFICATE DOCUMENTATION.



Pittwater Council Information for Access Driveway Profiles 1 July 2006 - 30 June 2007

To:

Christine and Trent Barnabas

Postal Address:

43 Crescent Road

NEWPORT NSW 2106

Date: 26 March 2007

Receipt No: 212903

Amount:

\$66.00

ACCESS DRIVEWAY PROFILE AT:

43 Crescent Road, Newport 2106

The proposed vehicular access driveway profile shall be as per the enclosed plan NL.

Type of Construction: Domestic

Slab Construction: Vehicular access slab 8.0m long, 4.0m wide at gutter crossing to 3.5m wide at the boundary.

Note: AS 2890.1-1993 Fig 3.1 does not allow driveway on kerb return.

- Council will only permit an absolute maximum gradient of 25% (1 in 4) measured at any point on the driveway and that an ease may be required for access into the car stand area, carport or garage. Refer to relevant attached profile.
- All work within the road reserve (including excavation) in connection with the above, is to be carried out by authorised Contractors only:
- Quotations for the work specified above should be obtained from any of the contractors on Council's list and should be for the whole of the work stated;
- Construction of vehicular access will be strictly in accordance with the profile supplied; and
- A formwork inspection by Council is required prior to construction. (Provide minimum 24 hours notice)
 - NOTE THAT THIS INFORMATION SHEET DOES NOT CONSTITUTE AN APPROVAL 1. TO COMMENCE OR PROCEED WITH ANY WORK ON SITE.
- 2. A SECTION 139 CONSENT UNDER THE ROADS ACT - 1993 IS REQUIRED (FORM UI203).
- FAILURE TO OBTAIN SUCH CONSENT PRIOR TO COMMENCING WORK WILL 3. INCUR A PENALTY.


S. milde


Sigi Melderis

ASSETS / RESTORATIONS OFFICER

Telephone: 9970 1348

THE CERTIFICATION GROUP PTY LTD APPROVED CONSTRUCTION CERTIFICATE DOCUMENTATION.

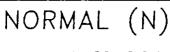

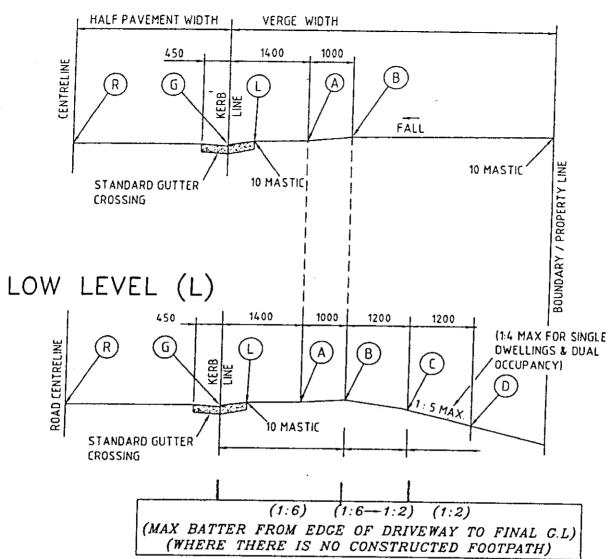

POINT	REMARKS	LEVELS
R	ROAD CENTRELINE	
G	INVERT OF GUTTER	
Ĺ	BACK OF LAYBACK	100 ABOVE "G"
Α	1400 FROM KERB LINE	130 ABOVE "G"
8	2400 FROM KERB LINE	150 ABOVE "G"
ζ	3600 FROM KERB LINE	MAX 20 ABOVE "G"
D	4800 FROM KERB LINE	MAX 130 BELOW "G"

THE CERTIFICATION GROUP PTY LTD APPROVED CONSTRUCTION CERTIFICATE DOCUMENTATION.

NOTE

- To be read in conjunction with Pittwater 21 Development Controls.



PITTWATER

COUNCIL

PLAN No. PWC-DW6

Standard Driveway Profile

NORMAL TO

REV No. В DATE 26/8/05

Plot Date: 26 August, 2005 - 9:46 AM



See reverse of form for instructions

.EVY PAYMENT FORM

FORM NO.

OFFICE USE ONLY

	SAVARIA CODEATESO PERSO	VGONPANY/ORGANISATION BY ADDRESTOR PAY BEASE PRINT ALL DETAILS USING CAPITALS
	Surname (if person) or Company/Organisation name	BARNABAS
	Given names (if person)	TRENT THE CERTIFICATION GROUP PTY LTD
X	ABN (if applicable)	APPROVED CONSTRUCTION CERTIFICATE DOCUMENTATION.
•	POSTAL ADDRESS No. and street or PO Box	43 BUNGAN HEAD RD
	Town/suburb	NEWPORT
Vicaliza	State	NSW Postcode 2106 Bus. hours phone 0400470062
	PART BE ADDRESS OF BUILD	Ng/construction awork
	Number and street	43 CRESCENT ROAD
	·	
X	Town/suburb	NEWPORT
	State	NSW Postcode 2106
	Estimated start date D	12 MOS Y 2007 Estimated finish date D 17 MOZ Y 2008
	PART CEDETAILS OF WORK	To be completed by consenting/certifying authority with whom plant lodged for approval.
	Local Council Area	PUH HEROCOUNCIONANA
	¹ DA/CC/CDC No.	MODUSTOCOCOCOCOCOCOCOCOCOCOCOCOCOCOCOCOCOCOC
	Estimated value of work (see note on back)	
	' If you have provided a CC above,	
	Signature of Officer/Private Certifi	Date DOC MOS Y Z CO 7
	Name of Officer/Private Certifier _	
a dina	Plies dans granden	plets to us bept Atting to where applicable least leveres
	Department/Authority	
	Contract/DA No (circle which)	Contract amount \$,
	Levy payable \$	
	Contact person (Print)	Phone number
	Contact person (Signature)	
	ART E - DECLARATION - To be	signed by person (lable, to pay lew or anthorised officer if company organisation
	Any talse or misleading information	provided on this form may result in prosecution under Section 58A. In provided on this form is true and correct to the best of my knowledge
		NABAS Signature Date D O V M O T v 2 C O 7
	And estimate our later and	NEAPAGAIRE SEENWEISE ON CONTROL
Ē	xemption Approval Certificate No.	K# 214433

Pittwater Council

ALM: 61340037871

TAX INVOICE OFFICIAL RECEIPT

1/05/2007 Receipt No 2:4433

. To trent barrabas

43 bungan nead road newport new 2106 THE CERTIFICATION GROUP PTY LTD
APPROVED CONSTRUCTION CERTIFICATE
DOCUMENTATION.

Oty/ Applic Feference Meduat

GLGL-Buil #1,481.80
GL Rec 1 x post3/06 43 crashent road
1 CCGST-CCa \$15.18
GL Rec 1
GST \$1.53
GL Rec


Total Amount: \$1,698.61
Locludes GST of: \$1.53

Amounts Tendered

Db/Cr Card \$1,698.51
Total \$1,698.61
Rouncing \$0.00
Change \$0.00
Nett \$1,678.51

Printed 1/05/2007 1:58:[3 PM | Cashier MPorter



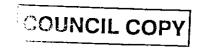

Ref: 183 - Schedule of External Finshes

22nd May 2007

43 Crescent Road, Newport

CC: 136/2007 DA: N0623/06 THE CERTIFICATION GROUP PTY LTD

APPROVED CONSTRUCTION CERTIFICATE

DOCUMENTATION.

Schedule of I	External Finishes
	als & Colours
Roofing and Gutters	Colour Bond - Wind Spray
External Privacy Screens	Western red cedar and coated with a natural oil
Fence Panels and Decks	Grey Ironback and coated with a natural oil
External Weatherboards	Dulux - Linseed
Window Frames	Clear anodised aluminium

NICK FADEEV

CIVIL & TRAFFIC ENGINEERING CONSULTANT

26 April 2007

Our Ref: 7002

General Manager
Pittwater Council
PO Box 882
MONA VALE NSW 1660

THE CERTIFICATION GROUP PTY LTD APPROVED CONSTRUCTION CERTIFICATE DOCUMENTATION.

Dear Sir

43 CRESCENT ROAD, NEWPORT -CONSTRUCTION OF A NEW DRIVEWAY TO A NEW DWELLING

Introduction

The subject property is located on the north east corner of the intersection of Cecil St with Crescent Road, Newport. Council has issued Development Consent for a new dwelling on the subject site, which includes Consent drawing No. DA2001 rev C, a copy of which is attached. This drawing shows the new driveway intersecting with Crescent Road at an angle to the kerb and partly within the kerb return of Cecil St.

Following application for levels, the property owner Mr Trent Barnabas was advised by Council officers that they had some concern for the location of the entry and exit location of the proposed driveway, and requested that Mr Barnabas obtain professional advice regarding its safety for future users. Mr Barnabas engaged my services to review the proposal, with a view to obtaining certification to overcome Council's concerns.

Assessment of Proposed Driveway Location

Following examination of the proposed location on the site, I concluded that the proposed arrangement would be unsafe for future users, for the following reasons.

- 1. The angle at which the driveway intersects Crescent Road, although slightly improving the line of sight for vehicles approaching from the north-west, makes worse the line of sight for vehicles approaching along Crescent Rd from the south.
- 2. The line of sight for vehicles approaching along Crescent Rd from the south is made worse by the fact that Crescent Road has a crest just south of the subject property and also bends around further to the west, which would require drivers backing out of the proposed driveway, to look back over their shoulder to see oncoming traffic from the south.
- 3. Due to the crest on Crescent Rd relative to the location of the exit point of the driveway, the sight distance to approaching vehicles from the south is somewhat restricted. From my observations on site I was able to conclude that the available sight distance would not Council's requirement for a minimum of 50m of sight distance, and therefore would not provide safe exit onto Crescent Road.

ABN 35 060 260 828

103 Essilia Street, Collaroy Plateau. NSW 2097

Phone: 02 9971 7562. Mobile 0418 462 829 Email: fadeev@optusnet.com.au

NICK FADEEV

CIVIL ENGINEERING CONSULTANT

4. The proposed driveway was also partly within the kerb return into Cecil St. This was also considered undesirable in that it would result in vehicles either backing out into the intersection with Cecil St, or out onto the wrong side of Crescent Rd. For the above reasons I was not prepared to certify the location of the proposed driveway as shown on the Consent plans.

Alternative Proposal

Due to crest and bend in Crescent Road just south of the subject property, as described above, it was clear that reversing out onto Crescent Rd from the approved garage was not an option on safety grounds. Given the approved location of the garage and entry point to the site, there were few available alternatives

I have designed an alternative which substantially improves safety for residents of the new dwelling by arranging entry and exit via Cecil St. See drawings No.s 7002/1 to 7002/3, which show the proposed alternate arrangement. In particular drawing 7002/3 demonstrates the turning path of an entering vehicle. I consider this arrangement to be far superior to the proposal on the Consent plans for the following reasons.

- 1. adequate sight distance is available in all directions, not only for the driver of the exiting vehicle, but for approaching vehicles in both Crescent Rd and Cecil St.
- 2. vehicles can enter and leave the driveway at almost 90° to the kerb,
- 3. vehicles are backing out into Cecil St, which has much lower traffic volumes, and
- its location is not so conducive to cutting across the intersection to enter the driveway, as was the case with proposal on the Consent plans.

Driveway Grading

Drawing No.s 7002/4 and 7002/5 show the proposed driveway gradings along each side of the driveway. Due to the existence of two Council concrete pit lids in the verge area, it was necessary to employ the use of the maximum allowable grade of 25%. However this is considered quite acceptable in the circumstance, given the short length over which it occurs, and the provision of adequate transition grades, as demonstrated by the AS 2890.1:2004 B85 Vehicle Ground Clearance Template. Also the maximum centre-line grade between the boundary and the kerb is approximately 20%.

Certification

I am a practicing consultant Civil Engineer with in excess of 25 years experience in local government civil design, including extensive experience in the assessment and design of safe pedestrian and vehicular access and parking associated with residential and commercial development. I hold a degree in Civil Engineering with a post graduate diploma in Local Government Engineering, and am a member of the Institution of Engineers Australia and the Local Government Engineers Association.

I certify that the driveway design shown on Drawing No.7002/1 to 7002/5, satisfies the objectives of Section B6 of Council's 21 DCP and AS2890.1: 2004, and will provide practical and safe vehicular access to the proposed garage.


NICK FADEEV

CIVIL ENGINEERING CONSULTANT

Should clarification of any aspect of this advice be required, please do not hesitate to contact the undersigned on mobile ph. 0418 462 829.

Yours faithfully

NICK FADEEV B.Sc(Civil Eng), Dip.LGEng, MIEAust.

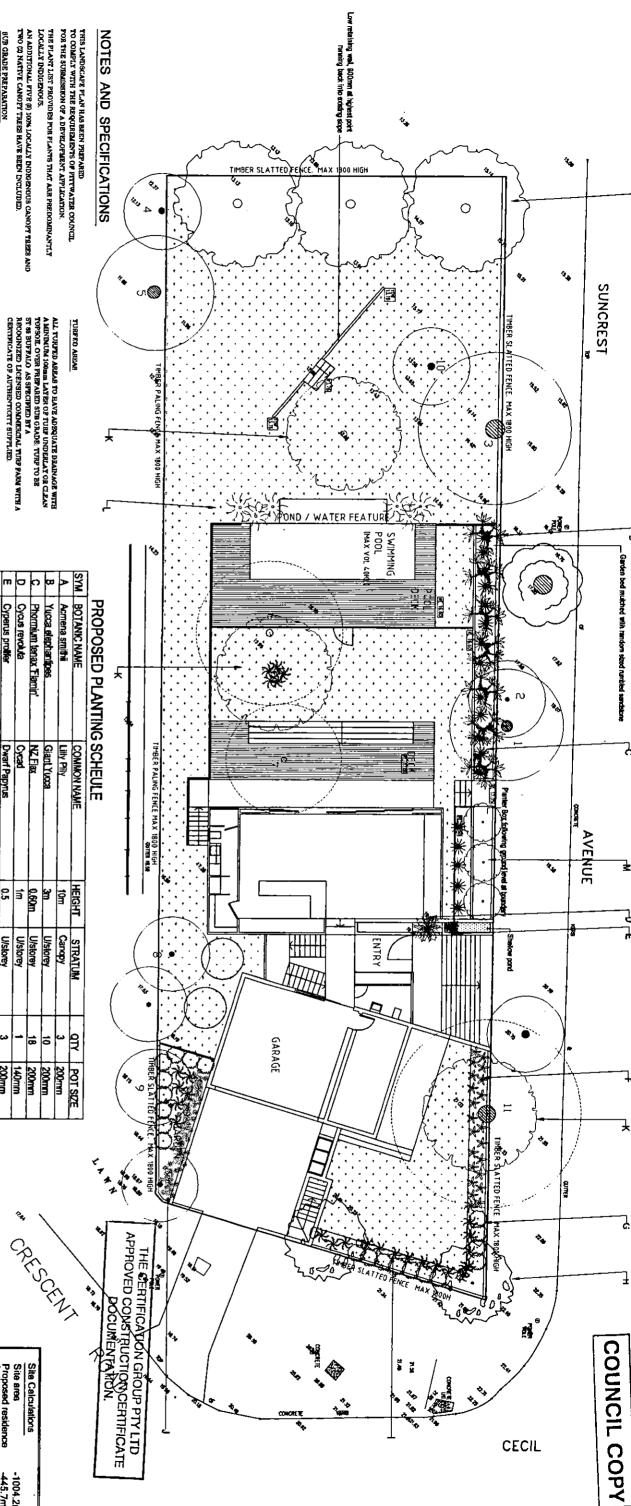

THIS LANDSCAPE FLAN HAS BEEN PREPARED TO COMPLY WITH THE REQUIREMENTS OF PITTWATER COUNCIL FOR THE SUBMISSION OF A DEVELOPMENT APPLICATION.

THE PLANT LIST PROVIDES FOR PLANTS THAT ARE PREDOMINANTLY LOCALLY INDIGENOUS.

AN ADDITIONAL FIVE (6) 100% LOCALLY INDIGENOUS CANOPT TREES AND I'WO (2) NATIVE CANOPT TREES HAVE BEEN INCLUDED.

ALL TURPED AREAS TO HAVE ADEQUATE DEAINAGE WITH A MINIMUM 100mm LAYER OF TURP UNDERLAY OR CLEAN TOPSOL. OVER PRE-RAND SUB-CRADS, TURP TO BE ST 85 BUFFALO, AS SPECIPED BY A RECOGNIZED LICENSED COMMERCIAL TURP FAKH WITH A CERTIFICATE OF AUTHENTICITY SUPPLIED.

BUB GRADE PREPARATION

THE SUB GRADE TO ALL LANDSCAPED AREAS IS TO BE GRADED BYZDUT TO ACHIEVE THE REQUIRED FALLS AND FURBIED LEVELS, LOOKS TO APP SUIDING DEBMS ARE TO BE EXECUTED FROM APPLICATIONS OF ANY TOPSOIL OR TURE UNDERLAY, WHERE THE SUBSOIL BE CLAY, APPLY GYPSUM AT A BAYE OP 2 SHE JOINT PHORE THE SUBSOIL BY CONTROLLED TO THE SUBSOIL BY CANTERING AND TOPSOIL OR THE SUBSOIL BY CONTROLLED THE SUBS

GARDEN BED PREPARATION

ALL GARDEN BEDS MUST HAVE ADEQUATE DRAINAGE AND BAVE A MUNKUN SODM LATER OF NATIVE SOIL MIX PLACED OVER PREVARED SUB GRADE. NATIVE SOIL MIX TO SE MULCEED WITH FOREST FIVES -TAKM THICK

AN AUTOMATIC DRIF BRRGATON SYSTEM IS TO BE INSTALLED TO ALL GAEDEN AREAS AND TREE ELANTINGS, THIS WILL ASSIST WITH THE ESTABLESHNENT AND LONG TERM DEVELOPMENT OF THE PLANT MATERIAL.

RRIGATION

PERTILIZZE, POR PLANTS TO BE LONG LIFE (*MONTES)
WITH A STITARLE NATUTE PLANT SORAILA NO BE APPLED
MITHER PLANTING BEFORE MULCHING AND EYERS (*MONTHS
THEREALTER, THER TO BE FRETILIZED FOLLOWING THE
COMMERCIAL TURF PAGNE INSTRUCTIONS.

PLANTING MATERIAL/FLANTING PROCEDURES

MAINTAIN ALL LANDSCAPED AREAS, BY THE FOLLOWING ACTIVITIES, MOWING, EDGING AND TOP DRESSING OF TURF AREAS, PERTILEZING ALL FAXT MATERIAL, PENDING, WATERING, TREAT PERT AND DISEASES, TOPING UP OF MULCH AREAS, WEEDING GARDSN BEDS AND THRE AREAS,

ALL PLANTS ARE TO BE TRUE TO TITE, FREE FROM FORT AND DISEASES AND BE IF A PROPROJE WELL DEVELOPED CONDITION. ALL TREES TO HAVE A SINGLE LEADER IN APPROPRIATE SPECIES.

ALL PLANTS ARE TO BE REMOVED FROM CONTAINERS REPORE PLANTS AND TO BE ORDER TO AND AFTER PLANTING OPERATIONS. PLANTS AUST EN WATERED REGULARLY AFTER PLANTING OPERATIONS. PLANTS MUST BE WATERED REGULARLY AFTER PLANTING TO ENCOURAGE HEALTS AND VIGOR.

Native garden mix; make the planting hole twice the diameter of the roothall and the same depth as the roothall

— Hardwood stake
38x38x1800mm long
18x48led wertically
— Keep the top of the rootball flush
with the top of the planting hole 75mm depth mulch; form a shallow saucer at the base of stem 50mm wide bestian tie twisted twice and stapled to stake

Cultivate sub-grade to 150mm depth
NOTE: REMOVE CONTAINER, WATERING AFTER PLANTING IS MOST CRITICAL
15 - 35 LITRE TREE PLANTING
DETAIL. NOT TO SCALE

200mm	ယ	U/Storey	3	Large Lear Banksia	Deliksia luuui	X
200mm	6	Canopy	ä	Lacy Parm	Raprils excesse	-
	•				Parkin amala	-
200mm	w	Canopy	≅	Water Gum	Tristaniopsis laurina	~
200mm	61	U/storey	0.30m	Lily Turf	Dianella revoluta 'Baby Biss'	٦
200mm	27	U/storey	0.6m	Tanika	Lomandra Longifolia Tanika'	-
200mm	2	Canopy	15m	Coastal Banksia	Banksia integrifolia	Ŧ
200mm	20	Ulstorey	¥	Coast Rosemary 'Sea Mist'	Westringia fruticosa	ြ
200mm	21	Ufstorey	0.5m	Lily Turi	Dianella prunina 'Utopia'	7
200mm	w	Ulstorey	0.5	Dwarf Papyrus	Cyperus proffer	E
140mm		U/storey	ā	Cycad	Cycus revoluta	0
200mm	18	U/storey	0.60m	NZFlax	Phornium tenax Flamin*	C
200mm	10	U/storey	33	Giant Yucca	Yucca elephantipes	В
200mm	cu	Canopy	10m	Lify Pily	Acmena smithii	P
POT SIZE	QTY	SIRAIUM	HERGHI	COMMON NAME	- 1	31.81

& driveway america series of the series of t

xosed residence

-1004.2m ² -445.7m²

ximum site cover

40% 44.3%

Site area

SCHEDULE OF EXISTING SITE VEGETATION

6	9	œ	7	65	5	4	w	2	-	₹	
Acmena smithi	ucalyptus botryoides	Velaleuca spp	Stenocarpus sinuatus	riobotrya Japonica	inus radiata	Lucalyptus microconys	Corymbia citríodora	Syncarpia glomulflera	Sycarpia glomufifera	BOTANIC NAME	
Lilly Pilly	Bangalay Gum	Tea Tree	Queensland Firewheel Tree	Loquat	Radiata Pine	Tallowood	Lemon Scented Gum	Turpentine	Turpentine	COMMON NAME	
BM	Sin	ST .	12m	4	17m	18m	18m	5m	â	HEIGHT	
en en	3m	3m	7m	6m	12m	12m	14m	4m	7m	SPREAD	
Good	Good	Good	Fair	Poor	Fair	Fair	Good	Fair	Fair	EXISTING	
Retain	Retain	Remove	Remove	Remove	Retain	Retain	Retain	Retain	Retain	PROPOSED ACTION	
	Achena smithil Lilly Pilly 8m 8m Good	Eucalyptus bottyoides BangalayGum 5m 3m Good 2 Acmena smithit Lilly Pilly 8m 8m Good	Melaleuca spp Tea Tree 5n 3m Good Eucalyptus bottyoides Bangalay Gum 5n 3m Good Acmena smithii Lilly Pilly 8m 8m Good	Stenocarpus sinuatus Queensland Firewheel Tree Melaleuca spp Tea Tree 5m 3m Good Lilly Pilly 8m 8m Good	Eriobothya japonica Loquet 4m 6m Poor Sternocarpus sinuatus Queensland Firewheel Tree 12m 7m Fair Melaleuca spp Tea Tree 5m 3m Good Eucalyptus bothyoides Bangalay Gum 5m 3m Good 2 Acmena smithii Lilly Pilly 8m 8m Good	Pinus radiata Radiata Pfre I7m. 12m Fair Eriobothya japonica Loquet Am 6m Poor Stenocarpus sinuatus Queensland Firewheel Tree 12m 7m Fair Melaleuca spp Tea Tree Eucalyptus bothyoides Bangalay Gum Acmena smithii Lilly Pilly 8m 8m Good	Eucalyptus microcorys Tallowcod 18m 12m Fair Pinus radiata Radiata Phe 17m 12m Fair Eriobothya japonica Loquet 4m 6m Poor Stenocarpus sinuatus Queensland Firewheel Tree 12m 7m Fair Metaleuca spp Tea Tree 5m 3m Good Eucalyptus bothycides Bangalay Gum 5m 8m Good	Corymbia citriodora Lemon Scented Gum 18m 14m Good Eucalyptus microconys Tallowood 18m 12m Fajr Pinus radiata Radiata Phe 17m 12m Fajr Eriobothya Japonica Loquet 4m 6m Poor Stenocarpus sinuatus Queensland Firewheel Tree 12m 7m Fair Melaleuca spp Tea Tree 5m 3m Good Eucalyptus bothycides Bangalay Gum 5m 3m Good D Acmena smithii Lilly Pilly 8m 8m Good	Syntarpia glomulifera Turpentire Sm 4m Fair Corymbia citriodoxa Lennon Scented Gum 18m 14m Good Eucalyptus microcorys Tallowood 18m 12m Fair Prinus radiala Radiata Phe 17m 12m Fair Eriobobra Japonica Loquet 4m 6m Poor Stenocarpus sinuatus Queensland Firewheel Tiree 12m 7m Fair Melaleuca spp Tea Tree 5m 3m Good Eucalyptus bothycides Bangalay Gum 5m 3m Good D Acmena smithii Lilly Pilly 8m 8m Good	Sycarpia glomulifiera Turpentire 8m 7m Fair Synicarpia glomulifiera Turpentire 5m 4m Fair Synicarpia glomulifiera Turpentire 5m 4m Fair Corymbia citriodoxa Lennon Scented Gurm 18m 14m Good Eucalyptus microcorys Tallowood 18m 12m Fair Prinus radiata Prinus	BOTANIC NAME COMMON NAME HEIGHT SPREAD CONDITION Trupentine Trupentine Syncarpia glomulifiera Trupentine Trupentine Trupentine Sm 4m Fair Corymbia citriodora Lennon Scented Gum Tallowood Tallowo

I Rebecta Anteliff certify that this plan provides that the works to be carried out will achieve the relevant conditions of the development

This Landscape Plan complies in all respects with the conditions of development consent. The understorey plannings provides species that are locally growing and will after three pears in conjunction with the canopy plannings errors 05% of the built form when riewed from the street. This plan provides three (3) locally native canopy trees that will acheive a height greater than 8.0m at maturity in the front yard.

This plan provides four (4) canopy trees that will achieve a canopy height greater than 8.5m in the rear yard.

The Camphor Laurel tree (Tree 11) is to be removed and a replacement canopy tree.

This tantopsis laurina (Water Gum) is to be provided



12 Wallumatta Road NEWPORT NSW 2106 Mob: 0412 345 683 Ph/Fax: 9940 1888 GARDEN**DESIGN** rebeccaantcliff

CLIENT: Mr & Mrs Barnabas


PROJECT: New Residence


DRAWING: 43 Crescent Road LANDSCAPE PLAN **NEWPORT NSW 2106**


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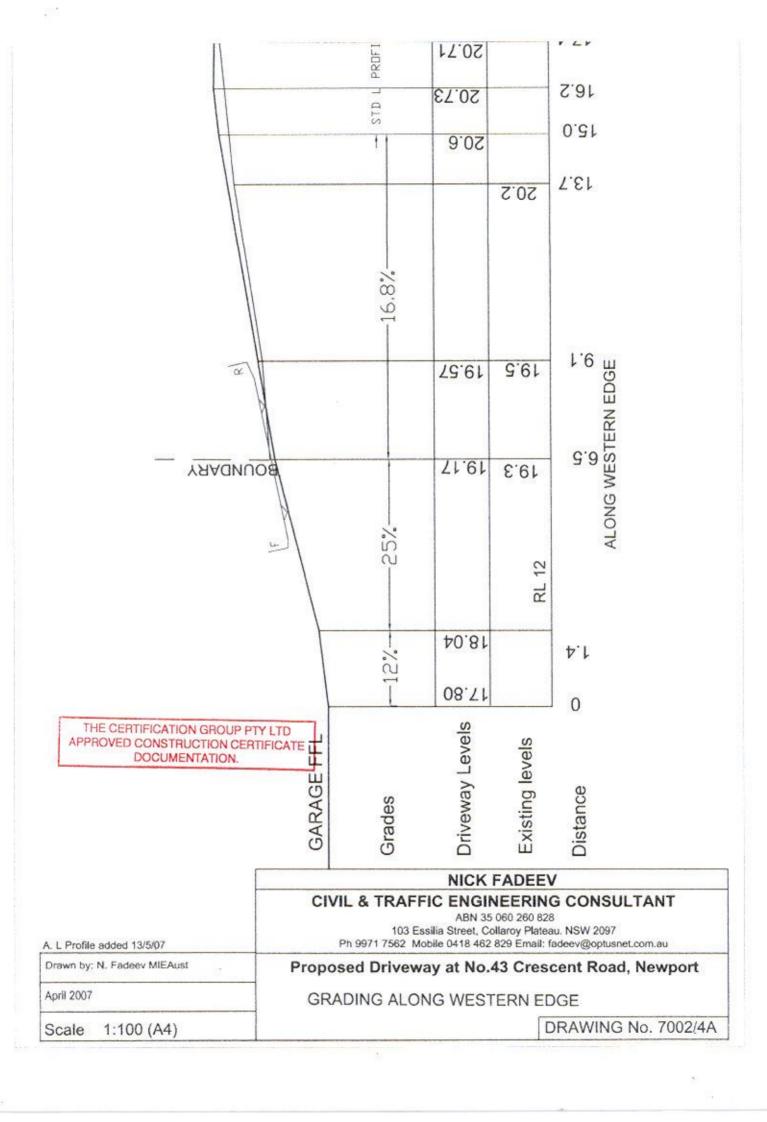
SCALE: DATE: 27 March 2007 1.200 @ A3






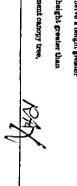

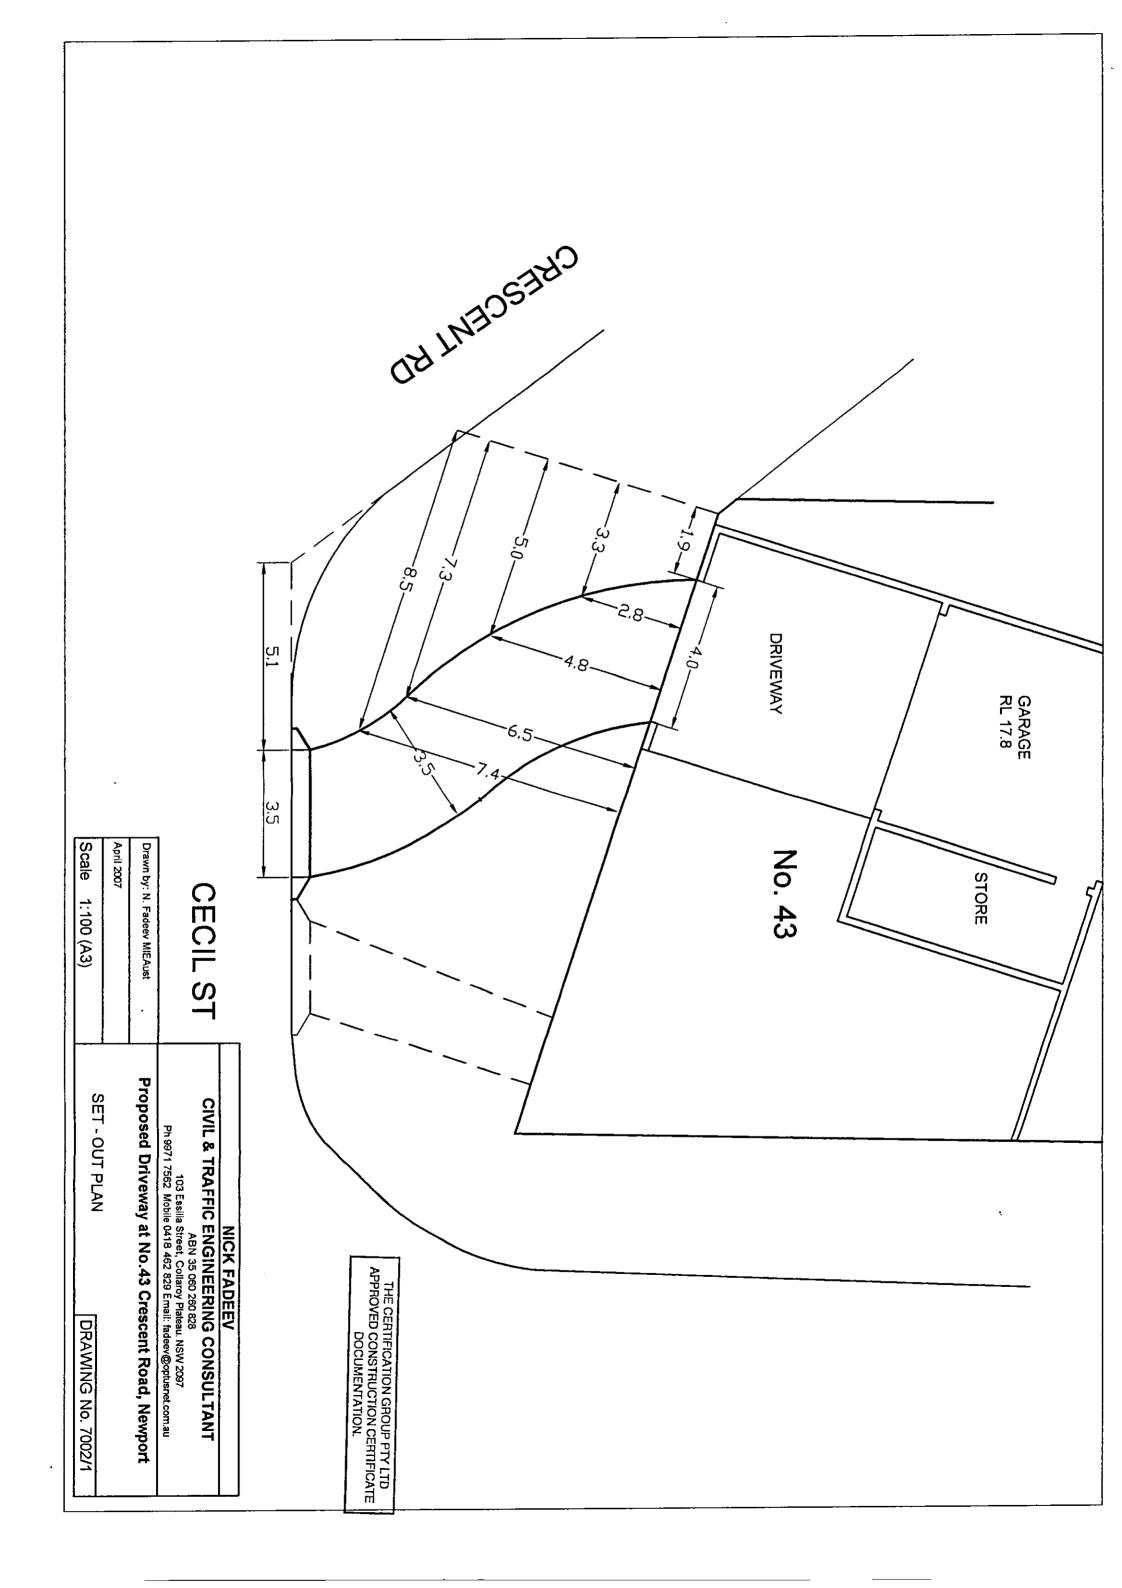


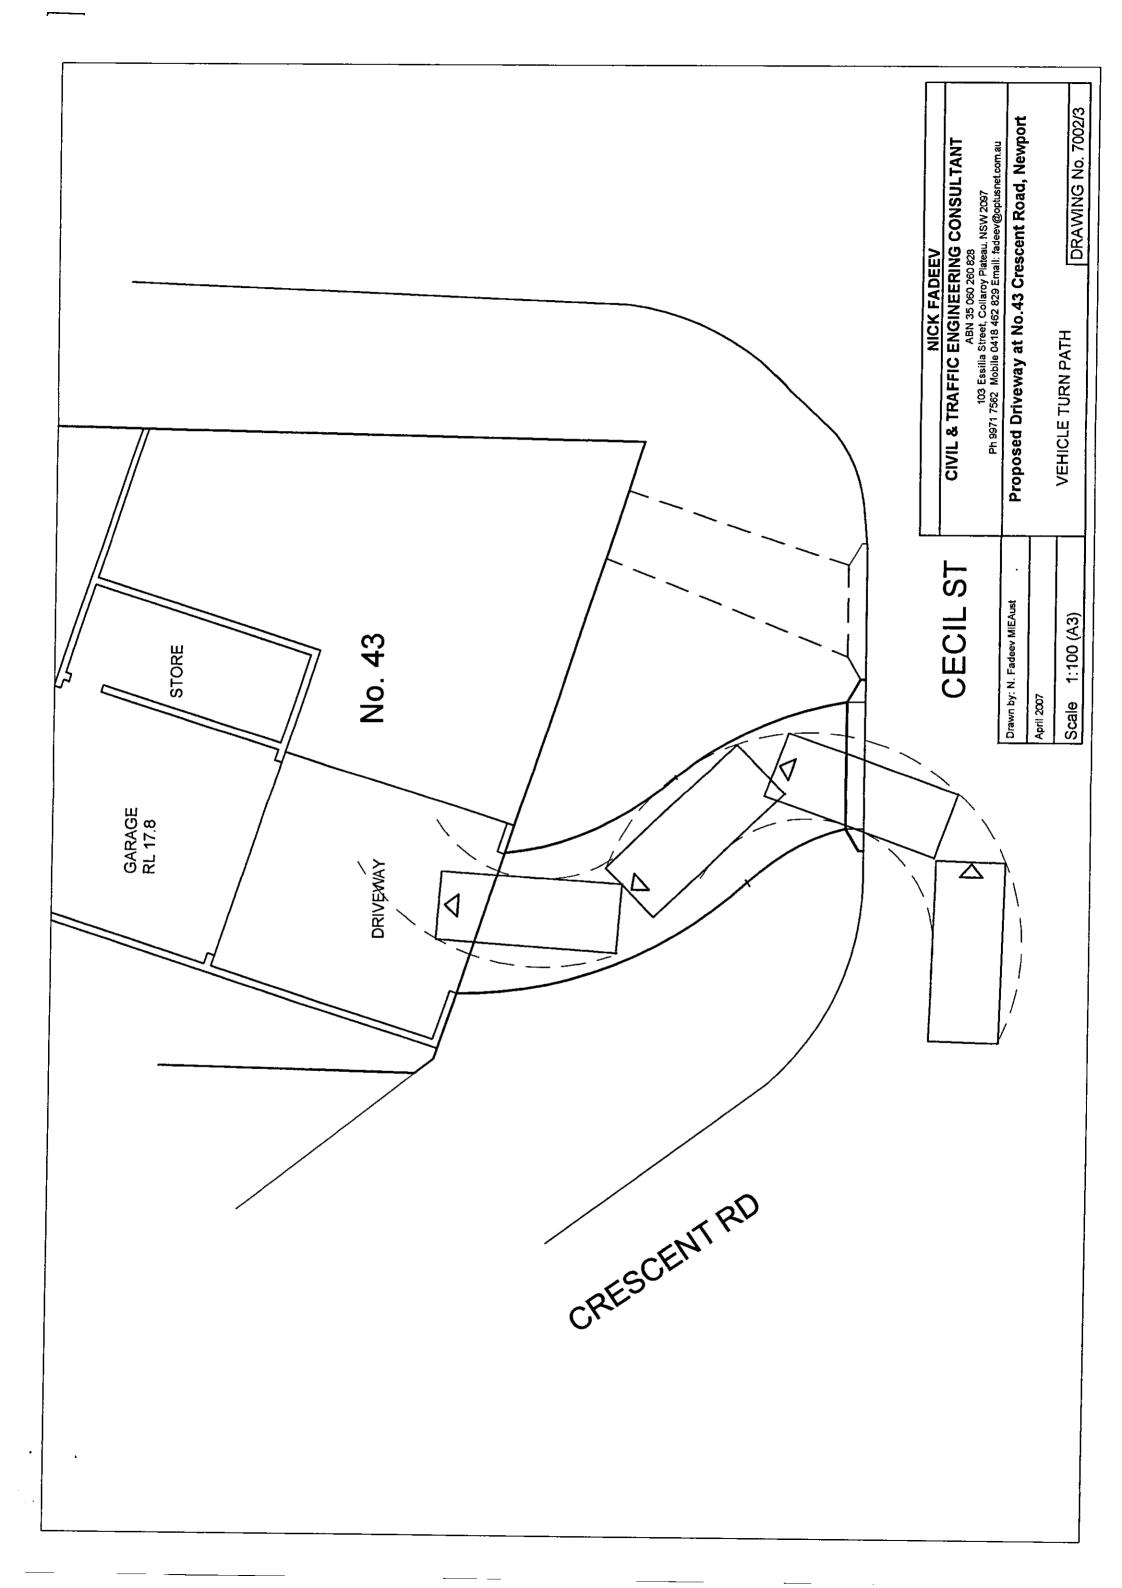


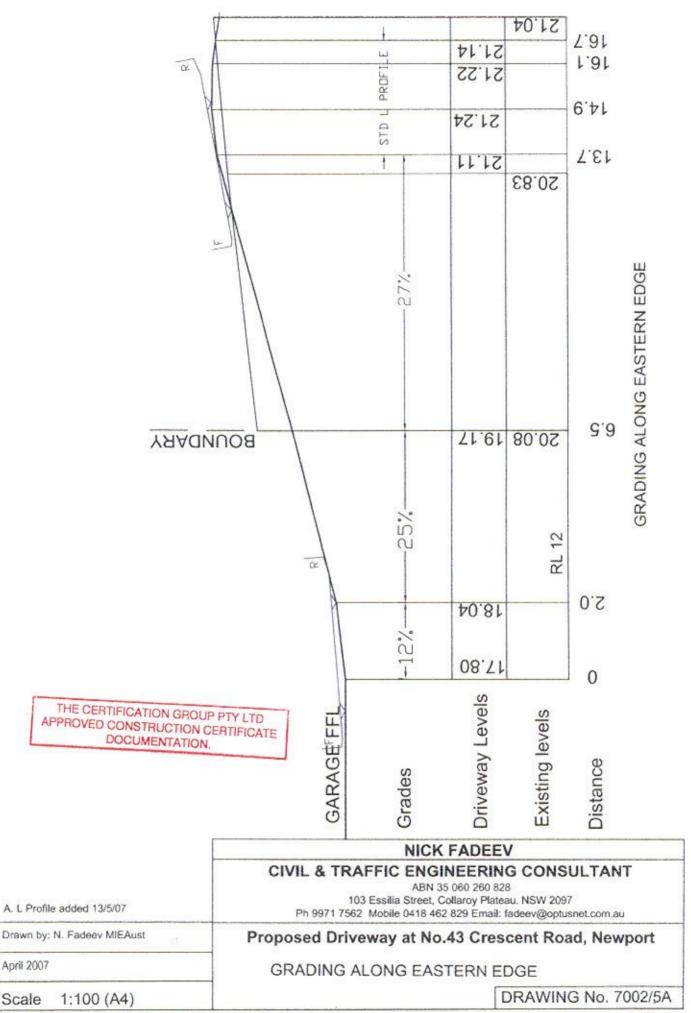


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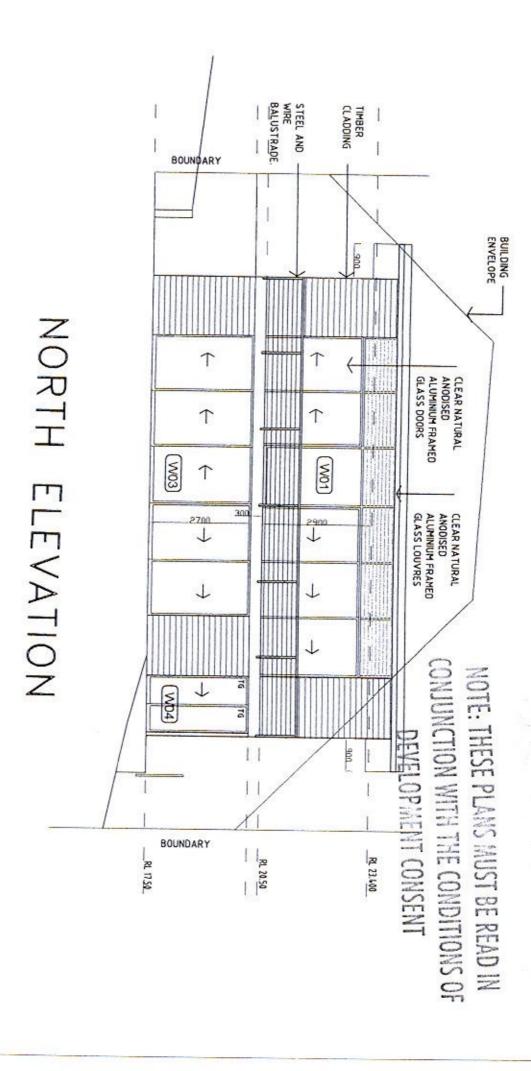




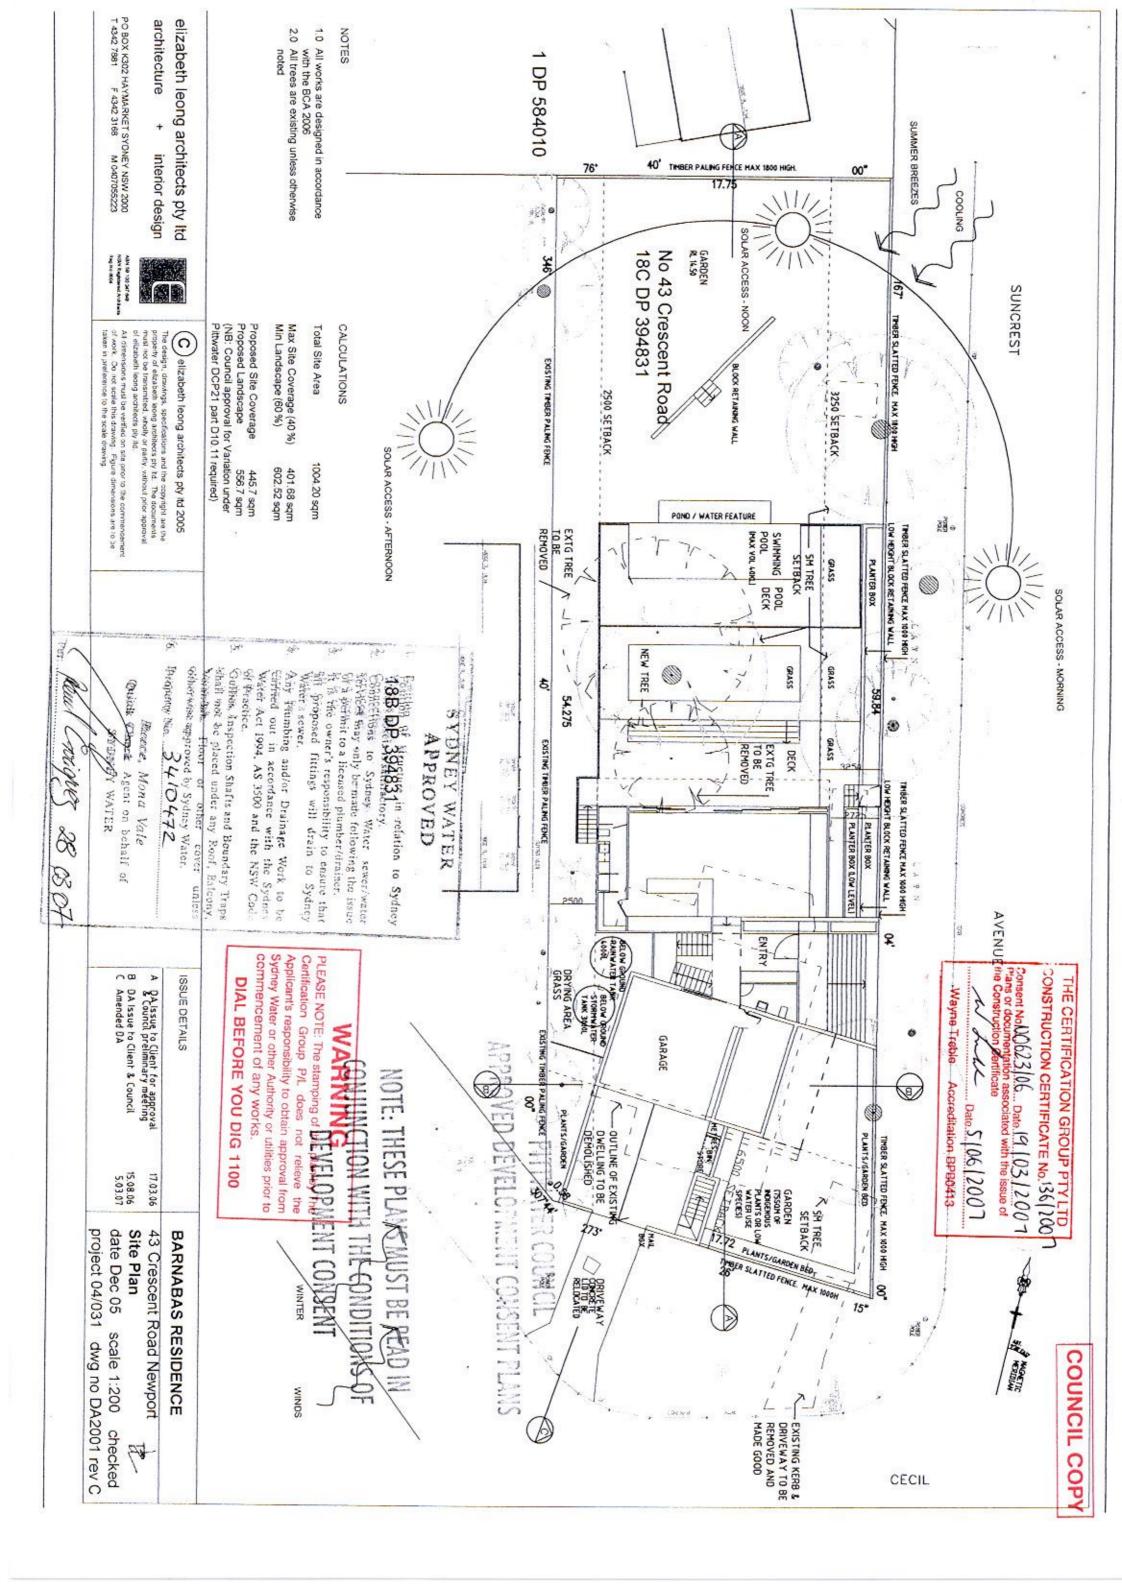

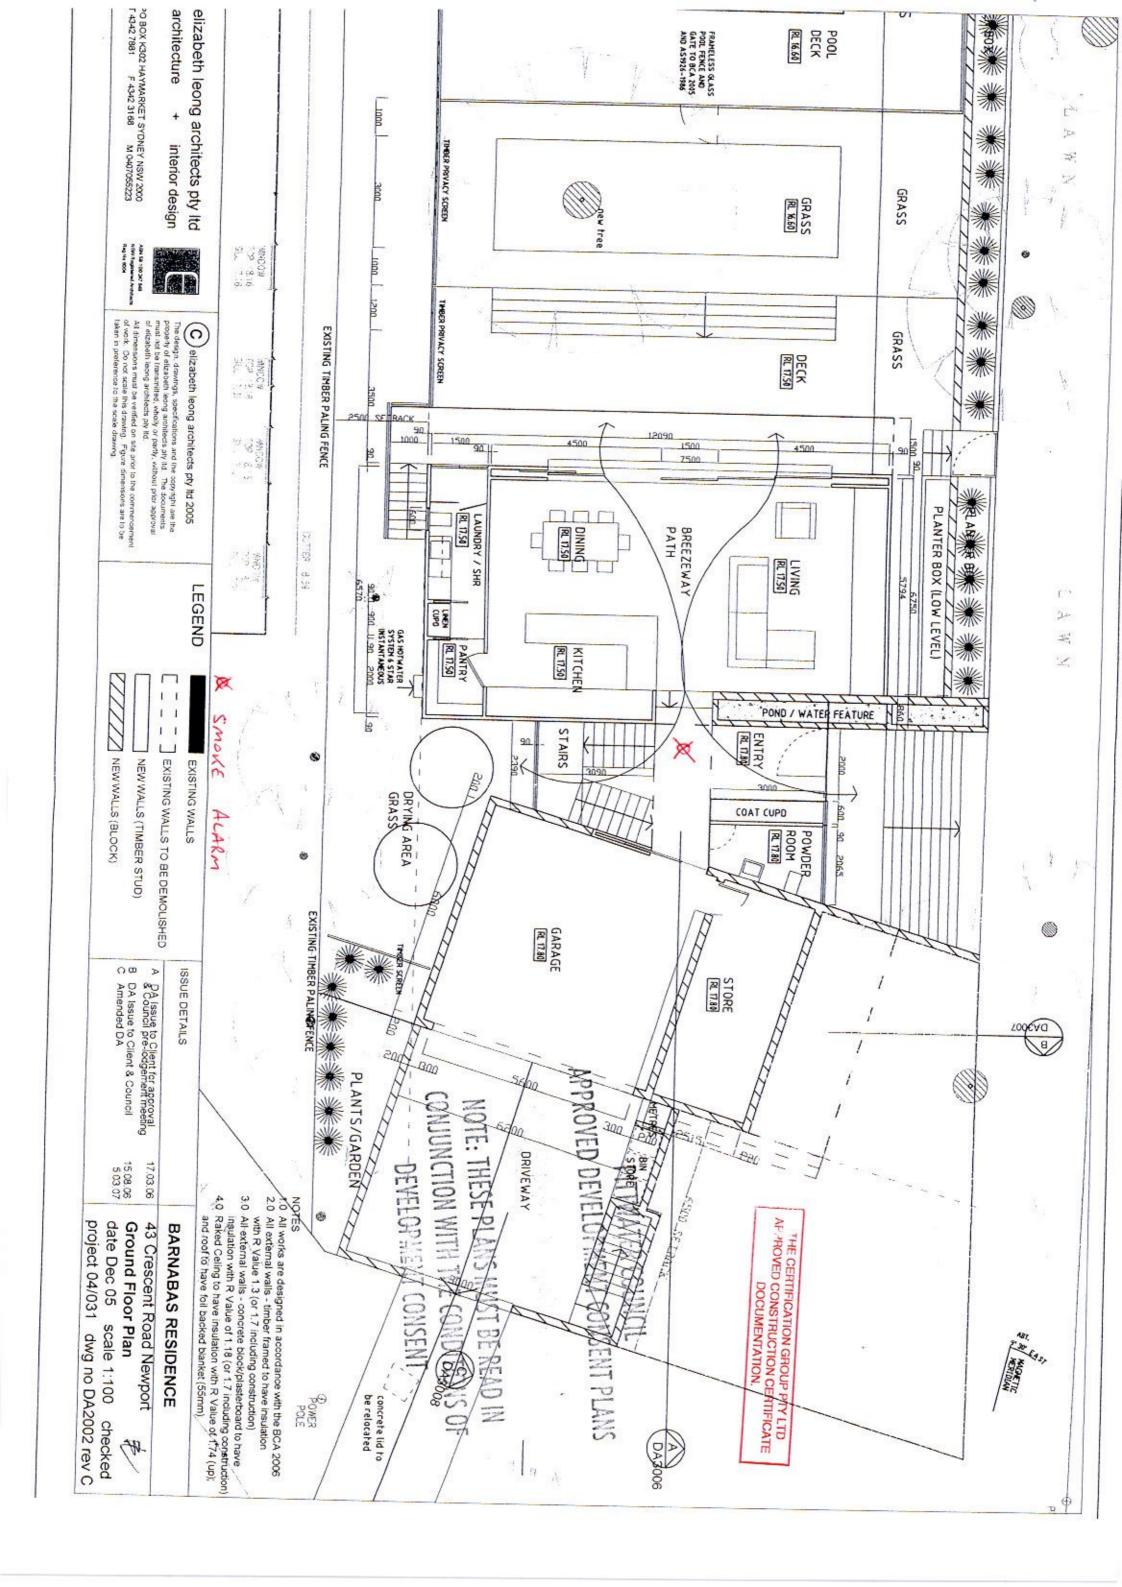

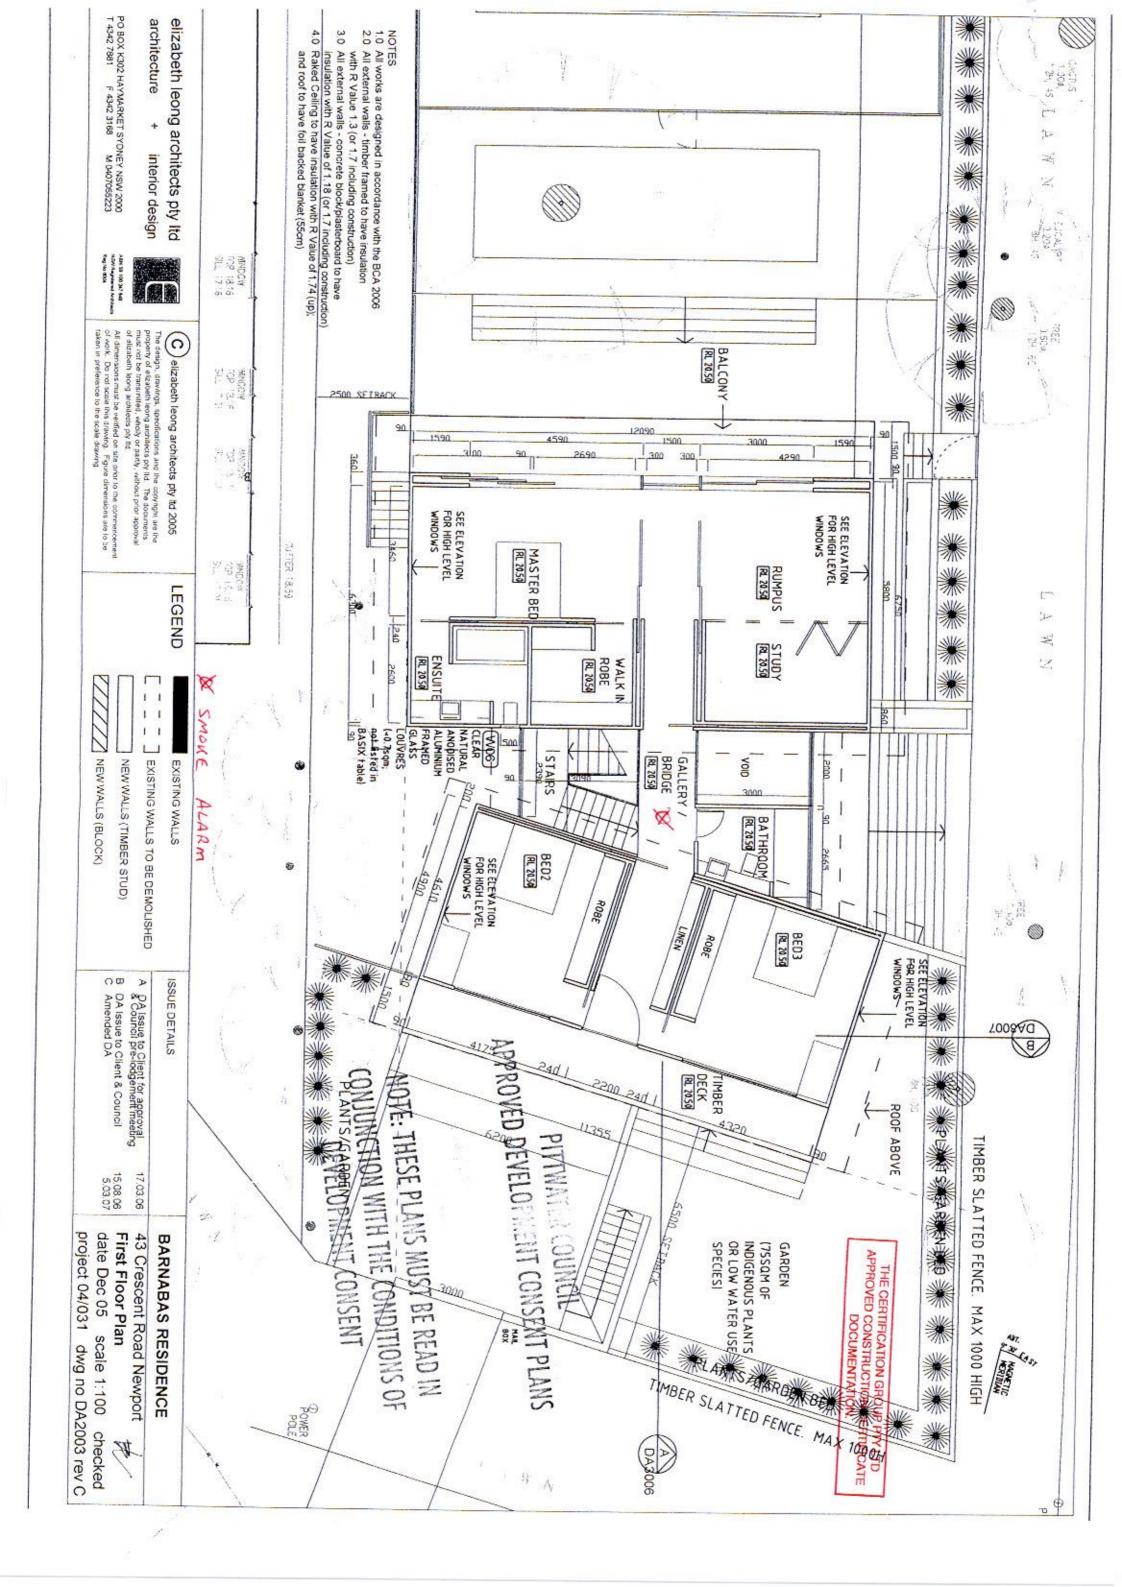APPROVED DEVELOR CONSENT PLANS



LEGEND

_ _] EXISTING WALLS TO BE DEMOLISHED

EXISTING WALLS

NEW WALLS (TIMBER STUD)

1

WINDOW NUMBER (BASIX)

G

TRANSLUCENT GLASS

NEW WALLS (BLOCK)

G

PYROLYTIC GLASS (Max U-Value: 4.48, SHGC; +/- 10% of 0.46)

NOTES
1.0 All works are designed in accordance with the BCA 2006
2.0 All external walls - timber framed to have insulation with R Value 1.3 (or 1.7 including construction)
3.0 All external walls - concrete block/plasterboard to have insulation with R Value of 1.18 (or 1.7 including construction)
4.0 Raked Ceiling to have insulation with R Value of 1.74 (up); and roof to have foil backed blanket (55cm)

elizabeth leong architects pty Itd

architecture interior design

PO BOX K302 HAYMARKET SYDNEY NSW 2000 T 4342 7881 F 4342 3168 M 0407055223

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All dimensions must be verified on site prior to the commencement of work. Do not scale this drawing. Figure dimensions are to be taken in preference to the scale drawing.

C elizabeth leong architects pty ltd 2005

B DA Issue to Client & Council C Amended DA Issue A DA Issue to Client for approval & Council pre-lodgement meeting 15,08,06 5,03,07

ISSUE DETAILS

17.03.06 BARNABAS RESIDENCE

Elevations Sheet1 43 Crescent Road Newport

THE CERTIFICATION GROUP PTY LTD APPROVED CONSTRUCTION CERTIFICATE DOCUMENTATION.



project 04/031 dwg no DA3001 rev C date Dec 05 scale 1:100 checked

Approved (stamped) architectural Construction Certificate plans take precedence over all supporting documentation in relation to any discrepancies between them

Smoke Alarms to be installed in accordance with AS 3786 -1993 'Smoke Alarms' & Part 3.7.2 'Smoke Alarms' of the Building

Termite Management to comply with AS 3660 - 2000 'Termite management - New building work

Glazing to comply with AS 1288 - 2006 'Glass in buildings - Selection & Installation' & AS 2047 - 1999 "Windows in

All external glazing is to have a maximum reflectivity index of 25%

Waterproofing of wet areas to comply with AS 3740 - 2004 'Waterproofing of wet areas in residential buildings

Doors to fully enclosed sanitary compartments to comply with Part 3.8.3 "Facilities" of the Building Code of Australia

Balustrades construction to comply with Part 3.9.2.3 - 'Balustrade' of the Building Code of Australia

Pittwater Council Approved Access Driveway Profile to be complied with

Materials and colour schemes are to be in accordance with the samples submitted to Council. No white or light coloured roofs are

Water conservation devices with a AAA rating to be installed, including tap flow regulators, shower head roses and dual flush toilets. All new hot water systems are to have a minimum rating of 3.5 stars

Pool fencing to be designed and located and maintained in accordance with the Swimming Pool Act 1972, and AS 1926.1

All plumbing and drainage fixtures are to be concealed and not exposed to public view on buildings over one storey in height

Building to incorporate BASIX commitments to comply with the BASIX Certificate No 69083S dated 15/08/06 (Note: Shading

Compliance with the colour schedule

Rainwater & Stormwater Tanks to be below ground

FINISH

LEGEND 1 1 G PYROLYTIC GLASS (Max U-Value : 4.48, SHGC: +/- 10% of 0.46) EXISTING WALLS NEW WALLS (BLOCK) EXISTING WALLS TO BE DEMOLISHED WINDOW NUMBER (BASIX) NEW WALLS (TIMBER STUD) TRANSLUCENT GLASS

HNISH

- NOTES
 1.0 All works are designed in accordance with the BCA 2006
 2.0 All external walls timber framed to have insulation with R Value 1.3 (or 1.7 including construction)
- All external walls concrete block/plasterboard to have insulation with R Value of 1.18 (or 1.7 including construction)
 Raked Ceiling to have insulation with R Value of 1.74 (up);
- and roof to have foil backed blanket (55cm)


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PITTE



SOUTH ELEVATION

THE CERTIFICATION GROUP PTY LTD APPROVED CONSTRUCTION CERTIFICATE DOCUMENTATION.

B DA Issue to Client & Council	A DA Issue to Client for approval & Council prelodgement meeting	ISSUE DETAILS
15.08.06	17.03.06	
date Dec 05 scale 1:100	43 Crescent Road Newport	BARNABAS RESIDENCE
checked	4_	

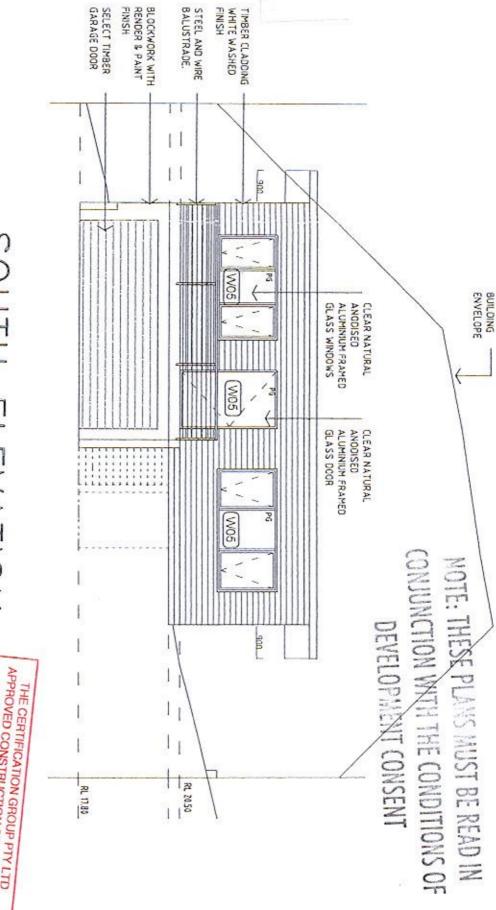project 04/031 dwg no DA3002 rev B

