1803-1803A PITTWATER ROAD, MONA VALE, NSW 2103

RESIDENTIAL FLAT BUILDING DA SUBMISSION



DRAWING	SLIST
DA-000	COVER AND REGISTER
DA-011	SITE PLAN - DEMOLITION
DA-012	SITE PLAN - PROPOSED
DA-101	GENERAL ARRANGEMENT PLAN - BASEMENT LEVEL
DA-102	GENERAL ARRANGEMENT PLAN - BASEMENT LEVEL
DA-103	GENERAL ARRANGEMENT PLAN - GROUND
DA-104	GENERAL ARRANGEMENT PLAN - LEVEL 1
A-105	GENERAL ARRANGEMENT PLAN - LEVEL 2
DA-106	GENERAL ARRANGEMENT PLAN - LEVEL 3
A-107	GENERAL ARRANGEMENT PLAN - LEVEL 4
DA-108	GENERAL ARRANGEMENT PLAN - LEVEL 5
DA-109	GENERAL ARRANGEMENT PLAN - ROOF
DA-201	EAST ELEVATION - PITTWATER ROAD
DA-202	NORTH ELEVATION
DA-203	WEST ELEVATION
DA-204	SOUTH EAST ELEVATION
DA-301	BUILDING SECTION
DA-302	BUILDING SECTION
DA-303	BUILDING SECTION
DA-700	ADG COMPLIANCE DIAGRAMS - B2
DA-701	ADG COMPLIANCE DIAGRAMS - GROUND LEVEL
DA-702	ADG COMPLIANCE DIAGRAMS - LEVEL 1
DA-703	ADG COMPLIANCE DIAGRAMS - LEVEL 2-3
DA-704	ADG COMPLIANCE DIAGRAMS - LEVEL 4
DA-705	ADG COMPLIANCE DIAGRAMS - LEVEL 5
DA-901	SHADOW DIAGRAMS
DA-902	SHADOW DIAGRAMS
DA-903	SHADOW DIAGRAMS
DA-904	SHADOW DIAGRAMS

TE AREA		GROSS FLOOI	R AREA
ΓΕ AREA 1560 m²			
		Ground Floor	525 m ²
	LEVEL 1	504 m²	
		LEVEL 2	504 m²
	LEVEL 3	504 m ²	
	LEVEL 4	366 m²	
	LEVEL 5	354 m²	
			2756 m ²

FSR TOTAL 1.77 : 1

Nathers Thermal Comport Inclusions

Glazing Doors/Windows
Awning U-value: 4.80 (equal to or lower than) SHGC: 0.51 (±5%)
Fixed U-value: 4.80 (equal to or lower than) SHGC: 0.59(±5%)
Sliding Door U-value: 4.80 (equal to or lower than) SHGC: 0.59 (±5%)
Louvres U-value: 4.80 (equal to or lower than) SHGC: 0.59 (±5%)

Sliding Door U-value: 3.20 (equal to or lower than) SHGC: 0.49 (±5%)

Upgrade applied as per thermal comfort upgrades table (no upgrade to louvre windows) Awning U-value: 3.20 (equal to or lower than) SHGC: 0.46 (±5%) Fixed U-value: 3.20 (equal to or lower than) SHGC: 0.49 (±5%)

Given values are AFRC total window system values (glass and frame) Note: BASIX Thermal Comfort Protocol Table 1 SHGC value of the unit should be within the range specified on the Assessor Certificate.

Roof and ceiling
Concrete roof, no insulation above
Plasterboard ceiling with R2.0 insulation (insulation only value) to soffit of concrete where roof and/or balcony is over Plasterboard ceiling, no insulation where neighbouring units are above

Upgrade applied as per thermal comfort upgrades tablePlasterboard ceiling with R4.0 insulation (insulation only value) to soffit of concrete where roof

External Colour

Ceiling Penetrations
Sealed LED downlights at a maximum of one every 5.0m2. Once lighting plan has been developed NatHERS certificate can be updated to improve specification.

200mm concrete, metal stud and plasterboard lining, with a minimum R2.5 insulation (insulation Any concrete columns within the external wall envelope are assumed to have the same R2.5

External Colour

Default colour modelled

Double steel stud walls between units, R1.5 each side Minimum 150mm concrete with furring channel and plasterboard lining to all walls adjacent to lift

stairs. No insulation required Thermal break applied as per NCC 2022 requirements.

Thermal break applied as per NCC 2022 requirements.

Walls within dwellings Plasterboard on studs – no insulation

Concrete with a minimum R1.0 subfloor insulation (insulation only value) required to units with

Concrete between levels, no insulation required

Floor coverings
Tiles to bathrooms and laundry, timber elsewhere

External Shading Shading as per stamped documentation

Builders / Contractors shall verify all dimensions before any work commences. Dimensions shown are nominal. Figured dimensions shall take precedence over scaled dimensions. Any discrepancies are to be made known to the Architects / Designers studio prior to any works commencing on site. All shop drawings shall be submitted for review and manufacture shall not commence prior to the return of stamped shop drawings. Drawings issued subject to the approval of the relevant building surveyor.

STUDIO MCCUE PTY LTD retains copyright and moral rights to this drawing and ideas therein. It cannot be reproduces or copied in any form or by any means without the written permission of STUDIO MCCUE PTY LTD.

NOTES



9/10/2025 COORDINATION PRE-DA ISSUE 6/8/2025 B 16/07/2025 PRE-DA ISSUE



DA SUBMISSION


MCCUE

MVE

1803 - 1803A PITTWATER ROAD, MONA VALE, NSW 2103

COVER AND REGISTER

DWg No DA-000		
Rev	Project No	
E	25004	
Scale @ A1	Drawn By JC	Checked By

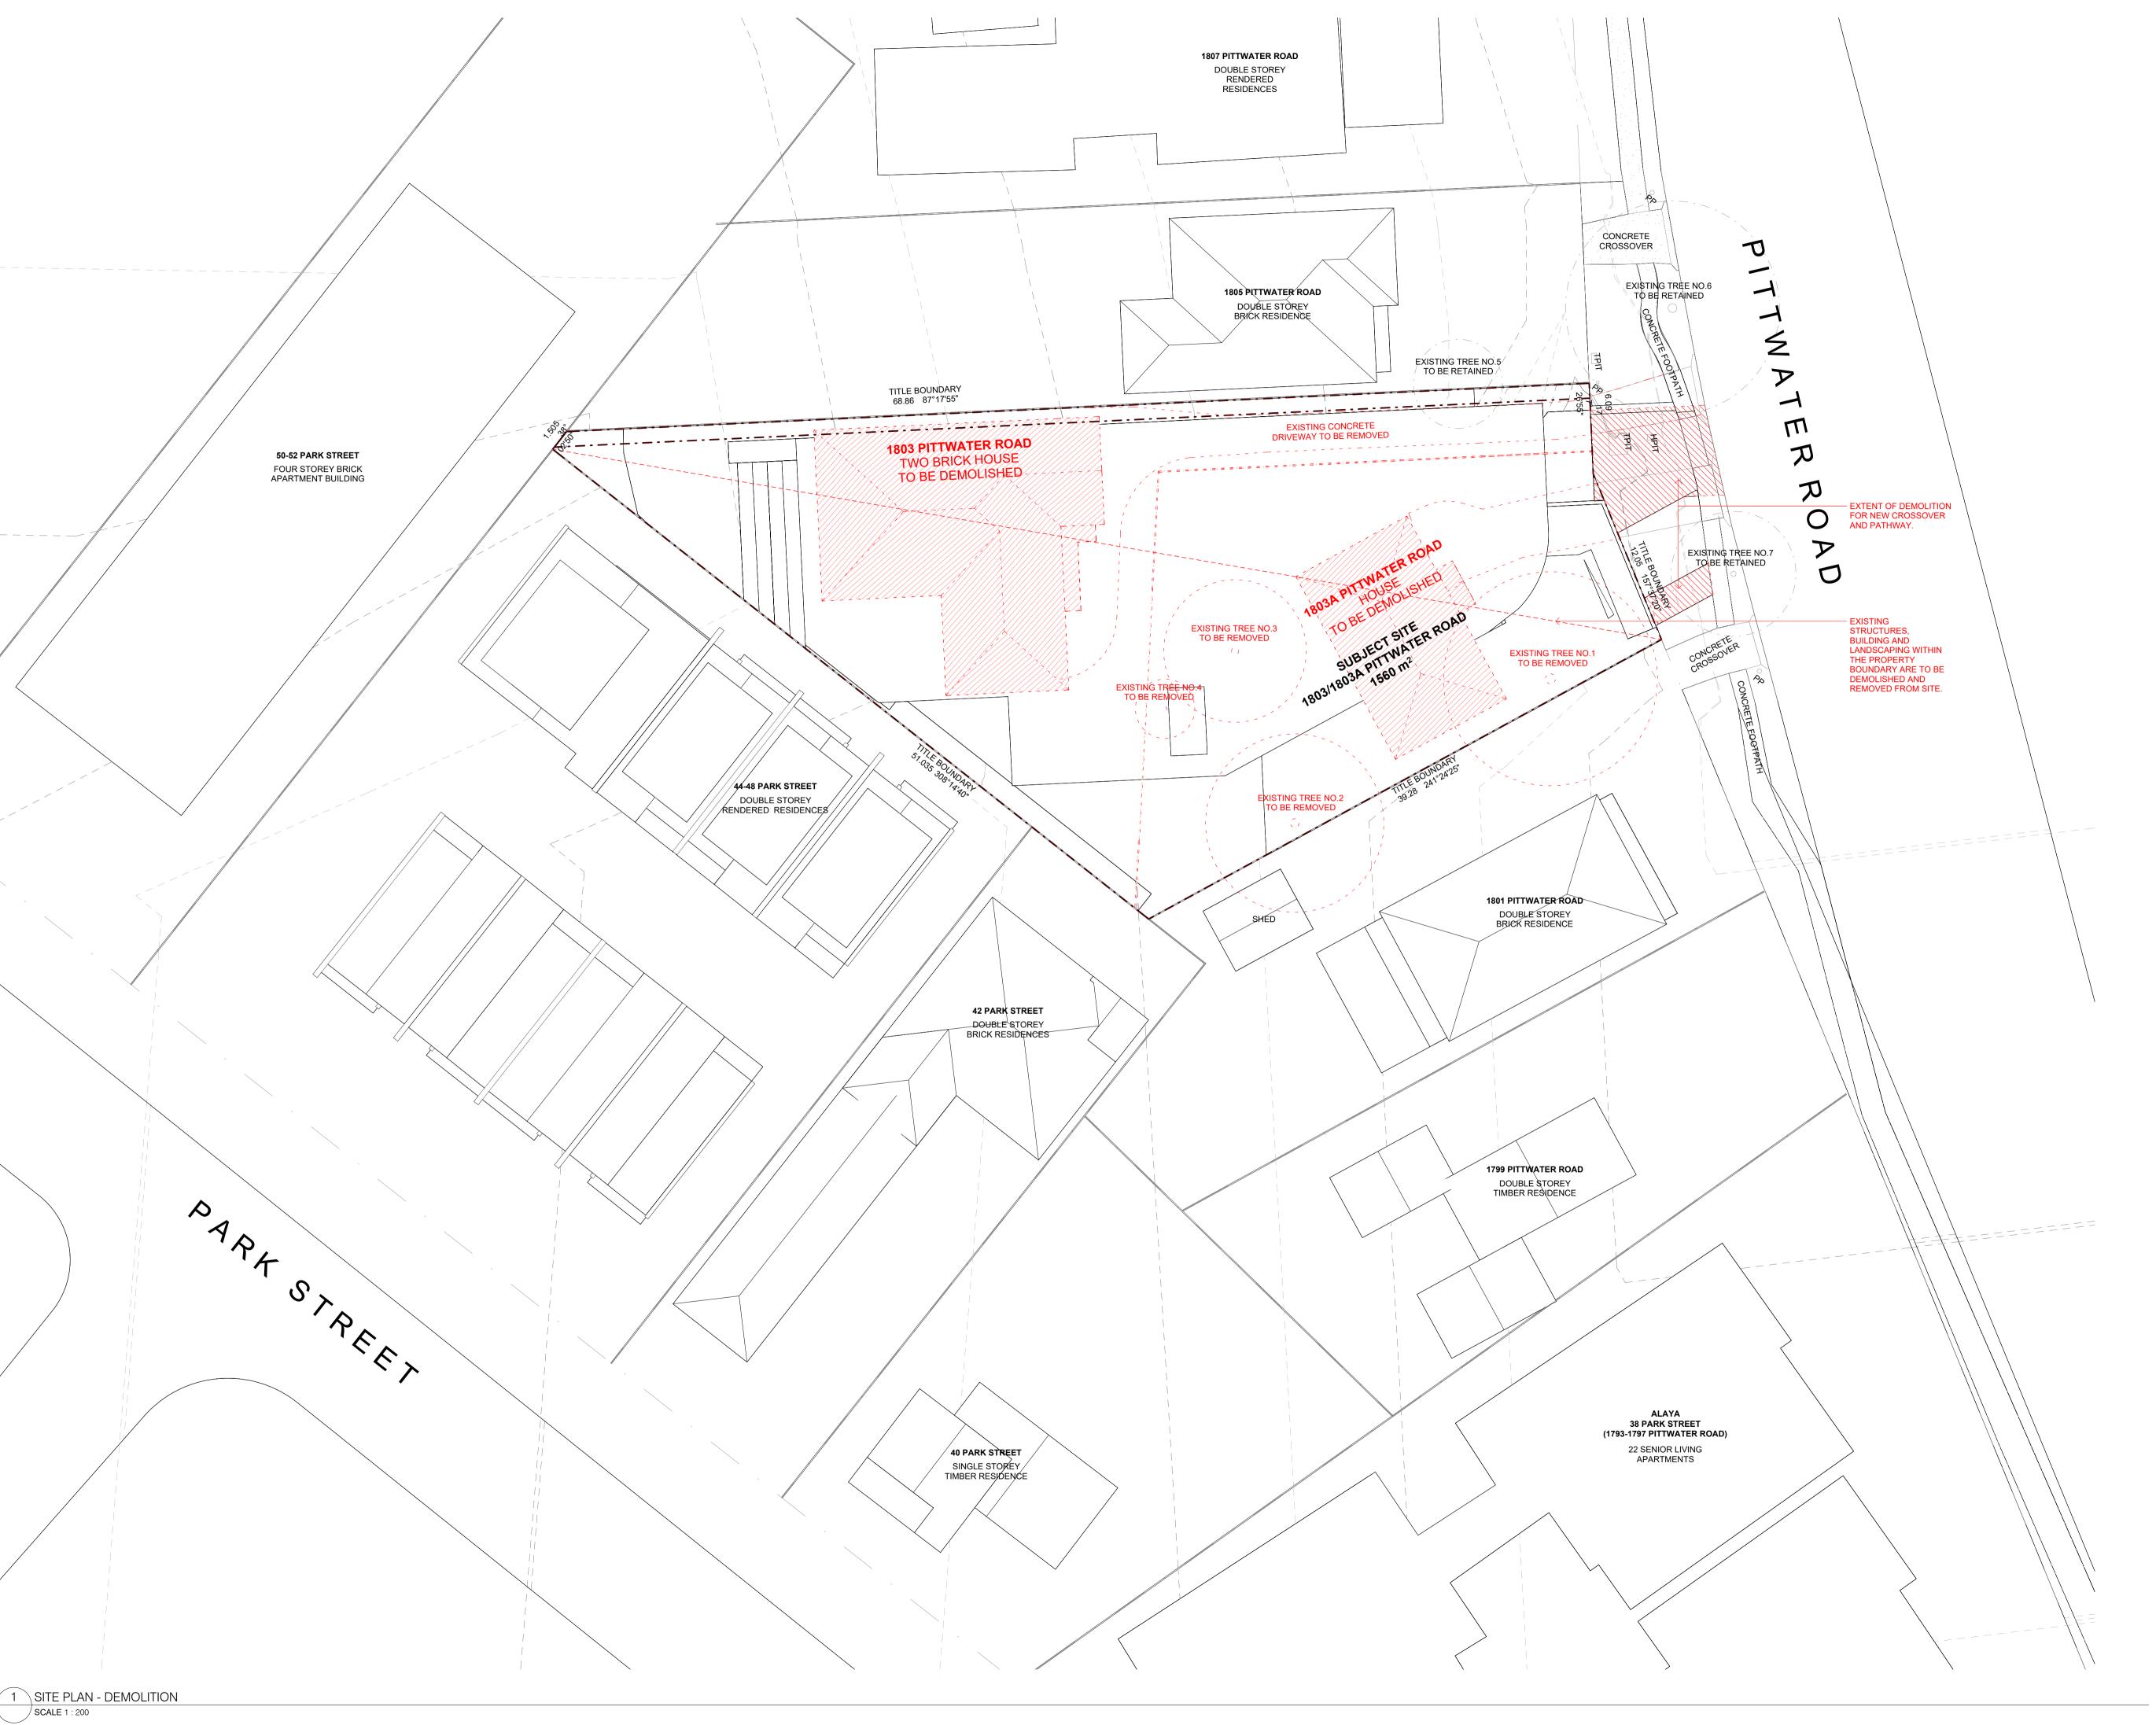

STUDIO MCCUE PTY LTD retains copyright and moral rights to this drawing and ideas therein. It cannot be reproduces or copied in any form or by any means without the written permission of STUDIO MCCUE PTY LTD.


NOTES

LEGEND

TITLE BOUNDARY



EXTENT OF DEMOLITION WORKS

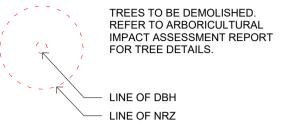

DEMOLITION NOTES

- 1. FFL, RL AND NGL LEVELS SHOWN ARE IN METERS TO
- 2. DRAWINGS TO BE READ IN CONJUNCTION WITH CONSULTANT REPORTS INCLUDING:

 LAND SURVEY
- TRAFFIC & PARKING REPORT CONSTRUCTION & DEMOLITION WASTE
- MANAGEMENT PLAN ARBORICULTURAL IMPACT ASSESSMENT REPORT
- ACCESS REPORT BCA REPORT CIVIL ENGINEER'S REPORTS
- LANDSCAPE ARCHITECT'S REPORT 3. WORKS TO ASSETS BEYOND THE PROPERTY
- BOUNDARY ARE TO BE TO THE REQUIREMENTS OF THE RELEVANT AUTHORITY. SITE DEMOLITION TO BE UNDERTAKEN TO THE REQUIREMENTS OF THE CONSTRUCTION &
- DEMOLITION WASTE MANAGEMENT PLAN. REMOVE ALL DEMOLISHED STRUCTURES FROM SITE.



9/10/2025 COORDINATION 16/07/2025 PRE-DA ISSUE PRE DA DRAFT ISSUE 09/07/2025



MCCUE

As indicated


MVE

1803 - 1803A PITTWATER ROAD, MONA VALE, NSW 2103

SITE PLAN - DEMOLITION

Dwg No DA-011 25004 Drawn By

PD

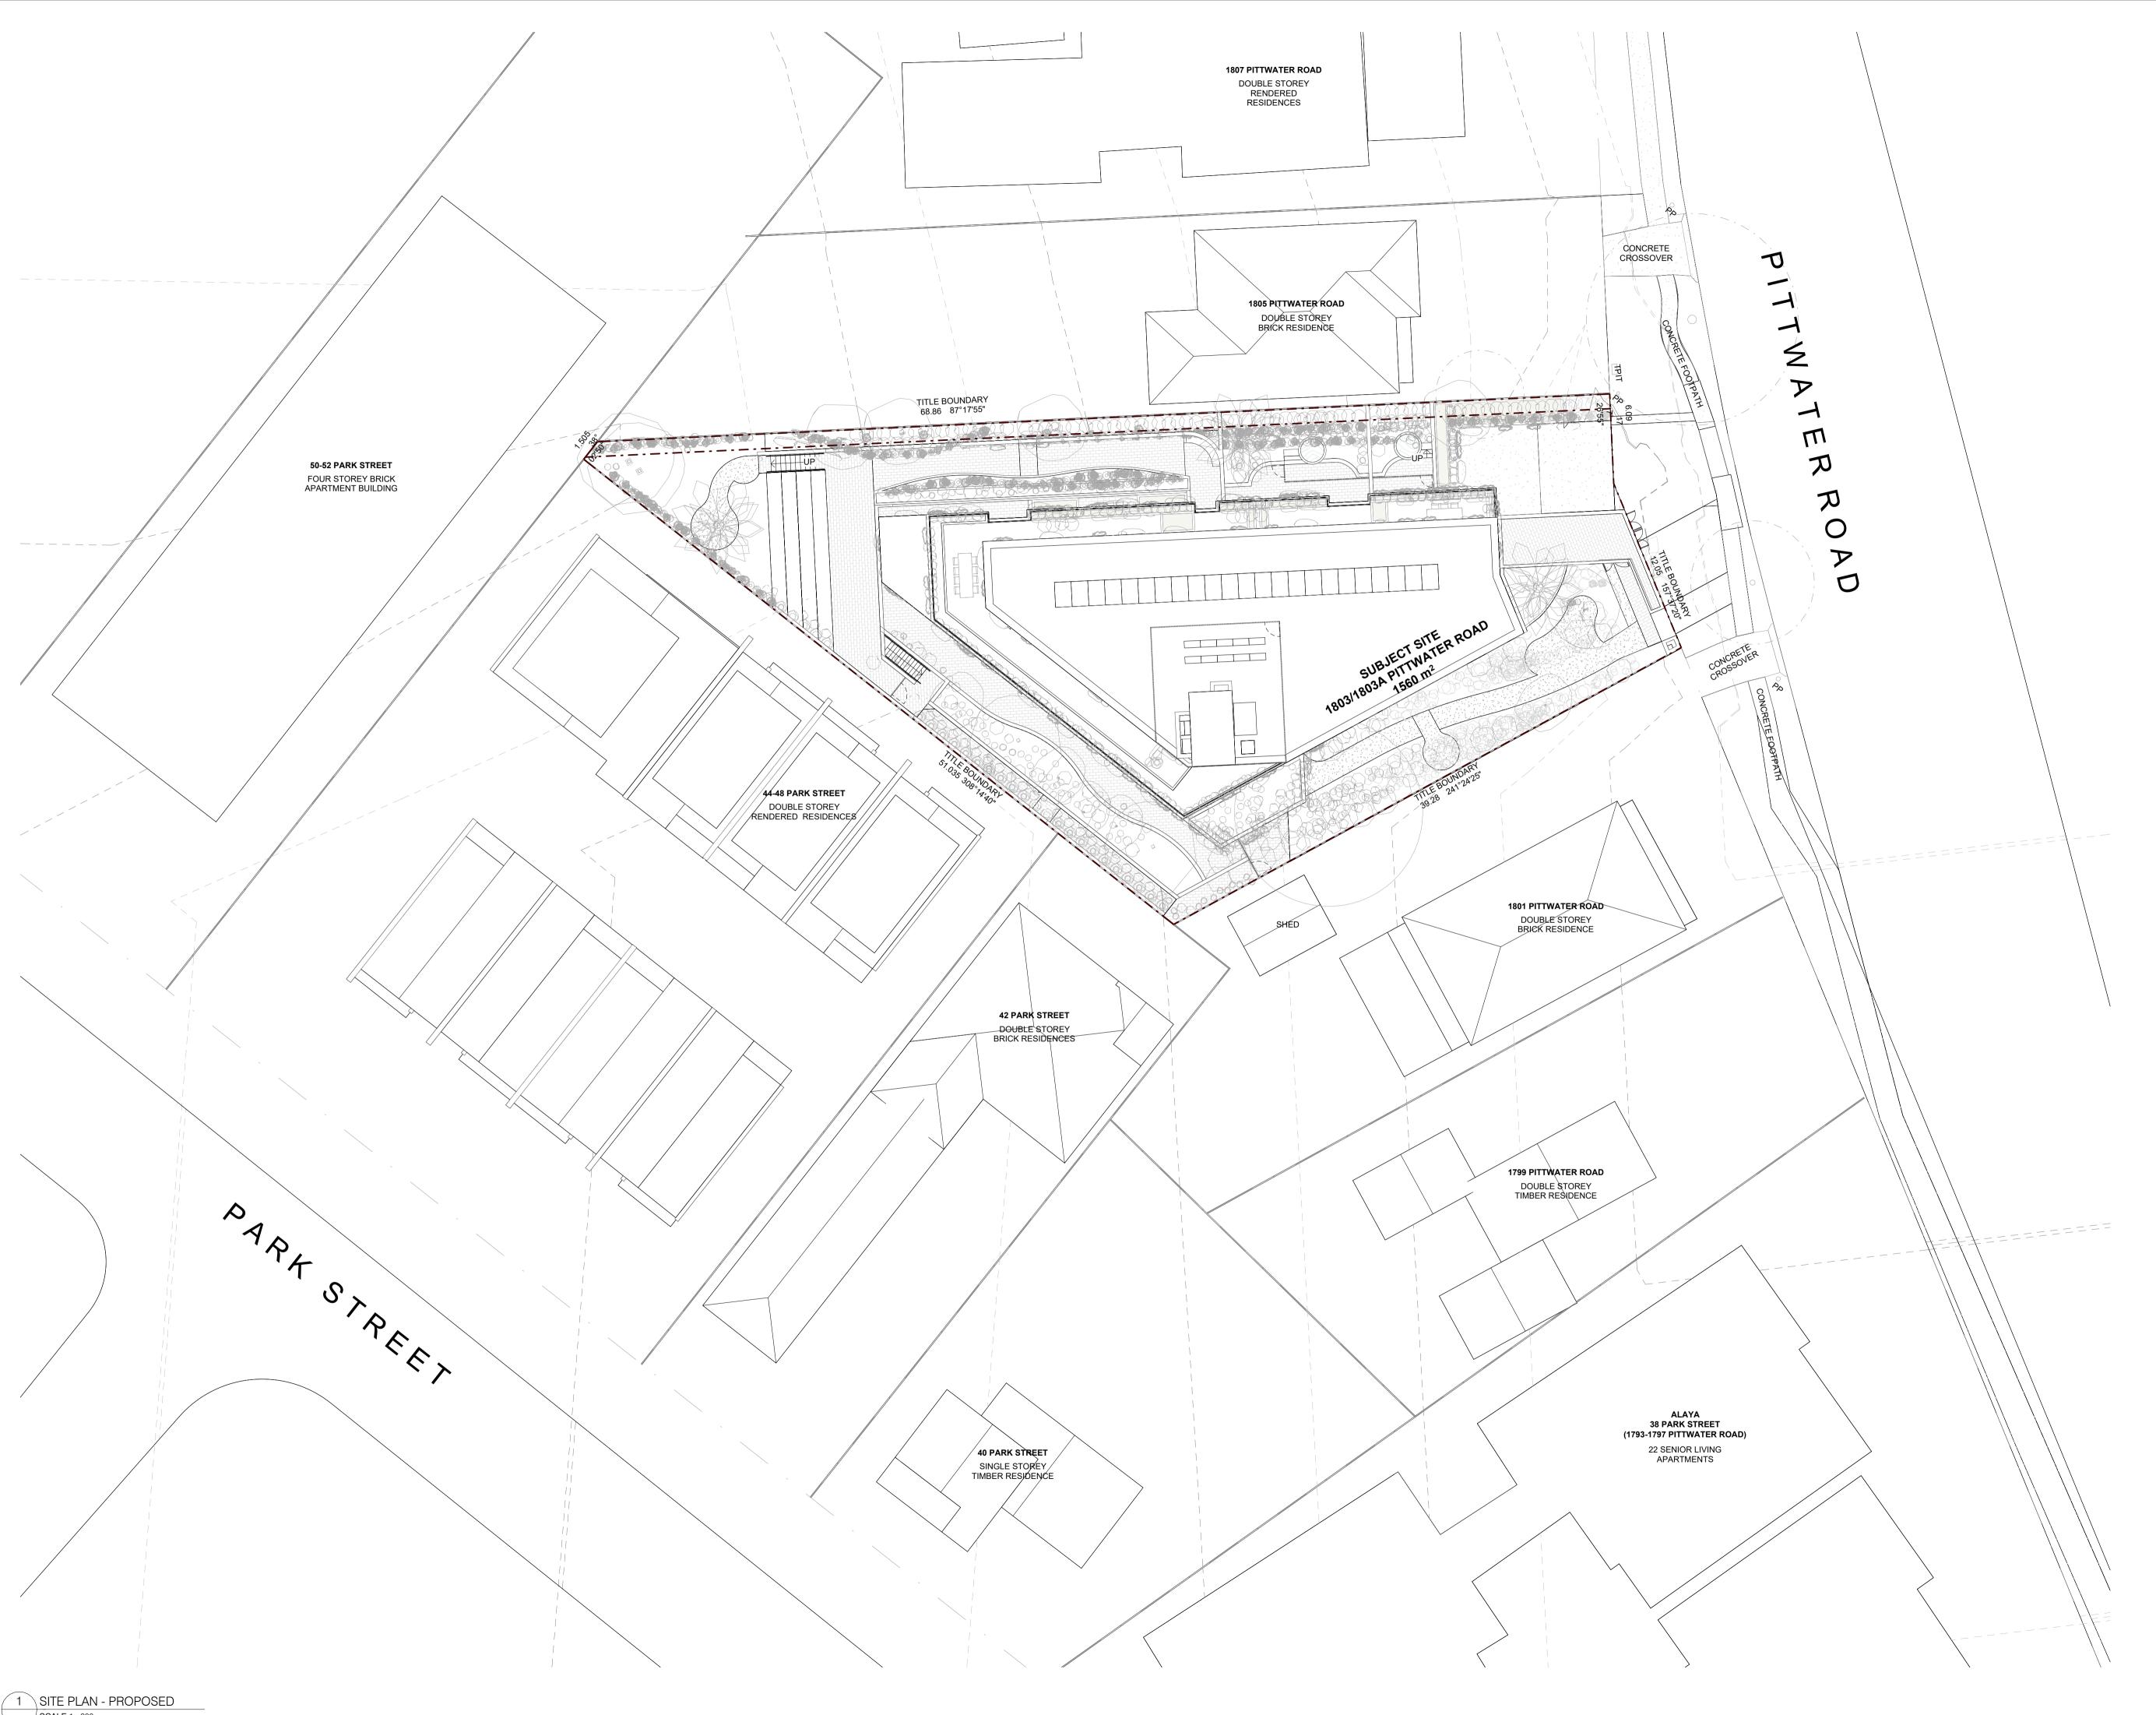

STUDIO MCCUE PTY LTD retains copyright and moral rights to this drawing and ideas therein. It cannot be reproduces or copied in any form or by any means without the written permission of STUDIO MCCUE PTY LTD.

NOTES

LEGEND

TITLE BOUNDARY

GENERAL NOTE

- 1. FFL, RL AND NGL LEVELS SHOWN ARE IN METERS
- DRAWINGS TO BE READ IN CONJUNCTION WITH CONSULTANT REPORTS INCLUDING:
 LAND SURVEY
- TRAFFIC & PARKING REPORT
 CONSTRUCTION & DEMOLITION WASTE
- MANAGEMENT PLAN

 ARBORICULTURAL IMPACT ASSESSMENT

- ARBORICOLTURAL IMPACT ASSESSMENT REPORT
 ACCESS REPORT
 BCA REPORT
 CIVIL ENGINEER'S REPORTS
 LANDSCAPE ARCHITECT'S REPORT

 3. WORKS TO ASSETS BEYOND THE PROPERTY

 ROLLINDARY ARE TO BE TO THE PEOLINEMENTS BOUNDARY ARE TO BE TO THE REQUIREMENTS OF
- THE RELEVANT AUTHORITY. 4. LANDSCAPE LAYOUT SHOWN INDICATIVELY. REFER TO LANDSCAPE ARCHITECTURE DRAWINGS FOR DETAIL. PLANTER BOXES TO BE CONNECTED
- TO IRRIGATION SYSTEM. 5. ALL SERVICES TO BE ELECTRIC.6. RAINWATER TANK TO BE CONNECTED TO
- IRRIGATION SYSTEM.
- 7. ALL FIXTURES AND APPLIANCES TO BE WATER
- 7. ALL FIXTURES AND APPLIANCES TO BE WATER EFFICIENT.
 8. BUILDING ENVELOPE TO MEET THE REQUIREMENTS OF THE BASIX REPORT. DOUBLE

GLAZING TO ALL WINDOWS AND GLAZED DOORS.



PRE-DA ISSUE 6/8/2025 16/07/2025 PRE-DA ISSUE PRE DA DRAFT ISSUE

DA SUBMISSION


MCCUE

MVE

1803 - 1803A PITTWATER ROAD, MONA VALE, NSW 2103

SITE PLAN - PROPOSED

Dwg No		
DA-012		
Rev	Project No	
D	25004	
Scale @ A1	Drawn By	Checked By
As indicated	JC PD	CM

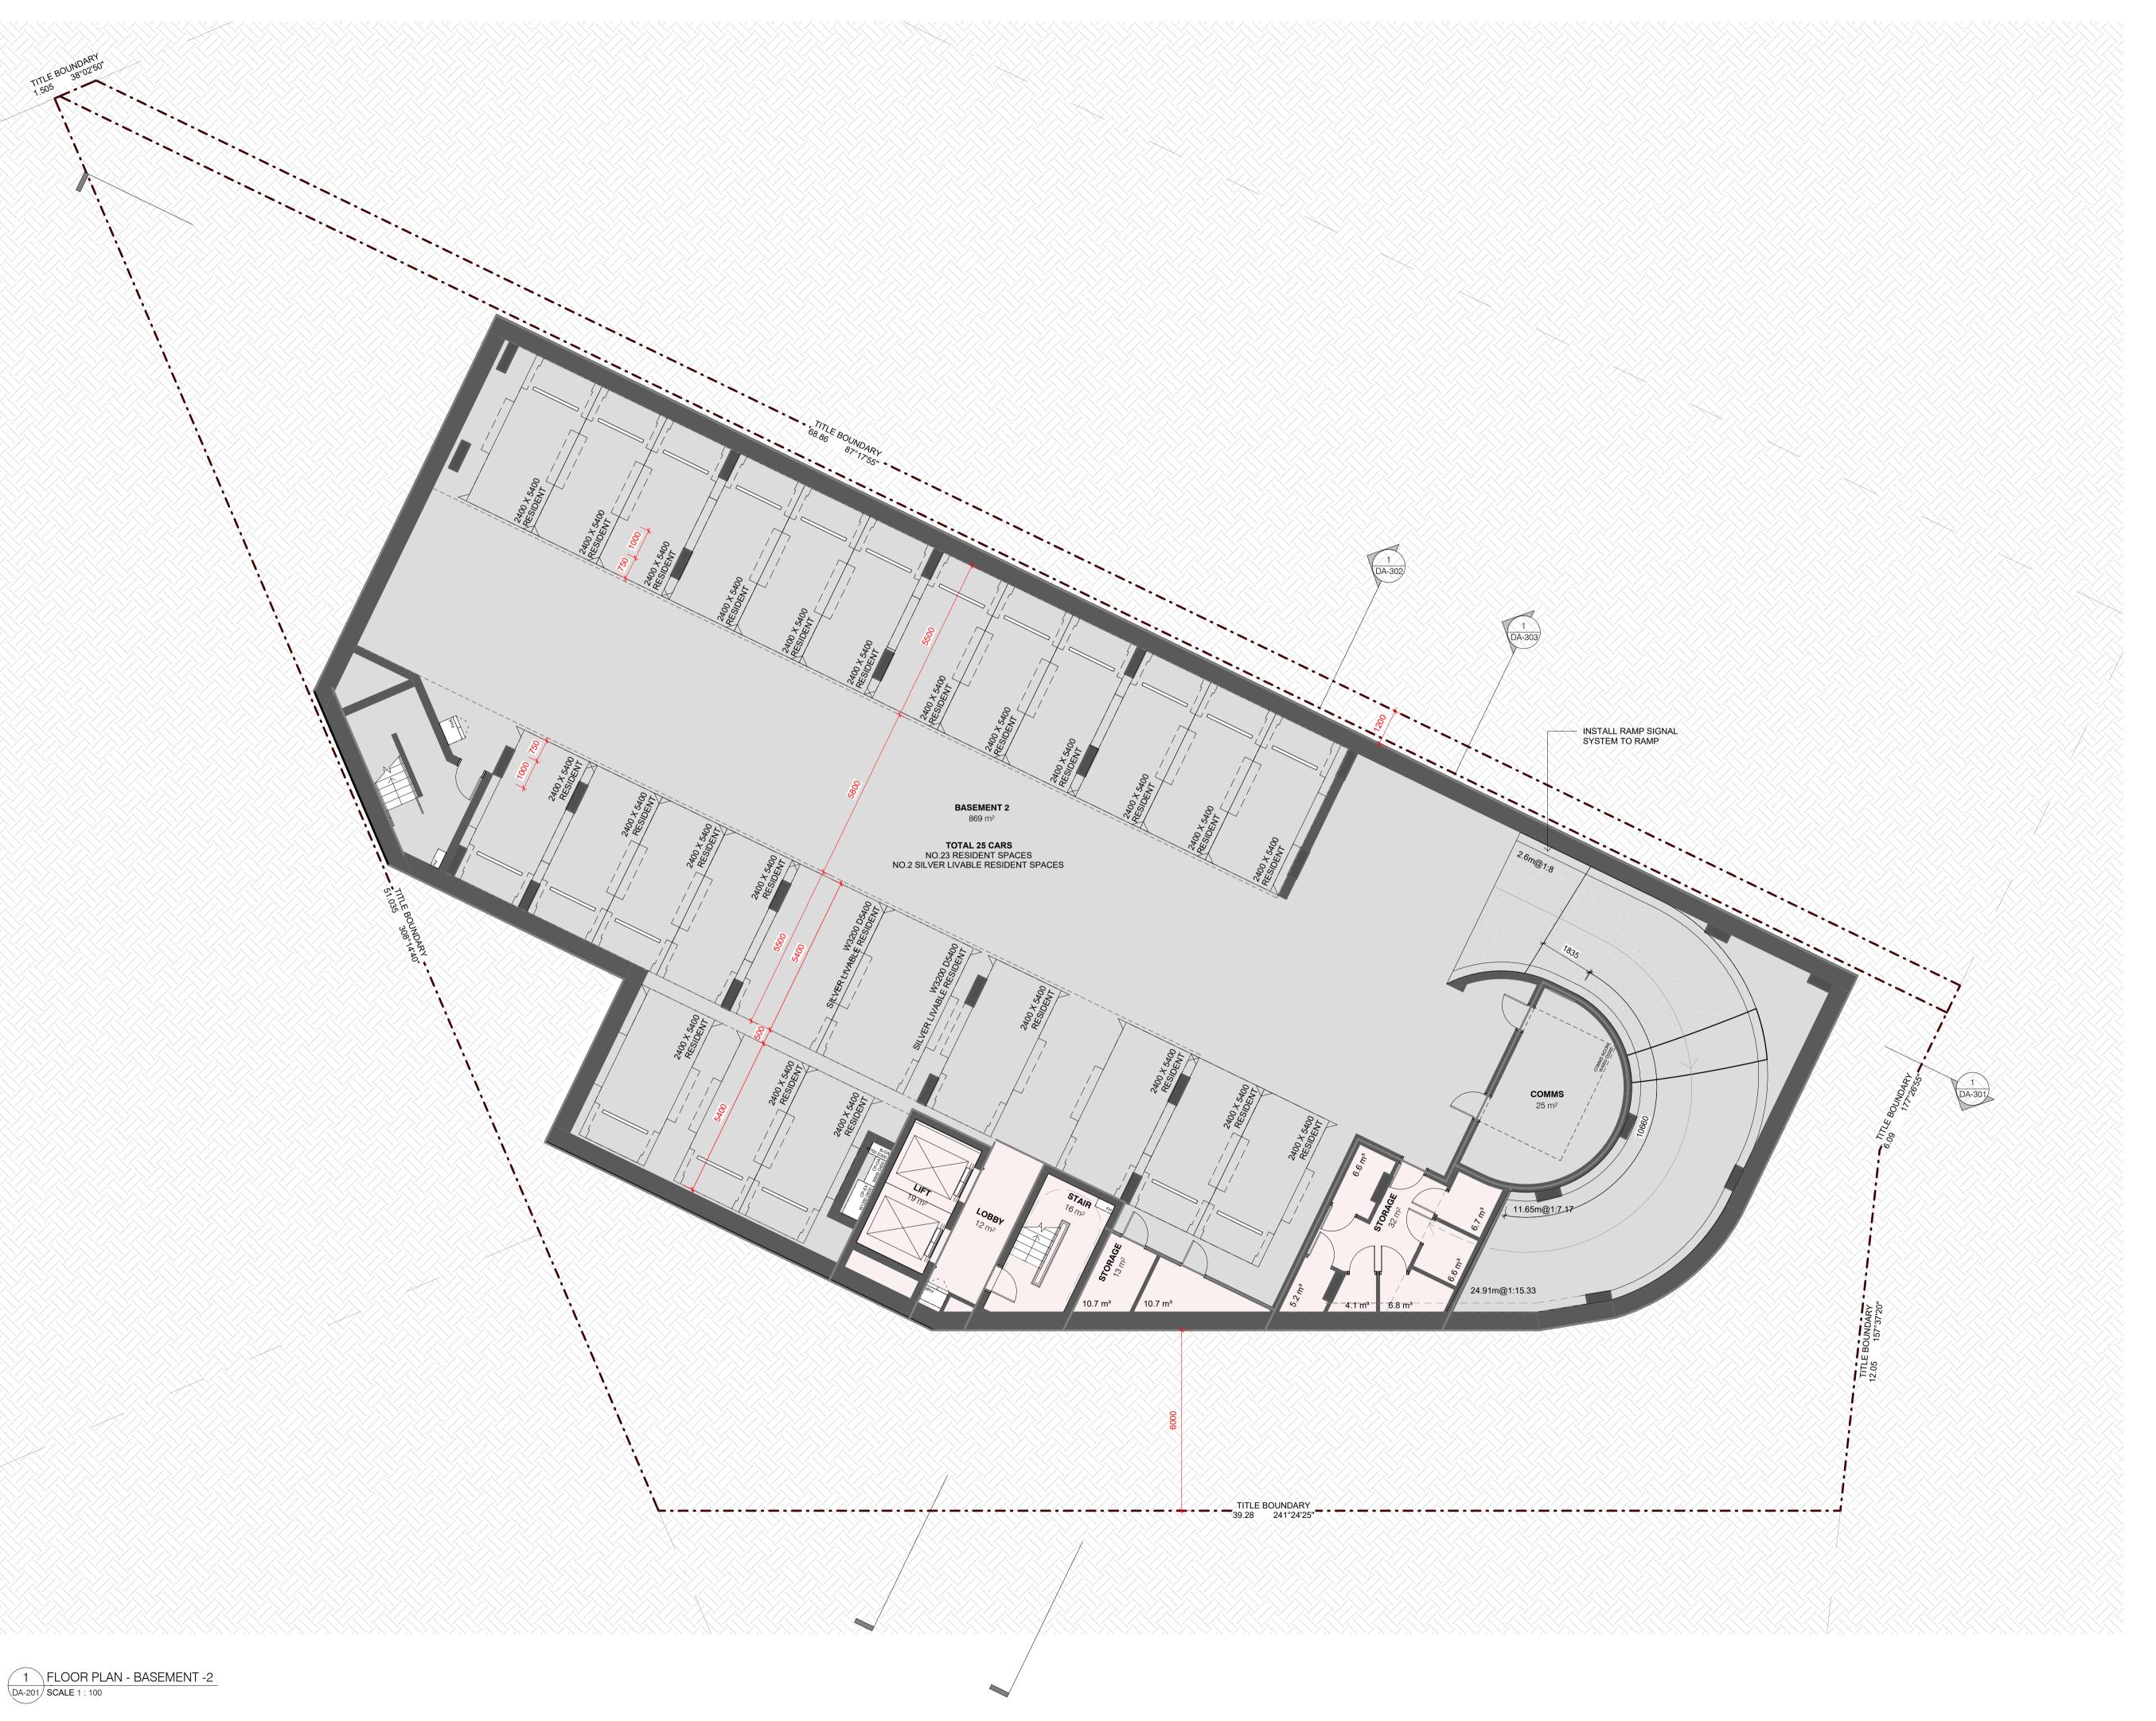

STUDIO MCCUE PTY LTD retains copyright and moral rights to this drawing and ideas therein. It cannot be reproduces or copied in any form or by any means without the written permission of STUDIO MCCUE PTY LTD.

NOTES


LEGEND

TITLE BOUNDARY

GENERAL NOTE

- 1. FFL, RL AND NGL LEVELS SHOWN ARE IN METERS
- DRAWINGS TO BE READ IN CONJUNCTION WITH CONSULTANT REPORTS INCLUDING:
 LAND SURVEY

- LAND SURVEY
 TRAFFIC & PARKING REPORT
 CONSTRUCTION & DEMOLITION WASTE MANAGEMENT PLAN
 ARBORICULTURAL IMPACT ASSESSMENT REPORT
 ACCESS REPORT
 BCA REPORT
 CIVIL ENGINEER'S REPORTS
 LANDSCAPE ARCHITECT'S REPORT
 WORKS TO ASSETS BEYOND THE PROPERTY BOUNDARY ARE TO BE TO THE REQUIREMENTS OF THE RELEVANT AUTHORITY.
- THE RELEVANT AUTHORITY. 4. LANDSCAPE LAYOUT SHOWN INDICATIVELY. REFER TO LANDSCAPE ARCHITECTURE DRAWINGS
- FOR DETAIL. PLANTER BOXES TO BE CONNECTED TO IRRIGATION SYSTEM.
- 5. ALL SERVICES TO BE ELECTRIC.
 6. RAINWATER TANK TO BE CONNECTED TO IRRIGATION SYSTEM.
- 7. ALL FIXTURES AND APPLIANCES TO BE WATER
- ALL FIXTURES AND APPLIANCES TO BE WATER EFFICIENT.
 BUILDING ENVELOPE TO MEET THE REQUIREMENTS OF THE BASIX REPORT. DOUBLE GLAZING TO ALL WINDOWS AND GLAZED DOORS.

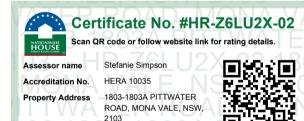

9/10/2025 COORDINATION 6/8/2025 PRE-DA ISSUE

PRE-DA ISSUE B 16/07/2025




MCCUE

MVE

1803 - 1803A PITTWATER ROAD, MONA VALE, NSW 2103

GENERAL ARRANGEMENT PLAN - BASEMENT LEVEL 2

Dwg No		
DA-101		
Rev	Project No	
E	25004	
Scale @ A1	Drawn By	Checked By
1 · 100	JC	CM

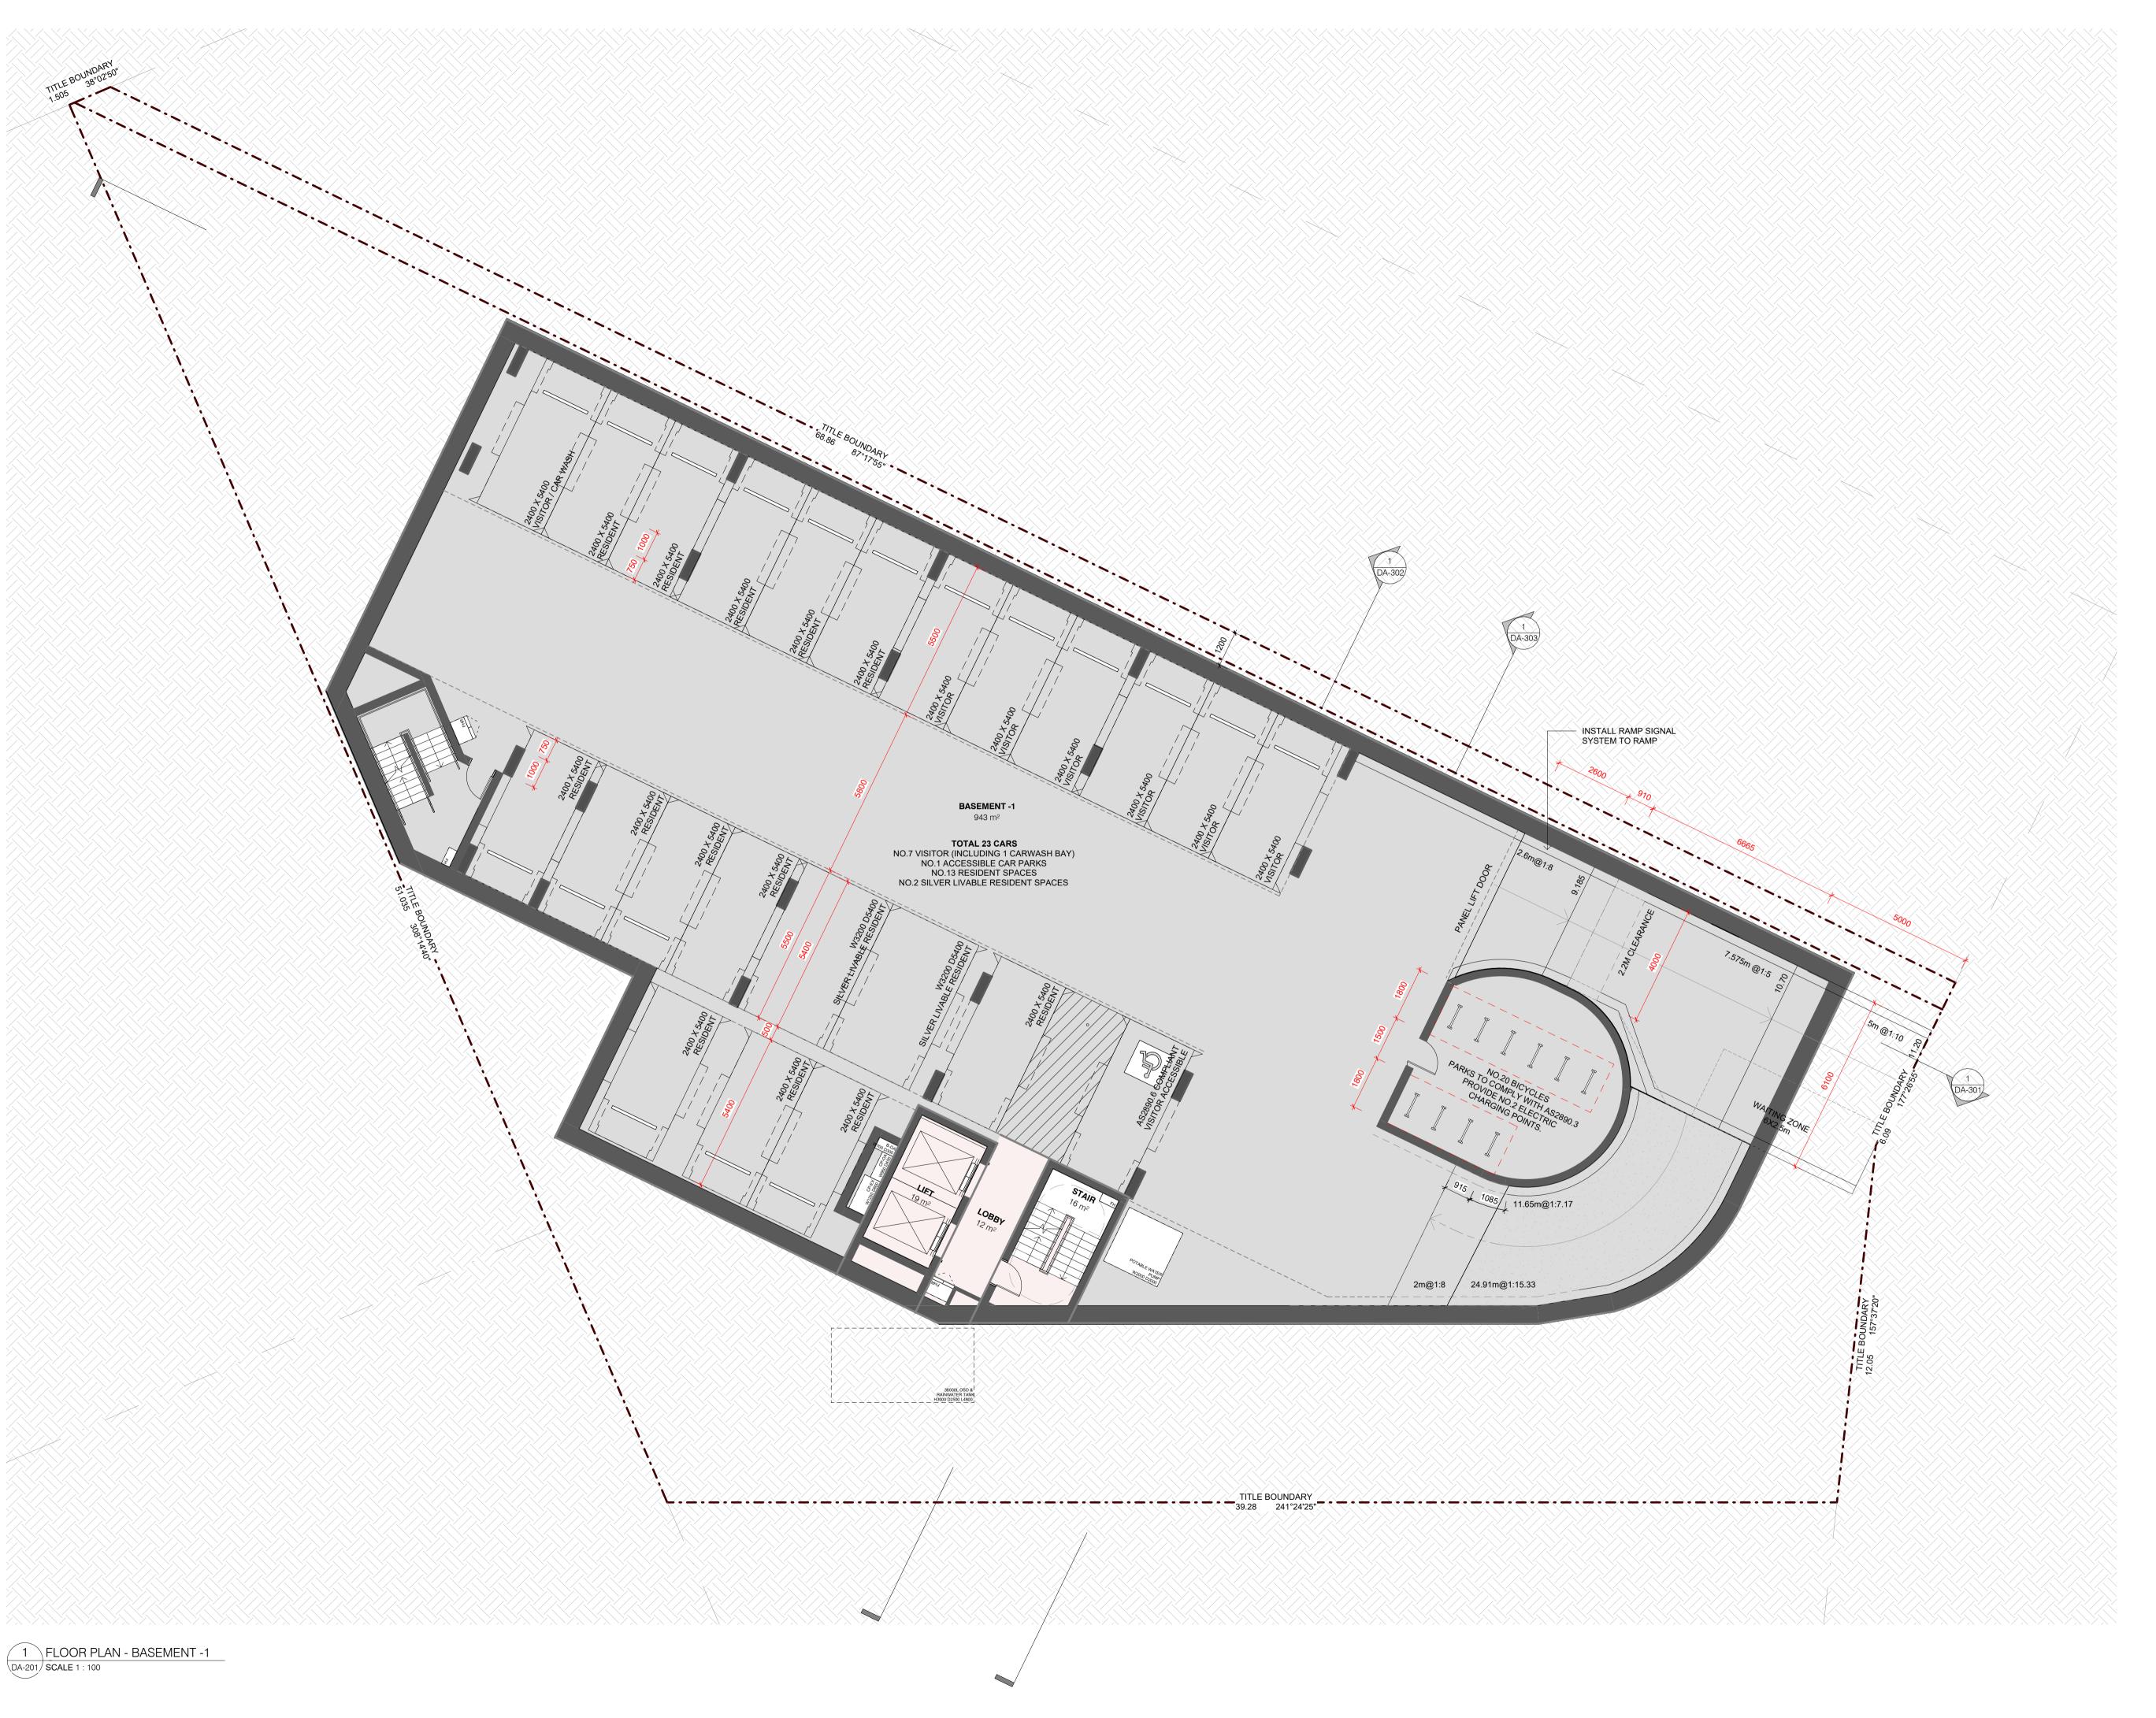

Builders / Contractors shall verify all dimensions before any work commences. Dimensions shown are nominal. any work commences. Dimensions snown are nominal.

Figured dimensions shall take precedence over scaled dimensions. Any discrepancies are to be made known to the Architects / Designers studio prior to any works commencing on site. All shop drawings shall be submitted for review and manufacture shall not commence prior to the setum of attention of the setum of the setum of attention of the setum of the set the return of stamped shop drawings. Drawings issued subject to the approval of the relevant building surveyor.

STUDIO MCCUE PTY LTD retains copyright and moral rights to this drawing and ideas therein. It cannot be reproduces or copied in any form or by any means without the written permission of STUDIO MCCUE PTY LTD.

NOTES

LEGEND TITLE BOUNDARY


GENERAL NOTE

- 1. FFL, RL AND NGL LEVELS SHOWN ARE IN METERS
- DRAWINGS TO BE READ IN CONJUNCTION WITH CONSULTANT REPORTS INCLUDING:
 LAND SURVEY

- LAND SURVEY
 TRAFFIC & PARKING REPORT
 CONSTRUCTION & DEMOLITION WASTE MANAGEMENT PLAN
 ARBORICULTURAL IMPACT ASSESSMENT REPORT
 ACCESS REPORT
 BCA REPORT
 CIVIL ENGINEER'S REPORTS
 LANDSCAPE ARCHITECT'S REPORT
 WORKS TO ASSETS BEYOND THE PROPERTY BOUNDARY ARE TO BE TO THE REQUIREMENTS
- BOUNDARY ARE TO BE TO THE REQUIREMENTS OF THE RELEVANT AUTHORITY. 4. LANDSCAPE LAYOUT SHOWN INDICATIVELY.
- REFER TO LANDSCAPE ARCHITECTURE DRAWINGS FOR DETAIL. PLANTER BOXES TO BE CONNECTED TO IRRIGATION SYSTEM.
- 5. ALL SERVICES TO BE ELECTRIC.
 6. RAINWATER TANK TO BE CONNECTED TO
- IRRIGATION SYSTEM.
- 7. ALL FIXTURES AND APPLIANCES TO BE WATER
- ALL FIXTURES AND APPLIANCES TO BE WATER EFFICIENT.
 BUILDING ENVELOPE TO MEET THE REQUIREMENTS OF THE BASIX REPORT. DOUBLE GLAZING TO ALL WINDOWS AND GLAZED DOORS.



COORDINATION 9/10/2025 6/8/2025 PRE-DA ISSUE PRE-DA ISSUE B 16/07/2025

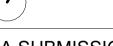

DA SUBMISSION

MCCUE

MVE

1803 - 1803A PITTWATER ROAD, MONA VALE, NSW 2103

GENERAL ARRANGEMENT PLAN - BASEMENT LEVEL 1

Project No	
25004	
Drawn By	Checked By
JC	СМ
	25004 Drawn By



STUDIO MCCUE PTY LTD retains copyright and moral rights to this drawing and ideas therein. It cannot be reproduces or copied in any form or by any means without the written permission of STUDIO MCCUE PTY LTD.

NOTES

LEGEND

TITLE BOUNDARY

GENERAL NOTE

- 1. FFL, RL AND NGL LEVELS SHOWN ARE IN METERS
- DRAWINGS TO BE READ IN CONJUNCTION WITH CONSULTANT REPORTS INCLUDING:
- LAND SURVEY
- TRAFFIC & PARKING REPORT
 CONSTRUCTION & DEMOLITION WASTE
- MANAGEMENT PLAN

 ARBORICULTURAL IMPACT ASSESSMENT

- ARBORICOLTURAL IMPACT ASSESSMENT REPORT
 ACCESS REPORT
 BCA REPORT
 CIVIL ENGINEER'S REPORTS
 LANDSCAPE ARCHITECT'S REPORT

 3. WORKS TO ASSETS BEYOND THE PROPERTY

 ROLLINDARY ARE TO BE TO THE PEOLINEMENTS
- BOUNDARY ARE TO BE TO THE REQUIREMENTS OF THE RELEVANT AUTHORITY. 4. LANDSCAPE LAYOUT SHOWN INDICATIVELY. REFER TO LANDSCAPE ARCHITECTURE DRAWINGS
- FOR DETAIL. PLANTER BOXES TO BE CONNECTED TO IRRIGATION SYSTEM.
- 5. ALL SERVICES TO BE ELECTRIC.6. RAINWATER TANK TO BE CONNECTED TO IRRIGATION SYSTEM.
- 7. ALL FIXTURES AND APPLIANCES TO BE WATER
- EFFICIENT.
- BUILDING ENVELOPE TO MEET THE
 REQUIREMENTS OF THE BASIX REPORT. DOUBLE GLAZING TO ALL WINDOWS AND GLAZED DOORS.



COORDINATION 9/10/2025 6/8/2025 PRE-DA ISSUE PRE-DA ISSUE 16/07/2025 Rev Date

DA SUBMISSION

MCCUE

03 7000 4899 info@studiomccue.com studiomccue.com

ABN 78 679 570 784 ARBV 600583 BOAQ 6254 NSWARB 9989

Project MVE

1803 - 1803A PITTWATER ROAD, MONA VALE, NSW 2103

GENERAL ARRANGEMENT PLAN - GROUND

Dwg No		
DA-103		
Rev	Project No	
E	25004	
Scale @ A1	Drawn By	Checked By
1:100	JC	CM



STUDIO MCCUE PTY LTD retains copyright and moral rights to this drawing and ideas therein. It cannot be reproduces or copied in any form or by any means without the written permission of STUDIO MCCUE PTY LTD.

NOTES

LEGEND

TITLE BOUNDARY

GENERAL NOTE

- 1. FFL, RL AND NGL LEVELS SHOWN ARE IN METERS
- TO AHD.

 2. DRAWINGS TO BE READ IN CONJUNCTION WITH CONSULTANT REPORTS INCLUDING:

 LAND SURVEY
- LAND SURVEY
 TRAFFIC & PARKING REPORT
 CONSTRUCTION & DEMOLITION WASTE MANAGEMENT PLAN
 ARBORICULTURAL IMPACT ASSESSMENT REPORT
 ACCESS REPORT
 BCA REPORT
 CIVIL ENGINEER'S REPORTS
 LANDSCAPE ARCHITECT'S REPORT
 WORKS TO ASSETS BEYOND THE PROPERTY BOUNDARY ARE TO BE TO THE REQUIREMENTS
- BOUNDARY ARE TO BE TO THE REQUIREMENTS OF THE RELEVANT AUTHORITY. 4. LANDSCAPE LAYOUT SHOWN INDICATIVELY.
- REFER TO LANDSCAPE ARCHITECTURE DRAWINGS FOR DETAIL. PLANTER BOXES TO BE CONNECTED TO IRRIGATION SYSTEM.
- 5. ALL SERVICES TO BE ELECTRIC.6. RAINWATER TANK TO BE CONNECTED TO
- IRRIGATION SYSTEM.
- 7. ALL FIXTURES AND APPLIANCES TO BE WATER EFFICIENT.

 8. BUILDING ENVELOPE TO MEET THE REQUIREMENTS OF THE BASIX REPORT. DOUBLE GLAZING TO ALL WINDOWS AND GLAZED DOORS.



9/10/2025 COORDINATION 6/8/2025 PRE-DA ISSUE PRE-DA ISSUE B 16/07/2025

DA SUBMISSION

MCCUE

MVE

1803 - 1803A PITTWATER ROAD, MONA VALE, NSW 2103

Dwg No		
DA-104		
Rev	Project No	
E	25004	
Scale @ A1	Drawn By	Checked By
1:100	JC	CM



STUDIO MCCUE PTY LTD retains copyright and moral rights to this drawing and ideas therein. It cannot be reproduces or copied in any form or by any means without the written permission of STUDIO MCCUE PTY LTD.

NOTES

LEGEND

TITLE BOUNDARY

GENERAL NOTE

- 1. FFL, RL AND NGL LEVELS SHOWN ARE IN METERS
- DRAWINGS TO BE READ IN CONJUNCTION WITH CONSULTANT REPORTS INCLUDING:
 LAND SURVEY
- LAND SURVEY
 TRAFFIC & PARKING REPORT
 CONSTRUCTION & DEMOLITION WASTE MANAGEMENT PLAN
 ARBORICULTURAL IMPACT ASSESSMENT REPORT
 ACCESS REPORT
 BCA REPORT
 CIVIL ENGINEER'S REPORTS
 LANDSCAPE ARCHITECT'S REPORT
 WORKS TO ASSETS BEYOND THE PROPERTY BOUNDARY ARE TO BE TO THE REQUIREMENTS
- BOUNDARY ARE TO BE TO THE REQUIREMENTS OF THE RELEVANT AUTHORITY.
- 4. LANDSCAPE LAYOUT SHOWN INDICATIVELY. REFER TO LANDSCAPE ARCHITECTURE DRAWINGS FOR DETAIL. PLANTER BOXES TO BE CONNECTED
- TO IRRIGATION SYSTEM. 5. ALL SERVICES TO BE ELECTRIC.6. RAINWATER TANK TO BE CONNECTED TO
- IRRIGATION SYSTEM.
- 7. ALL FIXTURES AND APPLIANCES TO BE WATER
- ALL FIXTURES AND APPLIANCES TO BE WATER EFFICIENT.
 BUILDING ENVELOPE TO MEET THE REQUIREMENTS OF THE BASIX REPORT. DOUBLE GLAZING TO ALL WINDOWS AND GLAZED DOORS.



9/10/2025 COORDINATION 6/8/2025 PRE-DA ISSUE PRE-DA ISSUE B 16/07/2025




DA SUBMISSION

MCCUE

MVE

1803 - 1803A PITTWATER ROAD, MONA VALE, NSW 2103

Dwg No		
DA-105		
Rev	Project No	
E	25004	
Scale @ A1	Drawn By	Checked By
1 · 100	JC	CM

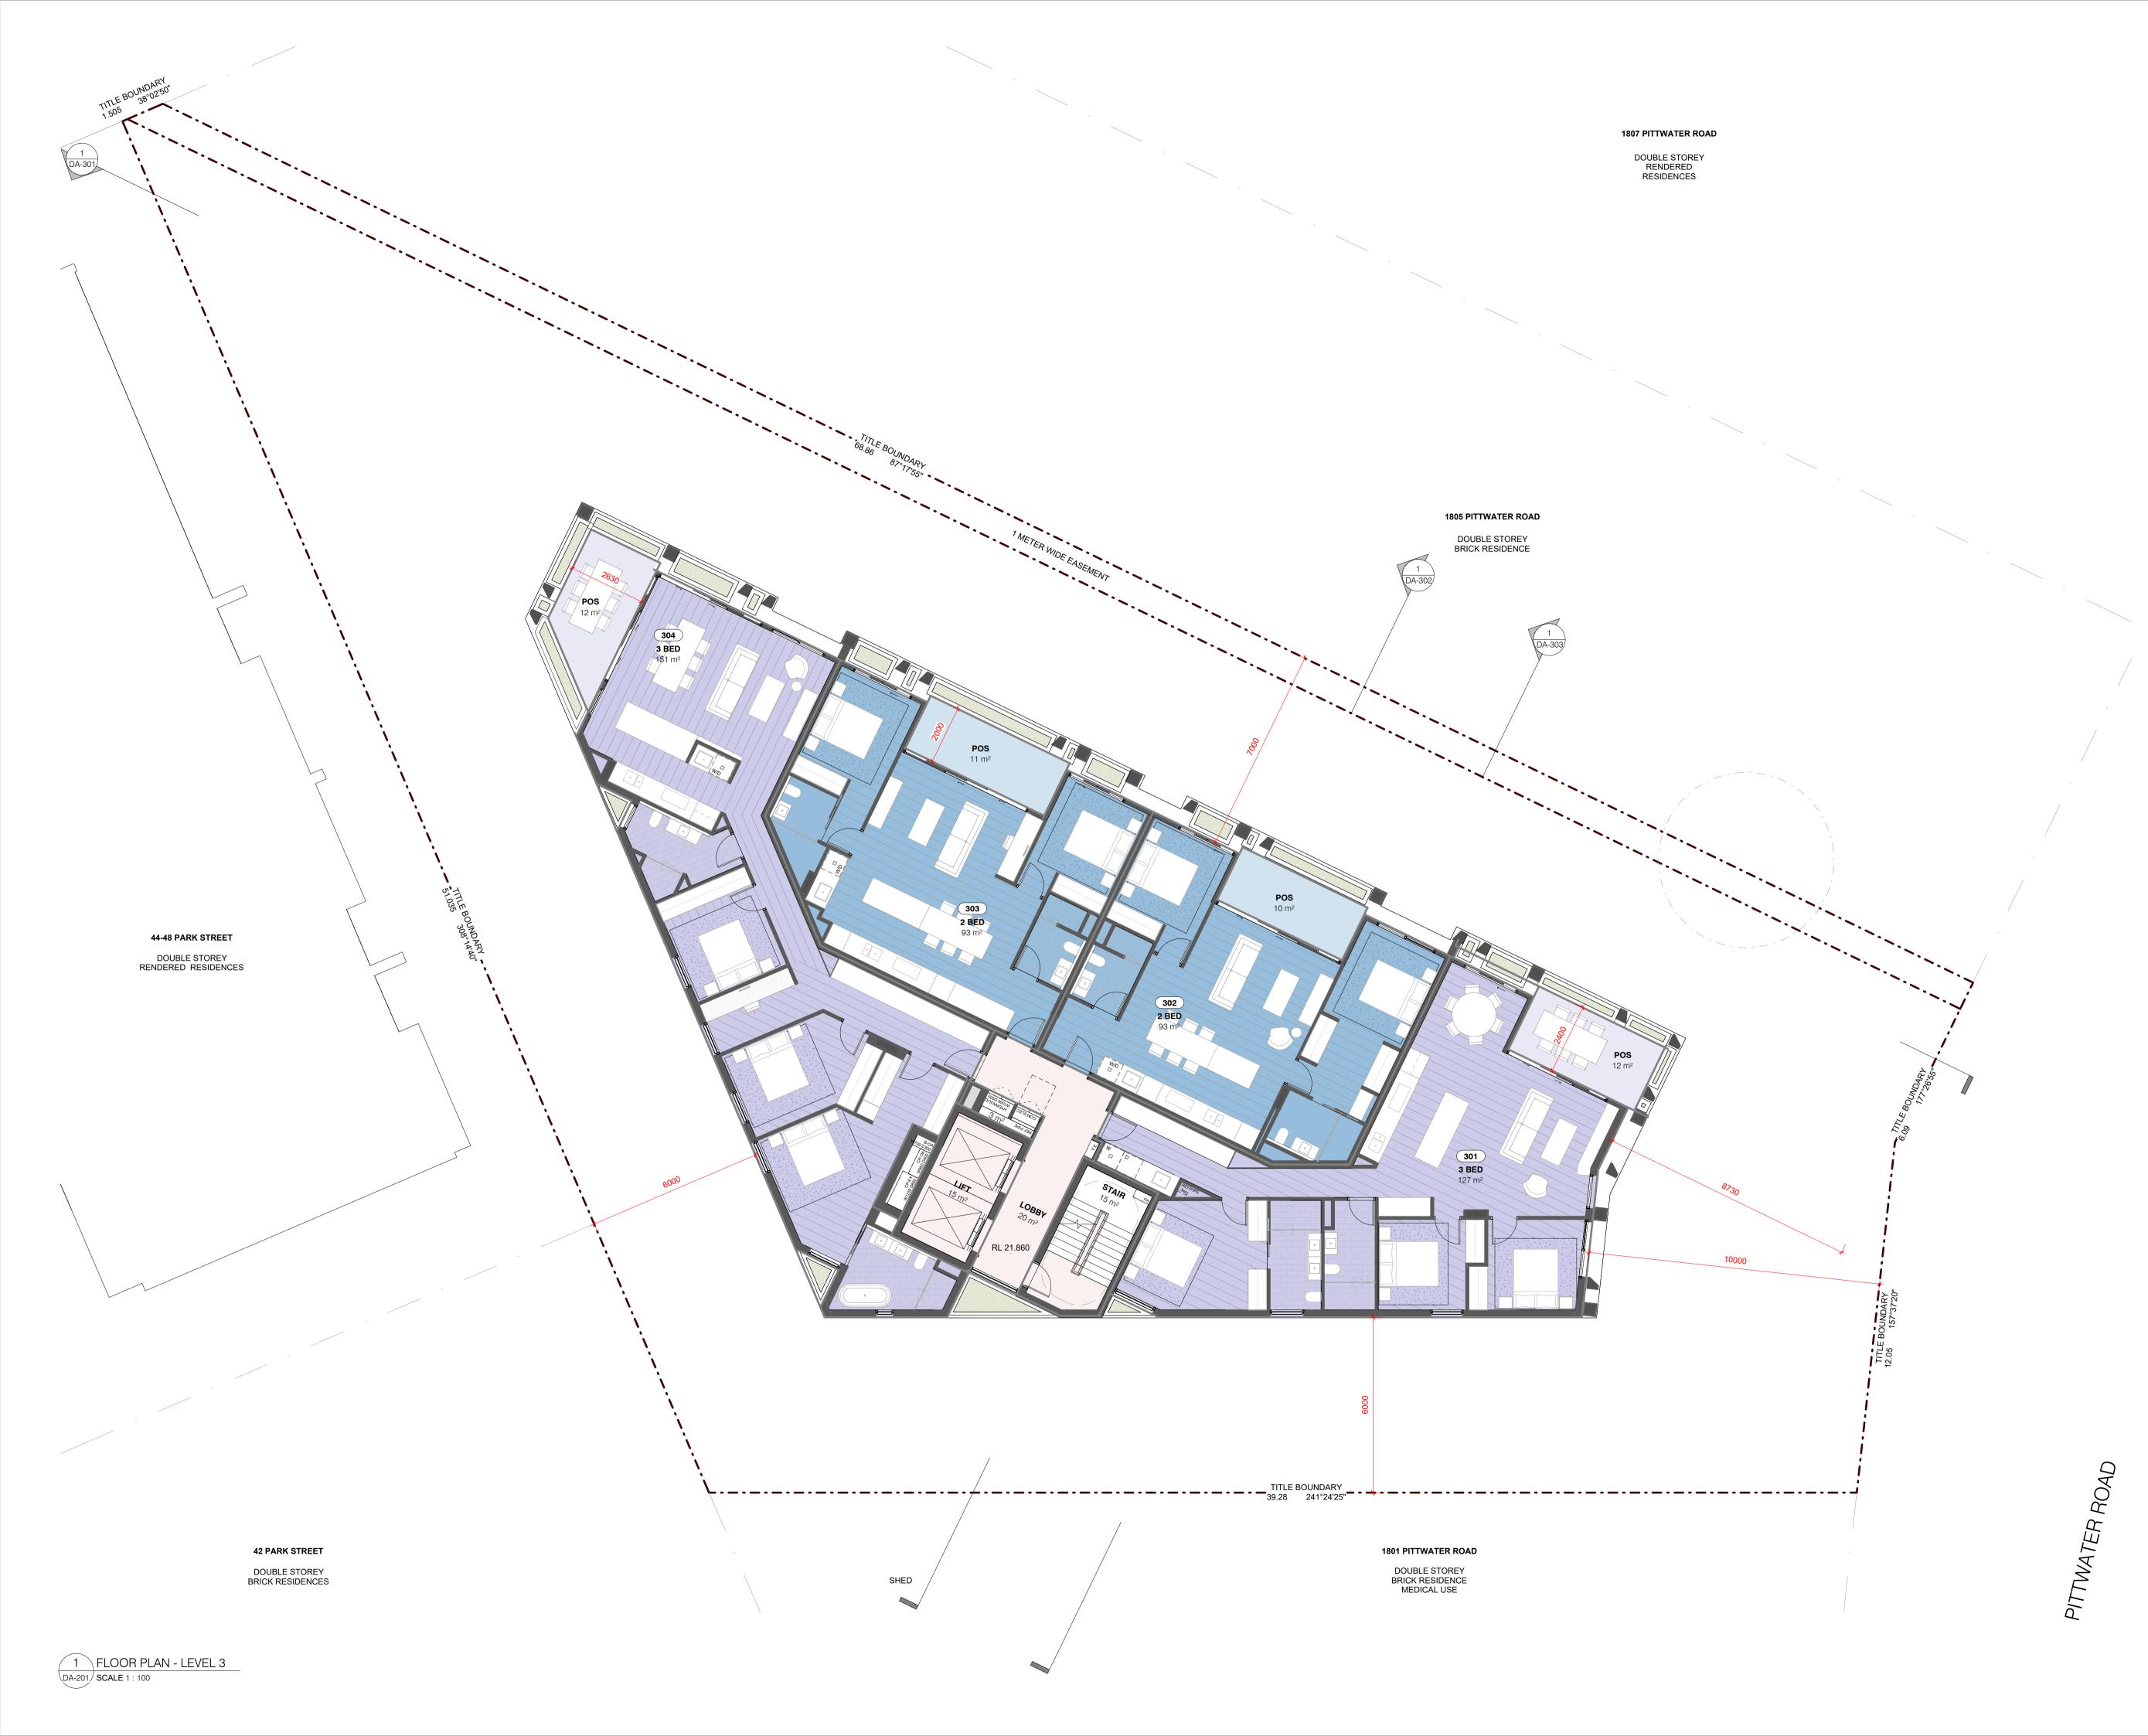

STUDIO MCCUE PTY LTD retains copyright and moral rights to this drawing and ideas therein. It cannot be reproduces or copied in any form or by any means without the written permission of STUDIO MCCUE PTY LTD.

NOTES

LEGEND

TITLE BOUNDARY

GENERAL NOTE

- 1. FFL, RL AND NGL LEVELS SHOWN ARE IN METERS
- TO AHD.

 2. DRAWINGS TO BE READ IN CONJUNCTION WITH CONSULTANT REPORTS INCLUDING:

 LAND SURVEY

- LAND SURVEY
 TRAFFIC & PARKING REPORT
 CONSTRUCTION & DEMOLITION WASTE MANAGEMENT PLAN
 ARBORICULTURAL IMPACT ASSESSMENT REPORT
 ACCESS REPORT
 BCA REPORT
 CIVIL ENGINEER'S REPORTS
 LANDSCAPE ARCHITECT'S REPORT
 WORKS TO ASSETS BEYOND THE PROPERTY BOUNDARY ARE TO BE TO THE REQUIREMENTS
- BOUNDARY ARE TO BE TO THE REQUIREMENTS OF THE RELEVANT AUTHORITY. 4. LANDSCAPE LAYOUT SHOWN INDICATIVELY.
- REFER TO LANDSCAPE ARCHITECTURE DRAWINGS FOR DETAIL. PLANTER BOXES TO BE CONNECTED TO IRRIGATION SYSTEM.
- 5. ALL SERVICES TO BE ELECTRIC.6. RAINWATER TANK TO BE CONNECTED TO
- IRRIGATION SYSTEM.
- 7. ALL FIXTURES AND APPLIANCES TO BE WATER
- ALL FIXTURES AND APPLIANCES TO BE WATER EFFICIENT.
 BUILDING ENVELOPE TO MEET THE REQUIREMENTS OF THE BASIX REPORT. DOUBLE GLAZING TO ALL WINDOWS AND GLAZED DOORS.



9/10/2025 COORDINATION 6/8/2025 PRE-DA ISSUE PRE-DA ISSUE B 16/07/2025



DA SUBMISSION

MCCUE

MVE

1803 - 1803A PITTWATER ROAD, MONA VALE, NSW 2103

Dwg No		
DA-106		
Rev	Project No	
E	25004	
Scale @ A1	Drawn By	Checked By
1:100	JC	CM



STUDIO MCCUE PTY LTD retains copyright and moral rights to this drawing and ideas therein. It cannot be reproduces or copied in any form or by any means without the written permission of STUDIO MCCUE PTY LTD.

NOTES

LEGEND

TITLE BOUNDARY

GENERAL NOTE

- 1. FFL, RL AND NGL LEVELS SHOWN ARE IN METERS
- TO AHD.

 2. DRAWINGS TO BE READ IN CONJUNCTION WITH CONSULTANT REPORTS INCLUDING:

 LAND SURVEY

- LAND SURVEY
 TRAFFIC & PARKING REPORT
 CONSTRUCTION & DEMOLITION WASTE MANAGEMENT PLAN
 ARBORICULTURAL IMPACT ASSESSMENT REPORT
 ACCESS REPORT
 BCA REPORT
 CIVIL ENGINEER'S REPORTS
 LANDSCAPE ARCHITECT'S REPORT
 WORKS TO ASSETS BEYOND THE PROPERTY BOUNDARY ARE TO BE TO THE REQUIREMENTS
- BOUNDARY ARE TO BE TO THE REQUIREMENTS OF THE RELEVANT AUTHORITY. 4. LANDSCAPE LAYOUT SHOWN INDICATIVELY. REFER TO LANDSCAPE ARCHITECTURE DRAWINGS
- FOR DETAIL. PLANTER BOXES TO BE CONNECTED TO IRRIGATION SYSTEM.
- 5. ALL SERVICES TO BE ELECTRIC.6. RAINWATER TANK TO BE CONNECTED TO
- IRRIGATION SYSTEM. 7. ALL FIXTURES AND APPLIANCES TO BE WATER
- ALL FIXTURES AND APPLIANCES TO BE WATER EFFICIENT.
 BUILDING ENVELOPE TO MEET THE REQUIREMENTS OF THE BASIX REPORT. DOUBLE GLAZING TO ALL WINDOWS AND GLAZED DOORS.



9/10/2025 COORDINATION 6/8/2025 PRE-DA ISSUE PRE-DA ISSUE B 16/07/2025



DA SUBMISSION

MCCUE

MVE

1803 - 1803A PITTWATER ROAD, MONA VALE, NSW 2103

GENERAL ARRANGEMENT PLAN - LEVEL 4

Dwg No DA-107 25004 Scale @ A1 Drawn By 1 : 100 JC



STUDIO MCCUE PTY LTD retains copyright and moral rights to this drawing and ideas therein. It cannot be reproduces or copied in any form or by any means without the written permission of STUDIO MCCUE PTY LTD.

NOTES

LEGEND

TITLE BOUNDARY

GENERAL NOTE

- 1. FFL, RL AND NGL LEVELS SHOWN ARE IN METERS
- DRAWINGS TO BE READ IN CONJUNCTION WITH CONSULTANT REPORTS INCLUDING:
 LAND SURVEY

- LAND SURVEY
 TRAFFIC & PARKING REPORT
 CONSTRUCTION & DEMOLITION WASTE MANAGEMENT PLAN
 ARBORICULTURAL IMPACT ASSESSMENT REPORT
 ACCESS REPORT
 BCA REPORT
 CIVIL ENGINEER'S REPORTS
 LANDSCAPE ARCHITECT'S REPORT
 WORKS TO ASSETS BEYOND THE PROPERTY BOUNDARY ARE TO BE TO THE REQUIREMENTS
- BOUNDARY ARE TO BE TO THE REQUIREMENTS OF THE RELEVANT AUTHORITY. 4. LANDSCAPE LAYOUT SHOWN INDICATIVELY.
- REFER TO LANDSCAPE ARCHITECTURE DRAWINGS FOR DETAIL. PLANTER BOXES TO BE CONNECTED TO IRRIGATION SYSTEM.
- 5. ALL SERVICES TO BE ELECTRIC.
 6. RAINWATER TANK TO BE CONNECTED TO
- IRRIGATION SYSTEM. 7. ALL FIXTURES AND APPLIANCES TO BE WATER
- ALL FIXTURES AND APPLIANCES TO BE WATER EFFICIENT.
 BUILDING ENVELOPE TO MEET THE REQUIREMENTS OF THE BASIX REPORT. DOUBLE GLAZING TO ALL WINDOWS AND GLAZED DOORS.



9/10/2025 COORDINATION 6/8/2025 PRE-DA ISSUE PRE-DA ISSUE B 16/07/2025




DA SUBMISSION

MCCUE

MVE

1803 - 1803A PITTWATER ROAD, MONA VALE, NSW 2103

Dwg No		
DA-108		
Rev	Project No	
E	25004	
Scale @ A1	Drawn By	Checked By
1:100	JC	CM

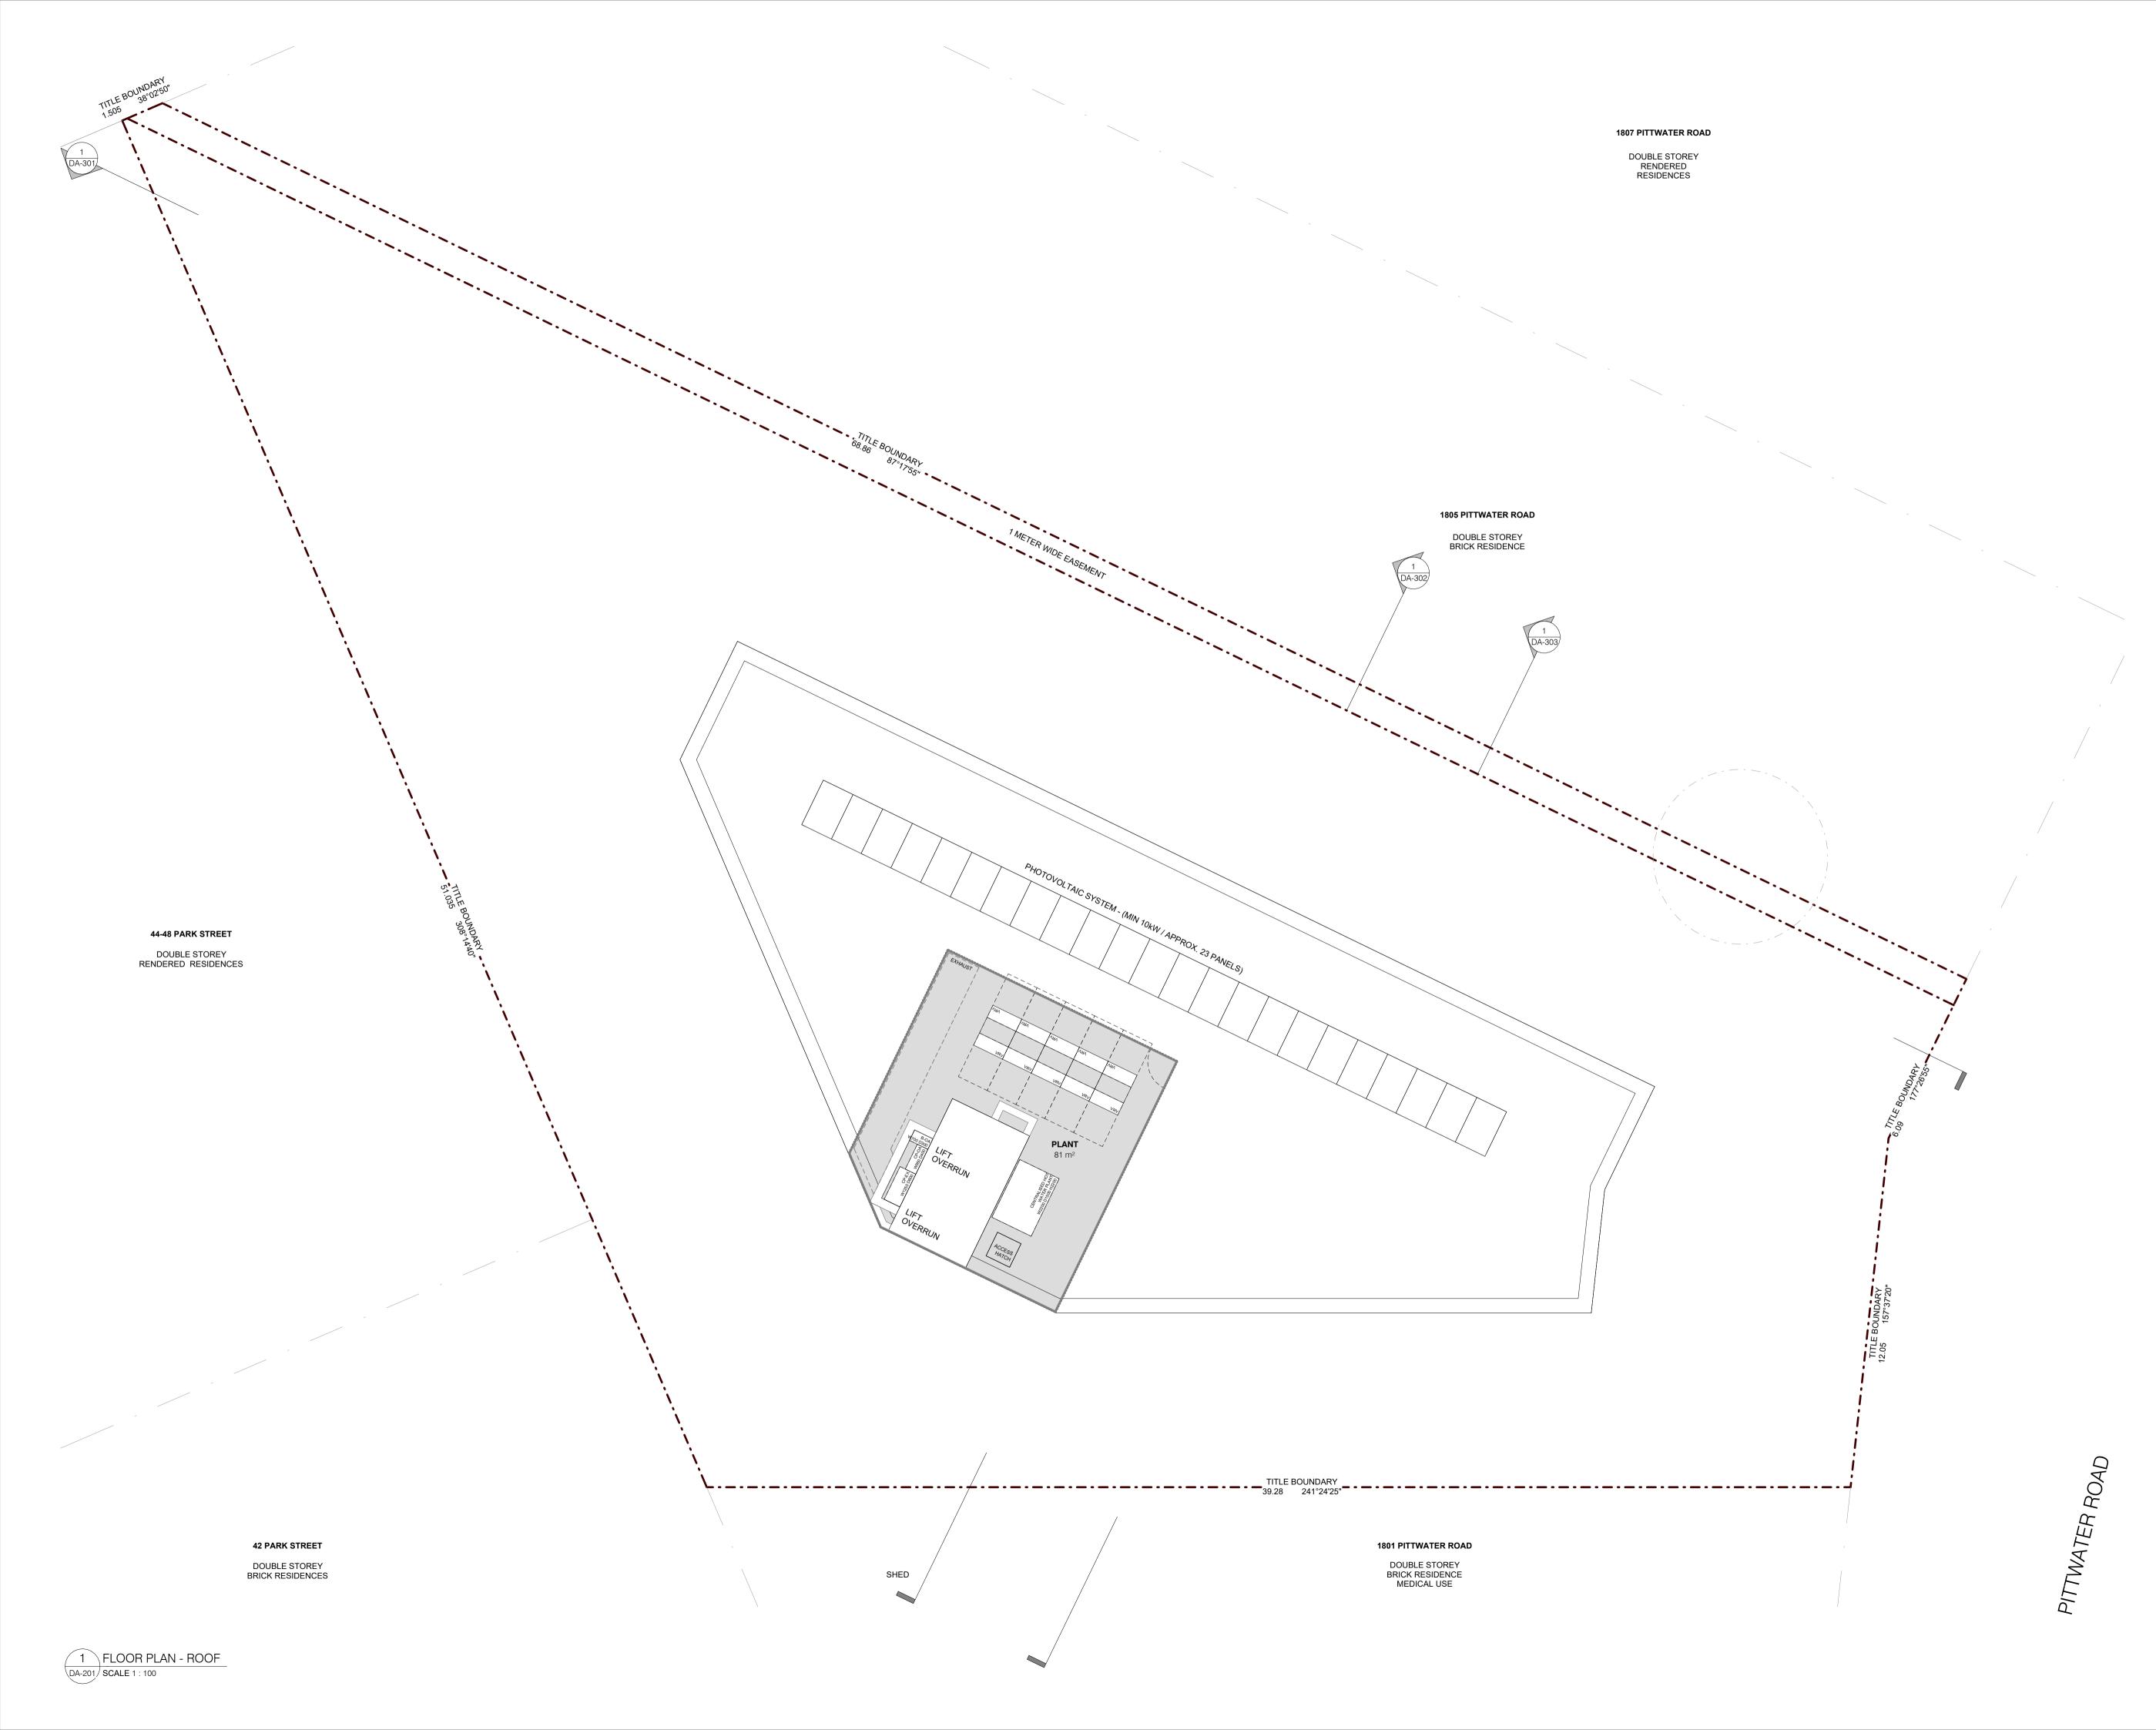

STUDIO MCCUE PTY LTD retains copyright and moral rights to this drawing and ideas therein. It cannot be reproduces or copied in any form or by any means without the written permission of STUDIO MCCUE PTY LTD.

NOTES

LEGEND

TITLE BOUNDARY

GENERAL NOTE

- 1. FFL, RL AND NGL LEVELS SHOWN ARE IN METERS
- TO AHD.

 2. DRAWINGS TO BE READ IN CONJUNCTION WITH CONSULTANT REPORTS INCLUDING:

 LAND SURVEY

- LAND SURVEY
 TRAFFIC & PARKING REPORT
 CONSTRUCTION & DEMOLITION WASTE MANAGEMENT PLAN
 ARBORICULTURAL IMPACT ASSESSMENT REPORT
 ACCESS REPORT
 BCA REPORT
 CIVIL ENGINEER'S REPORTS
 LANDSCAPE ARCHITECT'S REPORT
 WORKS TO ASSETS BEYOND THE PROPERTY BOUNDARY ARE TO BE TO THE REQUIREMENTS OF THE RELEVANT AUTHORITY. THE RELEVANT AUTHORITY. 4. LANDSCAPE LAYOUT SHOWN INDICATIVELY.
- REFER TO LANDSCAPE ARCHITECTURE DRAWINGS FOR DETAIL. PLANTER BOXES TO BE CONNECTED
- TO IRRIGATION SYSTEM.

 5. ALL SERVICES TO BE ELECTRIC.

 6. RAINWATER TANK TO BE CONNECTED TO
- IRRIGATION SYSTEM.
- 7. ALL FIXTURES AND APPLIANCES TO BE WATER EFFICIENT.

 8. BUILDING ENVELOPE TO MEET THE REQUIREMENTS OF THE BASIX REPORT. DOUBLE GLAZING TO ALL WINDOWS AND GLAZED DOORS.



D 9/10/2025 6/8/2025 PRE-DA ISSUE 16/07/2025 PRE-DA ISSUE PRE DA DRAFT ISSUE A 09/07/2025



DA SUBMISSION

MCCUE


info@studiomccue.com studiomccue.com

MVE

1803 - 1803A PITTWATER ROAD, MONA VALE, NSW 2103

GENERAL ARRANGEMENT PLAN - ROOF

Dwg No		
DA-109		
Rev	Project No	
D	25004	
Scale @ A1	Drawn By	Checked By
1:100	JC	CM

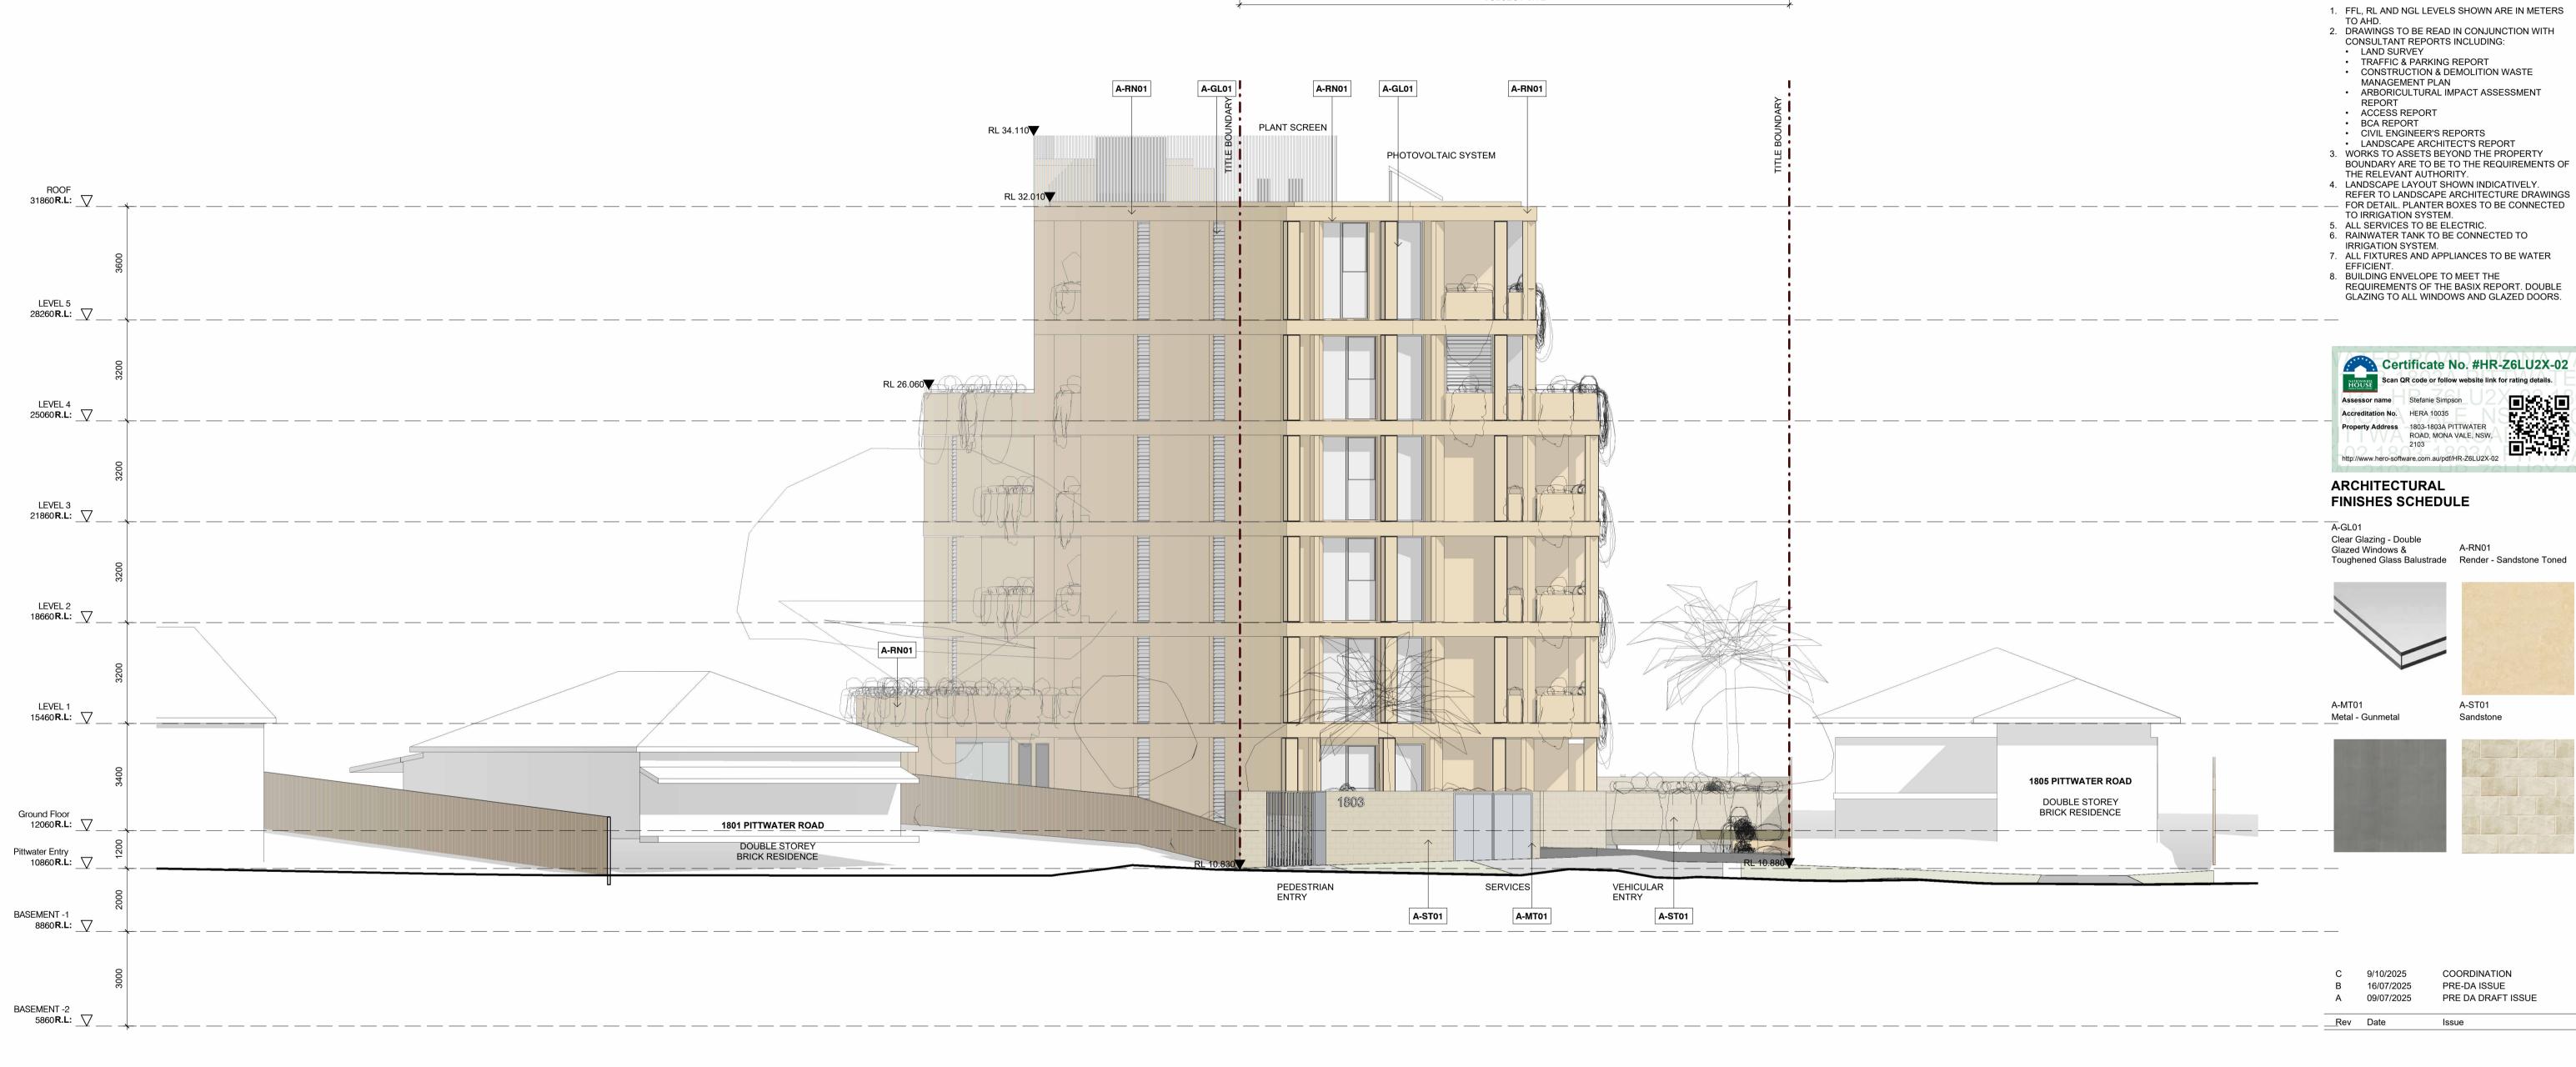

1 EAST ELEVATION (PITTWATER ROAD)
SCALE 1:100

SUBJECT SITE

Builders / Contractors shall verify all dimensions before any work commences. Dimensions shown are nominal. Figured dimensions shall take precedence over scaled dimensions. Any discrepancies are to be made known to the Architects / Designers studio prior to any works commencing on site. All shop drawings shall be submitted for review and manufacture shall not commence prior to the return of stamped shop drawings. Drawings issued subject to the approval of the relevant building surveyor.

STUDIO MCCUE PTY LTD retains copyright and moral rights to this drawing and ideas therein. It cannot be reproduces or copied in any form or by any means without the written permission of STUDIO MCCUE PTY LTD.

NOTES

LEGEND

TITLE BOUNDARY

GENERAL NOTE

- REFER TO LANDSCAPE ARCHITECTURE DRAWINGS



DA SUBMISSION

ABN 78 679 570 784 ARBV 600583 BOAQ 6254 NSWARB 9989

Project MVE

1803 - 1803A PITTWATER ROAD, MONA VALE, NSW 2103

EAST ELEVATION -PITTWATER ROAD

Dwg No		
DA-201		
Rev	Project No	
С	25004	
Scale @ A1	Drawn By	Checked By
As indicated	JC	CM



STUDIO MCCUE PTY LTD retains copyright and moral rights to this drawing and ideas therein. It cannot be reproduces or copied in any form or by any means without the written permission of STUDIO MCCUE PTY LTD.

NOTES

LEGEND


TITLE BOUNDARY

GENERAL NOTE

- FFL, RL AND NGL LEVELS SHOWN ARE IN METERS TO AHD.
 DRAWINGS TO BE READ IN CONJUNCTION WITH CONSULTANT REPORTS INCLUDING:


 LAND SURVEY

- LAND SURVEY
 TRAFFIC & PARKING REPORT
 CONSTRUCTION & DEMOLITION WASTE MANAGEMENT PLAN
 ARBORICULTURAL IMPACT ASSESSMENT REPORT
 ACCESS REPORT
 BCA REPORT
 CIVIL ENGINEER'S REPORTS
 LANDSCAPE ARCHITECT'S REPORT
 WORKS TO ASSETS BEYOND THE PROPERTY BOUNDARY ARE TO BE TO THE REQUIREMENTS
- BOUNDARY ARE TO BE TO THE REQUIREMENTS OF THE RELEVANT AUTHORITY.
- 4. LANDSCAPE LAYOUT SHOWN INDICATIVELY. REFER TO LANDSCAPE ARCHITECTURE DRAWINGS FOR DETAIL. PLANTER BOXES TO BE CONNECTED TO IRRIGATION SYSTEM.
- 5. ALL SERVICES TO BE ELECTRIC.
 6. RAINWATER TANK TO BE CONNECTED TO
- IRRIGATION SYSTEM. 7. ALL FIXTURES AND APPLIANCES TO BE WATER
- EFFICIENT.
- 8. BUILDING ENVELOPE TO MEET THE REQUIREMENTS OF THE BASIX REPORT. DOUBLE GLAZING TO ALL WINDOWS AND GLAZED DOORS.

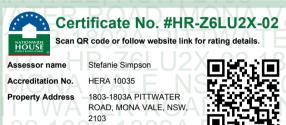

ARCHITECTURAL FINISHES SCHEDULE

Clear Glazing - Double Glazed Windows & Toughened Glass Balustrade Render - Sandstone Toned

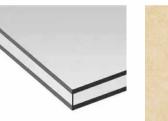







16/07/2025 PRE-DA ISSUE PRE DA DRAFT ISSUE 09/07/2025


DA SUBMISSION

MVE

1803 - 1803A PITTWATER ROAD, MONA VALE, NSW 2103

NORTH ELEVATION

Project No	
25004	
Drawn By	Checked By
JC	СМ
	25004 Drawn By

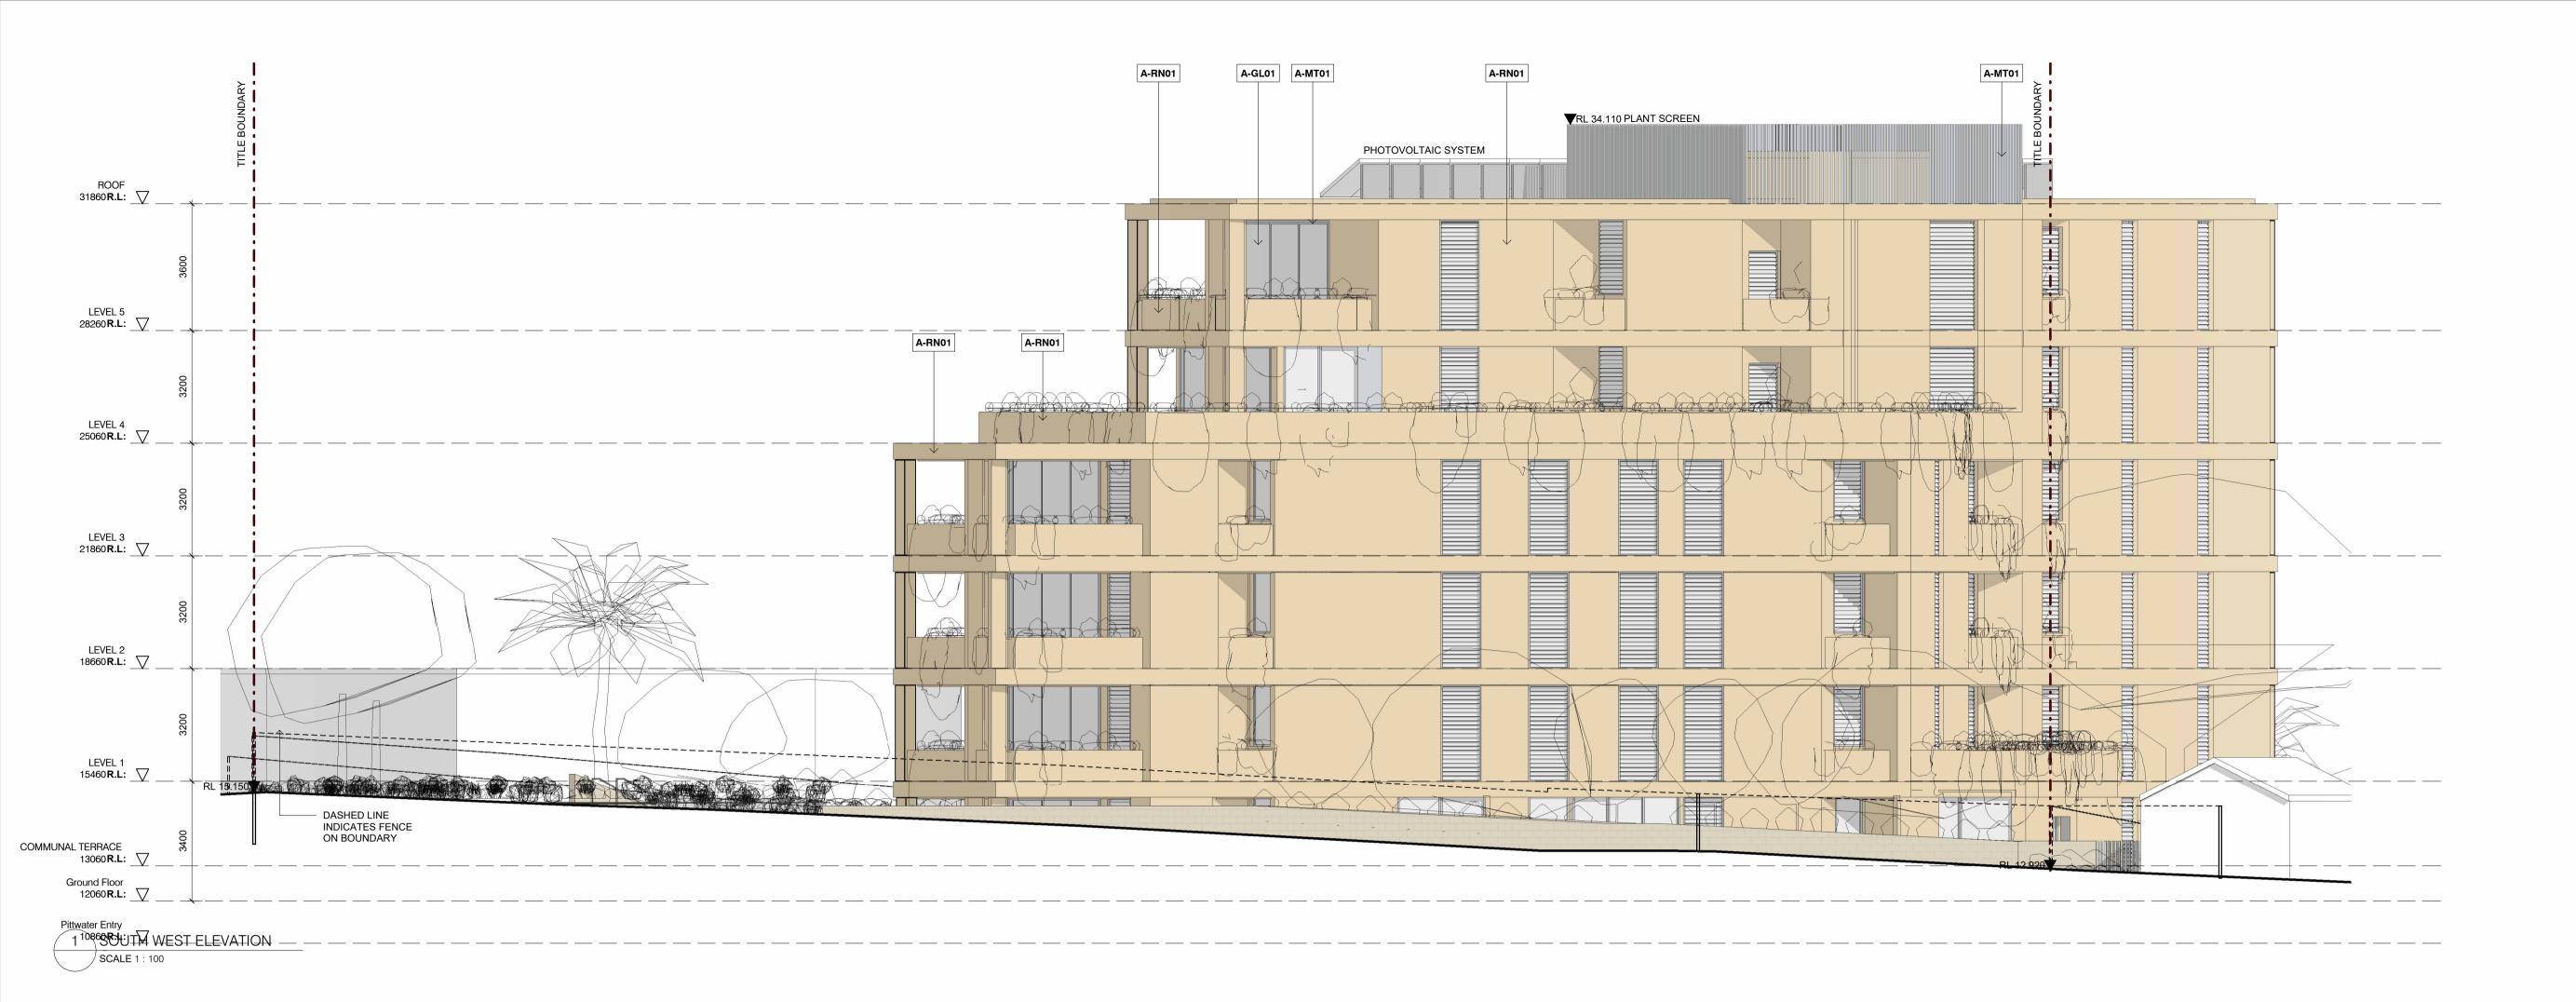



STUDIO MCCUE PTY LTD retains copyright and moral rights to this drawing and ideas therein. It cannot be reproduces or copied in any form or by any means without the written permission of STUDIO MCCUE PTY LTD.

NOTES

LEGEND

TITLE BOUNDARY

GENERAL NOTE

- 1. FFL, RL AND NGL LEVELS SHOWN ARE IN METERS
- DRAWINGS TO BE READ IN CONJUNCTION WITH CONSULTANT REPORTS INCLUDING:
- LAND SURVEY
- TRAFFIC & PARKING REPORT
 CONSTRUCTION & DEMOLITION WASTE
- MANAGEMENT PLAN

- MANAGEMENT PLAN

 ARBORICULTURAL IMPACT ASSESSMENT REPORT

 ACCESS REPORT

 BCA REPORT

 CIVIL ENGINEER'S REPORTS

 LANDSCAPE ARCHITECT'S REPORT


 WORKS TO ASSETS BEYOND THE PROPERTY

 BOLINDARY ARE TO BE TO THE REQUIREMENTS
- BOUNDARY ARE TO BE TO THE REQUIREMENTS OF THE RELEVANT AUTHORITY. 4. LANDSCAPE LAYOUT SHOWN INDICATIVELY. REFER TO LANDSCAPE ARCHITECTURE DRAWINGS
- FOR DETAIL. PLANTER BOXES TO BE CONNECTED TO IRRIGATION SYSTEM.
- 5. ALL SERVICES TO BE ELECTRIC.6. RAINWATER TANK TO BE CONNECTED TO
- IRRIGATION SYSTEM. 7. ALL FIXTURES AND APPLIANCES TO BE WATER
- ALL FIXTURES AND APPLIANCES TO BE WATER EFFICIENT.
 BUILDING ENVELOPE TO MEET THE REQUIREMENTS OF THE BASIX REPORT. DOUBLE GLAZING TO ALL WINDOWS AND GLAZED DOORS.



ARCHITECTURAL **FINISHES SCHEDULE**

A-GL01 Clear Glazing - Double Glazed Windows & Toughened Glass Balustrade Render - Sandstone Toned

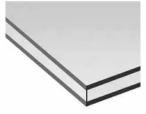



Metal - Gunmetal

Sandstone





9/10/2025 COORDINATION 16/07/2025 PRE-DA ISSUE PRE DA DRAFT ISSUE 09/07/2025

DA SUBMISSION

ABN 78 679 570 784 ARBV 600583 BOAQ 6254 NSWARB 9989

Project MVE

1803 - 1803A PITTWATER ROAD, MONA VALE, NSW 2103

WEST ELEVATION

Dwg No		
DA-203		
Rev	Project No	
С	25004	
Scale @ A1	Drawn By	Checked By
As indicated	JC	CM



1 SOUTH EAST ELEVATION SCALE 1 : 100

Builders / Contractors shall verify all dimensions before any work commences. Dimensions shown are nominal. Figured dimensions shall take precedence over scaled dimensions. Any discrepancies are to be made known to the Architects / Designers studio prior to any works commencing on site. All shop drawings shall be submitted for review and manufacture shall not commence prior to the return of stamped shop drawings. Drawings issued subject to the approval of the relevant building surveyor.

STUDIO MCCUE PTY LTD retains copyright and moral rights to this drawing and ideas therein. It cannot be reproduces or copied in any form or by any means without the written permission of STUDIO MCCUE PTY LTD.

NOTES

LEGEND

TITLE BOUNDARY

GENERAL NOTE

- 1. FFL, RL AND NGL LEVELS SHOWN ARE IN METERS
- DRAWINGS TO BE READ IN CONJUNCTION WITH CONSULTANT REPORTS INCLUDING:
- LAND SURVEY TRAFFIC & PARKING REPORT
- CONSTRUCTION & DEMOLITION WASTE MANAGEMENT PLAN


 • ARBORICULTURAL IMPACT ASSESSMENT
- REPORT
- ACCESS REPORTBCA REPORT
- CIVIL ENGINEER'S REPORTS LANDSCAPE ARCHITECT'S REPORT
- 3. WORKS TO ASSETS BEYOND THE PROPERTY BOUNDARY ARE TO BE TO THE REQUIREMENTS OF
- THE RELEVANT AUTHORITY. 4. LANDSCAPE LAYOUT SHOWN INDICATIVELY. REFER TO LANDSCAPE ARCHITECTURE DRAWINGS
- FOR DETAIL. PLANTER BOXES TO BE CONNECTED TO IRRIGATION SYSTEM.
- 5. ALL SERVICES TO BE ELECTRIC.
 6. RAINWATER TANK TO BE CONNECTED TO IRRIGATION SYSTEM.
- 7. ALL FIXTURES AND APPLIANCES TO BE WATER EFFICIENT.
- 8. BUILDING ENVELOPE TO MEET THE REQUIREMENTS OF THE BASIX REPORT. DOUBLE GLAZING TO ALL WINDOWS AND GLAZED DOORS.



ARCHITECTURAL FINISHES SCHEDULE

http://www.hero-software.com.au/pdf/HR-Z6LU2X-02

A-GL01 Clear Glazing - Double Glazed Windows & Toughened Glass Balustrade Render - Sandstone Toned

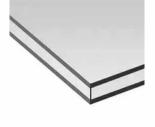



Metal - Gunmetal





C 9/10/2025 COORDINATION 16/07/2025 PRE-DA ISSUE PRE DA DRAFT ISSUE A 09/07/2025



DA SUBMISSION

MCCUE


ABN 78 679 570 784 ARBV 600583 BOAQ 6254 NSWARB 9989

Project MVE

1803 - 1803A PITTWATER ROAD, MONA VALE, NSW 2103

SOUTH EAST ELEVATION

DA-204		
Rev	Project No	
C	25004	
Scale @ A1	Drawn By	Checked By
As indicated	JC	CM

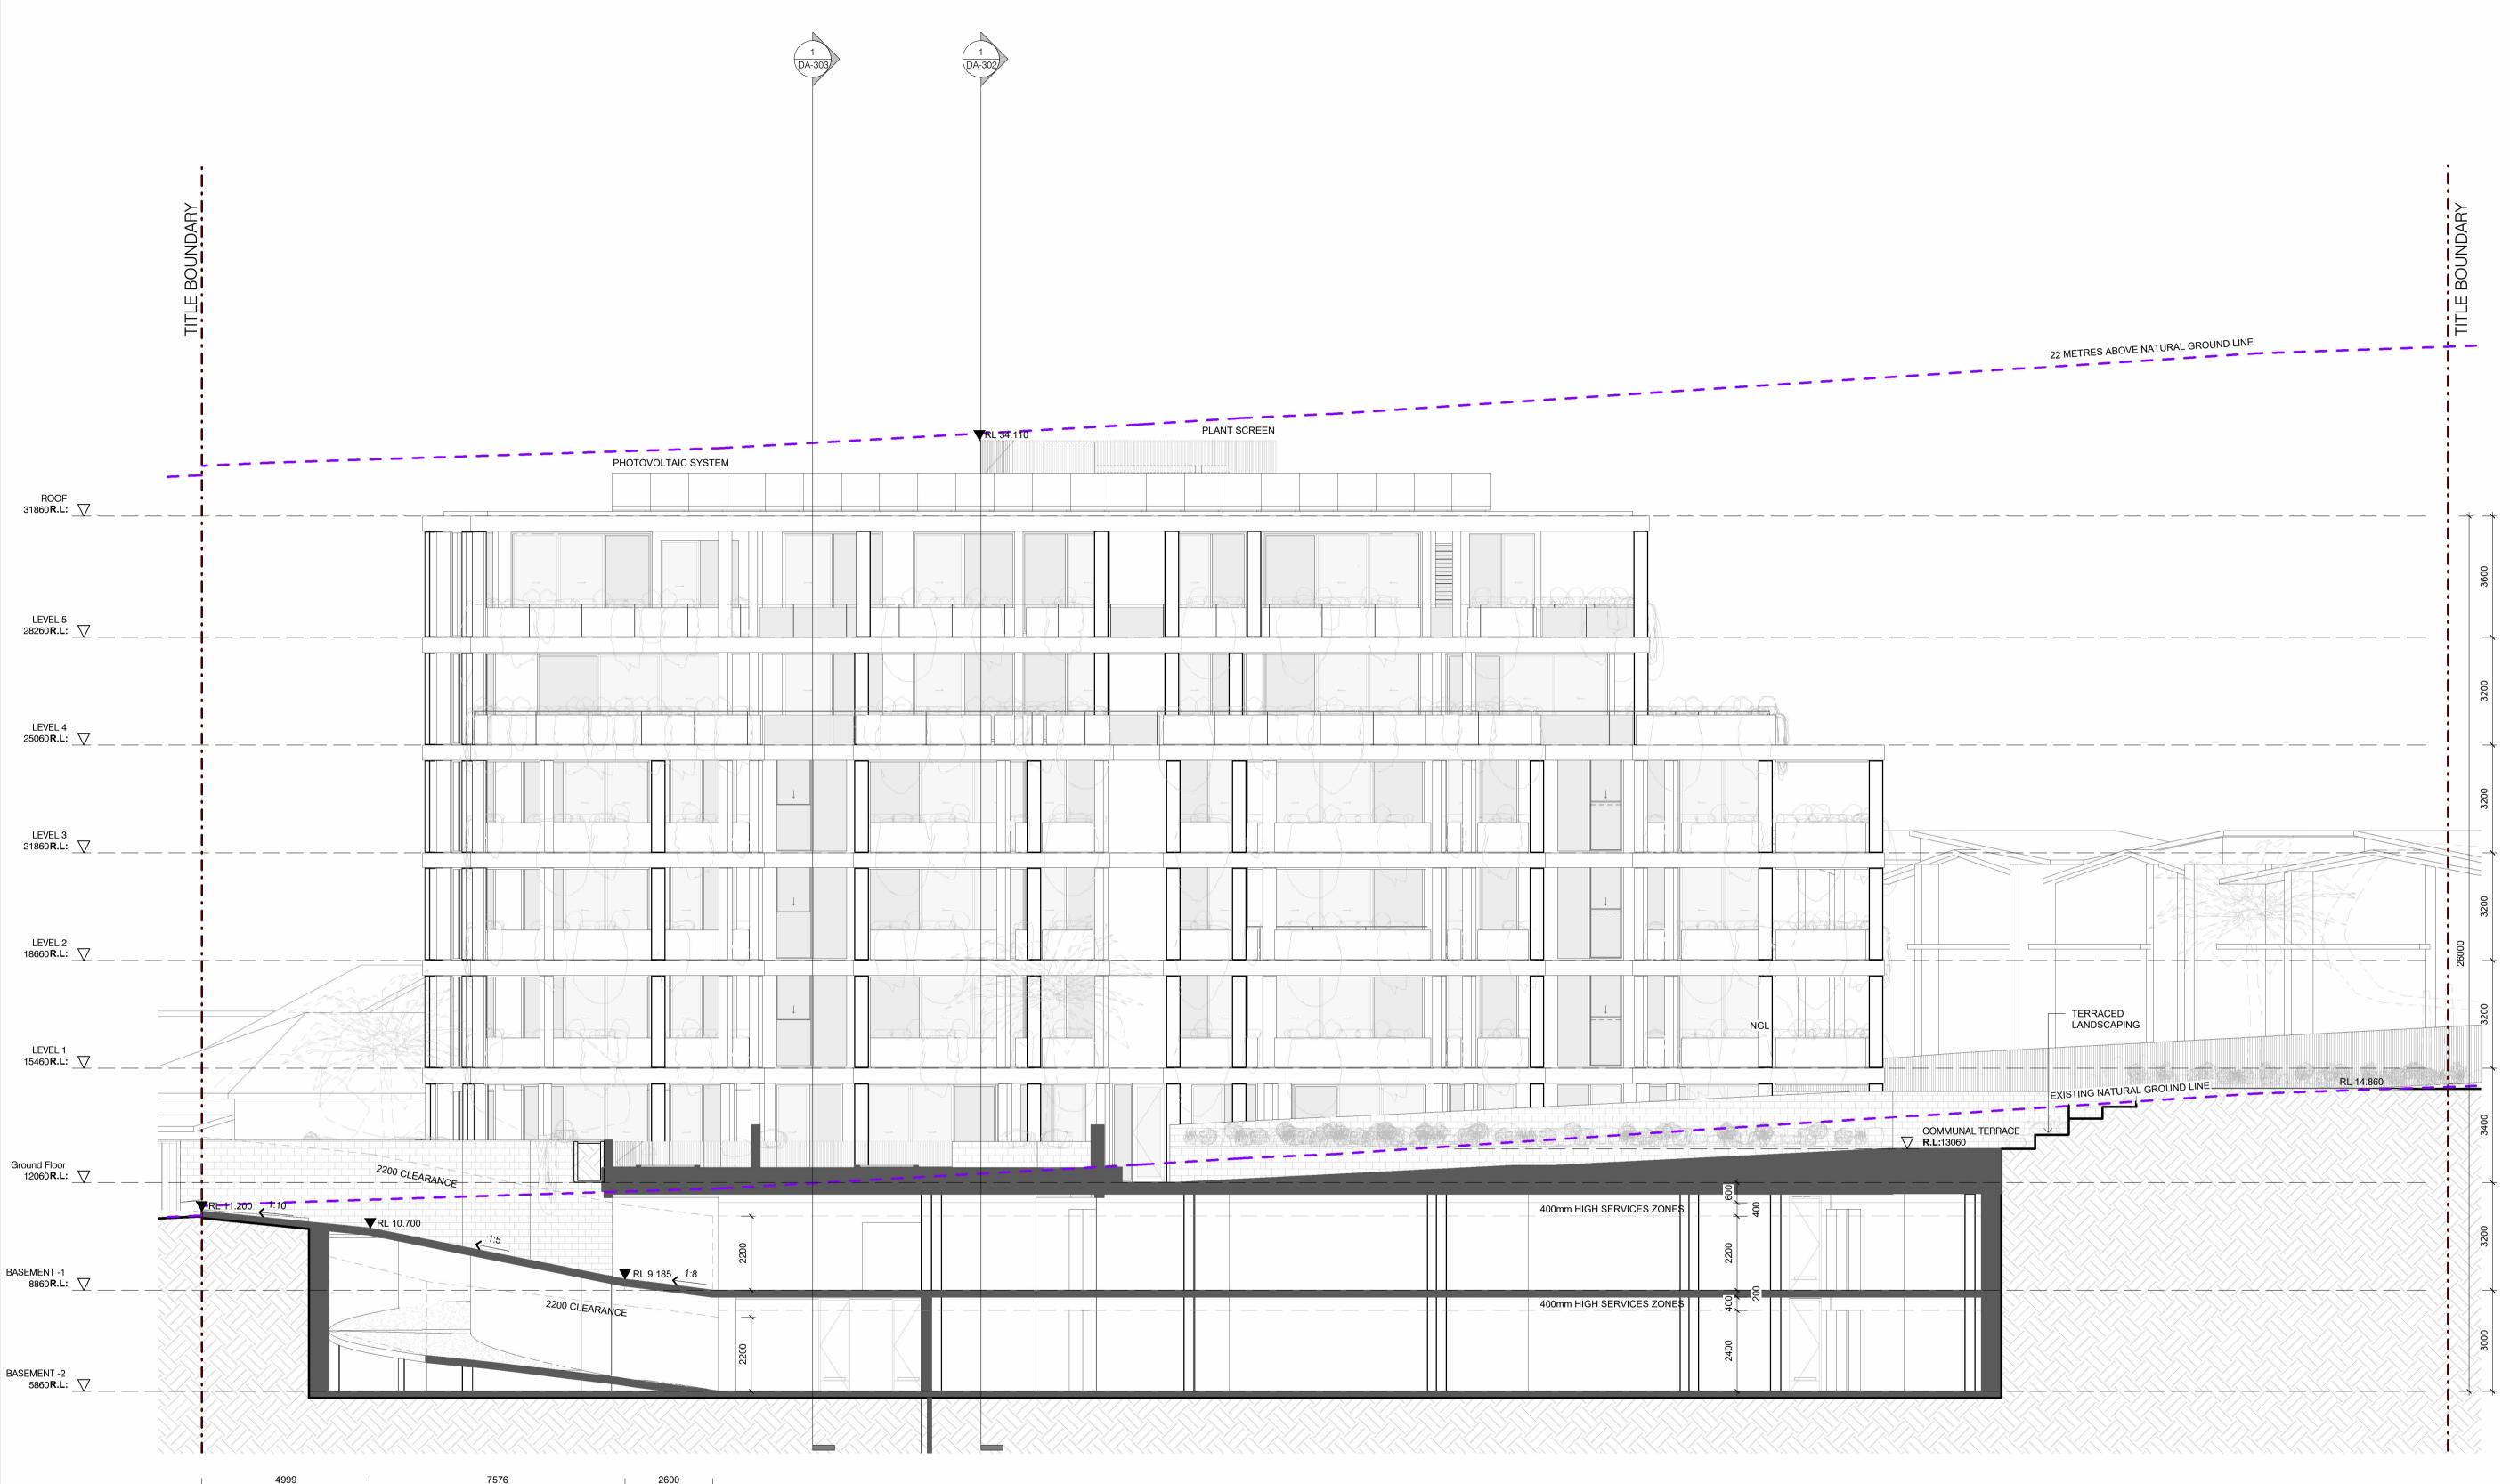

1 Section A
DA-101 SCALE 1: 100

Builders / Contractors shall verify all dimensions before any work commences. Dimensions shown are nominal. any work commences. Dimensions shown are nominal.

Figured dimensions shall take precedence over scaled dimensions. Any discrepancies are to be made known to the Architects / Designers studio prior to any works commencing on site. All shop drawings shall be submitted for review and manufacture shall not commence prior to the return of stamped class drawings. Provings insued the return of stamped shop drawings. Drawings issued subject to the approval of the relevant building surveyor.

STUDIO MCCUE PTY LTD retains copyright and moral rights to this drawing and ideas therein. It cannot be reproduces or copied in any form or by any means without the written permission of STUDIO MCCUE PTY LTD.

NOTES

LEGEND

TITLE BOUNDARY

GENERAL NOTE

- FFL, RL AND NGL LEVELS SHOWN ARE IN METERS TO AHD.
 DRAWINGS TO BE READ IN CONJUNCTION WITH CONSULTANT REPORTS INCLUDING:

 LAND SURVEY

- LAND SURVEY
 TRAFFIC & PARKING REPORT
 CONSTRUCTION & DEMOLITION WASTE MANAGEMENT PLAN
 ARBORICULTURAL IMPACT ASSESSMENT REPORT
 ACCESS REPORT
 BCA REPORT
 CIVIL ENGINEER'S REPORTS
 LANDSCAPE ARCHITECT'S REPORT
 WORKS TO ASSETS BEYOND THE PROPERTY BOUNDARY ARE TO BE TO THE REQUIREMENTS OF THE RELEVANT AUTHORITY. THE RELEVANT AUTHORITY.
- 4. LANDSCAPE LAYOUT SHOWN INDICATIVELY.
 REFER TO LANDSCAPE ARCHITECTURE DRAWINGS
 FOR DETAIL. PLANTER BOXES TO BE CONNECTED

 TO DETAIL. PLANTER BOXES TO BE CONNECTED TO IRRIGATION SYSTEM.
- 5. ALL SERVICES TO BE ELECTRIC.6. RAINWATER TANK TO BE CONNECTED TO
- IRRIGATION SYSTEM.
- ALL FIXTURES AND APPLIANCES TO BE WATER EFFICIENT.
 BUILDING ENVELOPE TO MEET THE REQUIREMENTS OF THE BASIX REPORT. DOUBLE GLAZING TO ALL WINDOWS AND GLAZED DOORS.



COORDINATION 6/8/2025 PRE-DA ISSUE PRE-DA ISSUE A 16/07/2025

DA SUBMISSION


MCCUE

MVE

1803 - 1803A PITTWATER ROAD, MONA VALE, NSW 2103

BUILDING SECTION

DA-301		
Rev	Project No	
С	25004	
Scale @ A1	Drawn By	Checked By
1:100	JC	CM

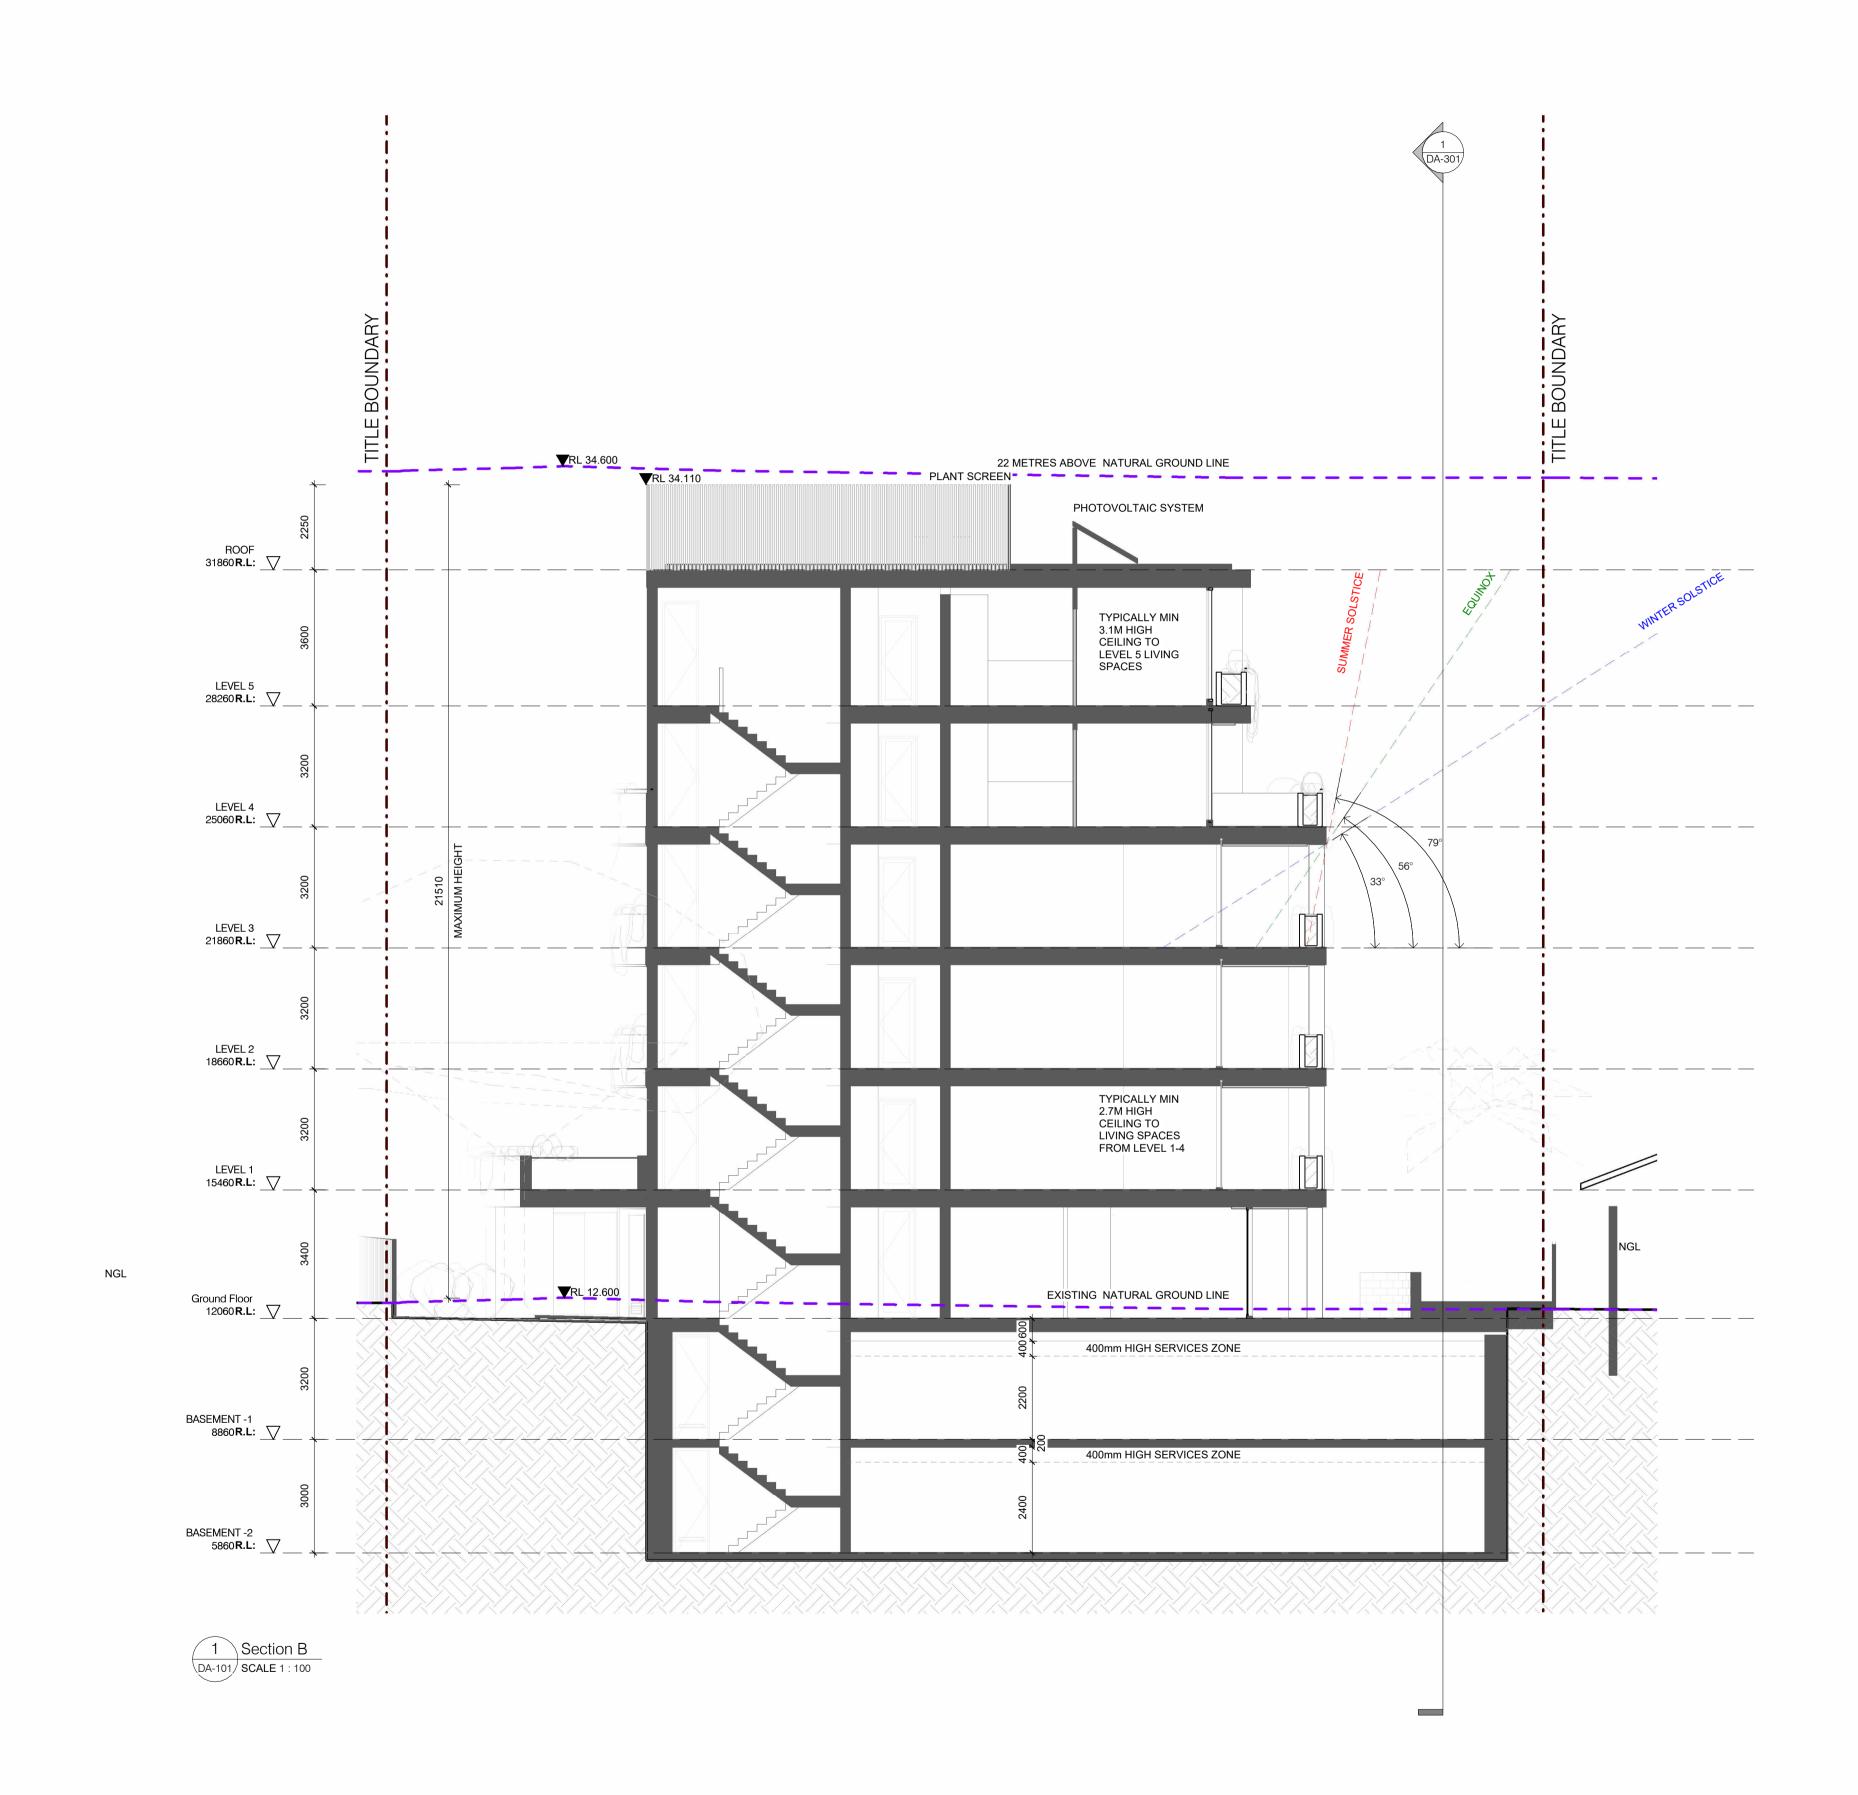

STUDIO MCCUE PTY LTD retains copyright and moral rights to this drawing and ideas therein. It cannot be reproduces or copied in any form or by any means without the written permission of STUDIO MCCUE PTY LTD.

NOTES

LEGEND

TITLE BOUNDARY


GENERAL NOTE

LAND SURVEY

- FFL, RL AND NGL LEVELS SHOWN ARE IN METERS TO AHD.
- DRAWINGS TO BE READ IN CONJUNCTION WITH CONSULTANT REPORTS INCLUDING:
- TRAFFIC & PARKING REPORT
 CONSTRUCTION & DEMOLITION WASTE

- CONSTRUCTION & DEMOLITION WASTE MANAGEMENT PLAN
 ARBORICULTURAL IMPACT ASSESSMENT REPORT
 ACCESS REPORT
 BCA REPORT
 CIVIL ENGINEER'S REPORTS
 LANDSCAPE ARCHITECT'S REPORT
 WORKS TO ASSETS BEYOND THE PROPERTY BOUNDARY ARE TO BE TO THE REQUIREMENTS. BOUNDARY ARE TO BE TO THE REQUIREMENTS OF
- THE RELEVANT AUTHORITY. 4. LANDSCAPE LAYOUT SHOWN INDICATIVELY. REFER TO LANDSCAPE ARCHITECTURE DRAWINGS FOR DETAIL. PLANTER BOXES TO BE CONNECTED
- TO IRRIGATION SYSTEM. 5. ALL SERVICES TO BE ELECTRIC.
 6. RAINWATER TANK TO BE CONNECTED TO
- IRRIGATION SYSTEM.
- 7. ALL FIXTURES AND APPLIANCES TO BE WATER EFFICIENT.

 8. BUILDING ENVELOPE TO MEET THE REQUIREMENTS OF THE BASIX REPORT. DOUBLE CLATER TO ALL WINDOWS AND CLATER POORS GLAZING TO ALL WINDOWS AND GLAZED DOORS.

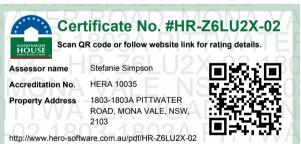

C 9/10/2025 COORDINATION 6/8/2025 PRE-DA ISSUE A 16/07/2025 PRE-DA ISSUE



MCCUE


ABN 78 679 570 784 ARBV 600583 BOAQ 6254 NSWARB 9989

Project

MVE 1803 - 1803A PITTWATER ROAD, MONA VALE, NSW 2103

BUILDING SECTION

No	
04	
By Checked	Ву
CM	
	СМ

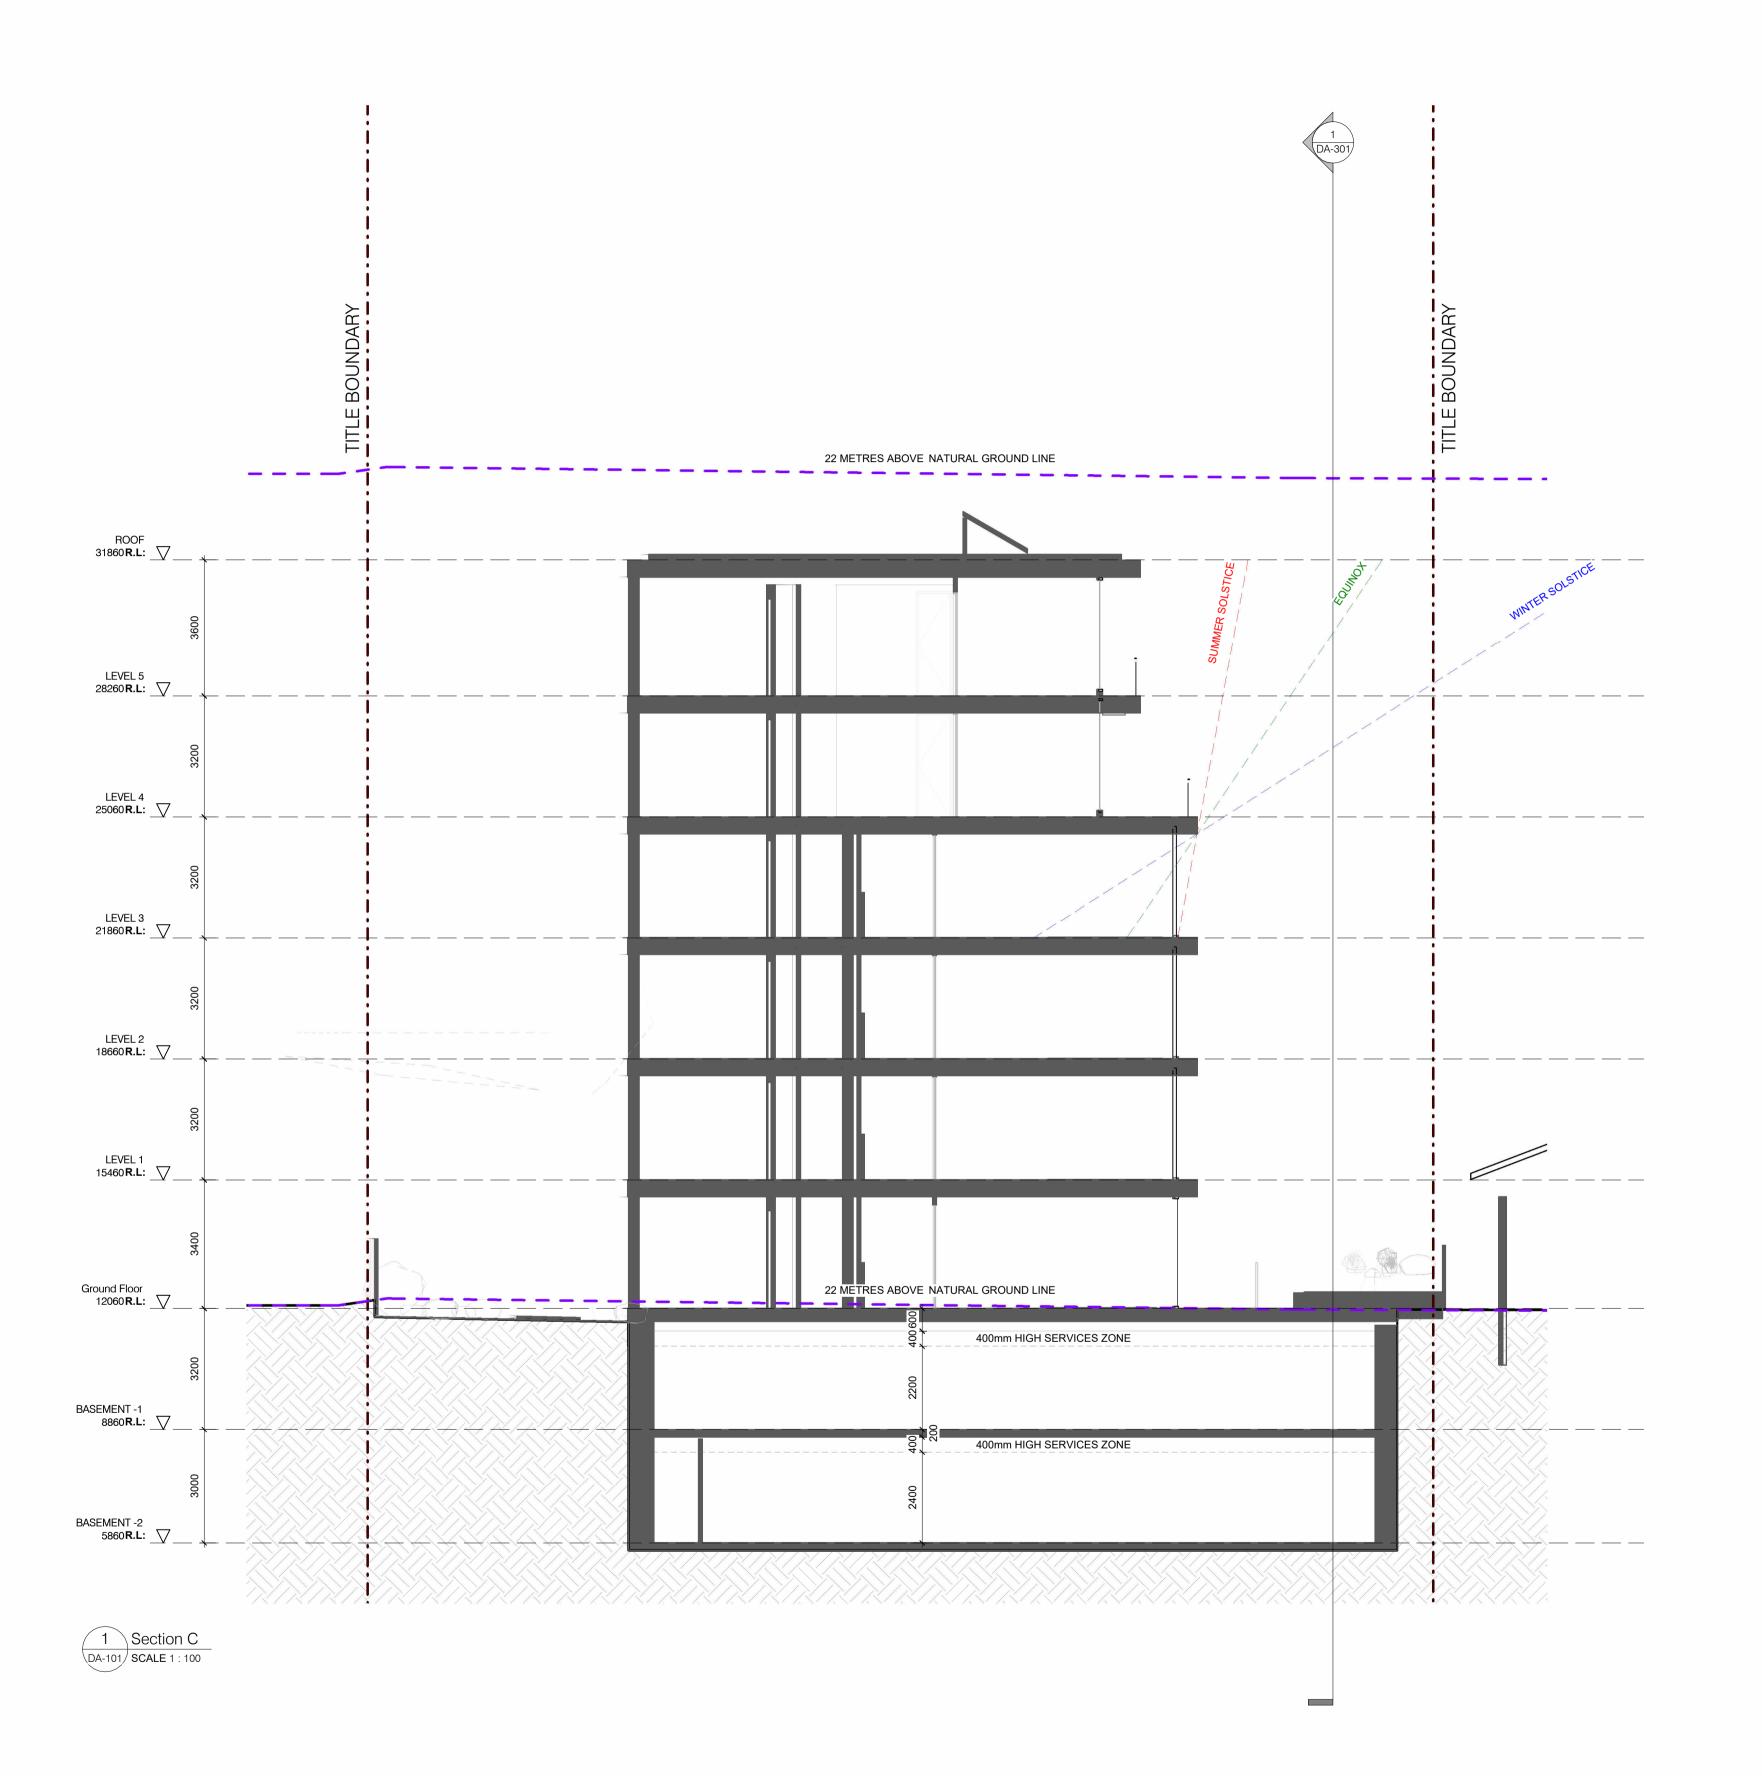

STUDIO MCCUE PTY LTD retains copyright and moral rights to this drawing and ideas therein. It cannot be reproduces or copied in any form or by any means without the written permission of STUDIO MCCUE PTY LTD.

NOTES

LEGEND

TITLE BOUNDARY

GENERAL NOTE

- FFL, RL AND NGL LEVELS SHOWN ARE IN METERS TO AHD.
 DRAWINGS TO BE READ IN CONJUNCTION WITH CONSULTANT REPORTS INCLUDING:

 LAND SURVEY
- TRAFFIC & PARKING REPORTCONSTRUCTION & DEMOLITION WASTE

- CONSTRUCTION & DEMOLITION WASTE MANAGEMENT PLAN
 ARBORICULTURAL IMPACT ASSESSMENT REPORT
 ACCESS REPORT
 BCA REPORT
 CIVIL ENGINEER'S REPORTS
 LANDSCAPE ARCHITECT'S REPORT
 WORKS TO ASSETS BEYOND THE PROPERTY BOUNDARY ARE TO BE TO THE REQUIREMENTS. BOUNDARY ARE TO BE TO THE REQUIREMENTS OF
- THE RELEVANT AUTHORITY. 4. LANDSCAPE LAYOUT SHOWN INDICATIVELY. REFER TO LANDSCAPE ARCHITECTURE DRAWINGS FOR DETAIL. PLANTER BOXES TO BE CONNECTED
- TO IRRIGATION SYSTEM. 5. ALL SERVICES TO BE ELECTRIC.
 6. RAINWATER TANK TO BE CONNECTED TO
- IRRIGATION SYSTEM.
- ALL FIXTURES AND APPLIANCES TO BE WATER EFFICIENT.
 BUILDING ENVELOPE TO MEET THE REQUIREMENTS OF THE BASIX REPORT. DOUBLE GLAZING TO ALL WINDOWS AND GLAZED DOORS.



B 9/10/2025 COORDINATION A 6/8/2025 PRE-DA ISSUE



DA SUBMISSION

MCCUE

ABN 78 679 570 784 ARBV 600583 BOAQ 6254 NSWARB 9989

Project MVE

1803 - 1803A PITTWATER ROAD, MONA VALE, NSW 2103

BUILDING SECTION

DA-303		
Rev	Project No	
В	25004	
Scale @ A1	Drawn By	Checked By
1:100	JC	CM